



7 POINTED
CHEROKEE GAZEBO
CHEROKEE NATION

101 S Muskogee Ave, Tahlequah, OK 74464



E. DELAWARE ST.

IMAGES ARE CONCEPTUAL - REFER CONSTRUCTION DRAWINGS FOR ACTUAL REQUIREMENTS




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A302 DETAILS
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E000 ELECTRICAL NOTES AND LEGEND
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E200 ELECTRICAL SITE PLAN
Grand total: 9

ADD ALTERNATES


- ALTERNATE #1 - SHINGLES**
- ADD ALTERNATE - INSTALL WOOD SHAKE SHINGLES TO MATCH NEARBY COURTHOUSE.
INSTALL WOOD SHAKE SHINGLES OVER 1x4s @ 8" O.C. FOLLOW ALL MANUFACTURER'S RECOMMENDED WATER PROOFING TECHNIQUES.
- BASE BID - INSTALL COMPOSITION SHINGLES SIMILAR TO EXISTING GAZEBO.
INSTALL COMPOSITION SHINGLES OVER 3/4" O.S.B. FOLLOW ALL MANUFACTURER'S RECOMMENDED WATER PROOFING TECHNIQUES.
- ALTERNATE #2 - CONCRETE COLORING**
- ADD ALTERNATE - STAINED CONCRETE
- BASE BID - INTEGRAL CONCRETE COLORING

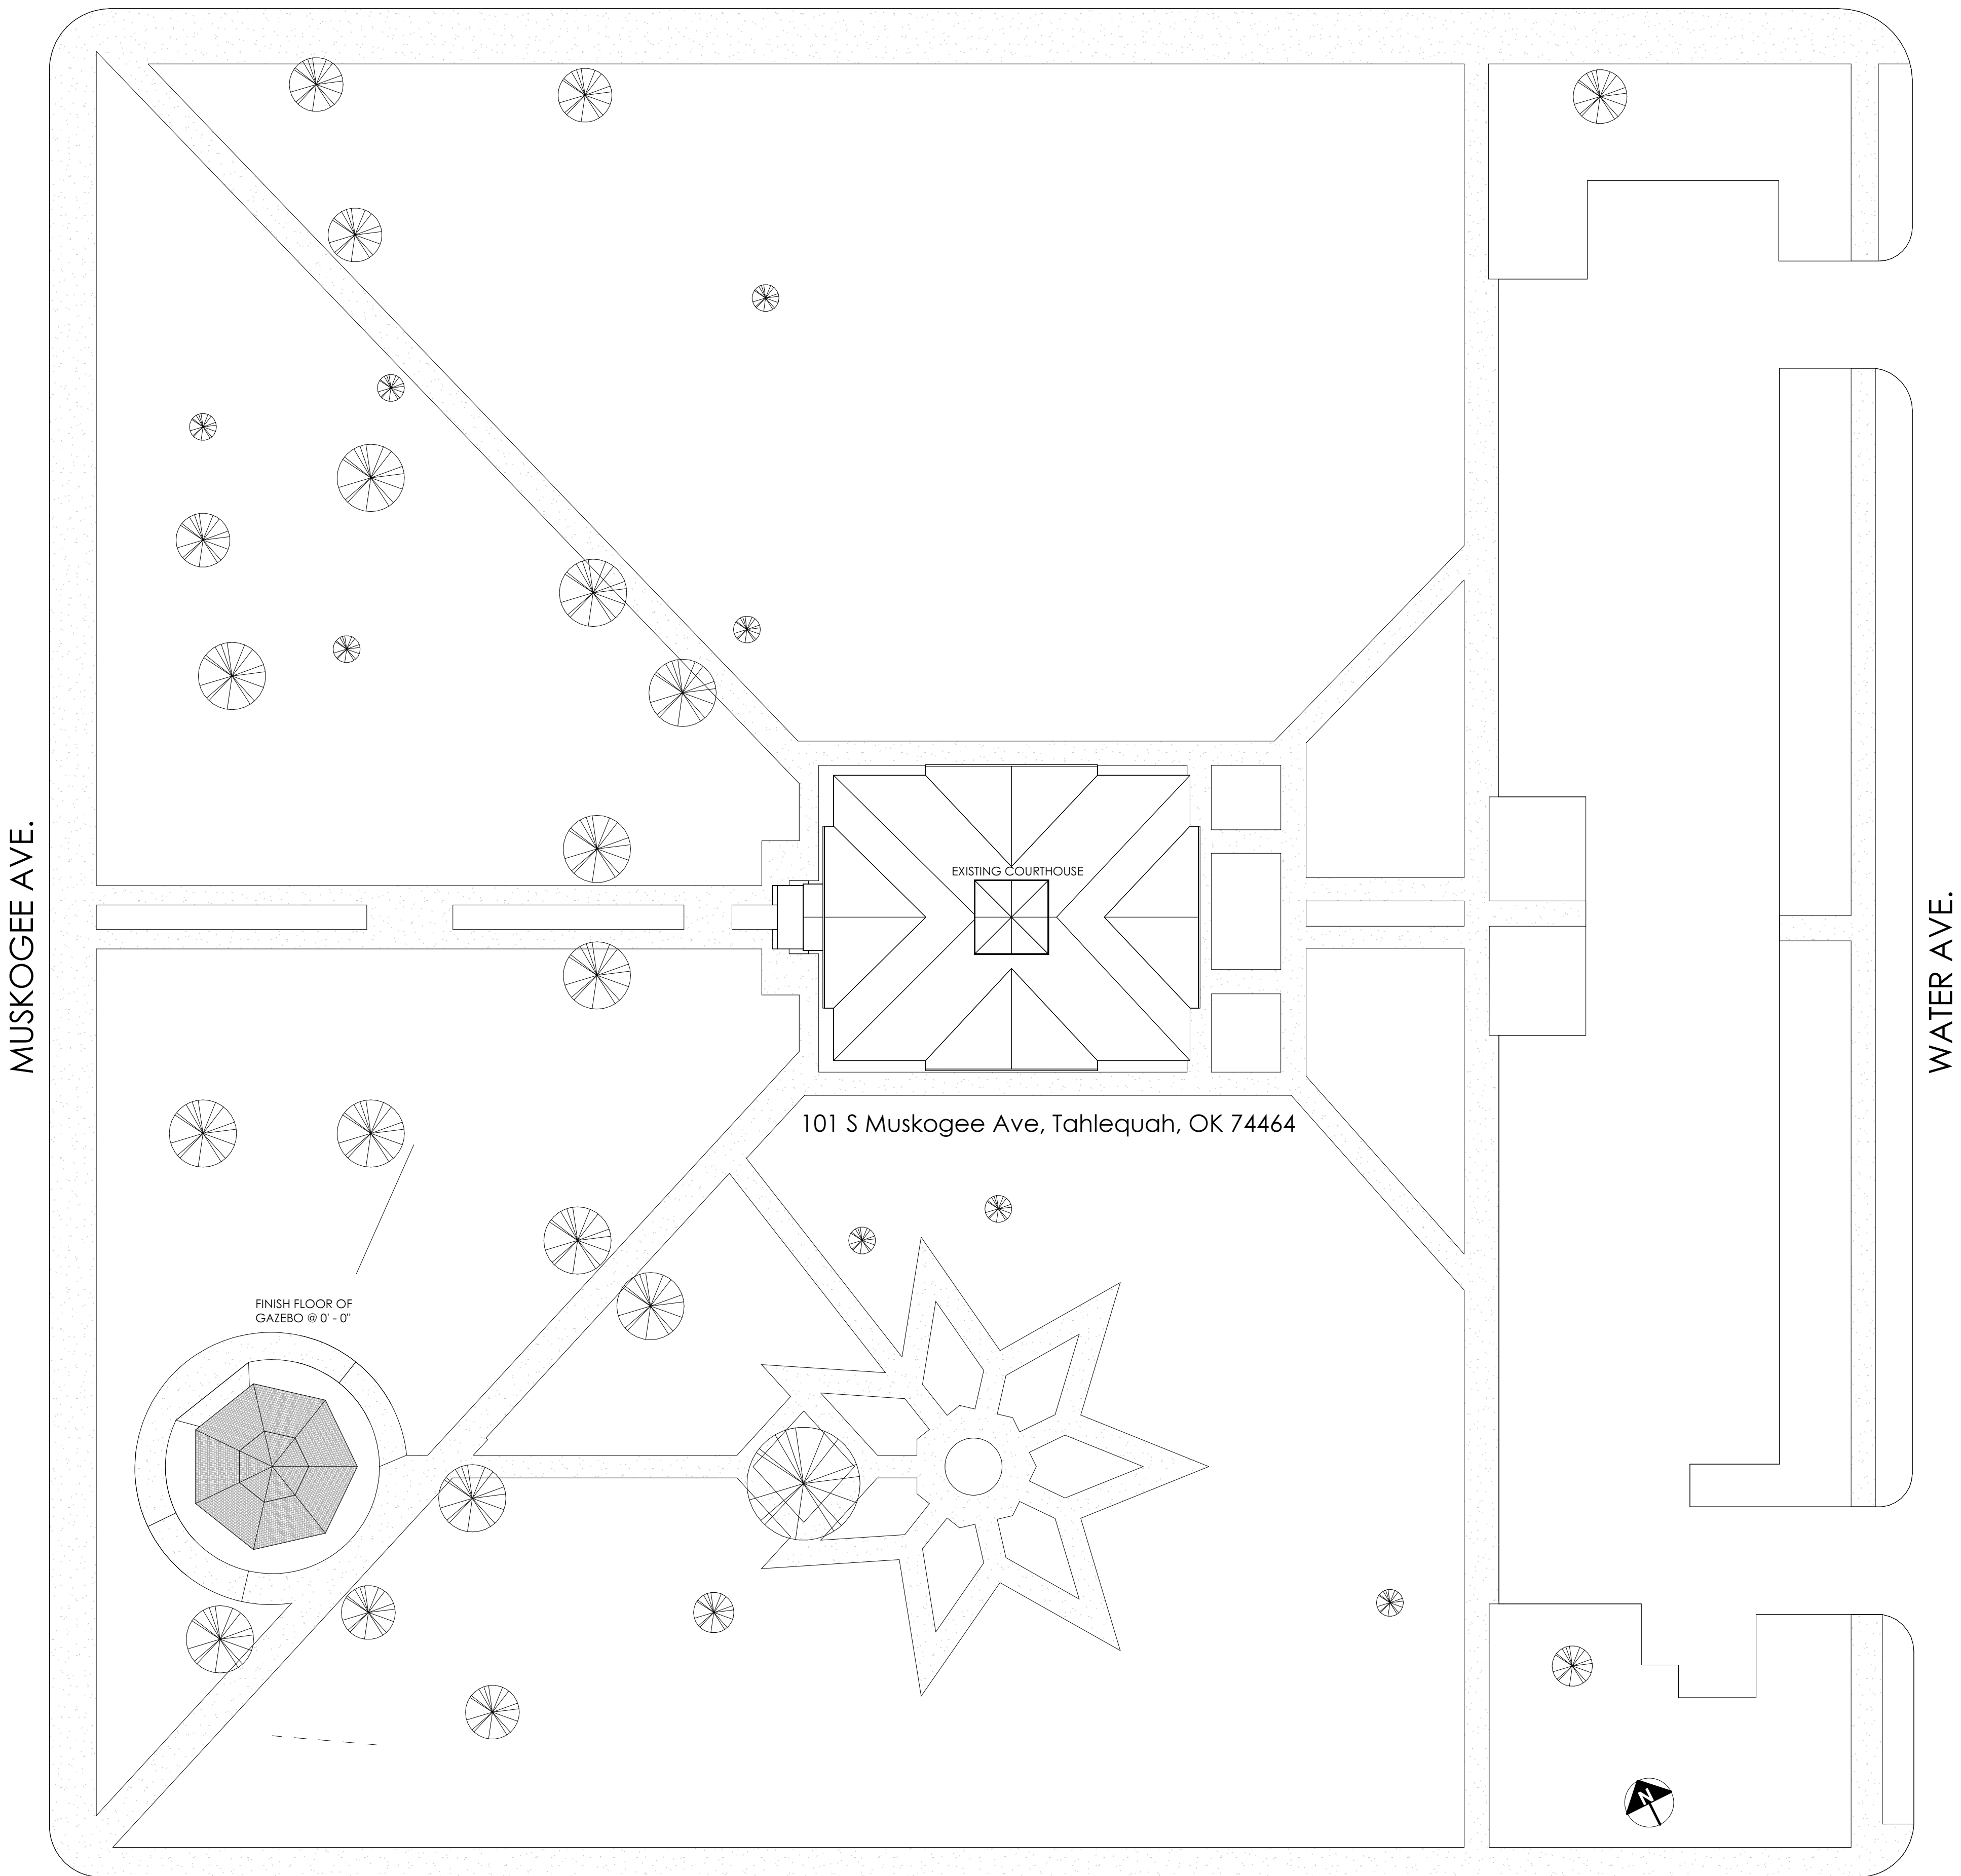

ARCHITECTURAL SITE PLAN
1" = 20'-0"

E. KEETOOWAH ST.

WATER AVE.

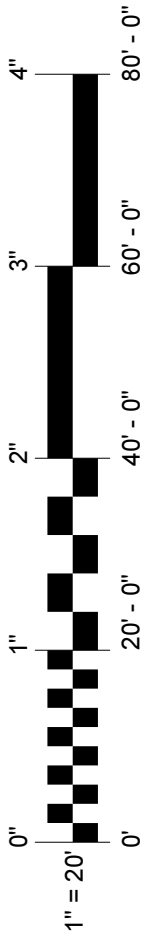



100% CONSTRUCTION
DOCUMENTS

PROJECT NO. 01-1335

SHEET TITLE: COVER SHEET

DRAWN BY: Author
CHECKED BY: Checker
ISSUE DATE: 6-23-2014

G000

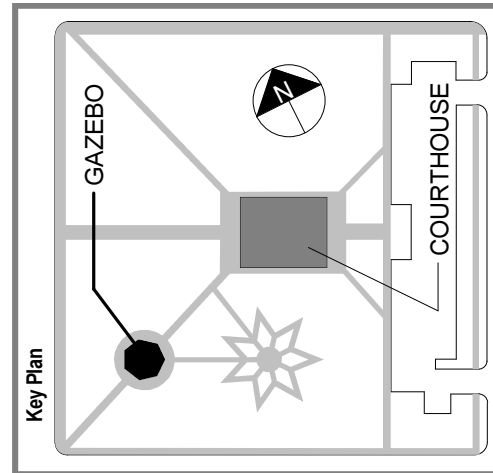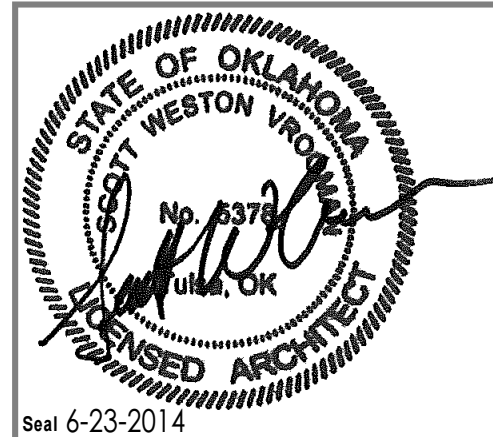

CHEROKEE GAZEBO

CHEROKEE NATION
101 S Muskogee Ave, Tahlequah, OK 74464

No.	Description	Date
1	REVISIONS	

Consultants

ABBREVIATIONS			
A		FRT	FIRE RETARDANT TREATED
AB	ANCHOR BOLT	FSR	FLEXIBLE SHEET ROOFING
A/C	AIR CONDITIONING	FT	FOOT/ FEET
ACP	ACOUSTICAL PANEL	FTG	FOOTING
AT	ACOUSTICAL TILE	FUR	FURRING
AD	AREA DRAIN		
ADH	ADHESIVE	G	
ADJ	ADJUSTABLE	GA	GAUGE
AFF	ABOVE FINISH FLOOR	GALV	GALVANIZED
AL	ALUMINUM	CS	GRAB BAR
ALT	ALTERNATE	GCMU	GLAZED CONCRETE MASONRY UNIT
AMB	AMBULATORY	GL	GLASS
ANSI	AMERICAN NATIONAL STANDARDS INSTITUTE	QD	GRADE
AP	ACCESS PANEL	GLT	GLAZED STRUCTURAL UNIT
APPROX	APPROXIMATE	GWB	GYPSUM WALL BOARD
ARCH	ARCHITECTURAL	GYP	GYPSUM
ASPH	ASPHALT		
AUTO	AUTOMATIC	H	
B		HB	HOSE BIBB
BBD	BULLETIN BOARDS	H/C	HANDICAPPED
BD	BOARD	HC	HOLLOW CORE
BT	BITUMINOUS	HD	HEAVY DUTY
BLDG	BUILDING	HDR	HEADER
BLDG	BLOCKING	HDW	HARDWARE
BM	BENCH MARK, BEAM	HK	HOCK
BRG	BEARING	HM	HOLLOW METAL
BTB	BACK TO BACK	HORZ	HORIZONTAL
BUR	BUILT-UP ROOFING	HP	HORSEPOWER
C		HR	HOUR
CA	CARPET/ CARPETING	HT	HEIGHT
CAB	CABINET	HVAC	HEATING, VENTILATING, AIR CONDITIONING
CB	CATCH BASIN	I	
CBB	CEMENTITIOUS BACKING BOARD	INSUL	INSULATION
CF	CUBIC FEET	INT	INTERIOR
CFM	CUBIC FEET PER MINUTE	J	
CG	CORNER GUARD	JAN	JANITOR'S CLOSET
CHBD	CHALKBOARD	JB	JUNCTION BOX
CI	CAST IRON	JOH	JAMB OPENING HEIGHT
CIP	CAST IN PLACE	JOW	JAMB OPENING WIDTH
CJ	CONTROL JOINT	K	
CL	CENTERLINE	KD	KNOCKDOWN
CLG	CEILING	KG	KILOGRAM
CLR	CLEARANCE	KIT	KITCHEN
CM	CONSTRUCTION MANAGER	KOC	KNOCKOUT
CMU	CONCRETE MASONRY UNIT	KVA	KILOVOLT AMPERES
COL	COLUMN	KW	KILOWATTS
CONC	CONCRETE	L	
CONF	CONFERENCE	L	LENGTH
CONST	CONSTRUCTION	LAM	LAMINATE(D)
CONT	CONTINUOUS	LAV	LAVATORY
CORR	CORRIDOR	LBS	POUNDS
C3MT	CASEMENT	LL	LIVE LOAD
CT	CERAMIC TILE	LLH	LONG LEG HORIZONTAL
CY	CUBIC YARD	LLV	LONG LEG VERTICAL
D		LVR	LOUVER
DBL	DRAIN	L/W	LIGHTWEIGHT
DEG	DEGREES	M	
DEMO	DEMOLISH, DEMOLITION	M	METER
DF	DRINKING FOUNTAIN	MAINT	MAINTENANCE
DH	DOUBLE HUNG	MAX	MAXIMUM
DIA	DIAMETER	MBR	MEMBRANE
DIAG	DIAGONAL	MC	MEDICINE CABINET
DIM	DIMENSION	MECH	MECHANICAL
DIV	DIVISION	MEZZ	MEZZANINE
DL	DEAD LOAD	MFR	MANUFACTURER
DN	DOWN	MH	MANHOLE
DP	DAMP PROOFING	MIN	MINIMUM
DR	DOOR	MI	MIRROR
DWS	DOWNSPOUT	MISC	MISCELLANEOUS
DWG	DRAWING	MSDB	MARKER BOARD
DWR	DRAWER	MDS	MOLDING
E		MM	MILLIMETER
E	EAST	MO	MASONRY OPENING
EB	EXPANSION BOLT	MPU	MULTIPURPOSE UNIT
EHD	ELECTRIC HAIR DRYER	MR	MOP RACK
EPS	EXTERIOR INSULATION FINISH SYSTEM	MTG	MOUNTING
EJ	EXPANSION JOINT	MTL	MATERIAL
EL	ELEVATION	MULL	MULLION
ELEC	ELECTRICAL	N	
ELEV	ELEVATOR	N	NORTH
ENGR	ENGINEER	NE	NORTHEAST
EQ	EQUAL	NIC	NOT IN CONTRACT
EQUIP	EQUIPMENT	NOM	NOMINAL
ES	EACH SIDE	NIS	NOT TO SCALE
EW	EACH WAY	NW	NORTHWEST
EW	ELECTRIC WATER COOLER	NPS	NOMINAL PIPE SIZE
EXH	EXHAUST	O	
EXP	EXPOSED	OC	ON CENTER
EXT	EXTERIOR	OD	OUTSIDE DIAMETER
EXIST	EXISTING	OH	OVERHEAD
F		OZ	OUNCE
FA	FIRE ALARM	P	
FBO	FURNISHED BY OWNER	PBD	PARTICLEBOARD
FB	FACE BRICK	P/C	PRECAST (CONCRETE)
FD	FLOOR DRAIN	PCF	POUNDS PER CUBIC FOOT
FE	FIRE EXTINGUISHER	PE	PORCELAIN ENAMEL
FEC	FIRE EXTINGUISHER CABINET	PEJ	PREFORMED EXPANSION JOINT
FF	FACTORY FINISH	PF	PREFABRICATED
FFE	FINISH FLOOR ELEVATION	PL	PLATE, PROPERTY LINE
FFL	FINISH FLOOR LINE	PLAM	PLASTIC LAMINATE
FHC	FIRE HOSE CABINET	PLBG	PLUMBING
FL	FLOOR FLOORING	PHL	PANEL(D)
FOC	FACE OF CONCRETE	PR	PAIR
FOF	FACE OF FINISH	PSF	POUNDS PER SQUARE FOOT
FORM	FACE OF MASONRY	PSI	POUNDS PER SQUARE INCH
FOS	FACE OF STUDS	PT	PAINT, POINT
FP	FIRE PROOF		
FRGB	FIRE RATED GYPSUM WALL BOARD		
		PART	PARTITION
		PVC	POLYVINYL CHLORIDE
		PVG	PAVING
		PWD	PLYWOOD
		R	
		R	RADIUS
		RA	RETURN AIR
		RB	RUBBER BASE
		RD	ROOF DRAIN
		REF	REFERENCE
		REFR	REFRIGERATOR
		REIN	REINFORCING/ REINFORCEMENT
		REQ	REQUIRED
		RES	RESILIENT
		REV	REVISION
		RFG	ROOFING
		RLG	RAILING
		RM	ROOM
		RO	ROUGH OPENING
		ROW	RIGHT-OF-WAY
		RPM	REVOLUTIONS PER MINUTE
		RTU	ROOF TOP UNIT (HVAC)
		RV	ROOF VENT PENETRATION
		S	
		S	SOUTH
		SATB	SOUND ATTENUATION BLANKET
		SC	SOLID CORE
		SCH	SCHEDULE
		SD	SOAP DISPENSER, STORM DRAIN
		SE	SOUTHEAST
		SECT	SECTION
		SF	SQUARE FOOT
		SGL	SAFETY GLASS
		SIM	SIMILAR
		SNR	SANITARY NAPKIN RECEPTACLE
		SNV	SANITARY NAPKIN VENDOR
		SP	SOUNDPROOF
		SPECS	SPECIFICATIONS
		SPK	SPEAKER
		SQ	SQUARE
		SR	SHOWER ROD
		SW	SERVICE SINK/
		SS	STAINLESS STEEL
		ST	STREET
		STD	STANDARD
		STG	SEATING
		STL	STEEL
		STOR	STORAGE
		SIP	STANDPIPE
		STRUC	STRUCTURAL
		SW	SOUTHWEST
		SYM	SYMMETRICAL
		SYS	SYSTEM
		T	
		TB	TOWEL BAR
		T/C	TOP OF CURB
		TD	TOWEL DISPENSER
		TDW	TOWEL DISPENSER & WASTE
		TE	TELEPHONE
		TEMP	TEMPERATURE
		TH	TEMPERED GLASS
		THK	TOWEL HOOK
		THR	THICKNESS
		THR	THRESHOLD
		TBD	TACK BOARD
		TL	TOILET
		TOPO	TOPOGRAPHY MAP
		T/P	TOP OF PARAPET
		TID	TOILET TISSUE DISPENSER
		TRT	TREATED (PRESERVATIVE)
		T/S	TOP OF SLAB
		T/STL	TOP OF STEEL
		TV	TELEVISION
		T/W	TOP OF WALL
		TYP	TYPICAL
		TZ	TERRAZZO
		T&B	TOP AND BOTTOM
		T&G	TONGUE AND GROOVE
		U	
		UC	UNDERCUT
		UH	UNIT HEATER
		UNFIN	UNFINISHED
		UR	URNAL
		US	UTILITY SHELF
		UTIL	UTILITY
		V	
		V	VENT
		VB	VAPOR BARRIER
		VCT	VINYL COMPOSITION TILE
		VERT	VERTICAL
		VIN	VINYL (SHEET)
		VJ	V-JOINTED(ED)
		VOL	VOLUME
		VT	VINYL TILE
		VNC	VINYL WALLCOVERING
		W	
		W	WEST WIDTH
		W/	WITH
		WC	WATER CLOSET
		WD	WOOD
		WGL	WIRE GLASS
		WH	WATER HEATER
		WM	WIRE MESH
		W/O	WITHOUT
		WP	WATERPROOFING
		WR	WASTE RECEPTACLE
		WSCT	WAINSCOT
		WT	WEIGHT
		WWF	WELED WIRE FABRIC
		Y	
		Y	YARD

SYMBOLS LEGEND			
	Column Grid Lines		View Identification
	Window Type		View Scale
	Door Number		Interior Elevation Identification
	Room Number and Name		Sheet on which Interior Elevation is drawn
	Elevation Height in Section View or Elevation View		Sheet Number
	Elevation in Plan View		Drawing Category:
	Wall Type		Discipline:
	Fire Extinguisher in Cabinet		Area, See Key Plan (If Used)
	Section Identification		Fire Separation Wall
	Indicates drawing is Similar		2 hr. Rated
	Drawing Number on Sheet		Fire Separation Wall
	Sheet on which Section is drawn		1 hr. Rated
	No. of Revision		Smoke Barrier
	Revision Cloud		1 hr. Rated
	View Identification		Non Rated Smoke Partition
	Sheet on which Exterior Elevation is drawn		

SITE FINISHING, TYPICAL


ALL DISTURBED SOIL ON SITE TO HAVE BERMUDA SOD INSTALLED. ALL SOIL TO BE PREPARED AS PER RECOMMENDATIONS OF SOD VENDOR. CONTRACTOR RESPONSIBLE FOR INITIAL IRRIGATION OF NEWLY INSTALLED SOD.

ALL NEW SIDEWALKS TO BE CLEANED AND WASHED IF NEEDED. ALL EXISTING SIDEWALKS THAT ARE DAMAGED OR SOILED DURING CONSTRUCTION TO BE REPAIRED AND CLEANED IF NEEDED.

ALL REMAINING TREES IN VICINITY OF NEW GAZEBO TO HAVE TEMPORARY FENCING AROUND DRIP LINE TO KEEP HEAVY EQUIPMENT FROM COMPACTING EARTH ON ROOTS. ALL MATERIALS FOR SITE TO BE LAID DOWN OUTSIDE OF DRIP LINE OF EXISTING TREES.

ALL NEW SIDEWALKS TO BE 3.5" THICK 3000 PSI CONCRETE WITH 6X6X6 WIRE THROUGHOUT.

MUSKOGEE AVE.

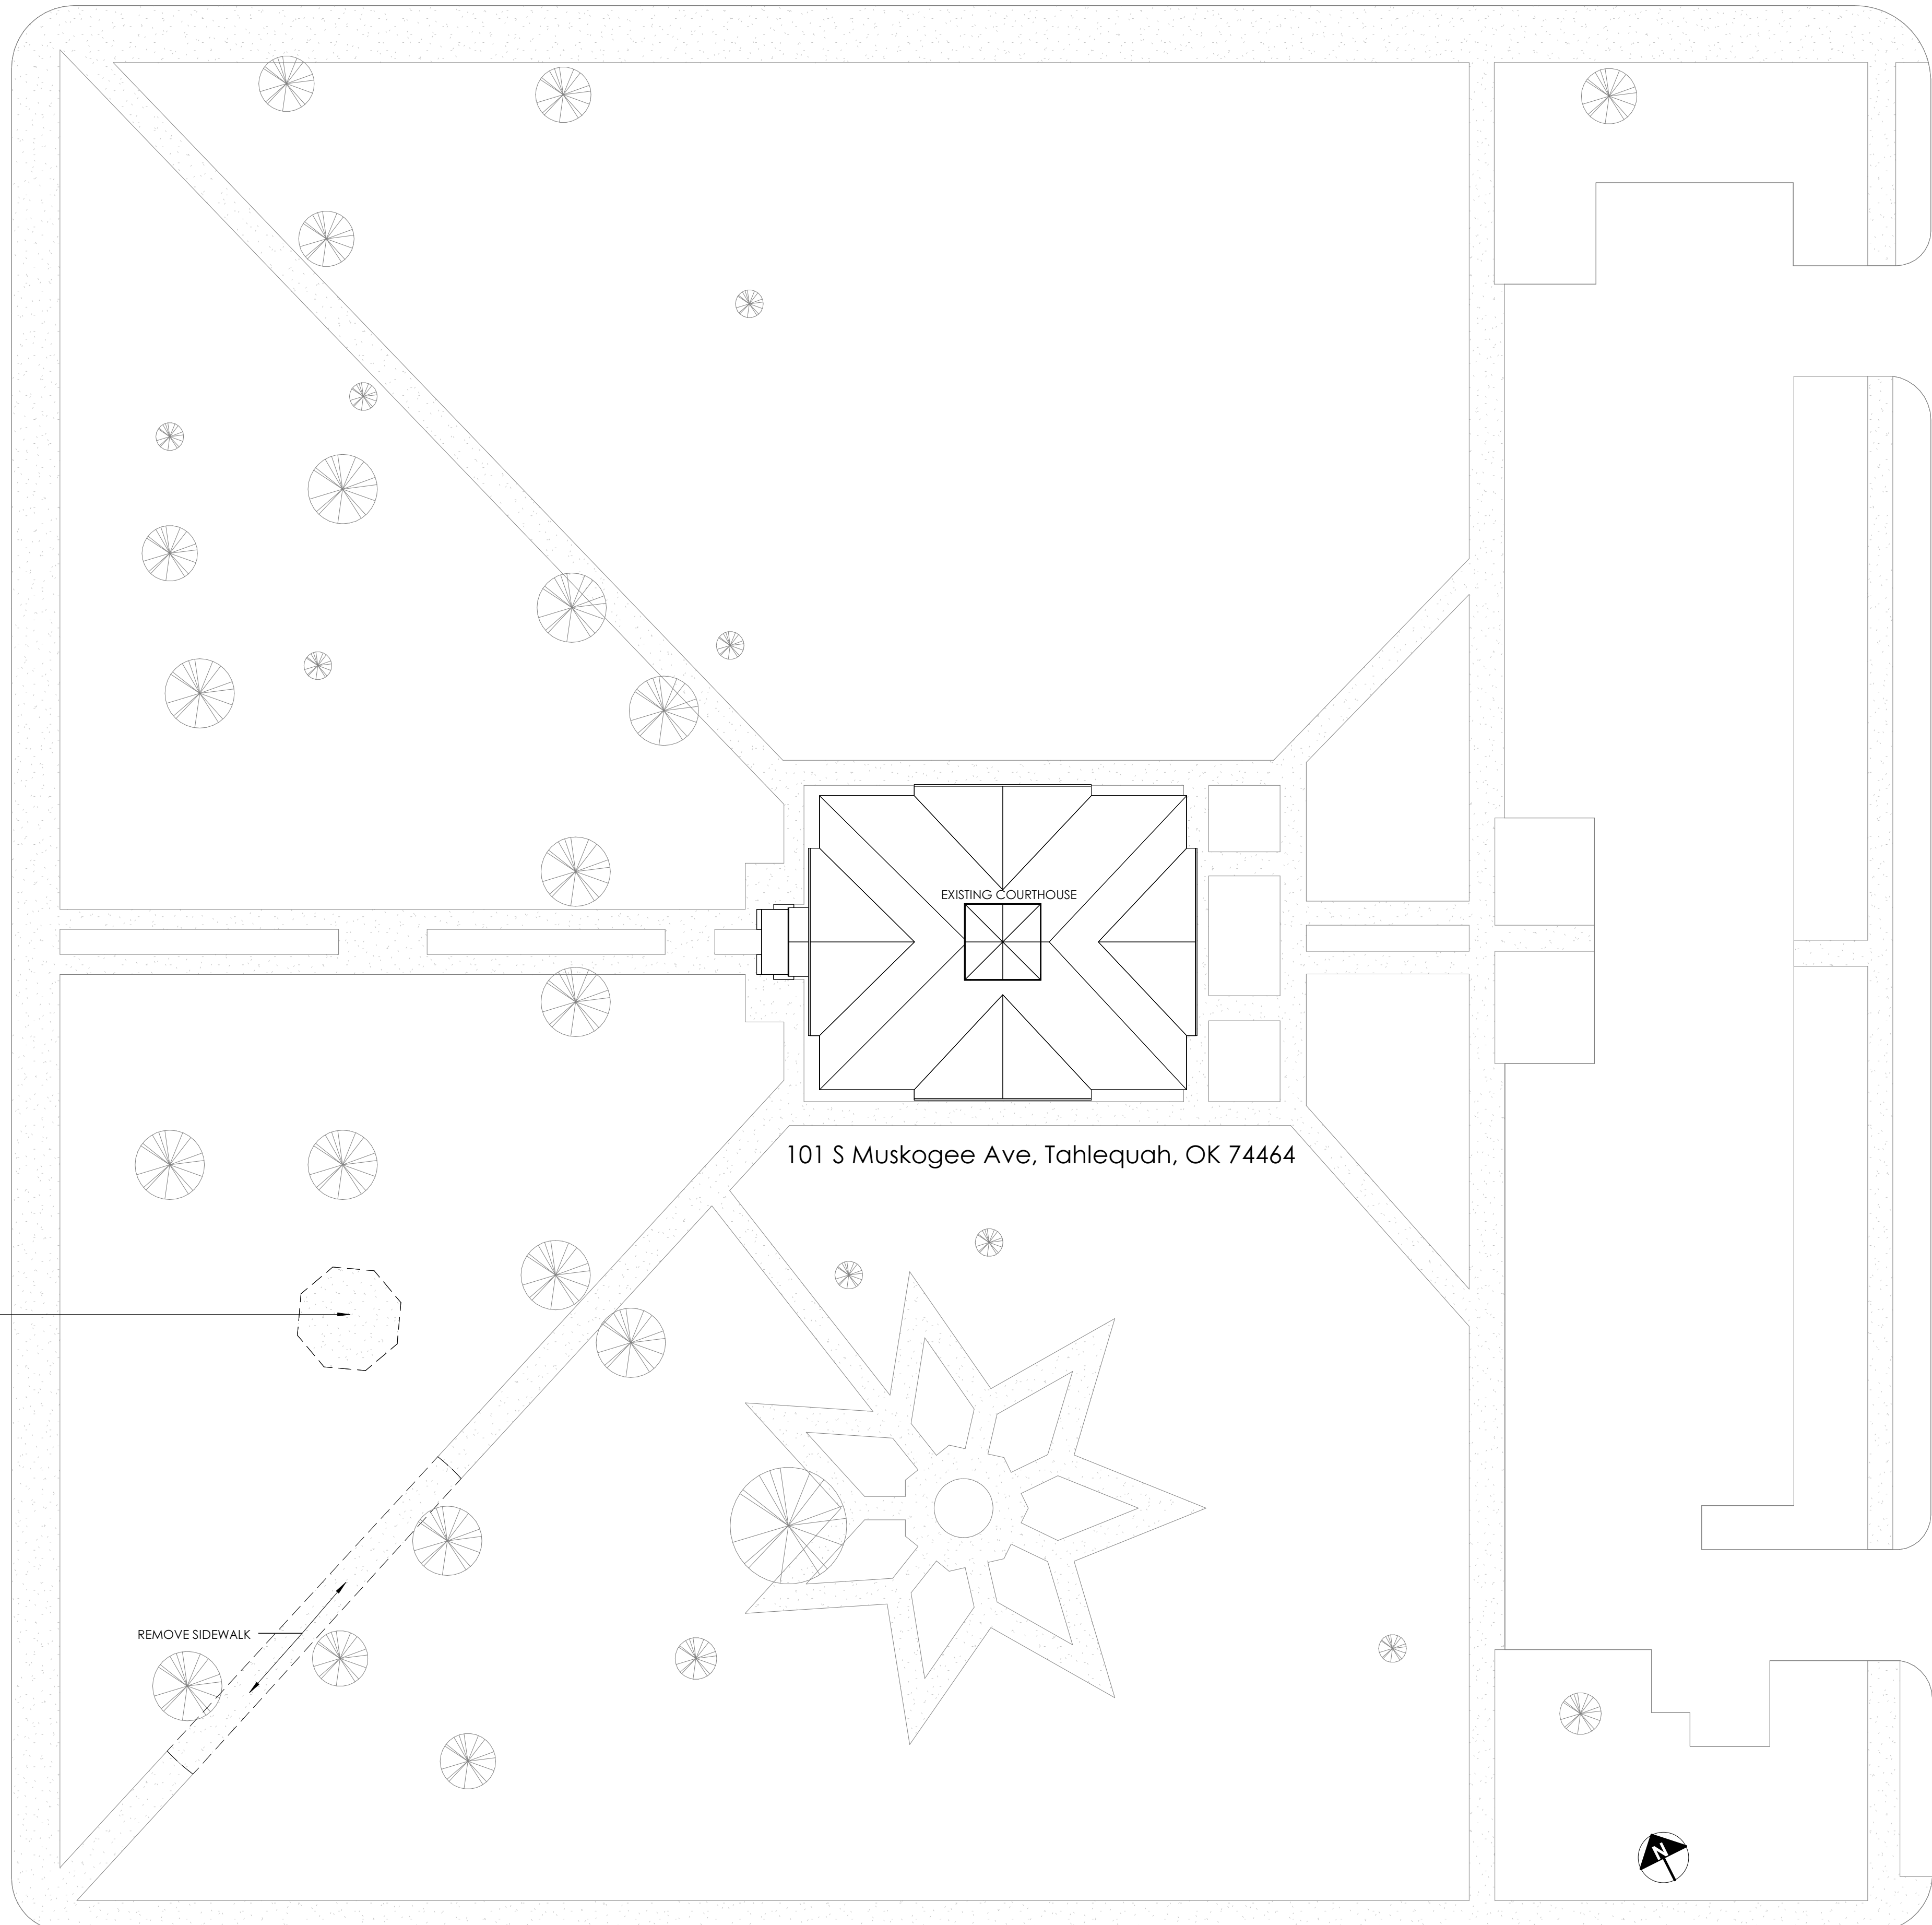

3 DEMOLITION SITE PLAN
1" = 20'-0"



No.	Description	Date
1		
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10		

REVISIONS

Consultants

CHEROKEE GAZEBO

CHEROKEE NATION
101 S Muskogee Ave, Tahlequah, OK 74464

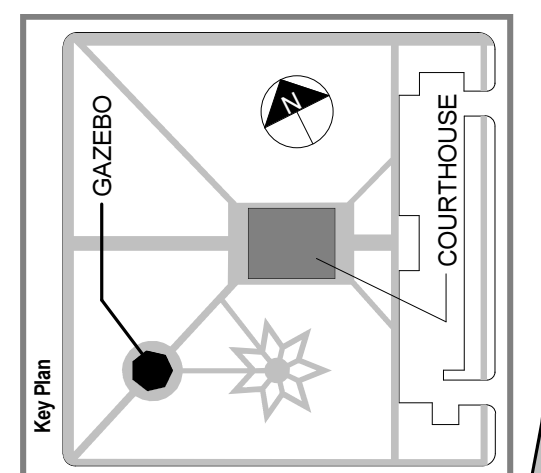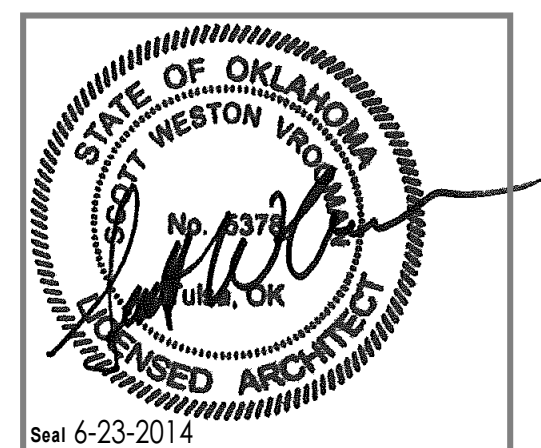

100% CONSTRUCTION
DOCUMENTS


PROJECT NO. 01-1035

SHEET TITLE: ABBREVIATIONS,
SYMBOLS &
DEMO SITE PLAN

DRAWN BY: Author
CHECKED BY: Checker
ISSUE DATE: 6-23-2014

G001


ALTA/ACSM LAND TITLE SURVEY
ALL OF BLOCK 75
OF THE CITY OF TAHLEQUAH,
CHEROKEE COUNTY, OKLAHOMA

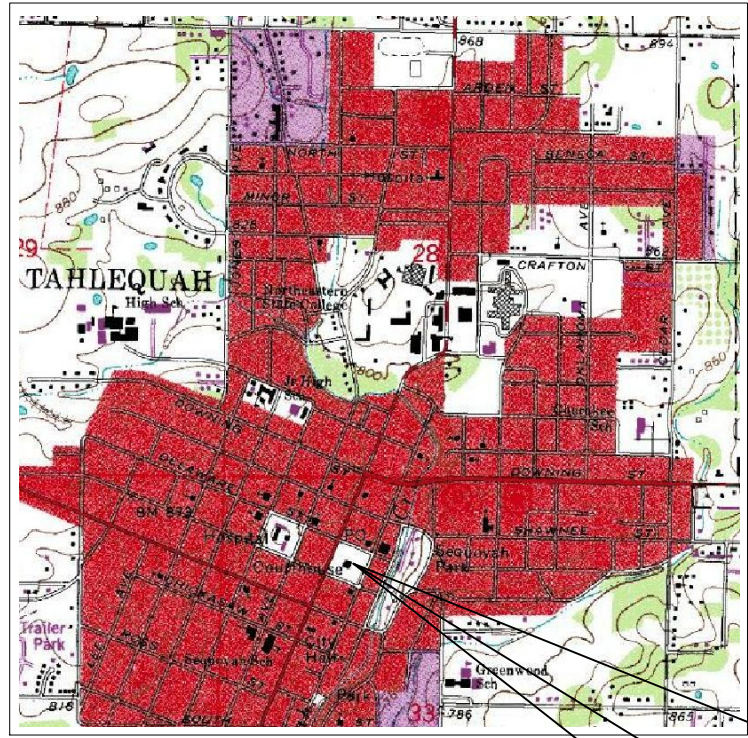


- LEGEND
- SECTION LINE
FENCE
WATER LINE
GAS LINE
ELECTRIC LINE
TELEPHONE LINE
IRON PIN
ELEVATION
EASEMENT LINE
- O V = WATER VALVE
● = WATER METER
GW = GUY WIRE
O PP = POWER POLE
X FH = FIRE HYDRANT
O MH = SEWER MANHOLE
MB = MAIL BOX
d = SIGN
■ = TELEPHONE PEDESTAL
☆ = LIGHT POLE
- -x-x-
-w-w-w-
-g-g-g-
-e-e-e-
-t-t-t-
● FND. O
□

VICINITY MAP

PROJECT

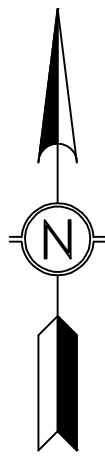

30' 0 30' 60' 90 Feet
SCALE 1" = 40'

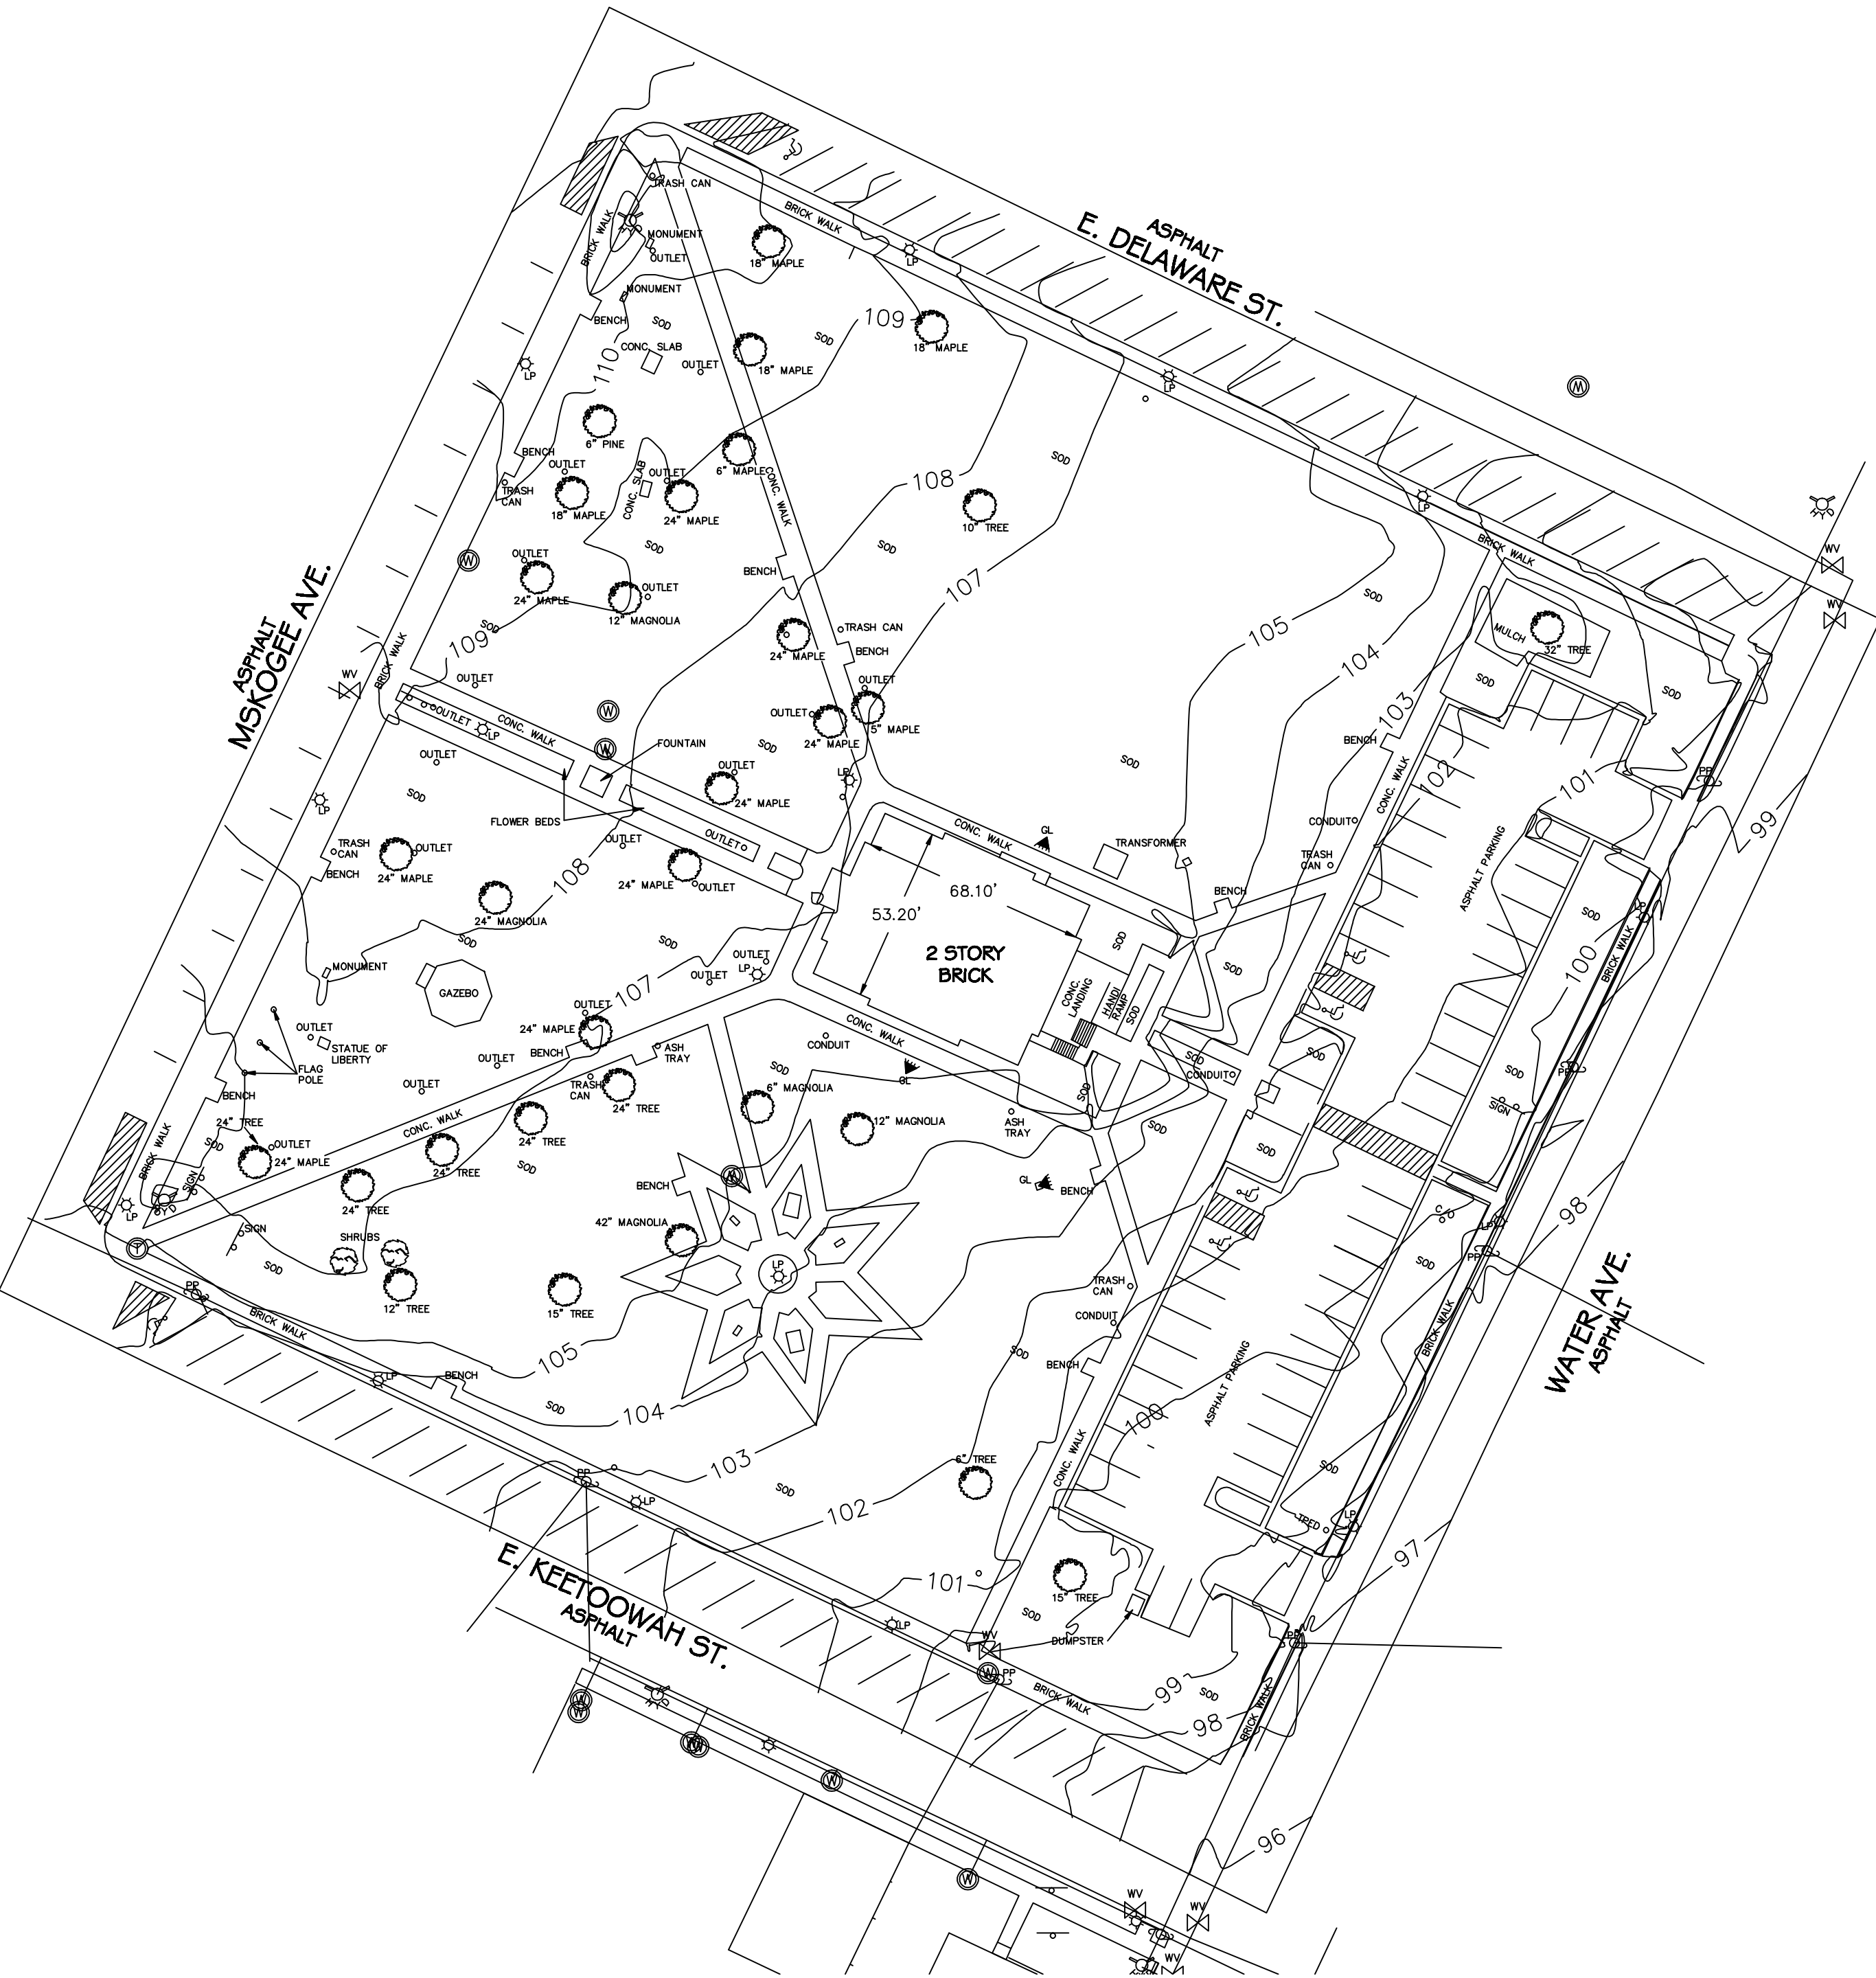

SUBJECT PROPERTY SHOWN TO BE LOCATED IN CHEROKEE COUNTY, OKLAHOMA.
AREAS DETERMINED TO BE OUTSIDE THE 500-YEAR FLOOD PLAIN
BASED ON FLOOD INSURANCE RATE MAP #40021C0093, EFFECTIVE MARCH 18, 1991 .

Land area as specified by the client. Area of land is 3.02 acres.

LEGAL DESCRIPTION:

All of Block 75, in the City of Tahlequah, Oklahoma, according to the Official Plat thereof, known as the Cherokee Supreme Court Building.

ELEV DATUM= LOCAL (CP-1 = 100)

THIS PLAT MEETS OR EXCEEDS THE OKLAHOMA MINIMUM STANDARDS FOR THE PRACTICE OF LAND SURVEYING AS ADOPTED BY THE OKLAHOMA STATE BOARD OF REGISTRATION FOR PROFESSIONAL ENGINEERS AND LAND SURVEYORS.

SURVEYORS CERTIFICATE:

State of Oklahoma
County of Cherokee

ALTA/ACSM LAND TITLE CERTIFICATION

To Cherokee Nation Enterprises, Cherokee Nation:
This is to certify that this map or plat and the survey on which it is based were made in accordance with the "Minimum Standard Detail Requirements for ALTA/ACSM Land Title Surveys," jointly established and adopted by ALTA and NSPS in 2005, and includes items 1,2,3,4,5,8,9,10,11(a) and 14 of Table A thereof. Pursuant to the Accuracy Standards as adopted by ALTA and NSPS and in effect on the date of this certification, undersigned further certifies that in my professional opinion, as a land surveyor registered in the State of Oklahoma, the Relative Positional Accuracy of this survey does not exceed that which is specified therein.

Date:

Basil E. Scott JR. PLS #545
CA. #1041 (PLS, PE) Exp. 6/30/09

SURVEYOR

SCOTT & ASSOCIATES, INC.
Land Surveyors & Engineers

CA. #1041 (PLS, PE) Exp. 6/30/09

901-B Callahan Street

Muskogee, OK 74403

Tel: (918) 682-7577

- AMERICAN LAND TITLE ASSOCIATION
TABLE A
- Monuments placed (or a reference monument or witness to the corner) at all major corners of the boundary of the property, unless already marked or referenced by an existing monument or witness to the corner.
 - Vicinity map showing the property surveyed in reference to nearby highway(s) or major street intersection(s). (SEE SURVEY)
 - Flood zone designation (with property annotation based on Federal Flood Insurance Rate Maps or the state or local equivalent, by scaled map location and graphic plotting only.) (SEE SURVEY)
 - Gross land area (and other areas if specified by client). (SEE SURVEY)
 - Contours and the datum of the elevations. (SEE SURVEY)
 - List setback, height, and floor space restrictions disclosed by applicable zoning or building codes (beyond those required under paragraph 5d of these standards). If none, so state. The source of such information must be disclosed. See "Note" above.
 - (a) Exterior dimensions of all buildings at ground level
(b) Square footage of:
(1) exterior footprint of all buildings at ground level;
(2) gross floor area of all buildings; or
(3) other areas to be defined by the client
(c) Measured height of all buildings above grade at a defined locations. If no defined location is provided, the point of measurement shall be shown.
 - Substantial, visible improvements (in addition to buildings) such as billboards, signs, parking structures, swimming pools, etc. (SEE SURVEY)
 - Parking areas and, if striped, the striping and the type (e.g. handicapped, motorcycle, regular, etc.) and number of parking spaces. (SEE SURVEY)
 - Indication of access to a public way such as curb cuts and driveways, and to and from waters adjoining the surveyed tract, such as boat slips, launches, piers and docks. (SEE SURVEY)
 - Location of utilities (representative examples of which are shown below) existing on or serving the surveyed property as determined by:
(a) Observed evidence (SEE SURVEY)
(b) Observed evidence together with plans and markings provided by client, and markings by utility companies, and other appropriate sources (with reference as to the source of information) (SEE PLAT)

railroad tracks and sidings;

manholes, catch basins, valve vaults or other surface indications of subterranean uses;

wires and cables (including their function) crossing the surveyed premises, all poles on or within ten feet of the surveyed premises, and the dimensions of all crossmembers or overhangs affecting the surveyed premises; and

utility company installations on the surveyed premises.
 - Governmental Agency survey-related requirements as specified by the client. (SEE PLAT)
 - Names of adjoining owners of plotted lands.
 - The distance to the nearest intersecting street as designated by the client ON SITE
 - Rectified orthophotography, photogrammetric mapping, laser scanning and other similar products, tools or technologies may be utilized as the basis for the location of certain features (excluding boundaries) where ground measurements are not otherwise necessary to locate those features to an appropriate and acceptable accuracy relative to a nearby boundary. The surveyor shall (a) discuss the ramifications of such methodologies (e.g. the potential accuracy and completeness of the data gathered thereby) with the title company, lender and client prior to the performance of the survey and, (b) place a note on the face of the survey explaining the source, date, relative accuracy and other relevant qualifications of any such data. N/A
 - Observable evidence of earth moving work, building construction or building additions within recent months.
 - Any changes in street right of way lines either completed or proposed, and available from the controlling jurisdiction. Observable evidence of recent street or sidewalk construction or repairs.
 - Observable evidence of site use as a solid waste dump, sump or sanitary landfill.

Cherokee Capital Building


Cherokee County, Oklahoma

CHK'D BY: B.E.S.
DATE:


SURVEYED BY: L.F.
DATE: 04/21/08

DRAWN BY: S.F.P.
DATE: 04/23/08


C100 - EXISTING SITE

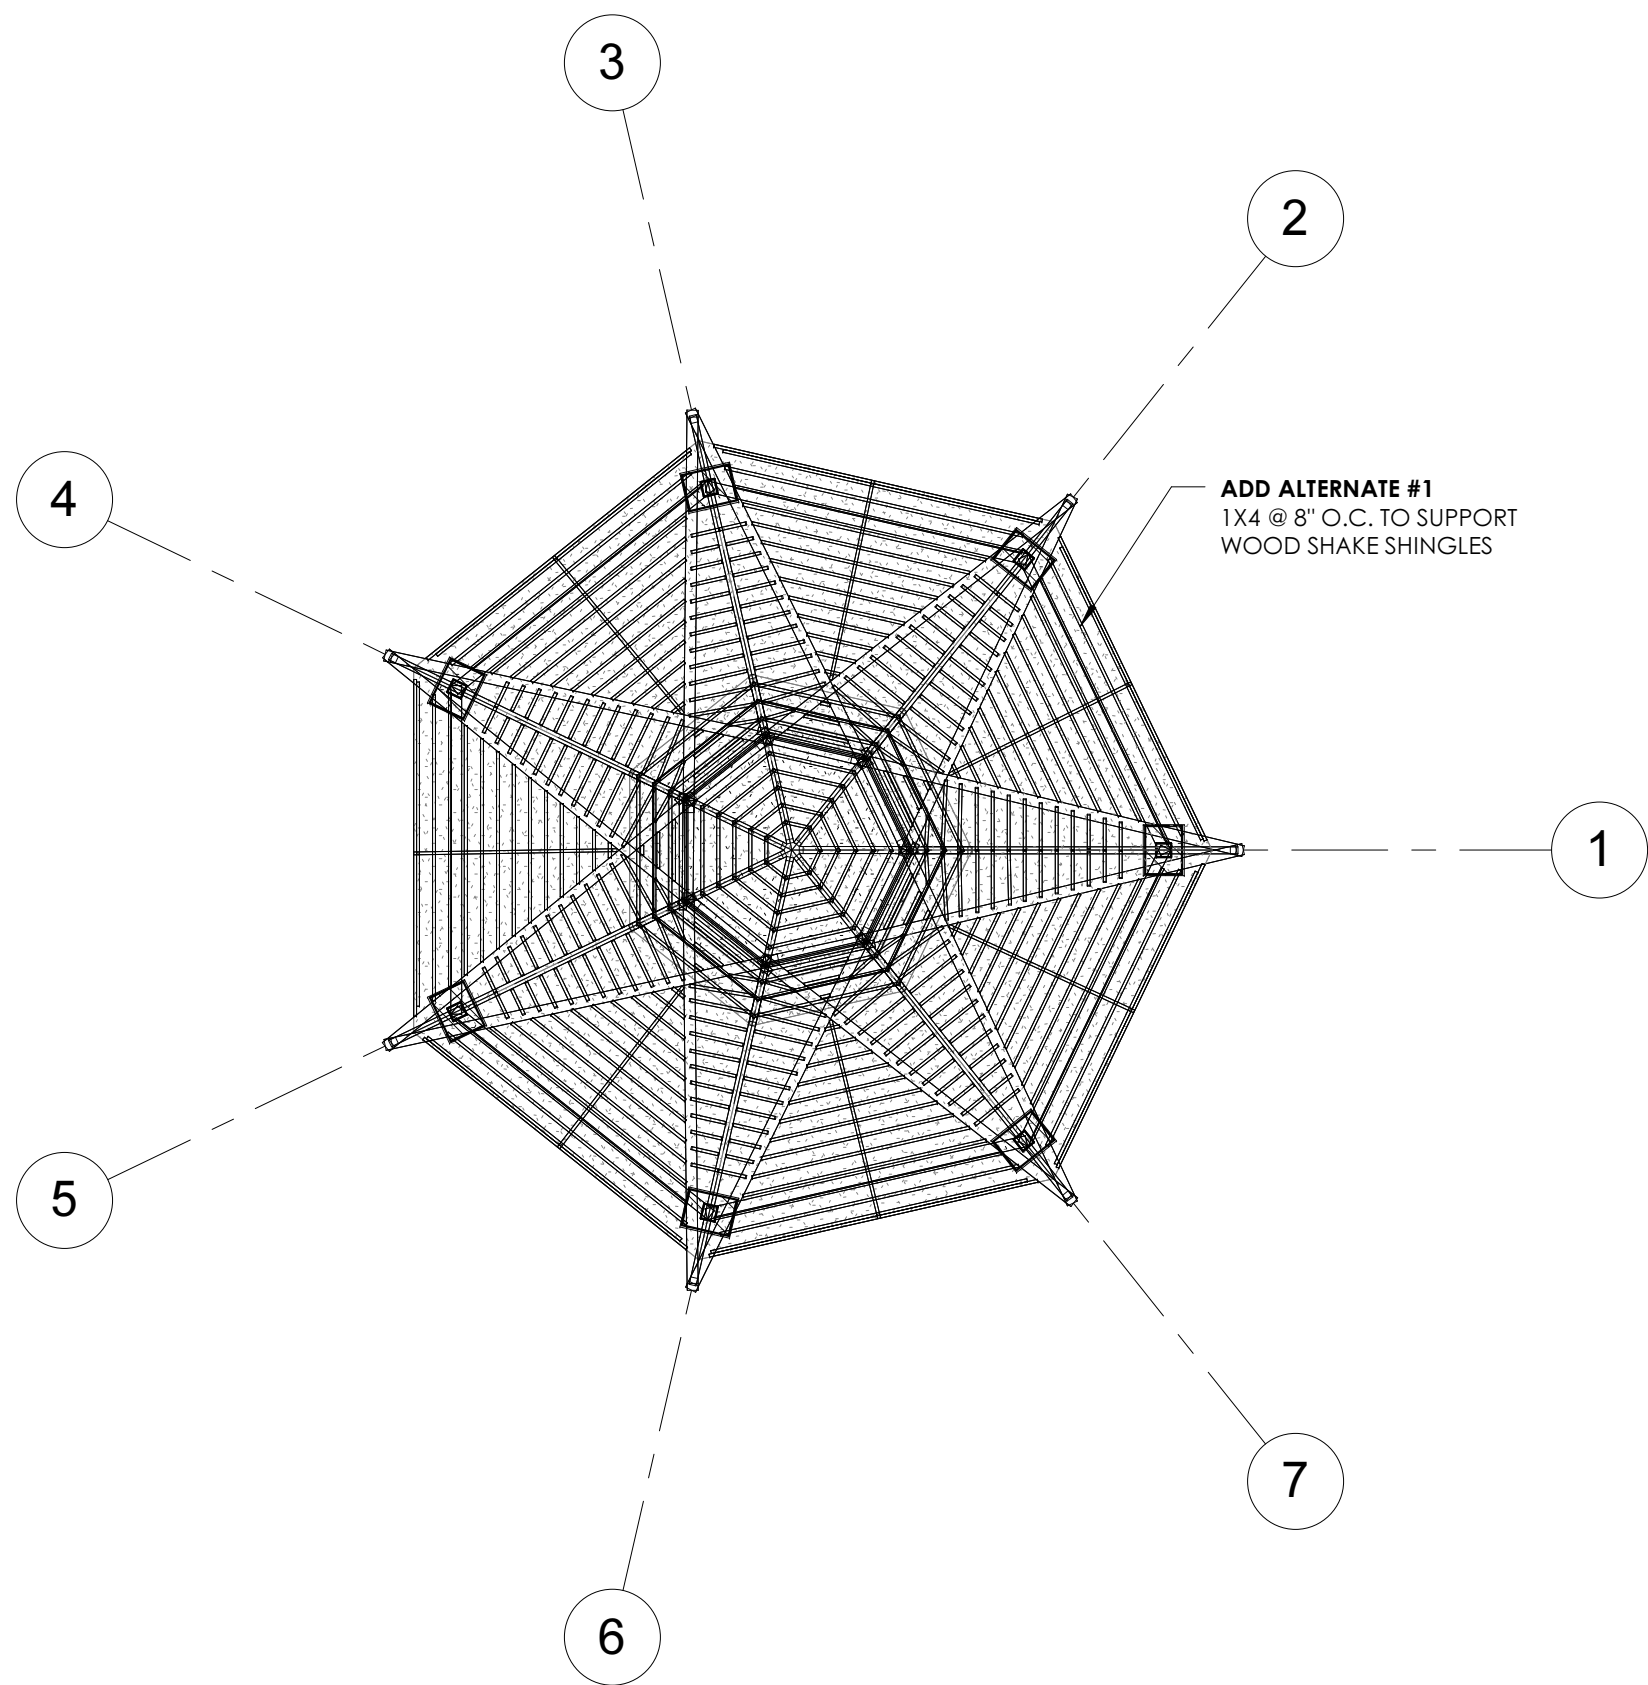


3 REFLECTED CEILING PLAN
1/8" = 1'-0"

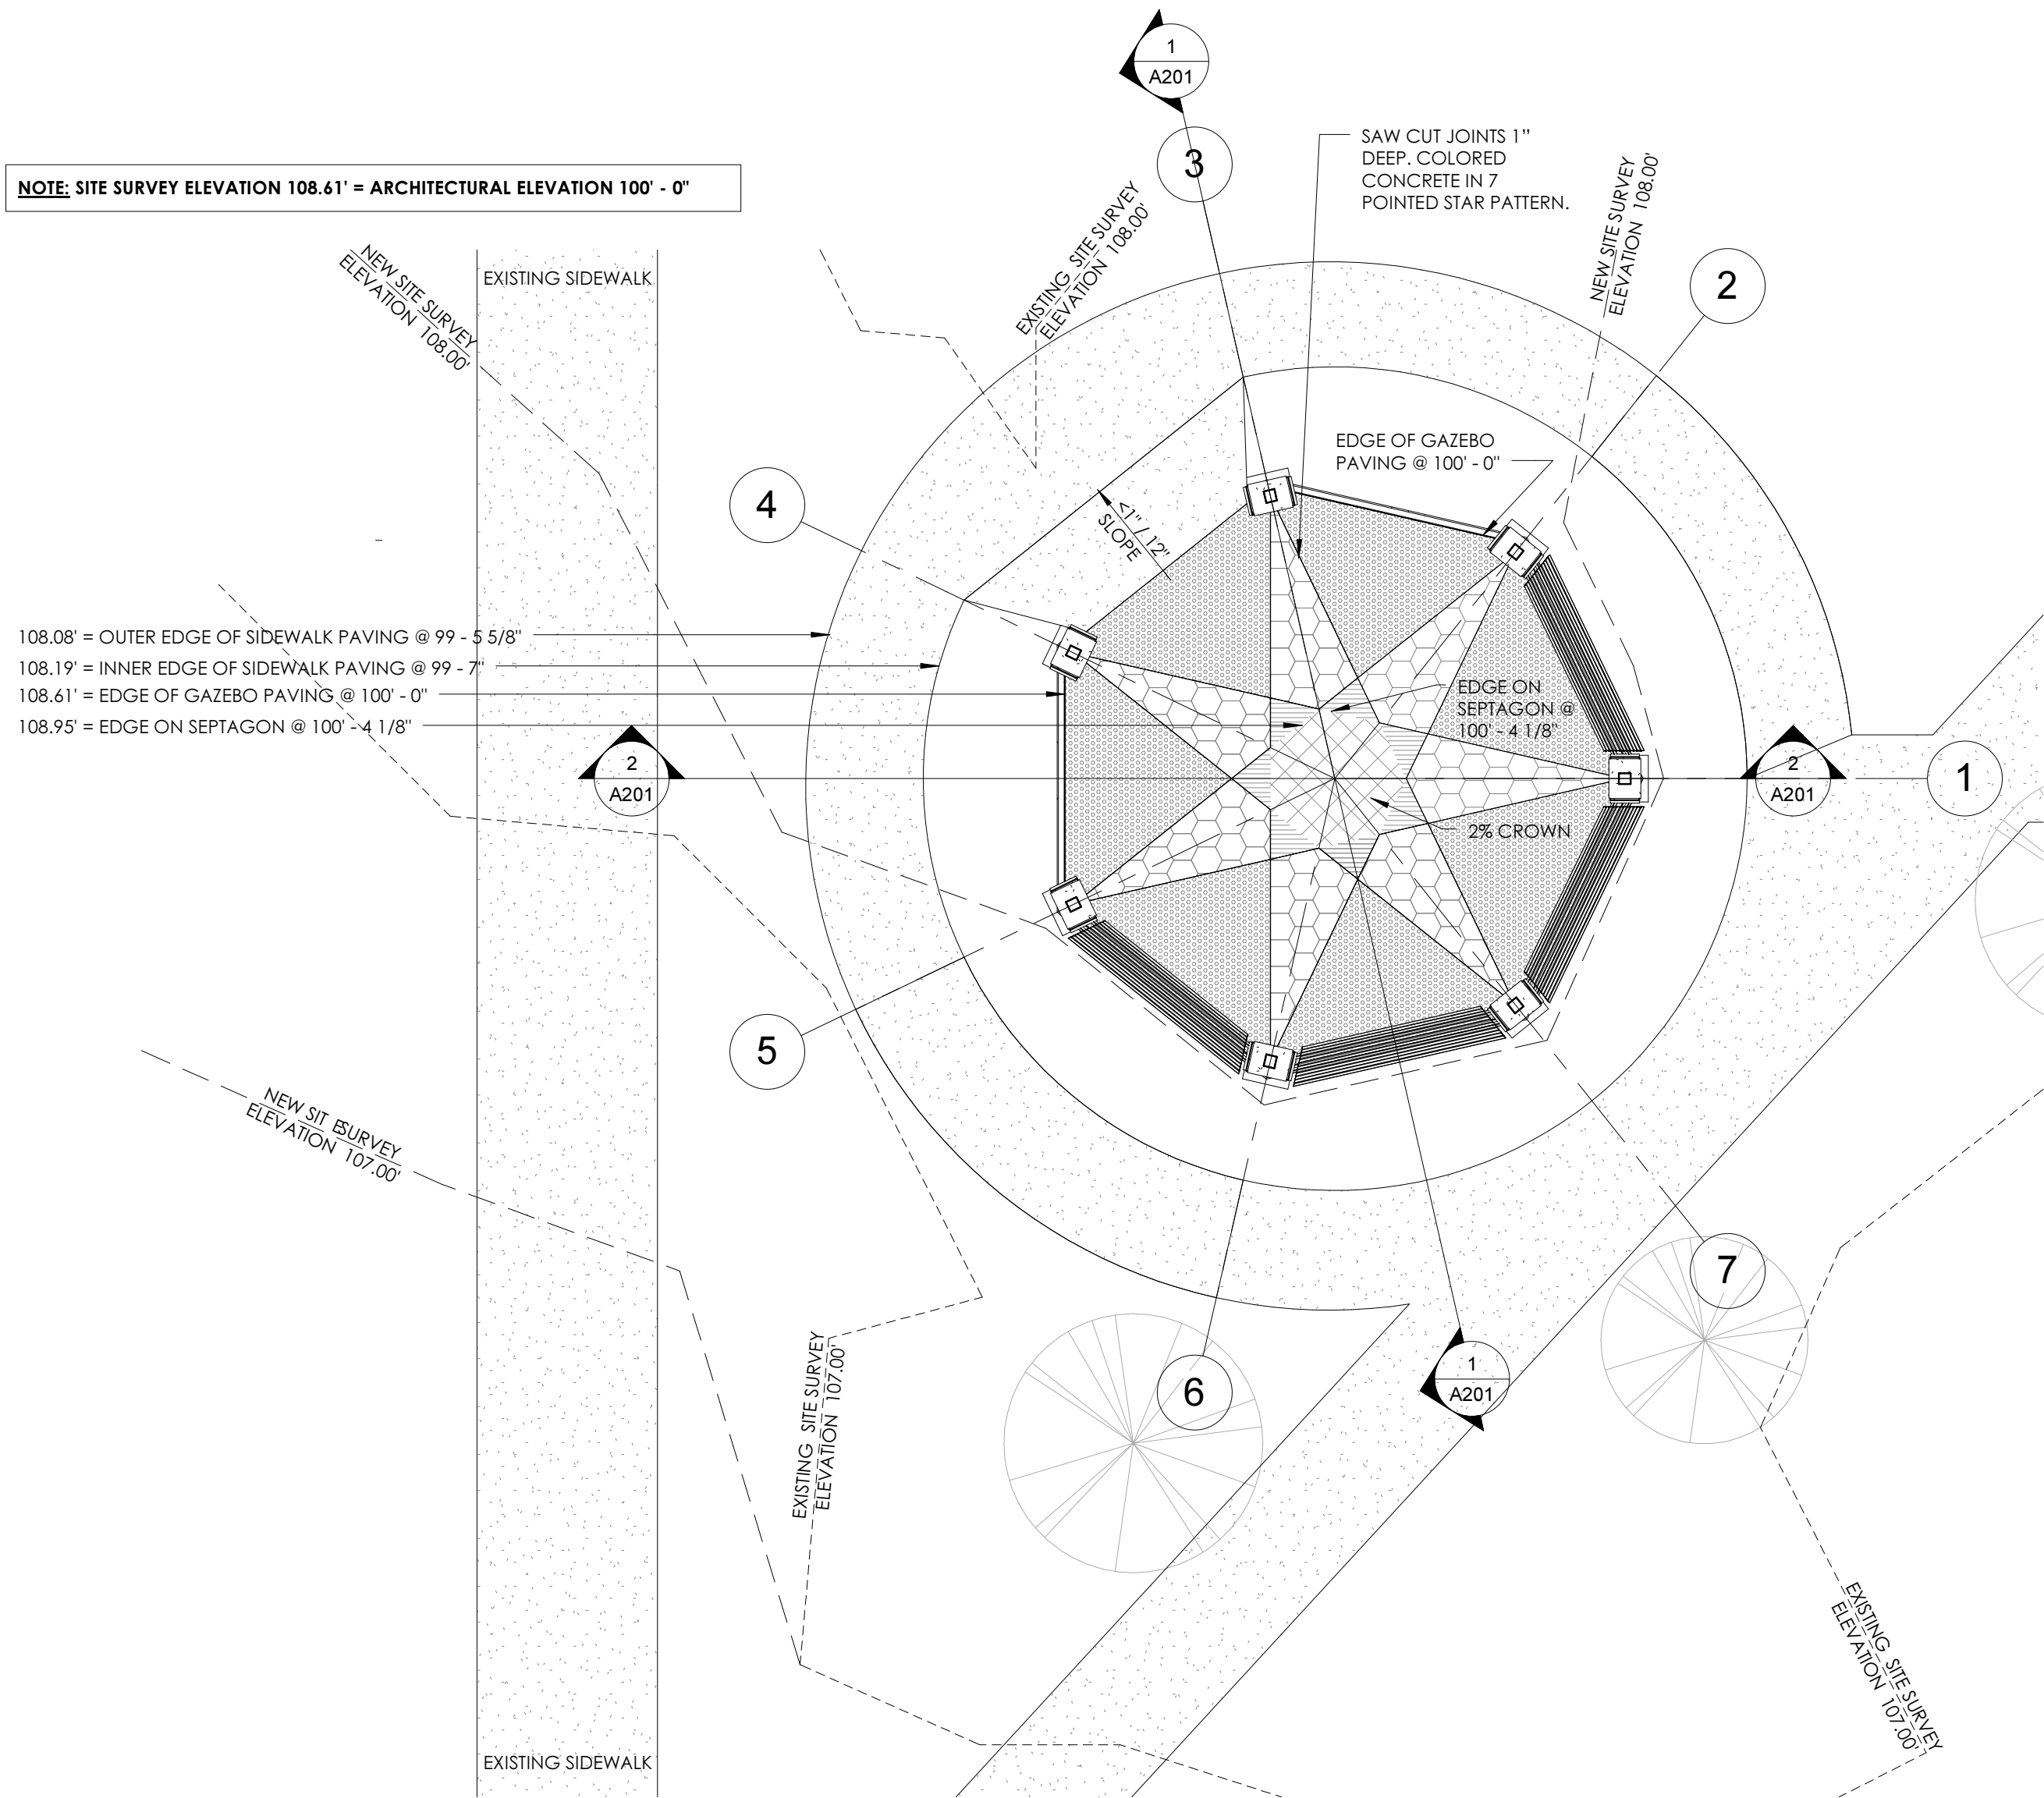

1 GRADING, PAVING & FLOOR PLAN
1/8" = 1'-0"

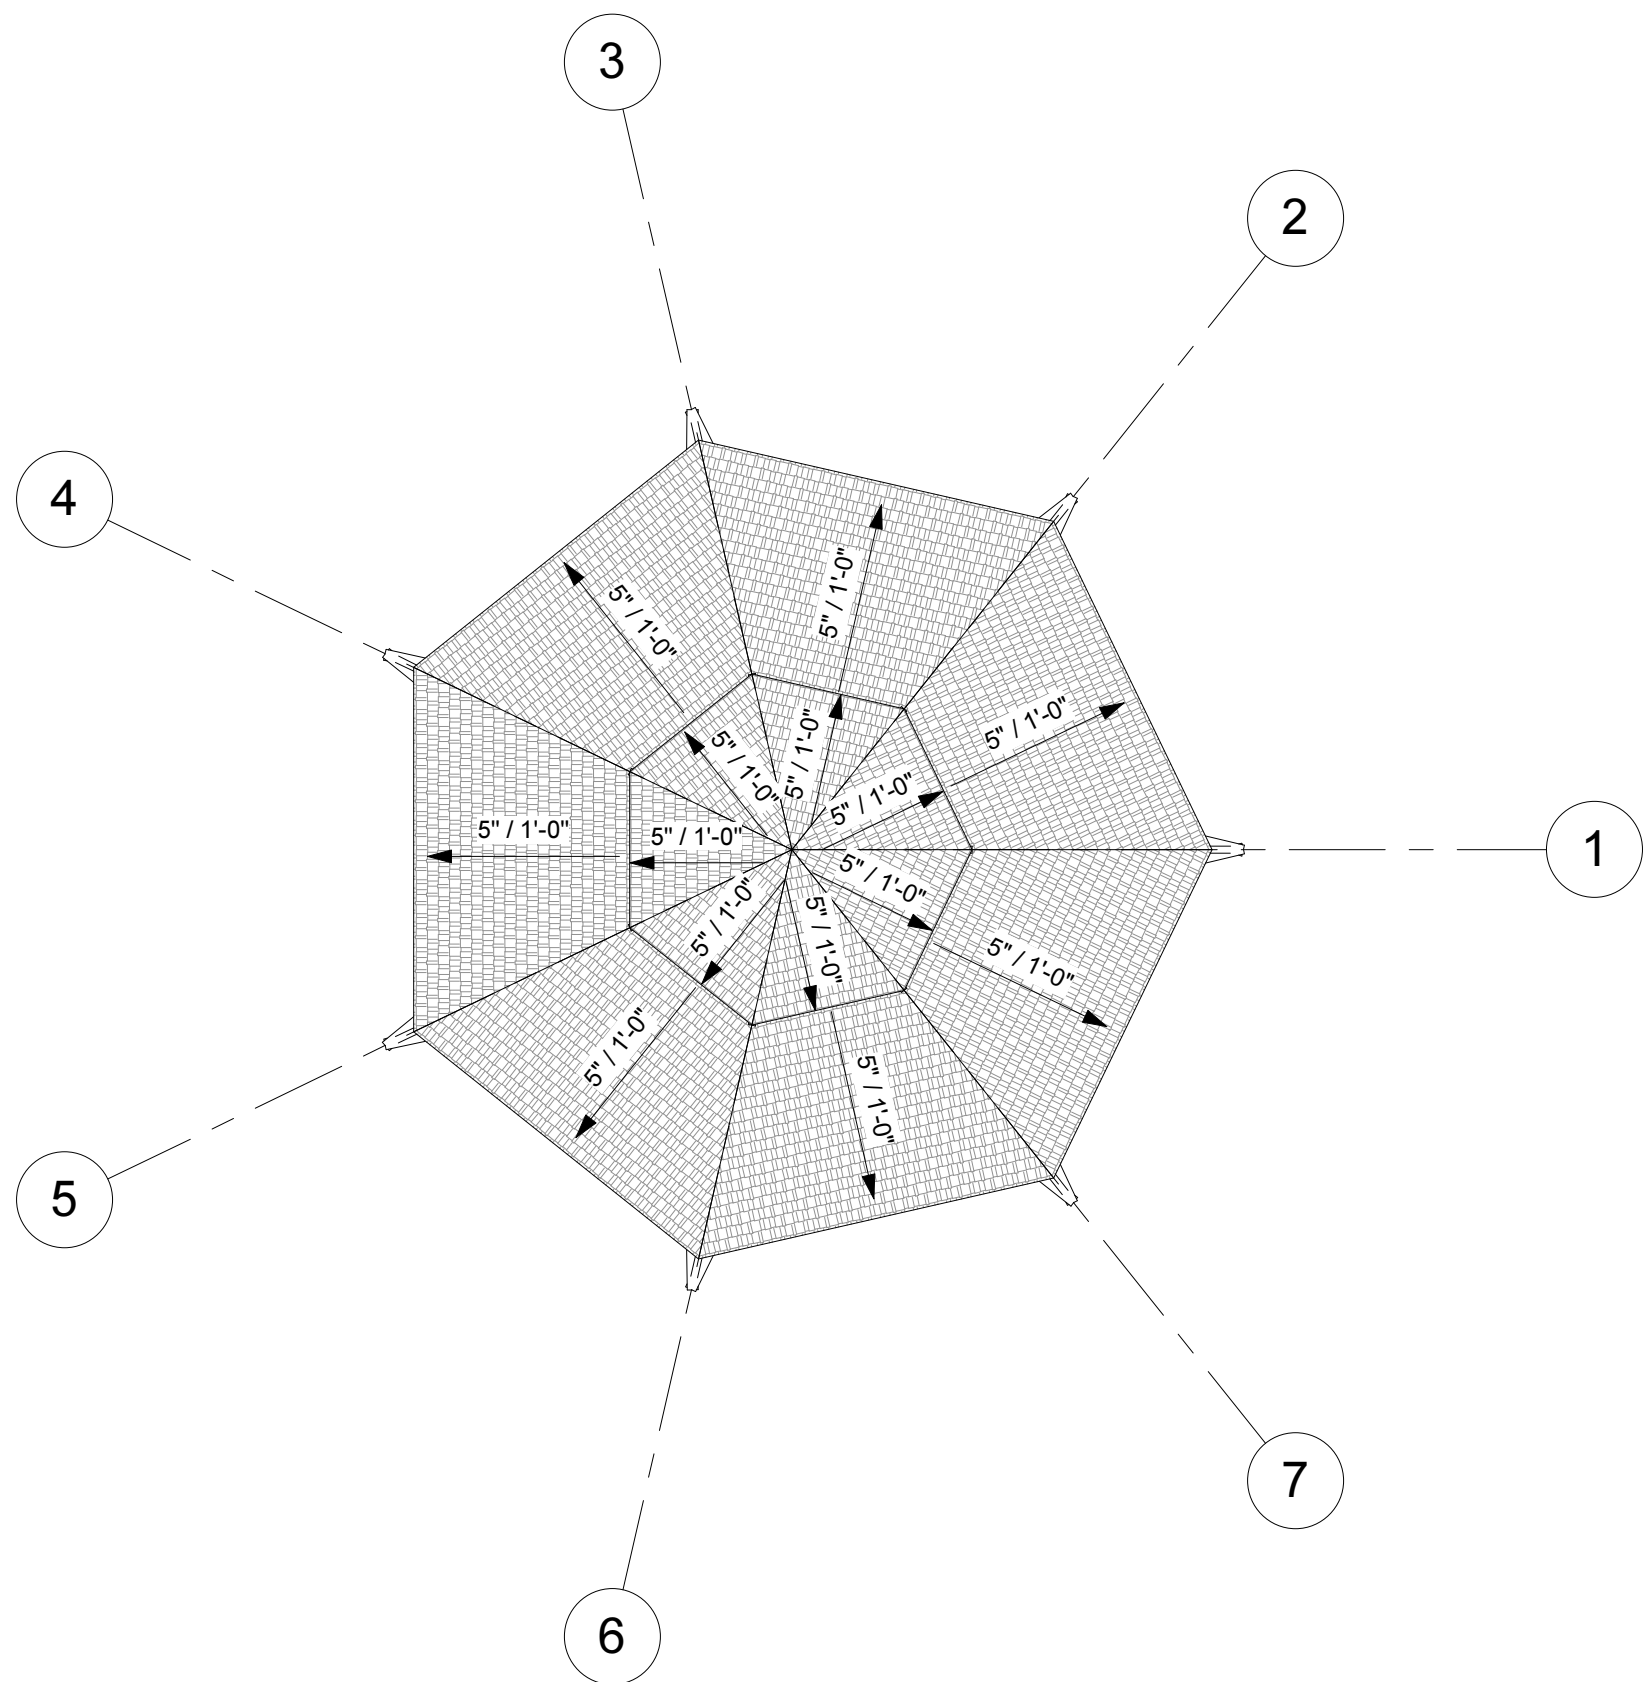

4 ROOF PLAN
1/8" = 1'-0"

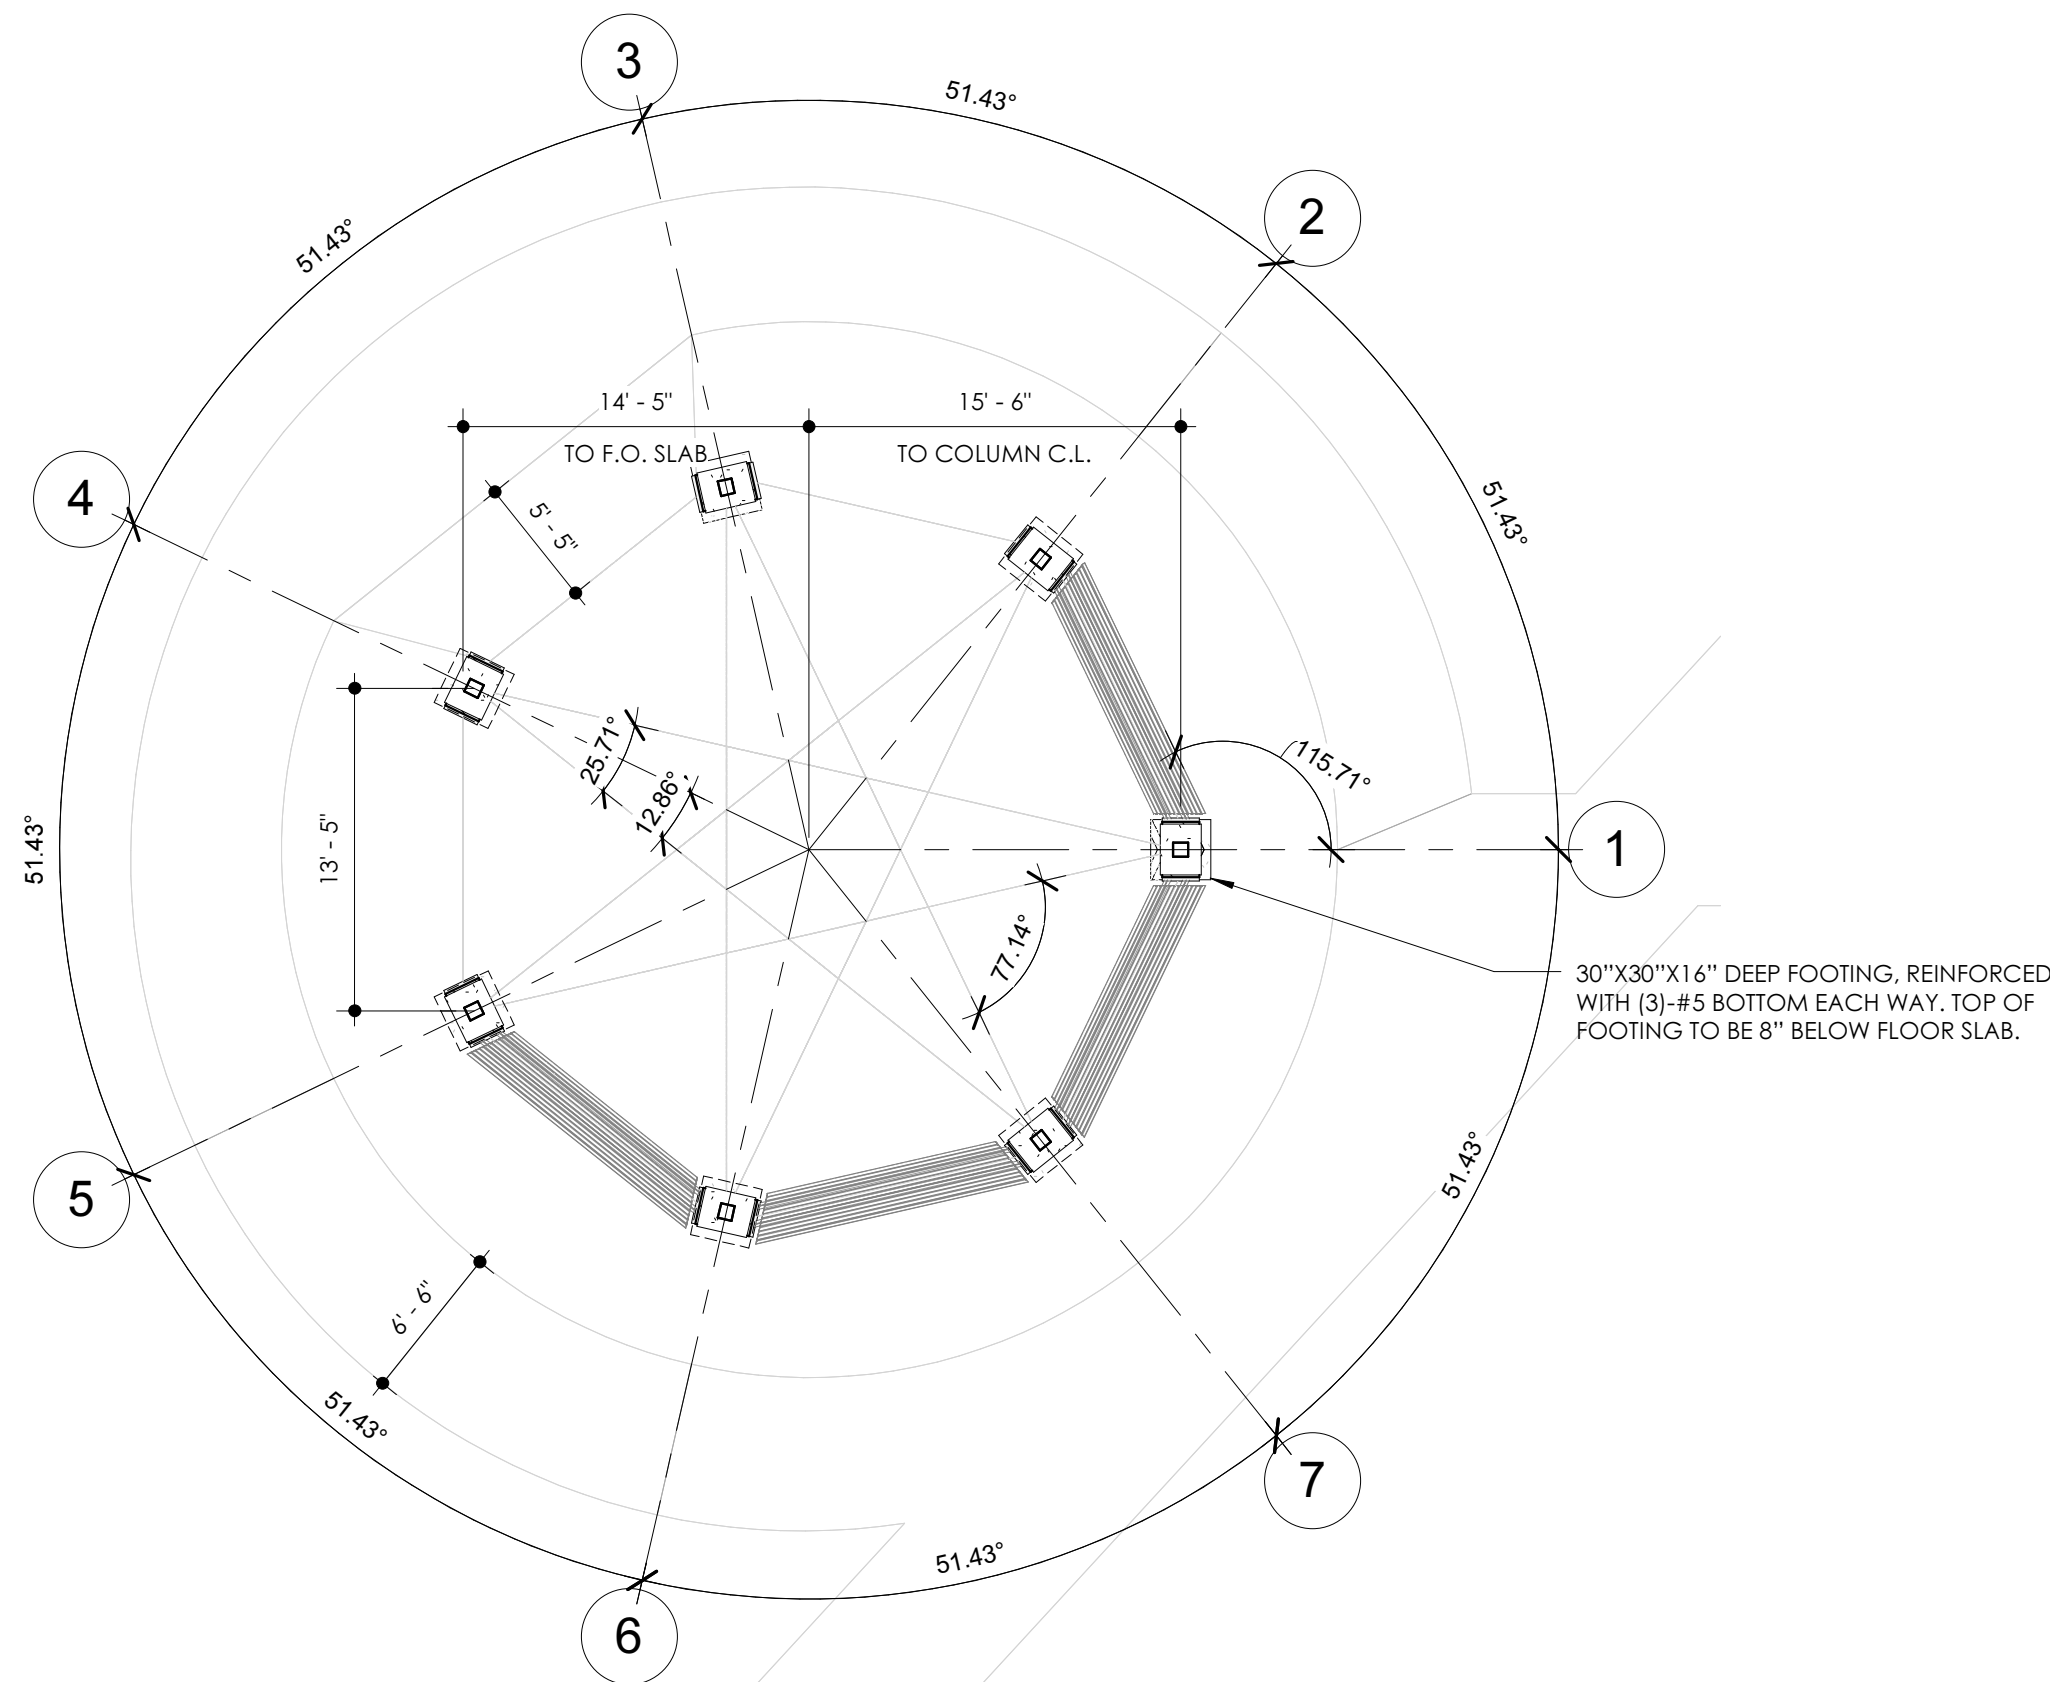

2 DIMENSION PLAN
1/8" = 1'-0"

GENERAL NOTES

- THE DRAWINGS AND SPECIFICATIONS, AND ALL COPIES THEREOF, ARE LEGAL INSTRUMENTS OF SERVICE FOR THE USE OF THE OWNER AND AUTHORIZED REPRESENTATIVES ON THE DESIGNATED PROPERTY ONLY. OTHER USE, WITHOUT THE EXPRESSED WRITTEN PERMISSION OF THE ARCHITECT OF RECORD, IS PROHIBITED.
- SPECIFICATIONS, DETAILS AND SCHEDULES WHICH MAY BE BOUND SEPARATELY ARE PART OF THESE CONTRACT DOCUMENTS. DRAWINGS BY CONSULTING PROFESSIONALS, SUCH AS STRUCTURAL, LANDSCAPE, ETC., ARE SUPPLEMENTARY TO THE ARCHITECTURAL DRAWINGS AND ARE PART OF THESE CONTRACT DOCUMENTS.
- THE CONTRACTOR SHALL NOTIFY THE ARCHITECT IMMEDIATELY OF ANY OMISSIONS OR DISCREPANCIES BETWEEN THE ARCHITECTURAL DRAWINGS, CONSULTING PROFESSIONAL'S DRAWINGS, SPECIFICATIONS OR EXISTING CONDITIONS. SHOULD THERE BE AN OMISSION OR DISCREPANCY BETWEEN SAID DRAWINGS, SPECIFICATIONS OR CONDITIONS, IT SHALL BE BROUGHT TO THE ARCHITECT'S ATTENTION IN WRITING FOR CLARIFICATION PRIOR TO INSTALLATION OF SAID WORK.
- THE CONTRACTOR SHALL NOTIFY THE ARCHITECT IMMEDIATELY IF INFORMATION IS NOT SHOWN OR UNCLEAR.
- THE CONTRACTOR SHALL VERIFY ALL DIMENSIONS, ELEVATIONS AND EXISTING CONDITIONS PRIOR TO STARTING WORK AND REPORT ANY DISCREPANCIES IN WRITING TO THE ARCHITECT. ANY WORK INSTALLED IN CONFLICT WITH THE ARCHITECTURAL DRAWINGS SHALL BE CORRECTED BY THE CONTRACTOR AT HIS EXPENSE.
- THE CONTRACTOR SHALL OBTAIN ALL NECESSARY PERMITS AND APPROVALS FOR ALL WORK.
- THE CONTRACTOR SHALL BE RESPONSIBLE FOR SCHEDULING AND COORDINATING THE WORK FOR ALL UTILITIES AND SERVICES.
- ALL SYMBOLS AND ABBREVIATIONS USED ON THE DRAWINGS ARE CONSIDERED TO BE CONSTRUCTION STANDARDS. QUESTIONS REGARDING THE SAME, OR THEIR EXACT MEANING, SHOULD BE DIRECTED TO THE ARCHITECT.
- WRITTEN DIMENSIONS SHALL TAKE PRECEDENCE OVER SCALE. DO NOT SCALE DRAWINGS. THE CONTRACTOR SHALL BE RESPONSIBLE FOR THE ACCURATE PLACEMENT AND CONFIGURATION OF THE BUILDING ON THE SITE.
- FLOOR ELEVATIONS ARE TO TOP OF CONCRETE SLAB, UNLESS NOTED.
- PAINT ALL EXPOSED WOOD. COLOR TO BE DETERMINED LATER. PREPARE SURFACES AND APPLY PAINTS IN ACCORDANCE WITH MANUFACTURER'S WRITTEN INSTRUCTIONS AND RECOMMENDATIONS. MUST COMPLY WITH MPI STANDARDS, REF. SPEC.

FLOORING LEGEND

COLORED CONCRETE RED	COLORED CONCRETE OTHER	COLORED CONCRETE DARK GRAY	COLORED CONCRETE LIGHT GRAY

TriArch
ARCHITECTURE DESIGN PLANNING
414 East 3rd Street
Tulsa, Oklahoma 74101
918.742.2724 (ext)
918.742.2725 (fax)

No.	Description	Date

REVISIONS

No.	Description	Date

Consultants

CHEROKEE GAZEBO
CHEROKEE NATION
101 S Muskogee Ave, Tahlequah, OK 74464

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PROJECT NO. 11-1335

SHEET TITLE: **PLANS**

DRAWN BY: Author
CHECKED BY: Checker
ISSUE DATE: 6-23-2014

A101



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CHEROKEE GAZEBO

CHEROKEE NATION
101 S Muskogee Ave, Tahlequah, OK 74464




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PROJECT NO. 11-1335


SHEET TITLE: ELEVATIONS & SECTIONS

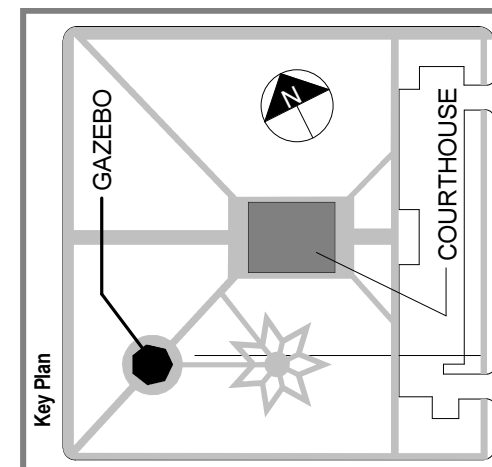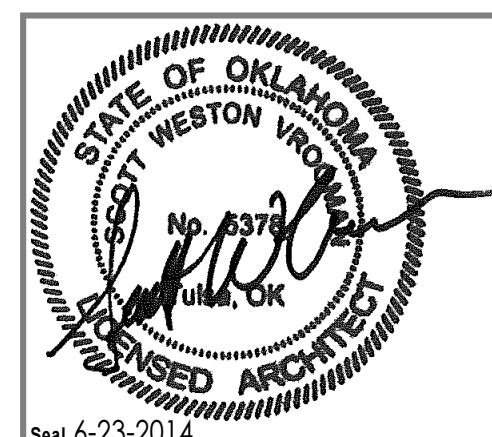DRAWN BY: Author
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ISSUE DATE: 6-23-2014


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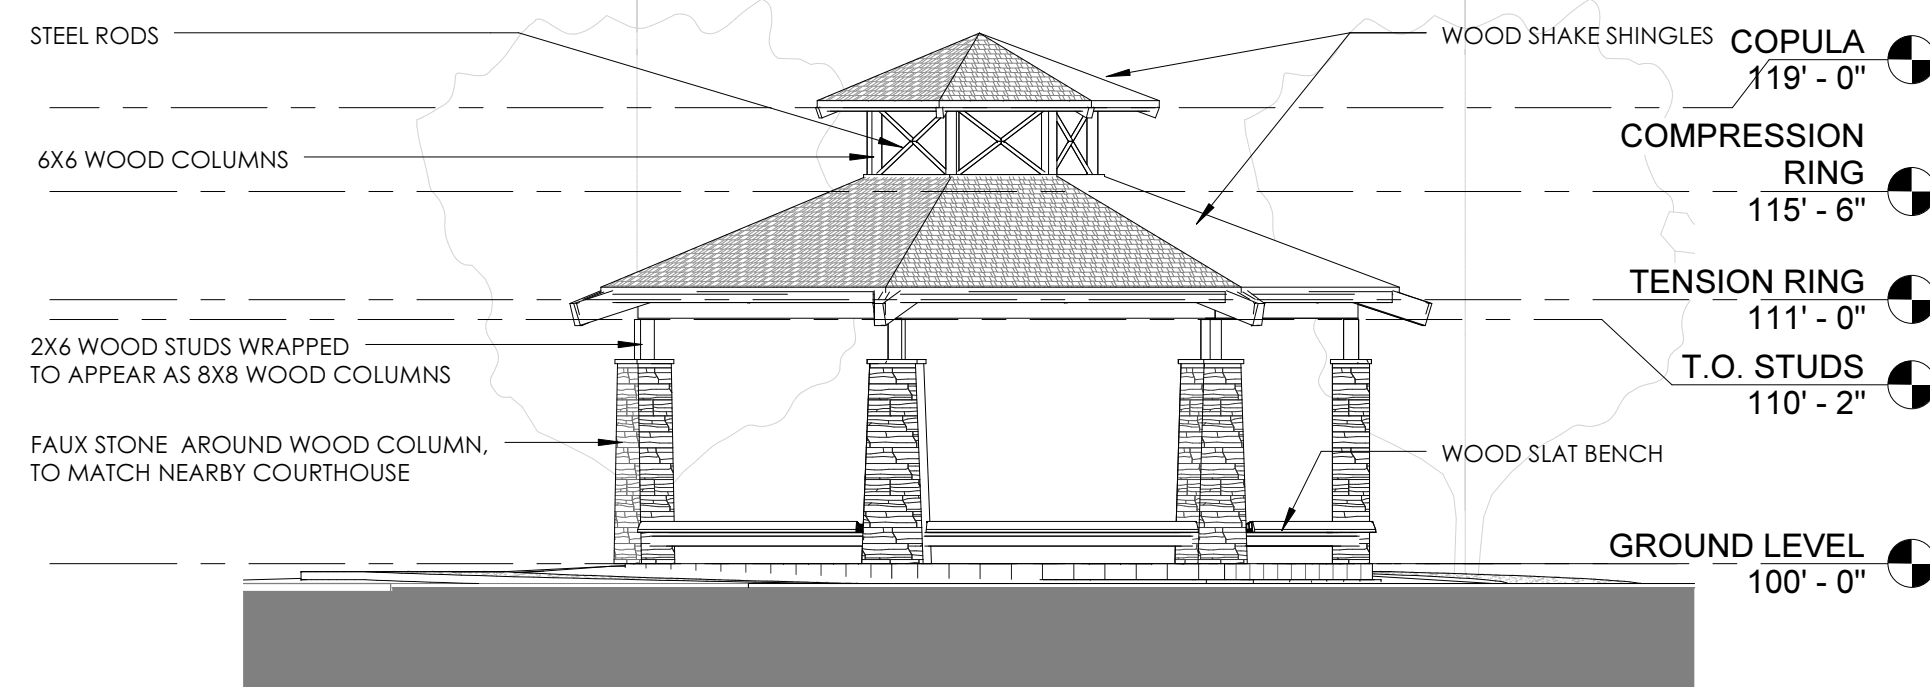
6 NORTH EXTERIOR ELEVATION
1/8" = 1'-0"

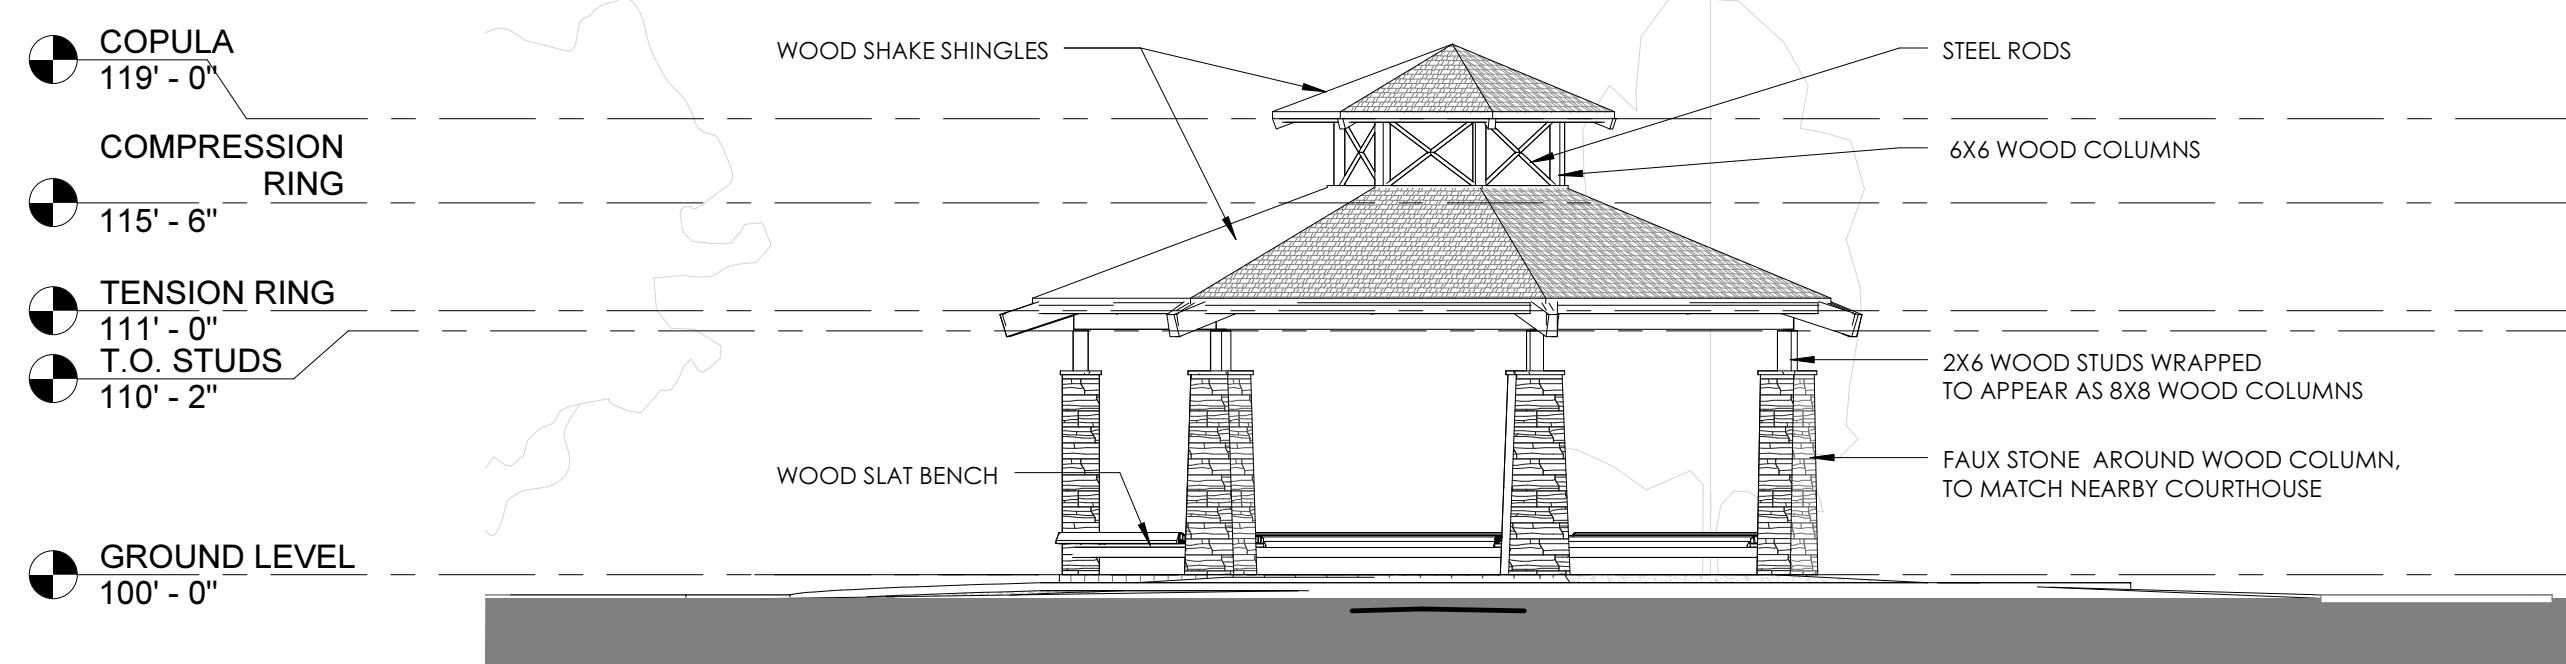


5 WEST EXTERIOR ELEVATION
1/8" = 1'-0"

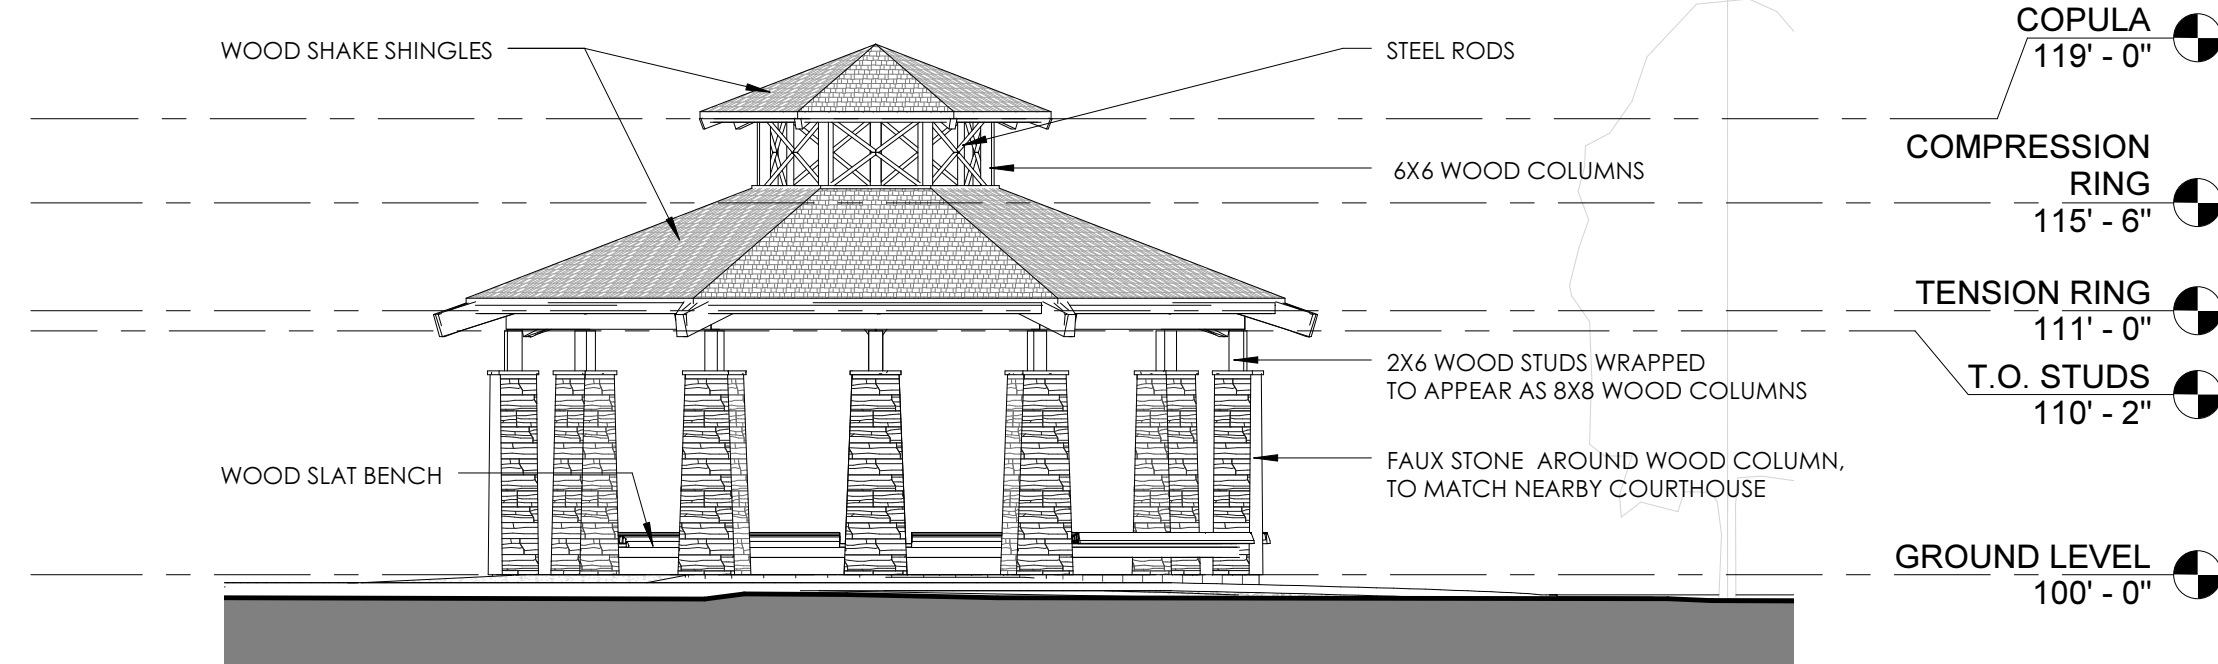


4 EAST EXTERIOR ELEVATION
1/8" = 1'-0"

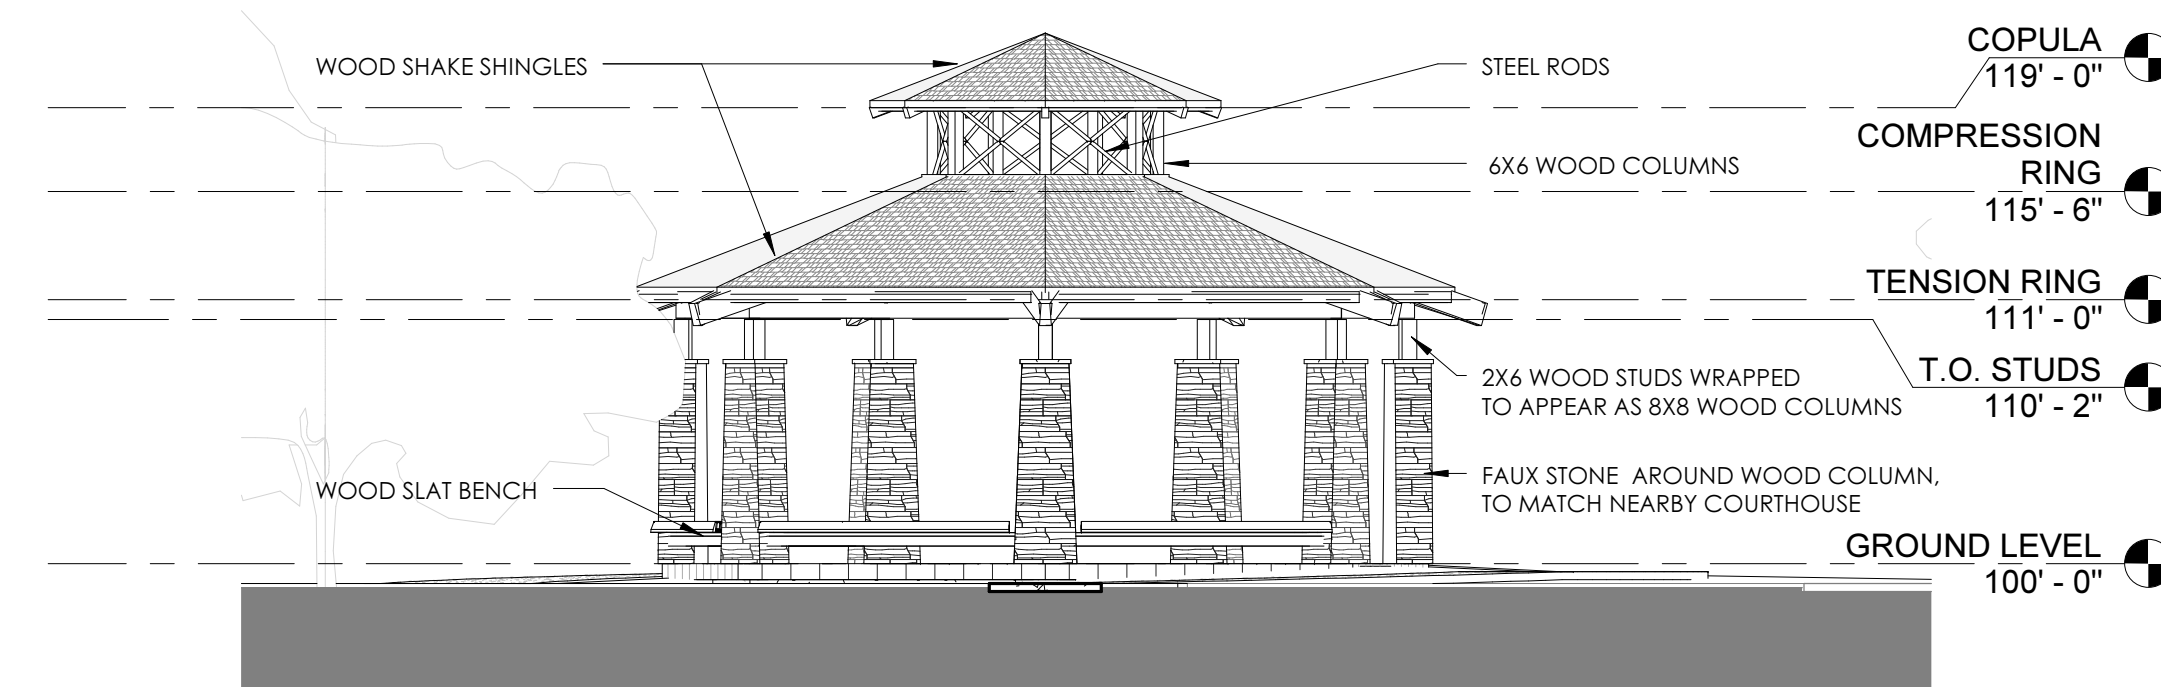


3 SOUTH EXTERIOR ELEVATION
1/8" = 1'-0"




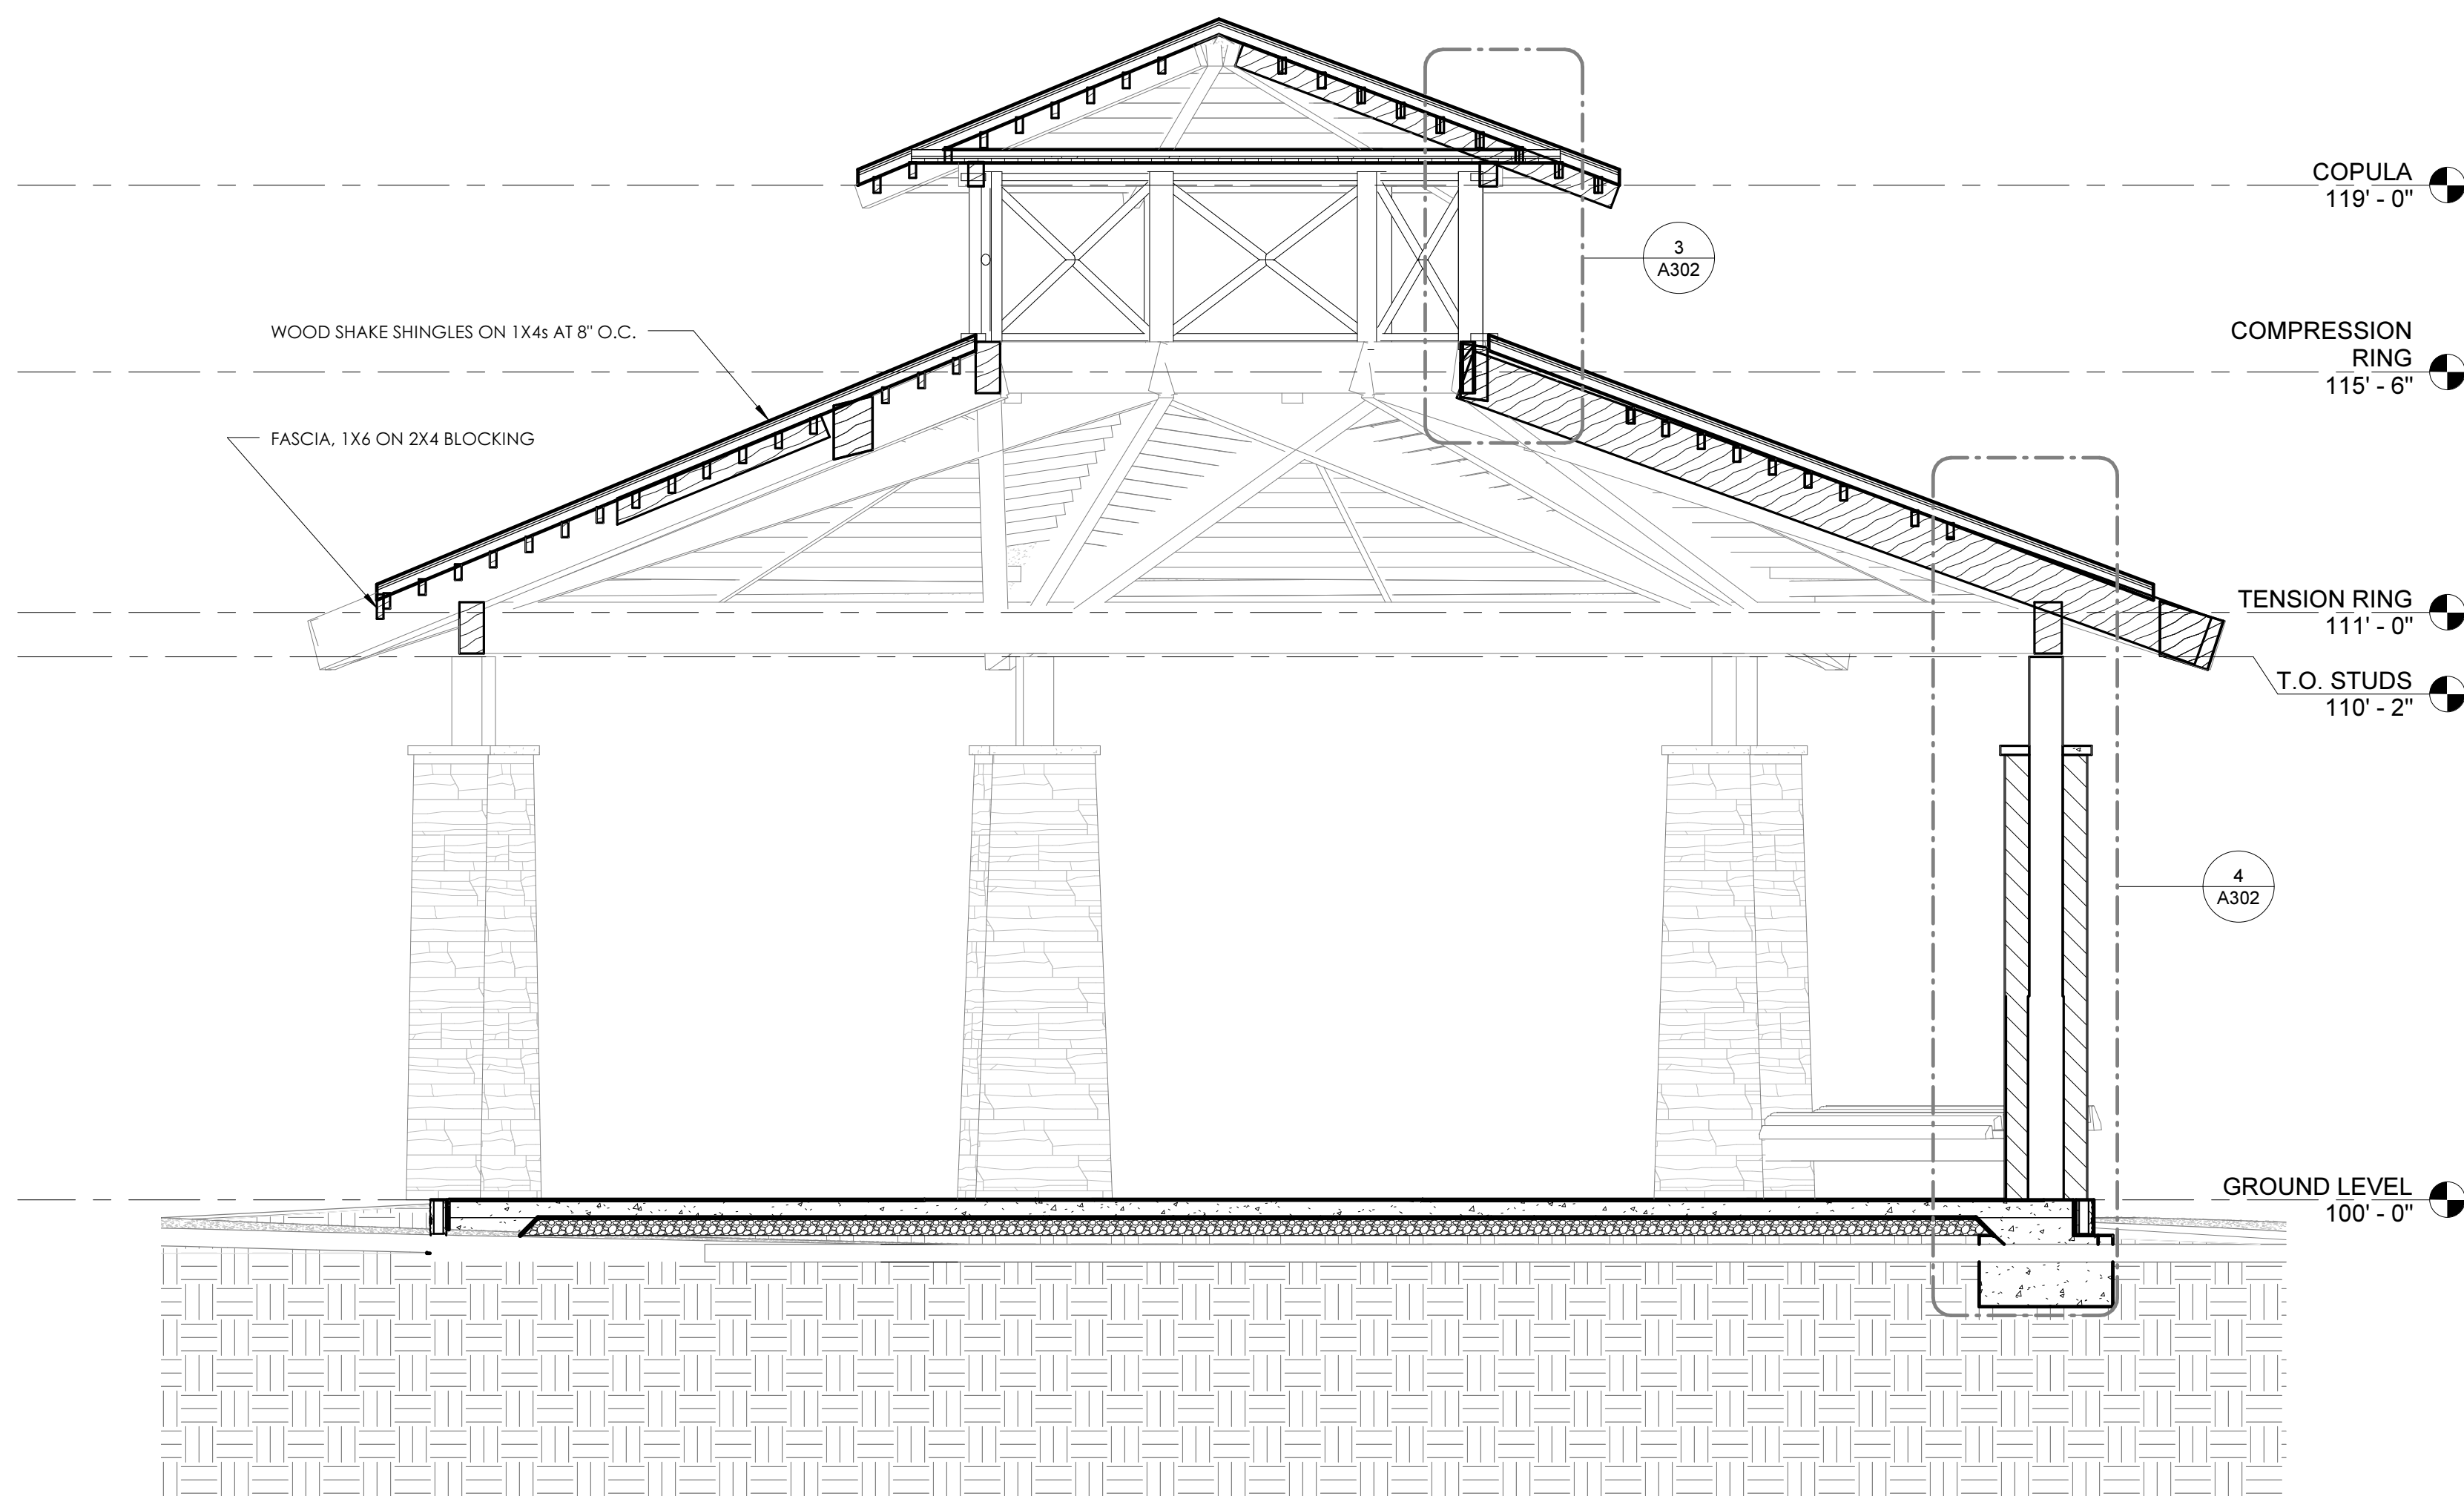


2 BUILDING SECTION B
3/8" = 1'-0"

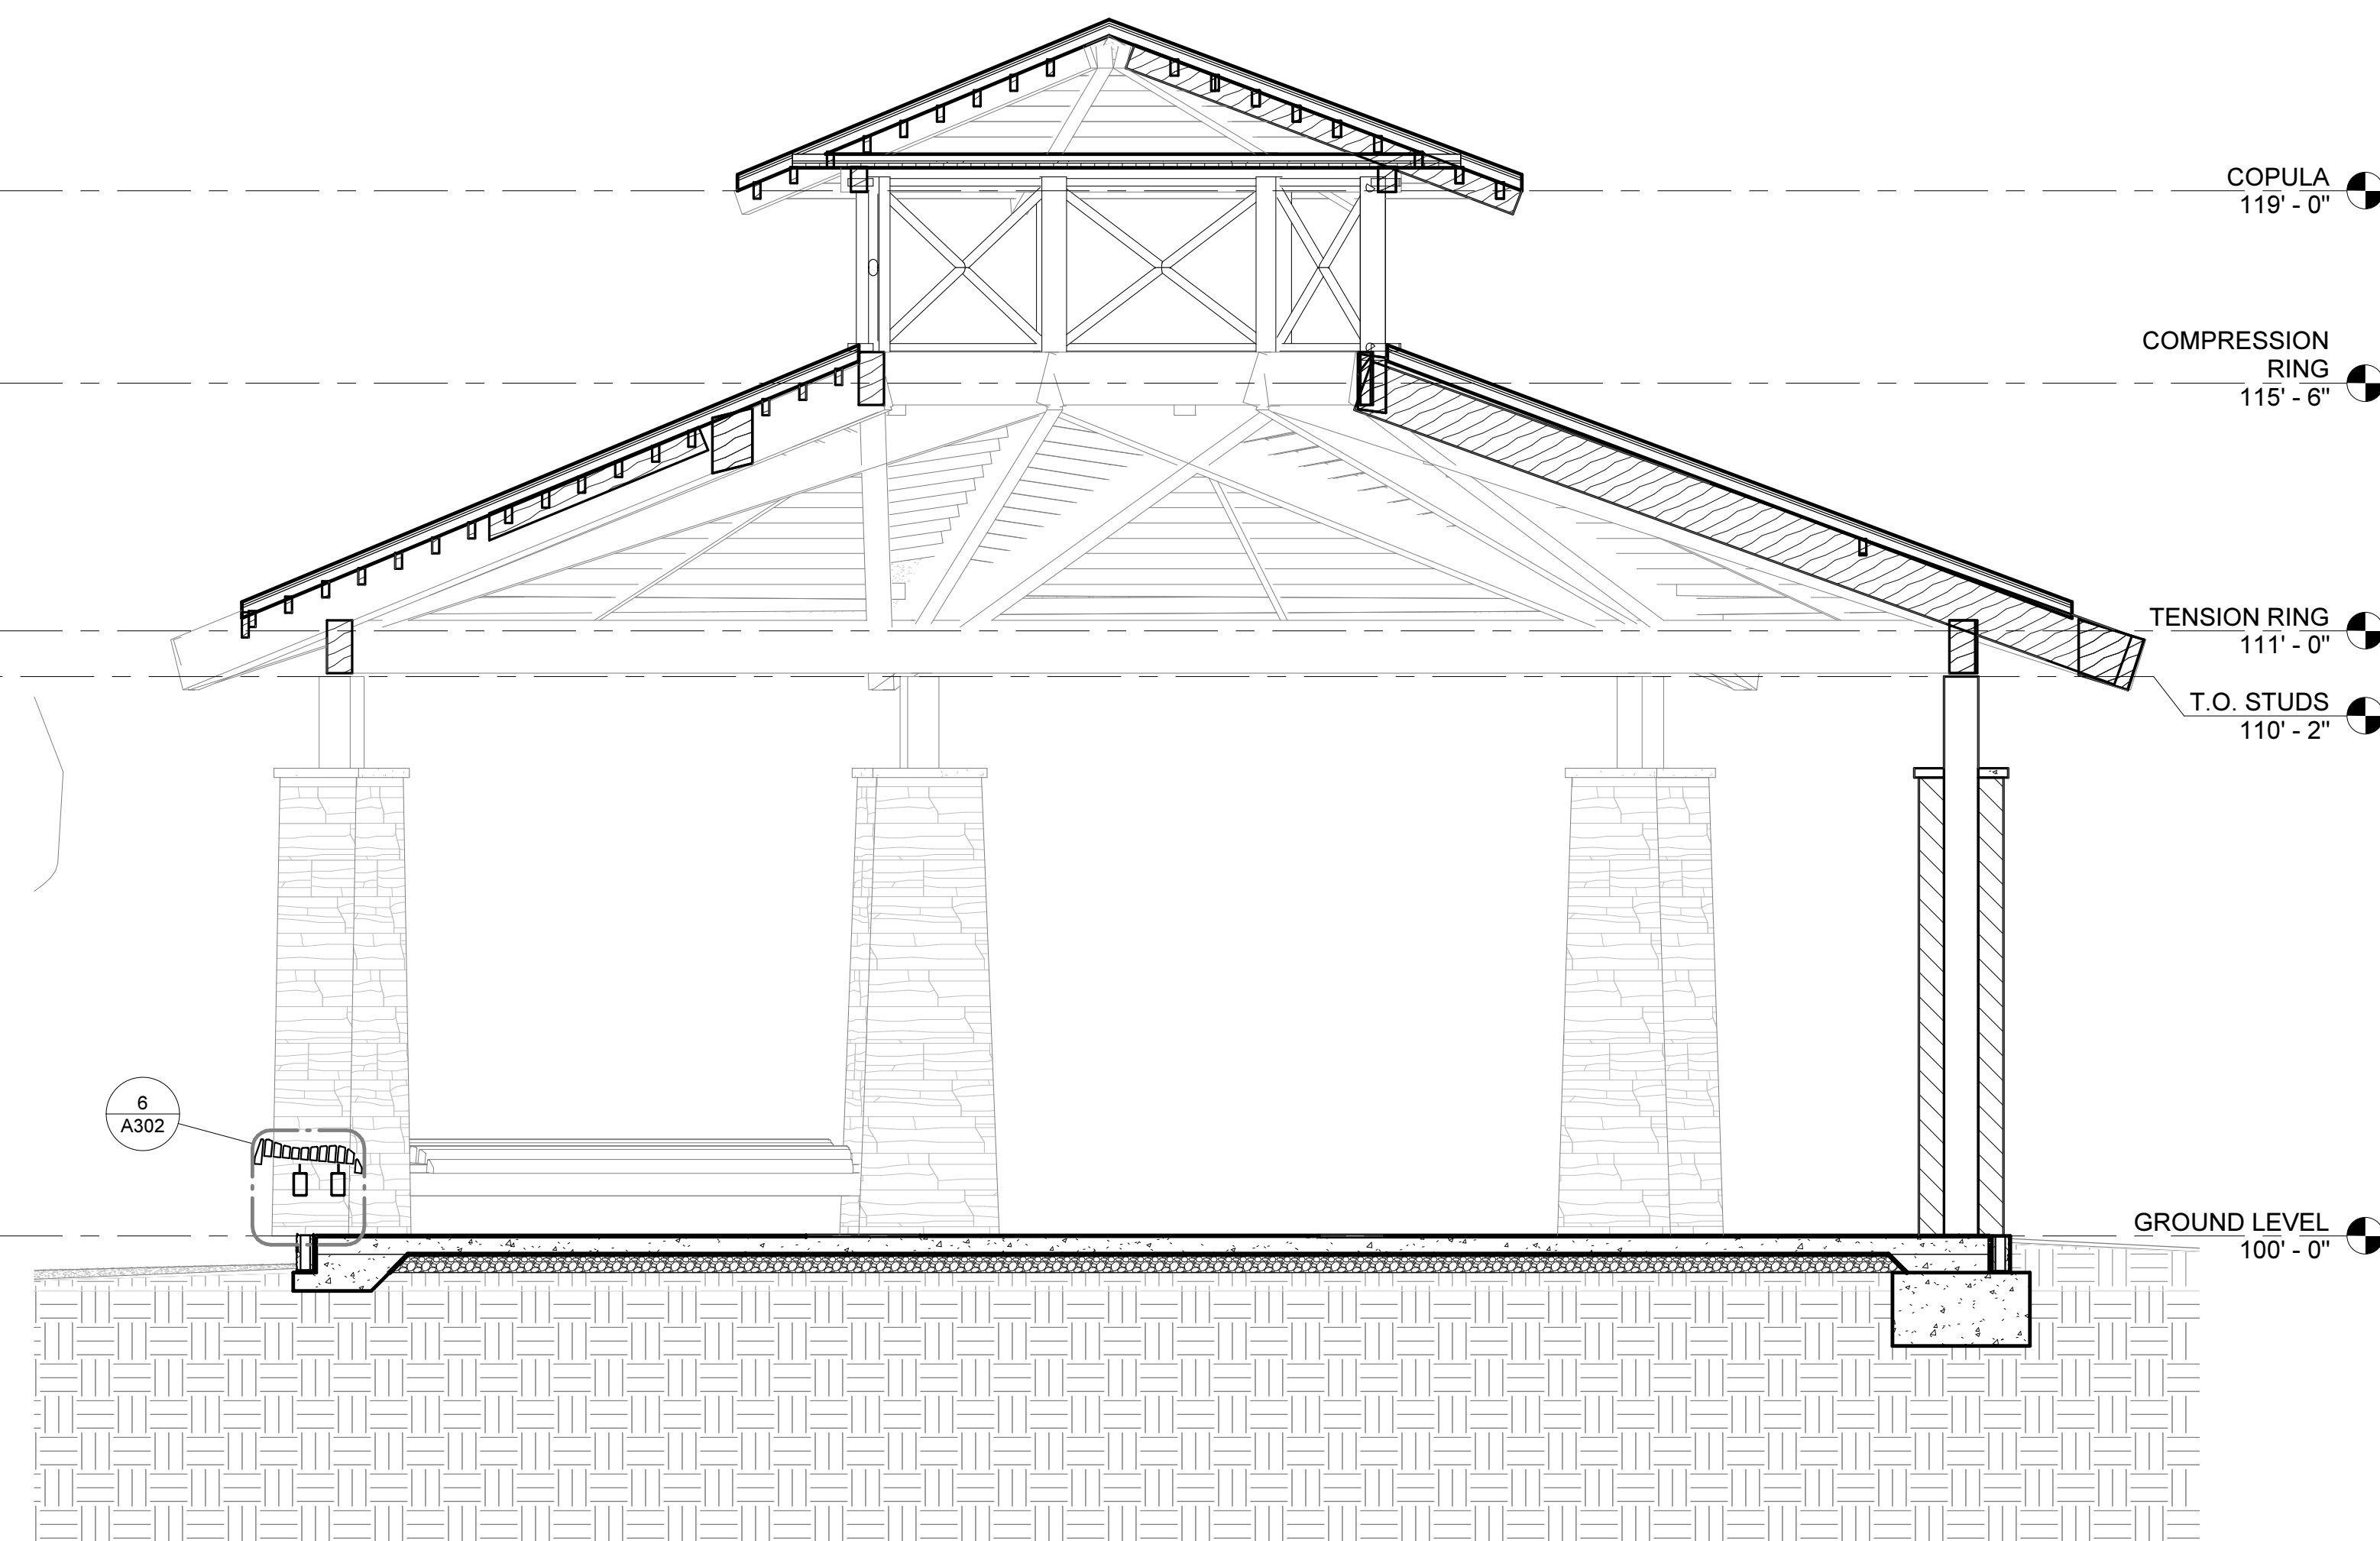

1 BUILDING SECTION A
3/8" = 1'-0"

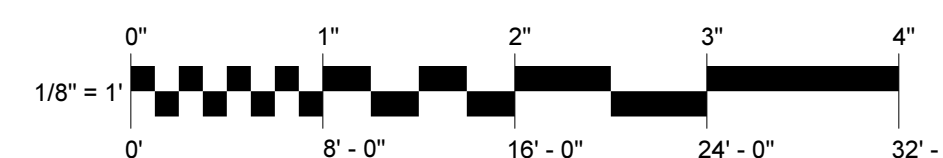

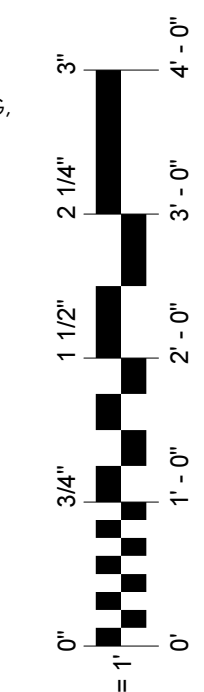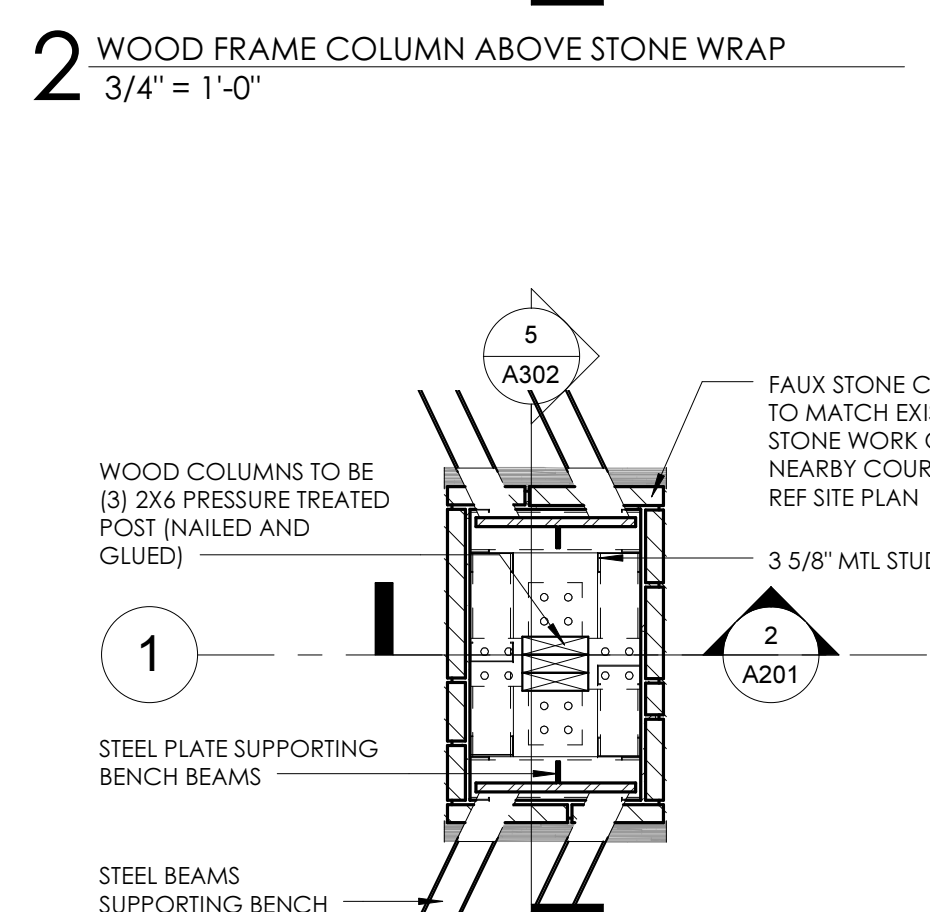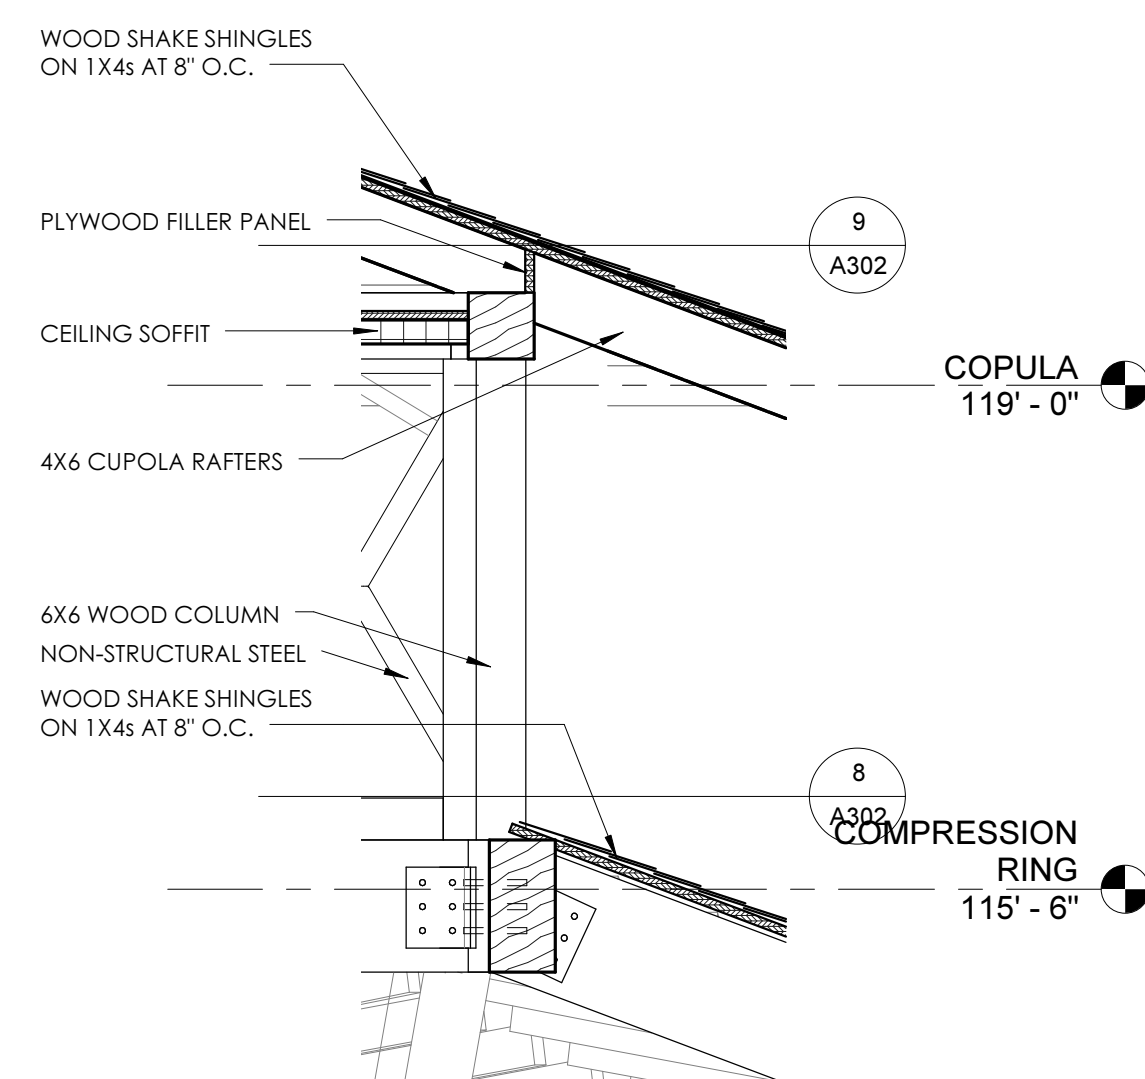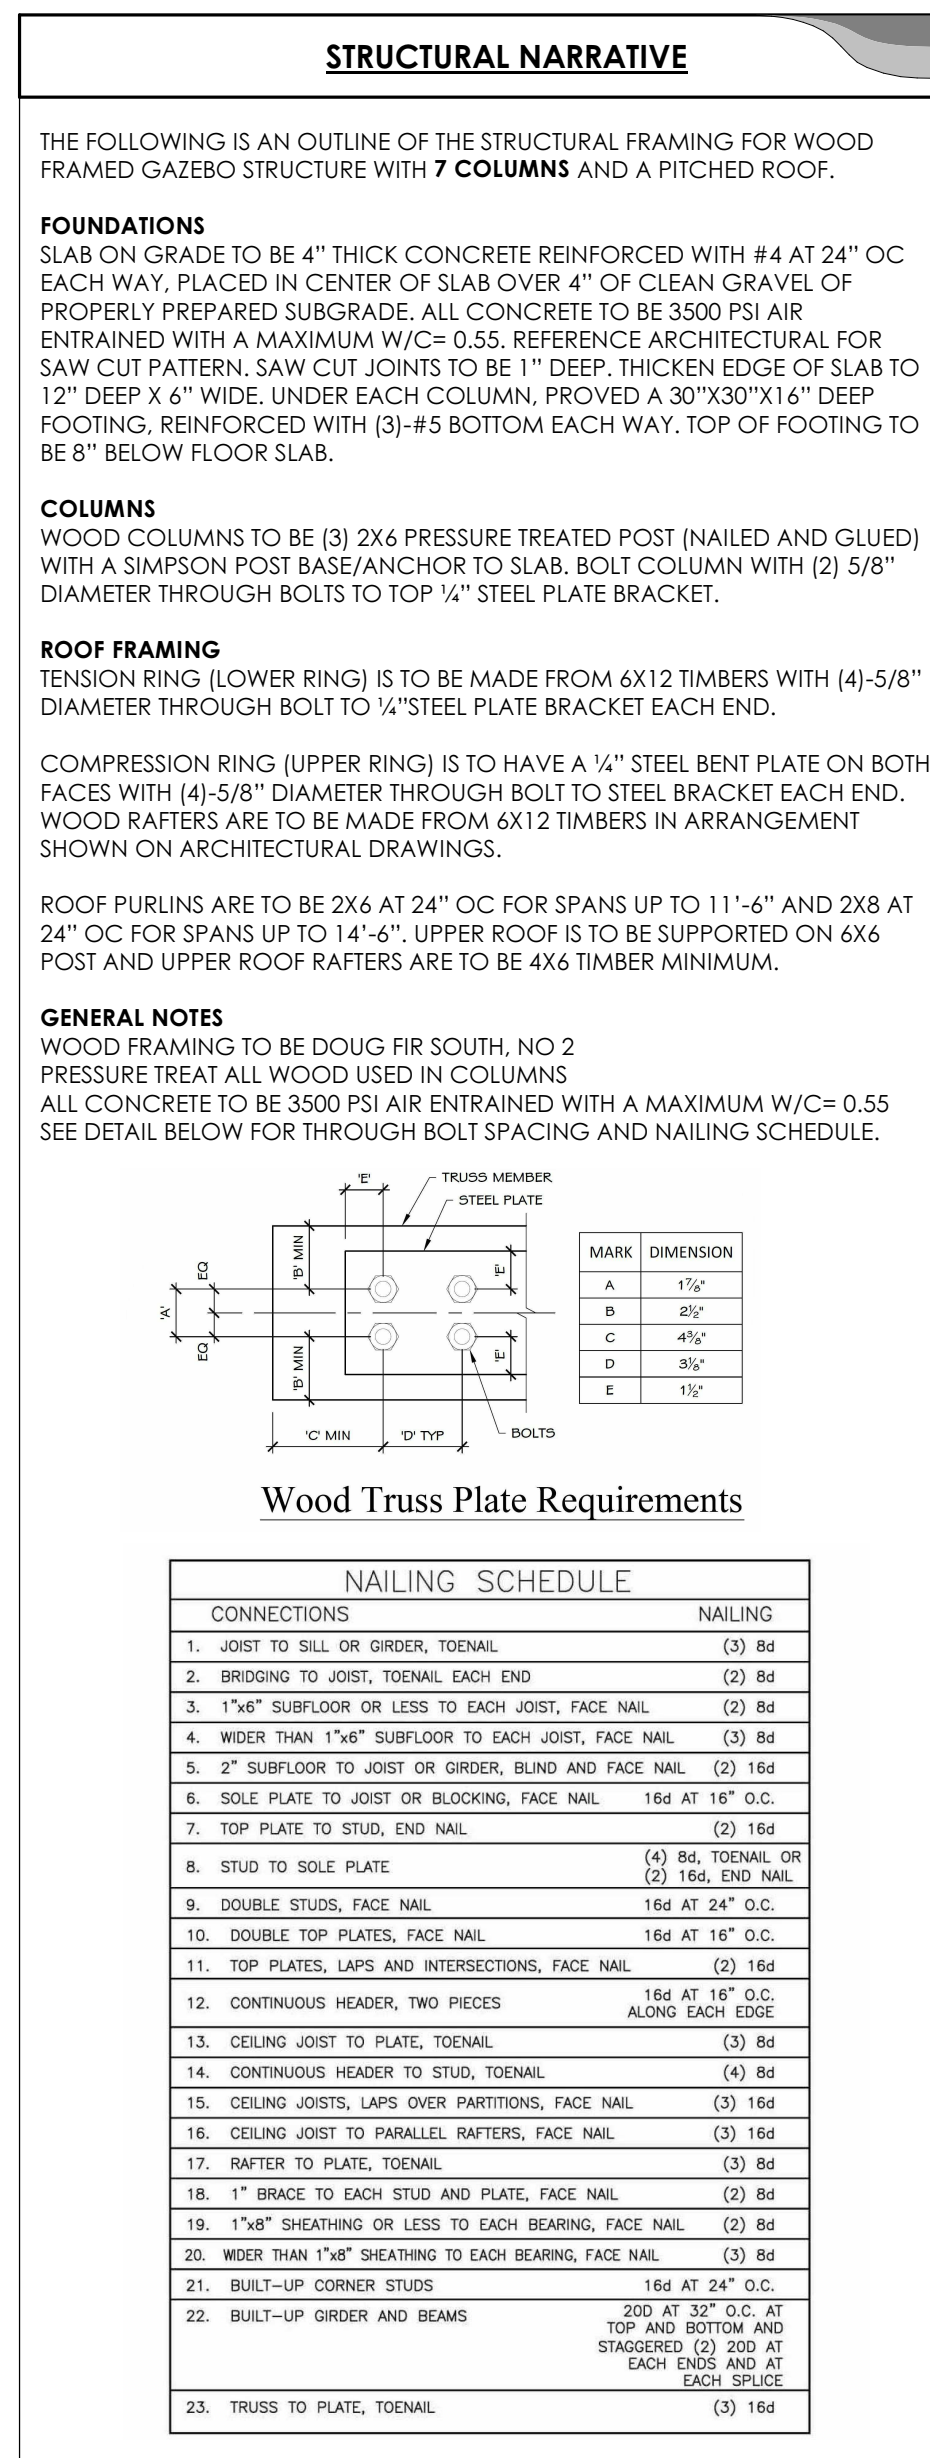


No.	Description	Date
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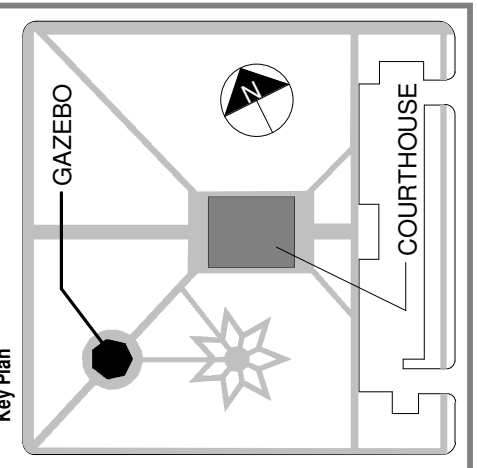
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CHEROKEE GAZEBO

CHEROKEE NATION
101 S Mustang Ave, Tahlequah, OK 74464



Seal

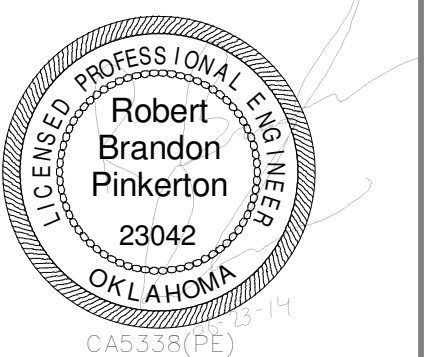


100% Construction Documents

PROJECT NO. 21-1035


SHEET TITLE: ELECTRICAL PLAN

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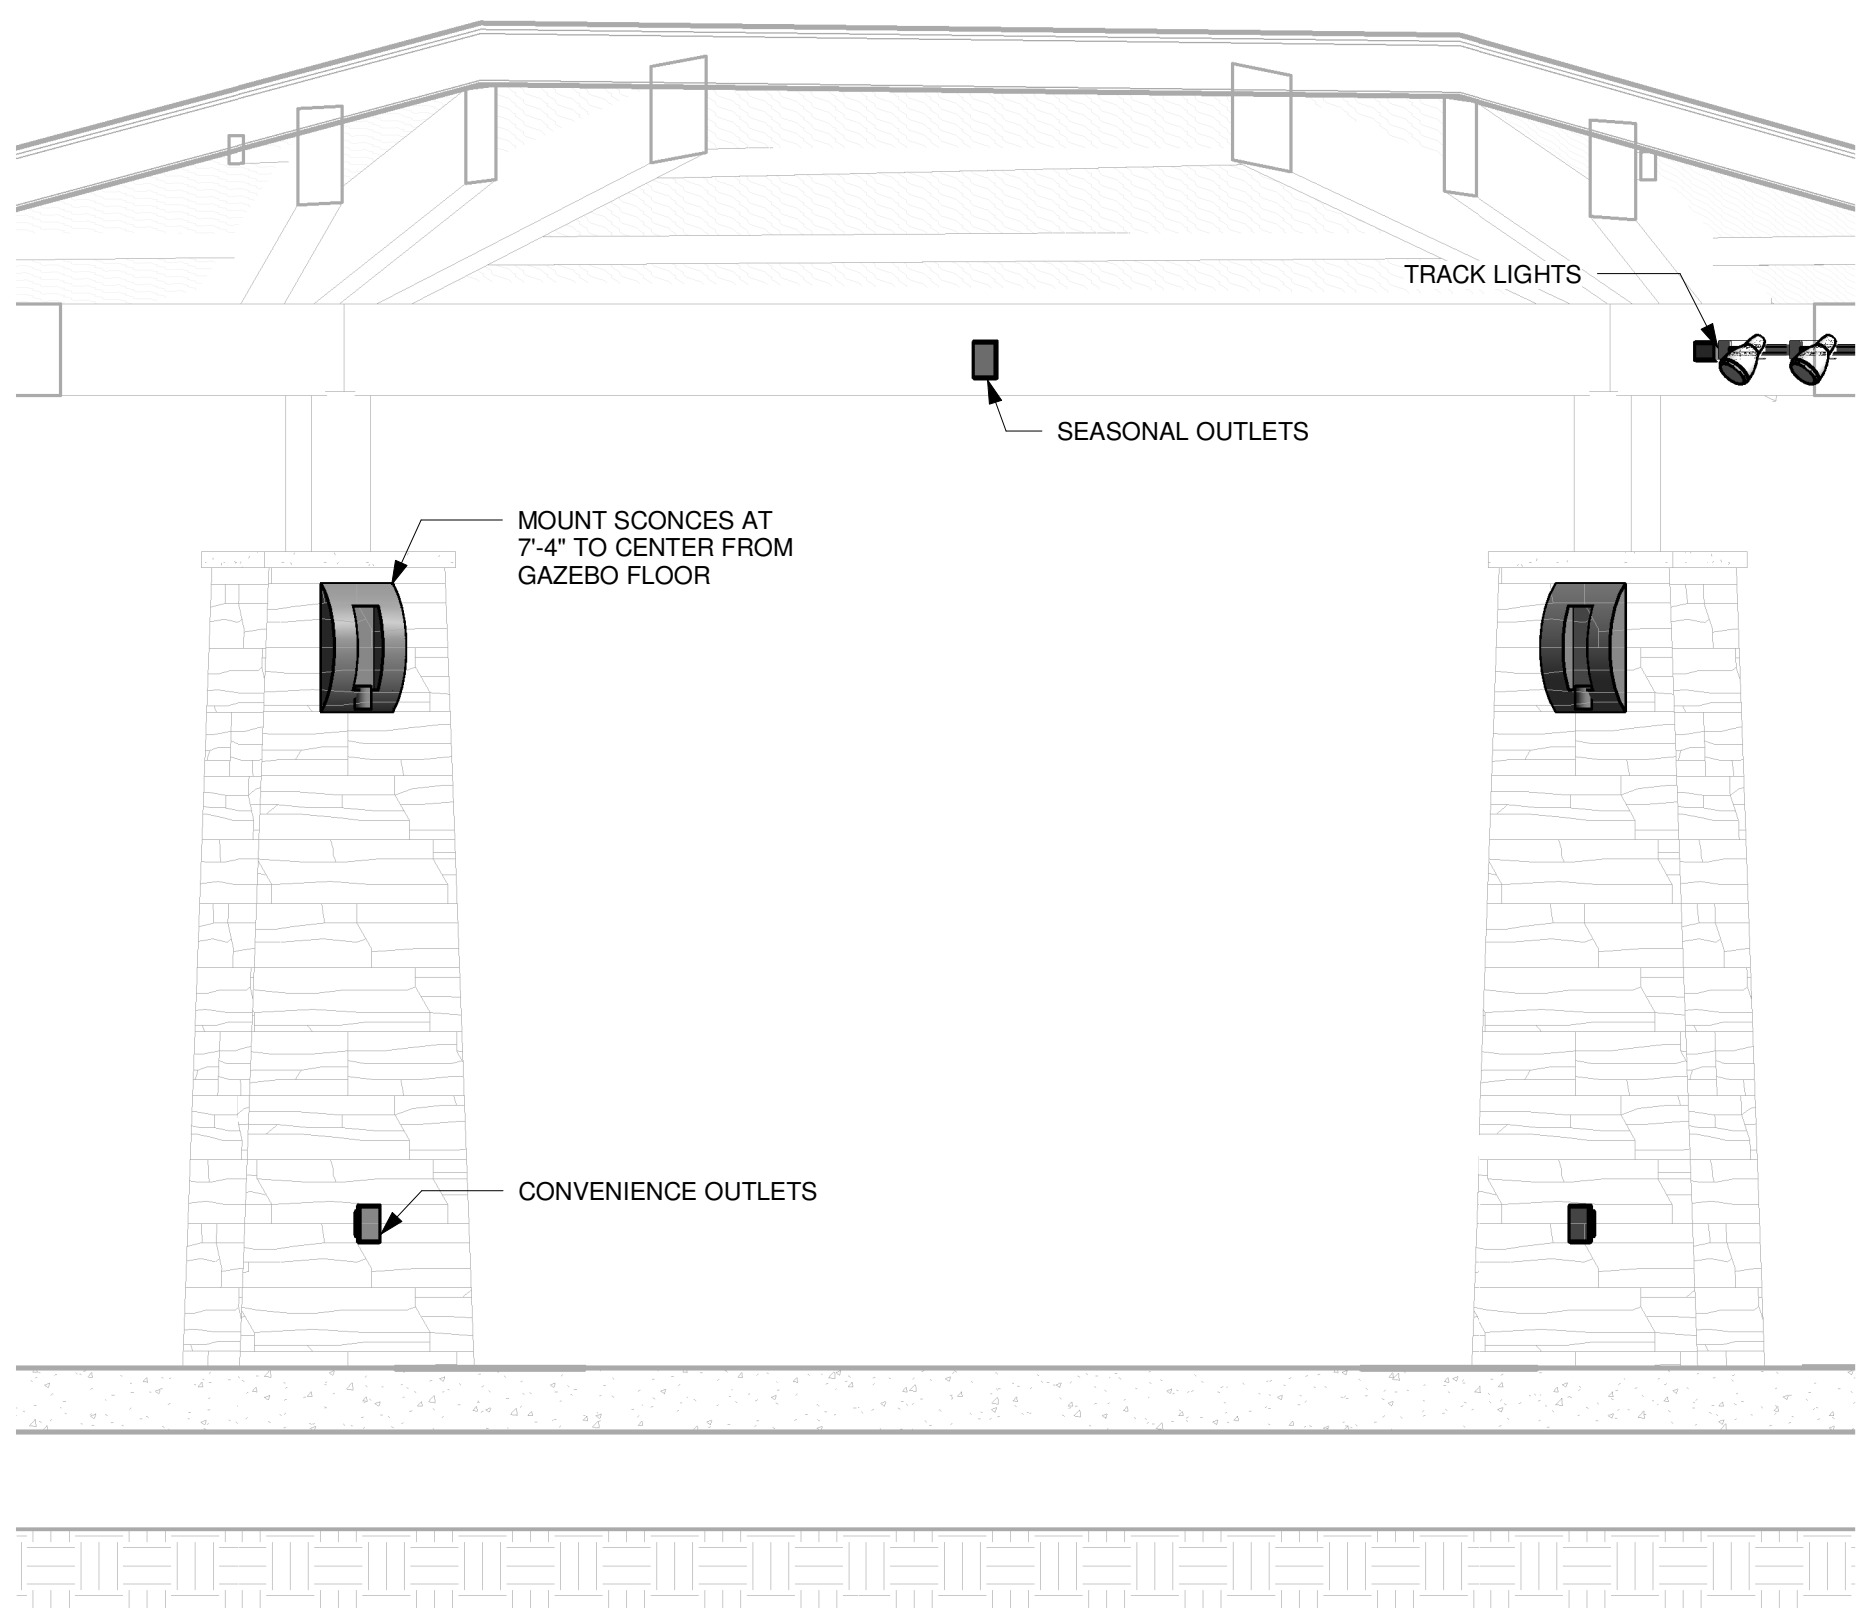
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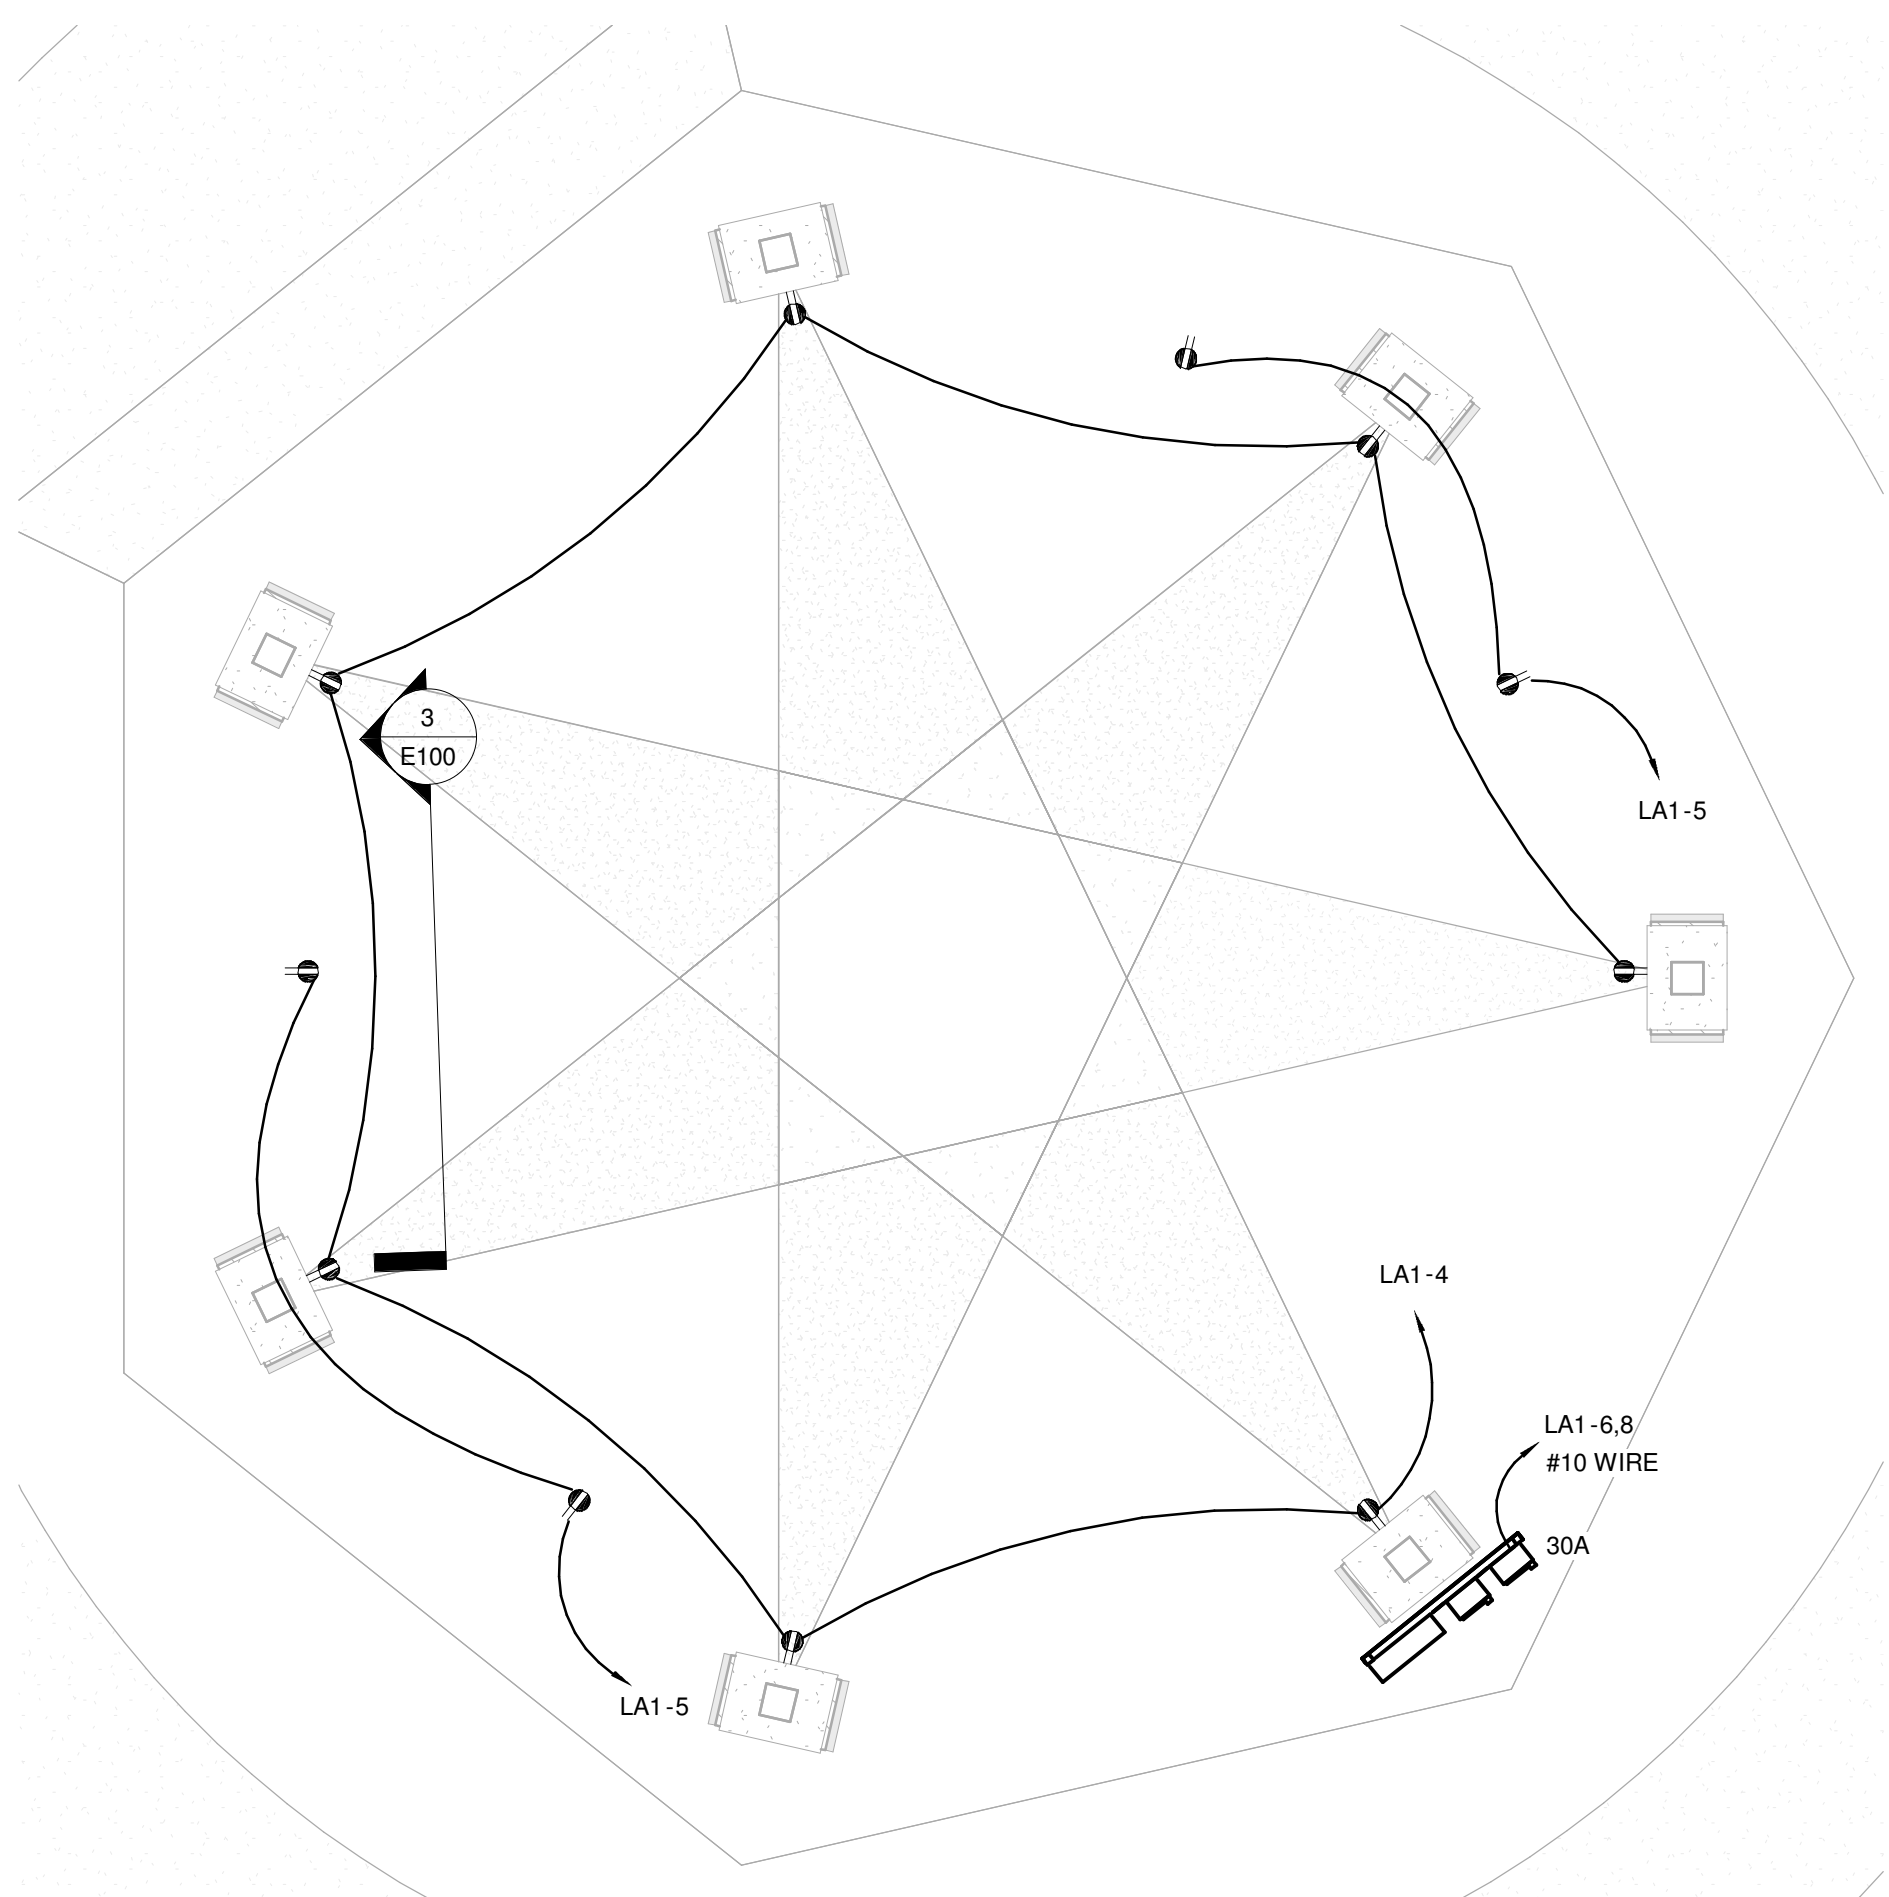
② LIGHTING CONTROL DIAGRAM
NTS

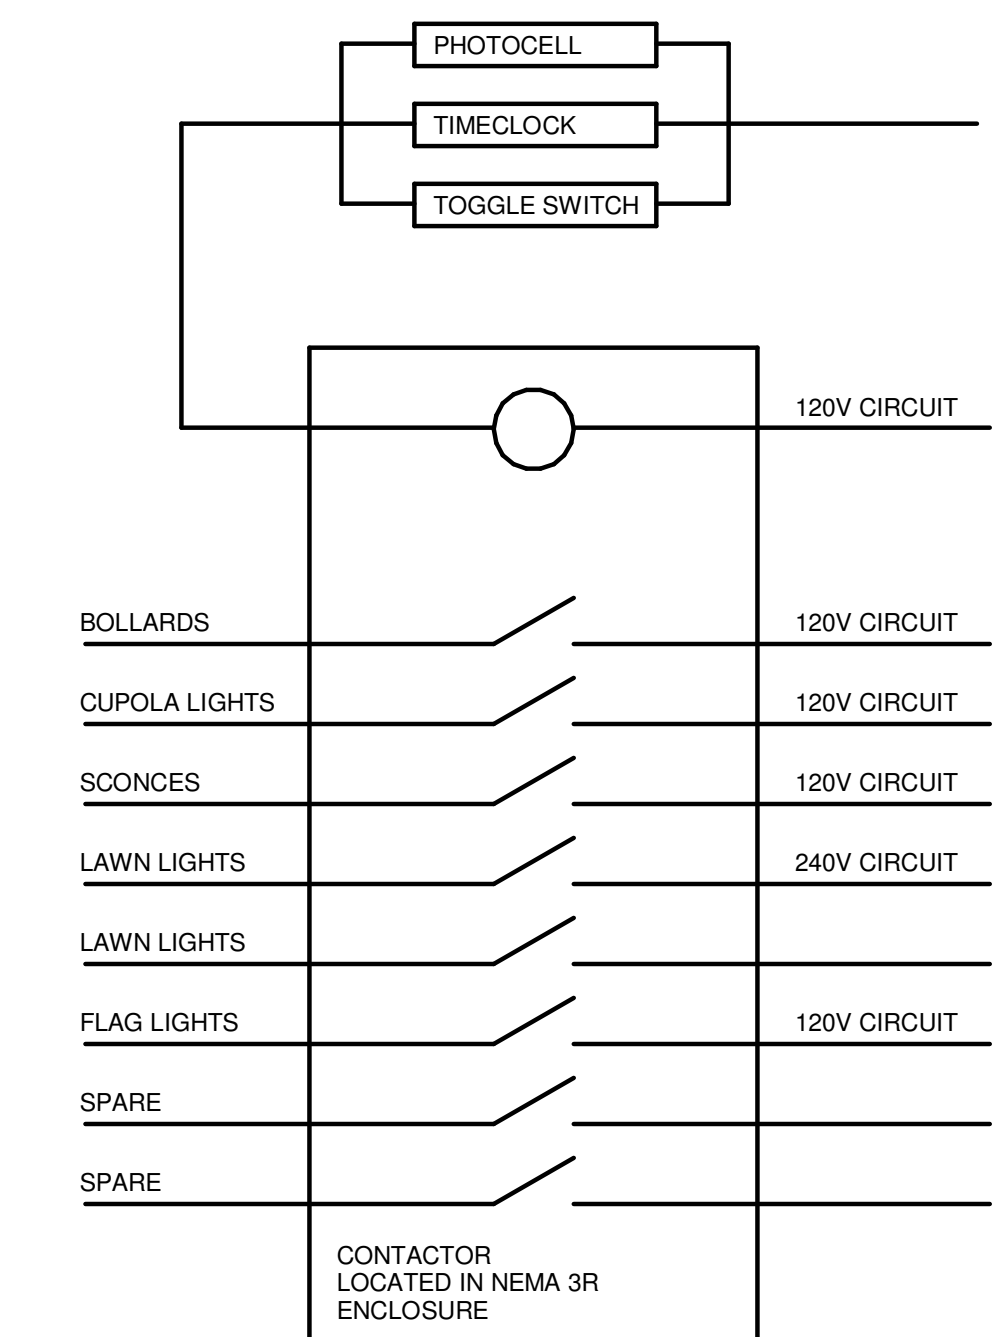

② GAZEBO LIGHTING
1/4" = 1'-0"

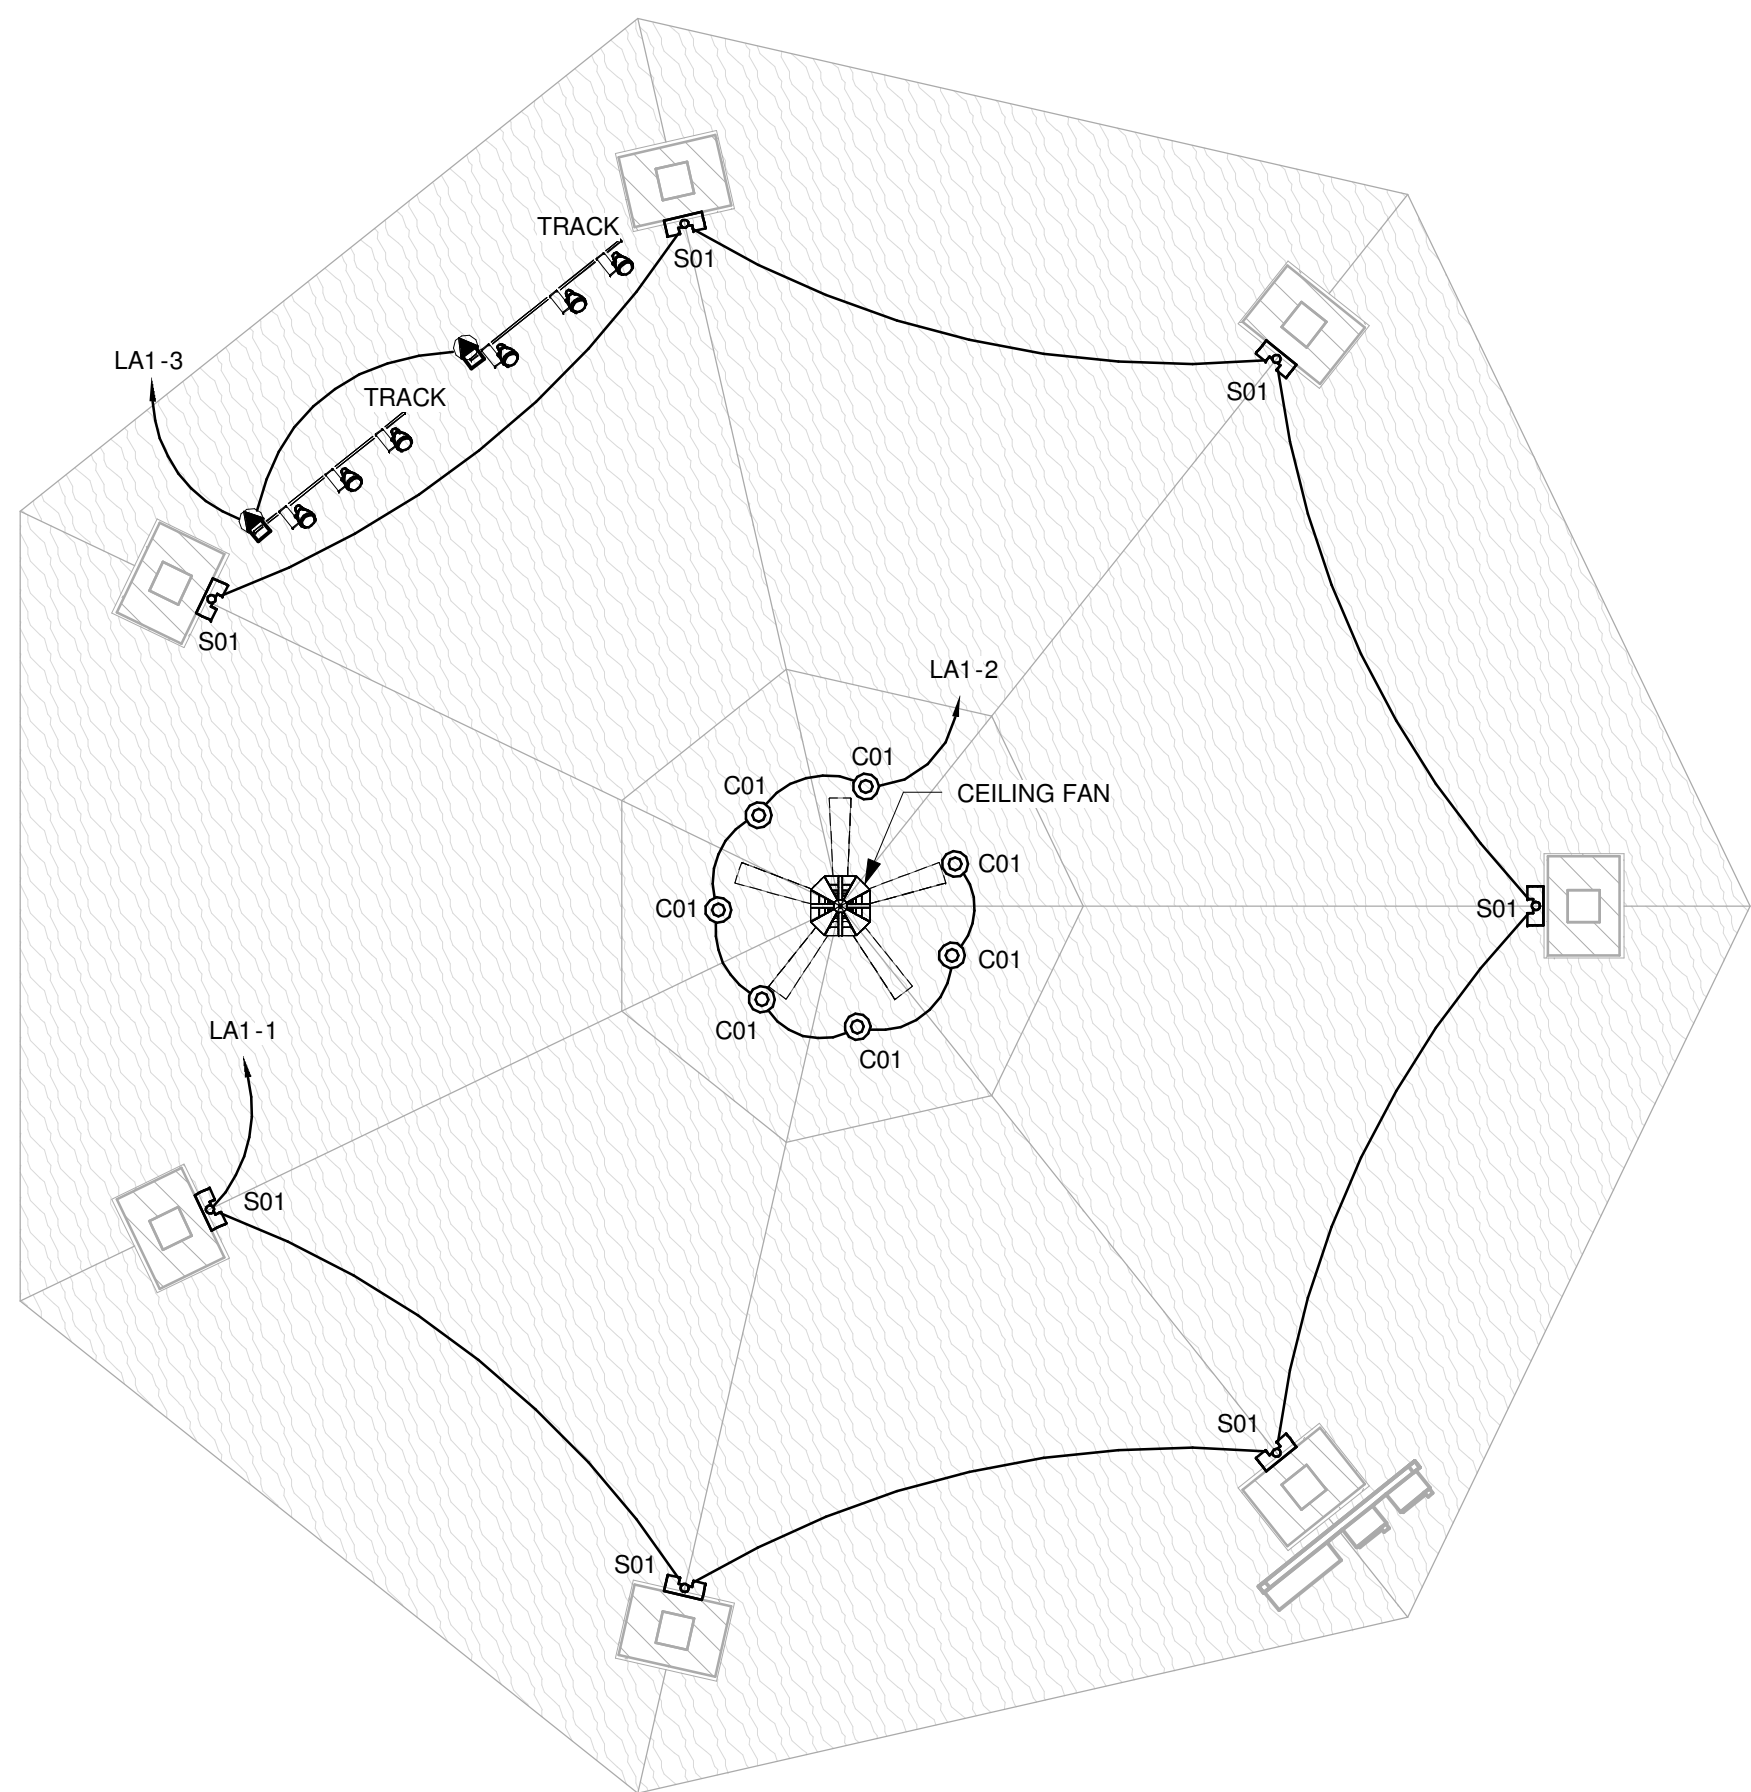

③ ELECTRICAL ELEVATION
1/2" = 1'-0"



④ GAZEBO POWER PLAN
1/4" = 1'-0"

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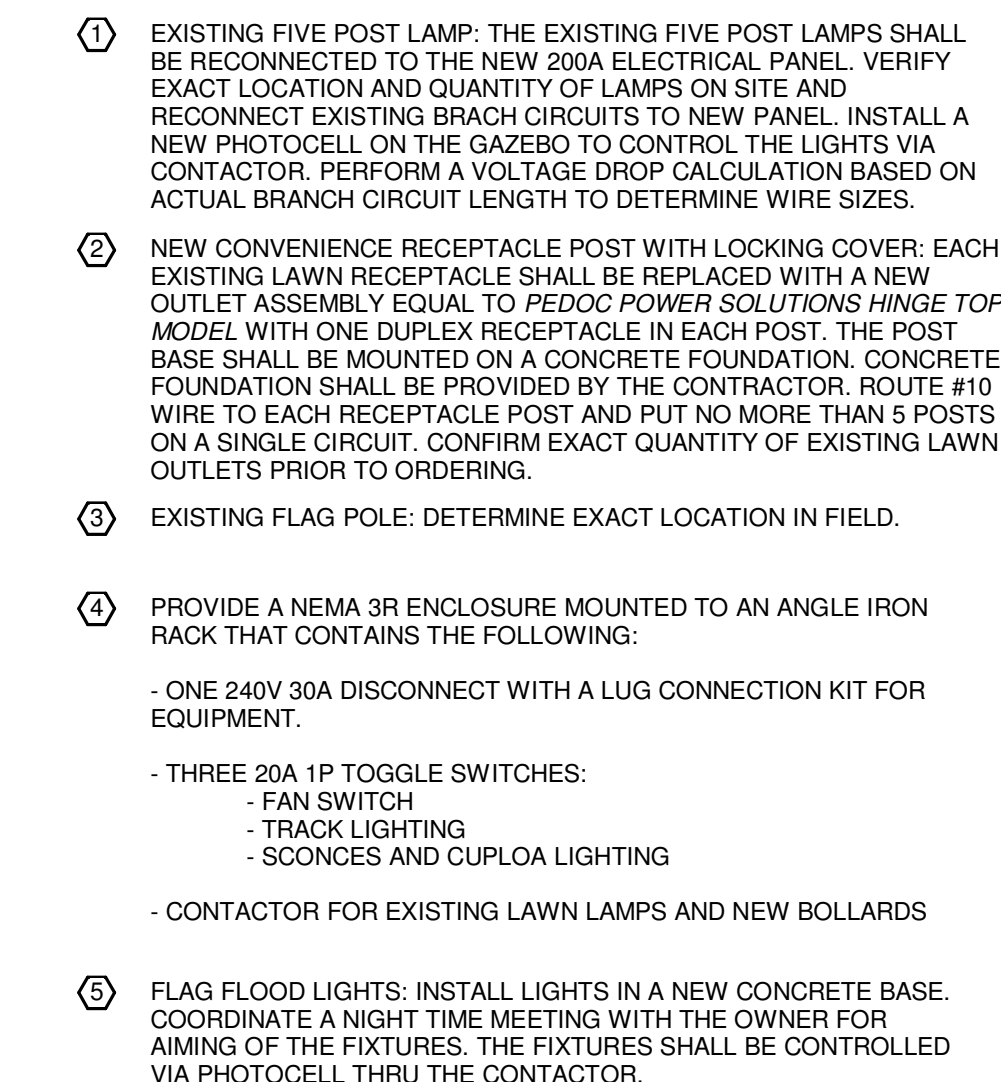
PROJECT NO. 01-1205

SHEET TITLE: ELECTRICAL SITE
PLAN

DRAWN BY: RBP
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ISSUE DATE: 6-23-2014

E200

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1 SITE ELECTRICAL PLAN
1/16" = 1'-0"