工

 α Ш Ω

⋖

Ш \succeq

S

CHEROKEE NATION ENTERTAINMENT/ CULTURE & TOURISM

Cherokee National Capitol - Phase One

Tahlequah, OK

OWNER

CHEROKEE NATION ENTERPRISES / CULTURE 4 TOURISM TITI WEST CHEROKEE STREET CATOOSA, OK 14015 PHONE: (918) 384-1800 FAX: (918) 439-4364

ARCHITECT

SIKES ABERNATHIE ARCHITECTS P.C. 406 SOUTH BOULDER AVENUE, SUITE 100

STRUCTURAL ENGINEER

SNOWDEN ENGINEERING, P.C. 8128 EAST 63RD STREET TULSA, ØK PHONE: (918) 252-4551 FAX: (918) 254-0838 CONTACT: KEVIN SNOWDEN

DRAWING INDEX

ARCHITECTURAL

SITE PLAN SITE DETAILS BASEMENT LEVEL DEMOLITION PLAN FIRST LEVEL DEMOLITION PLAN SECOND LEVEL DEMOLITION PLAN ROOF DEMOLITION PLAN BASEMENT LEVEL FLOOR PLAN FIRST LEVEL FLOOR PLAN SECOND LEVEL FLOOR PLAN ROOF PLAN EXISTING ELEVATIONS SCHEDULES & DOOR DETAILS WINDOW SCHEDULES 4 DETAILS

STRUCTURAL

BASEMENT/ FOUNDATION LEVEL AND FIRST FLOOR FRAMING PLAN CEILING FRAMING PLAN ROOF FRAMING PLAN BASEMENT/ FOUNDATION SECTIONS

1. PROJECT DATA

1. LOCATION

A. LEGAL DESCRIPTION:

ALL OF BLOCK 15, IN THE CITY OF TAHLEQUAH, OKLAHOMA, ACCORDING TO THE OFFICIAL PLAT THEREOF, KNOWN AS THE CHEROKEE SUPREME COURT BUILDING.

2. SITE DATA

NORTH

A. TOTAL SITE AREA

SECOND LEVEL TOTAL GROSS SQUARE FOOTAGE

8662 SF

LOCATION PLAN CS NOT TO SCALE

2. CODE REVIEW

INTERNATIONAL BUILDING CODE INTERNATIONAL MECHANICAL CODE INTERNATIONAL PLUMBING CODE NATIONAL ELECTRIC CODE INTERNATIONAL FIRE CODE 2003 2003 2003 2008 2003

OCCUPANCY:

CONSTRUCTION TYPE:

HEIGHT/AREA LIMITATIONS:

FULLY SPRINKLERED NEPA 13 SYSTEM ALLOWABLE (STORIES/SF/HEIGHT) I STORY/ 6,000 SF/ 40 FT PER TABLE 503

2 STORIES/ 12,0005F/ 60 FT PER 5042 4 506.3

TOTAL ALLOWABLE AREA FER FLOOR 24000SF.

THE RESISTIVE RECORDENES -		
STRUCTURAL FRAME	Ø HR	TABLE 60
EXTERIOR BEARING WALLS	Ø HR	TABLE 601
INTERIOR BEARING WALLS	Ø HR	TABLE 601
EXTERIOR NON BEARING WALLS	Ø HR	TABLE 601
INTERIOR NON BEARING WALLS	Ø HR	TABLE 601
FLOOR CONSTRUCTION	Ø HR	TABLE 601
ROOF CONSTRUCTION	Ø HR	TABLE 601
CORRIDORS	Ø HR	TABLE 1016

- ALL EXTERIOR AND INTERIOR RESTORATION, AND NEW CONSTRUCTION IN HISTORICALLY CONTRIBUTING AREAS, MUST CONFORM WITH THE SECRETARY OF INTERIORS STANDARDS FOR REHABILITATION, AS PUBLISHED BY THE U.S. DEPARTMENT OF INTERIOR, NATIONAL PARK SERVICE.
- THESE DOCUMENTS INDICATE THE INTENT OF THE PHASE ONE IMPROVEMENTS/REPAIRS AND MAY REQUIRE ADDITIONAL INTERPRETATION OR DETAIL AS CONSTRUCTION CONDITIONS OCCUR. DIRECT ALL QUESTIONS TO THE OWNER OR ARCHITECT PRIOR TO INSTALLATION.
- THE SQUARE FOOTAGE IN THESE DOCUMENTS, DEFINED AS TOTAL AREA, WAS CALCULATED FROM THE EXTERIOR FACE OF WALL AT EACH LEVEL.
- ALL WORK SHALL MEET ALL GOVERNING CODE JURISDICTIONS AND ADAGE ACCESSIBILITY REQUIREMENTS. CONTRACTOR SHALL REVIEW SITE CONDITIONS & INCLUDE ACCESSIBLE COMPONENTS AS REQUIRED.
- 5. VERIFY ALL DIMENSIONS AND CONDITIONS SHOUN ON THESE DRAWINGS WITH THOSE AT THE SITE PRIOR TO CONSTRUCTION.
- 6. CONTRACTOR SHALL COORDINATE ALL USE OF THE SITE WITH THE OWNER PRIOR TO CONSTRUCTION.
- REFER TO TECHNICAL SPECIFICATION, CHEROKEE NATION ENTERTAINMENT REQUEST FOR PROPOSAL, FOR ADDITIONAL BID
- 8. FINAL LOCATIONS OF FIRE EXTINGUISHERS SHALL BE DETERMINED BY THE OFFICE OF CHEROKEE NATION RISK MANAGEMENT.
- FROJECT SIGN:
 CONTRACTOR SHALL PROVIDE 8'-0" X 6'-0" EXTERIOR WEATHER PROOF PROJECT SIGN THAT LISTS THE NAME OF THE PROJECT,
 OWNER, ARCHITECT, CONTRACTOR AND FUNDING SOURCES. SUBMIT COPY TO OWNER FOR APPROVAL PRIOR TO FABRICATION.
- CONTRACTOR SHALL REFER TO CUNER PROVIDED ENVIRONMENTAL REPORT, CONTRACTOR SHALL BE RESPONSIBLE TO REMEDIATE CONTAMINANTS RELATED TO THE SCOPE OF WORK. CONTAMINANTS INCLUDING BUT NOT LIMITED TO ASBESTOS, MOLD, TERMITE, SOIL 4 LEAD.
- II. CONTRACTOR TO PROVIDE 24 HR NOTICE TO OWNER FOR COORDINATION OF ALL TESTING.

4. MISC. CODE ISSUES

THIS PROJECT IS GOVERNED BY THE REQUIREMENTS ESTABLISHED BY THE OFFICE OF CHEROKEE NATION RISK MANAGEMENT. ALL PROPOSED MODIFICATIONS TO THESE DOCUMENTS SHALL BE REVIEWED AND APPROVED BY THE OFFICE OF CHEROKEE NATION RISK MANAGEMENT FRICAR TO COMMENCEMENT OF THE WORK.

5. REVISION LOG

NAME:	DATE:

6. MOCK-UP LIST

- FULL WINDOW ASSEMBLY IN MASONRY OPENING
- CONDITION(5)

 ALL TRIM PROFILES AND ASSEMBLIES WITH FINISH CHOICES

CHOICES

STONE WALL ASSEMBLIES WITH WATERPROOFING, FLASHING AND SEALANTS

SOFFIT AND FASCIA MOCKUP WITH ROOFING MATERIAL, FLASHING, ETC.

REFER TO PROJECT MANUAL FOR ADDITIONAL MOCK-UP 4 SUBMITTAL REQUIREMENT

 \bigcirc

ं °े |

O OOCHRET DO

AVE

MSKOGEE /

· O.

0016510

SITE PLAN

CIOI 1/32" • 1'-@"

156 100

ALL SITE LIGHTING TO BE RECONNECTED TO EXISTING CIRCUITS PRIOR TO BACKFILL. COORDINATE WITH OUNER ANY REPAIRS NECESSARY TO BE FERFORMED BY FACILITIES DISCONNECTED DURACTED DURACTED DURACTED PRIOR TO BACKFILL BEACKFILL

REMOVE EXISTING
CONCRETE RAMP,
STAIRS, BASETIENT
WALLS I FOUNDATIONS
COORDINATE WITH
NEW CONSTRUCTION

E. KEETOOWAH ST

ASPHALT

ALL BITE LIGHTING TOBE RECONNECTED TO
EXIBITING CIRCUITS
FRIOR TO BACKFILL.
CORONNATE WITH
CUNER ANY REPAIRS
NECESSARY TO BE
PERFORMED BY
FACILITIES
DISCOVERED DURING
DEMOLITION TO BE

0

EXISTING CONCRETE SIDEWALK TO BE REMOVED 4 REPLACED- COLOR AND TEXTURE TBD -FINAL EXTENT TBD IN FIELD


4/01/02

EXISTING
UTILITY
ENTRIES 4
EQUIPMENTMAINTAIN
DURING
CONSTRUCTION

SH)


رکیده:

رکیہ

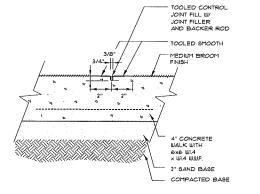

WATER /

SIDEWALK CONTROL JOINT DETAIL SIDEWALK EXPANSION JOINT DETAIL CIOI SCALE I" . I .O" CHOI SCALE I' . I'-0"

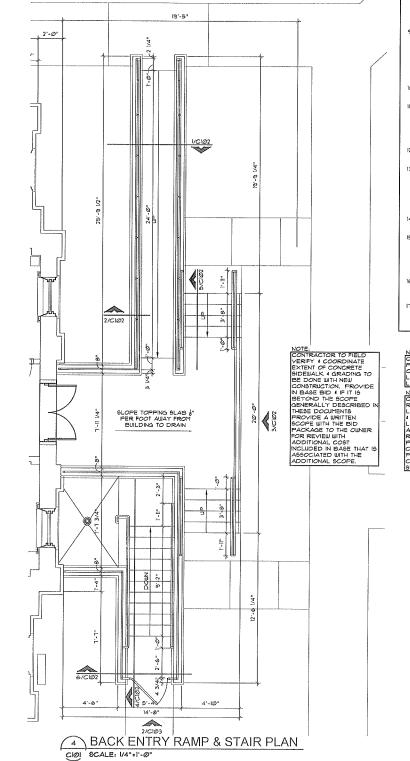

SITE GENERAL NOTES

1/2" EXPANSION

TOOLED EDGE

" CONC. WALK WITH 6x6 W 1.4

1/2" SMOOTH ROD

COMPACTED BASE

× 2'-0" 12" O.C.

JOINT WITH SEALER

X W 1.4 W/WF

TO BE AS SHOWN ON

PLANS AND/OR SPECIFIED.

2. EXPANSION JOINTS

TO BE 30'-0" O.C. MAX.

NOTES:

- CONTRACTOR SHALL VERIFY THAT THE EXISTING UNDERGROUND STORY DRAINS NOT AFFECTED BY NEI STORY DRAIN AND PERIMETER DRAINAGE SYSTEM ARE CLEAR IN MORKING CONDITION, SNAKE ALL CLOGGED DRAINS AS NEEDED TO PROVIDE AN OPERATING SYSTEM.
- CONTRACTOR SHALL MAKE THE OWNER AWARE OF THEXISTING SITE WORK CONDITIONS, CONTRACTOR SHALL REPAIR OR REPLACE ANY AREAS DAMAGED BY CONSTRUCTION ACTIVITIES.
- CONTRACTOR 19 RESPONSIBLE FOR PROVIDING ALL NEW UTILITIES/SERVICE LINES TO THE BUILDING IF REQUIRED FOR NEW CONSTRUCTION, INCLUDING ALL TAP FLES, REPAIR PAVING, LANDSCAPING OR SIDEWALK AREAS IF DISTURBED.
- EXISTING LAWN IF UNDISTURBED SHALL BE CLEANED, AERATED AND SEEDED.
- LANDSCAPED AREAS SHALL BE BY THE OWNER'S FACILITIES GROUP. COORDINATE WITH THE OWNER
- CONTRACTOR SHALL ACKNOWLEDGE THAT THE EXISTING TREES, SHRUBS, AND VARIOUS LANDSCA. ARE IN AGOD CONDITION. CONTRACTOR SHALL REPAIR OR REPLACE ANY AREAS DAMAGED BY CONSTRUCTION ACTIVITIES.
- I. PROVIDE CONCRETE PADS AT ALL MECHANICAL UNIT.
- PROVIDE FOR TEMPORARY POWER, LIGHTING, FLUTHING 4 HVAC DURING CONSTRUCTION. THE BUILDING WILL BE OPERATIONAL 4 NEEDS TO BE MAINTAINED OPERABLE, COORDINATE WITH THE DUNER PRIOR TO CONTRICTION ACTIVITY WILL BE PERCHITED 4 IN WHAT HANNER THE GITE FULLY BE MAINTAINED.
- FINAL GRADE ELEVATIONS OF NEW PAVING, SIDEWALKS ETC. 8HALL BE ESTABLISHED DURING CONSTRUCTION BY THE CONTRACTOR, GRADES SHALL BE APPROVED BY THE CUNER AND ARCHITECT, PROVIDE A POSITIVE SLOPE AWAY FROM THE BUILDING, TOP OF GRADE SHALL ALIGN WITH ADJACENT PAVING OR RETAINING WALL, MATCH EXISTING SITE DRAINAGE PATTERNS, FIELD VERIFY PRIOR TO BID.
- ALL SITE STEPS, RAMPS & RAILINGS SHALL MEET ADAAG REQUIREMENTS.
- ADDITIONAL PAVING SAUCUT/EXPANSION JOINTS MAY BE RECUIRED TO PROVIDE PROPER EXPANSION CONTRACTION FINAL CONFIGURATION SHALL BE DETERMINED AT THE SITE BY THE CONTRACTOR (AFPROVED BY THE OWNER (ARCHITECT, PROVIDE PROPER JOINTS AT ALL BUILDING EDGES.
- PROVIDE A POSITIVE SLOPE OF ALL GRADE TO MUNICIPAL STORM WATER DRAIN INLETS.
- . LOCATION OF ANY NEW OR TEMPORARY
 TRANSFORMERS, GAŠ 4 ELECTRIC METERŠ TO BE
 DETERMINED, FINAL LOCATION SHALL BE AFFROVED
 BY COURER ARCHITECT, CNLY (MOERGROUND LINES
 TO BE DETERMINED IN THE RELL OF CORDINATED
 WITH FUTURE PHASES OF CONSTRUCTION.
- SIDEWALK ACCESSIBLE ROUTE SHALL NOT EXCEED A SLOPE OF 1:20.
- CONTRACTOR MUST MAINTAIN THE CONSTRUCTION SITE IN A SAFE MANNER DAILY CLEANUP IS REQUIRED OF ALL TRADES AND THE CONTRACTOR MAINTAIN FENCING OF OTHER BARRIERS THAT ELIMINATE THE OPPORTUNITY FOR NOVIDUALS NOT INVOLVED IN THE WORK ACCESS INTO THE CONSTRUCTION AREA.
- PROTECT ADJACENT BUILDING DURING CONSTRUCTION CONTRACTOR SHALL REPAIR OR REPLACE ANY AREAS DAMAGED BY CONSTRUCTION ACTIVITIES.
- 11. CONTRACTOR TO PROVIDE FOR THE INSTALLATION OF CHEROKEE SITE SIGNAGE FOR WAY FINDING 4 ACCESSIBILITY. COORDINATE WITH THE OWNER PRIOR TO COMMENCING WORK.

NOTE:
CONTRACTOR TO PROVIDE
PATH FROM BASEMENT TO
OUTSIDE OF SIDEWALK
LINE FOR FUTURE SITE LIGHTING IN BASE BID

NOTE: CONTRACTOR TO PROVIDE RECESSED TREAD
LIGHTING AT EACH TREAD
RECESSED SIDE
LIGHTING AT 24" OC.
ALONG EACH SIDE OF
AMPIN IN BASE BID.
PROVIDE FOR FIXTURES,
COMDUIT, BREAKERS
POWER SUPPLY FOR
COMPULET OPERATIONAL
SYSTEM. Шΰ _ : ⋖

Z α Ш α ⋖ S Ш \leq S

406 S. BOULDER AVENUE. 918:599:0541 FAX: 918:599:0983

One

Capitol Nation S Cherokee


Phase

Tahlequah, CHECKED BY MOS

SSUED:

<u>8</u> $\overline{\Omega}$ Site

C101

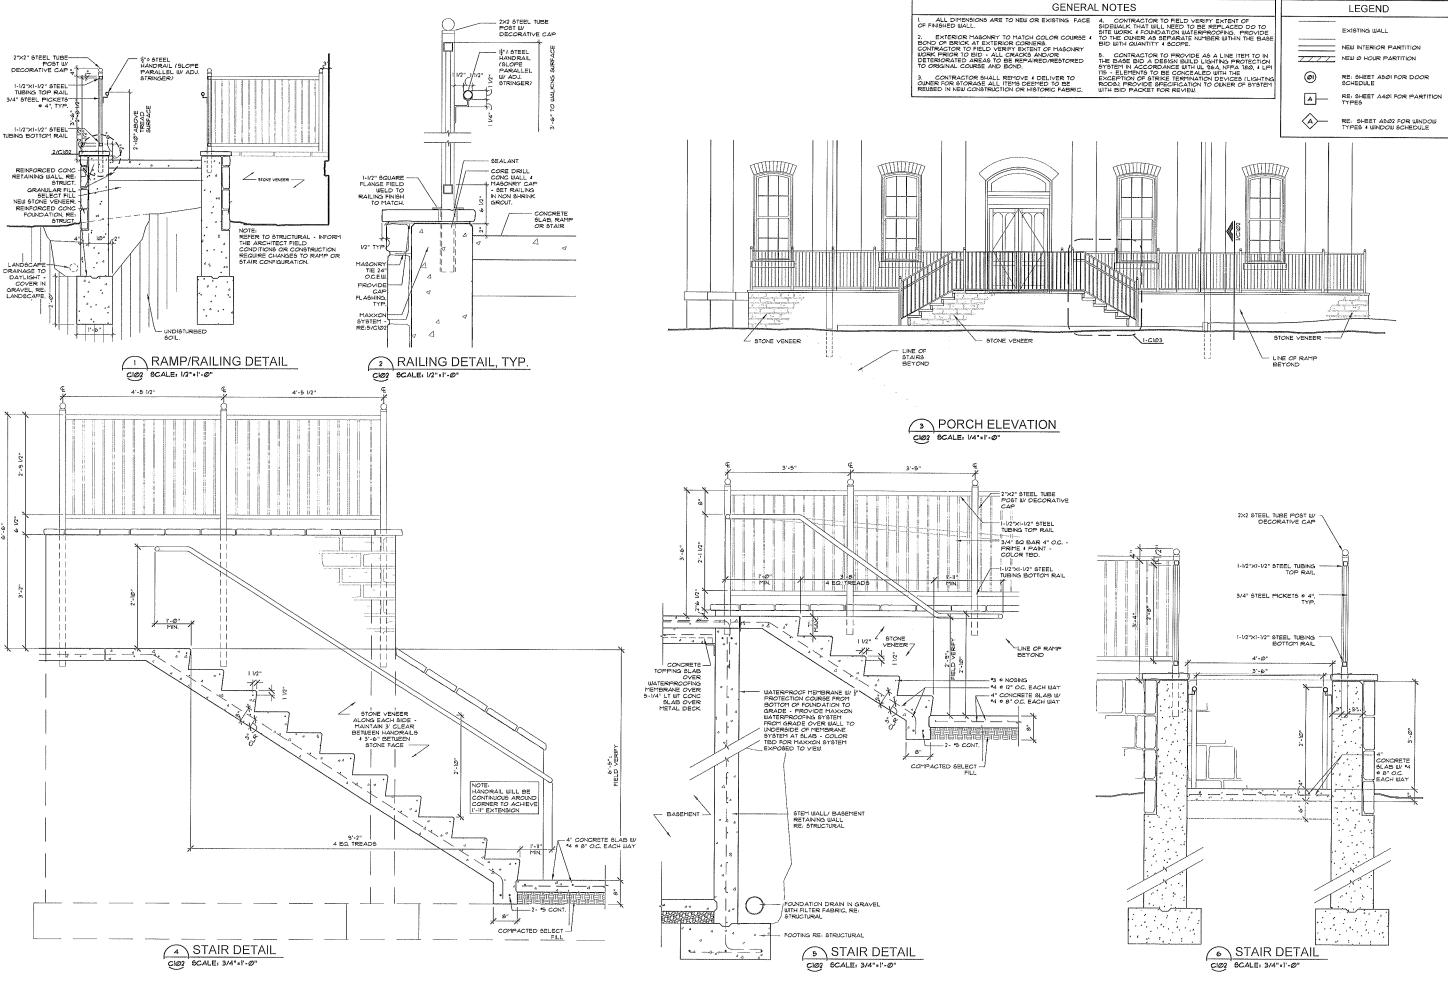

406 S. BOULDER AVENUE 918.599.0541 FAX: 918.599.0983 ESA ∾ ⊼

I

⋖

Z

 α Ш

 $_{\Omega}$

One $\mathbf{\Phi}$ Phase E Capitol


Cherokee Nation

Tahlequah Che DRAUN BY:


HECKED BY SSUED: REVISIONS

Details Site

C102

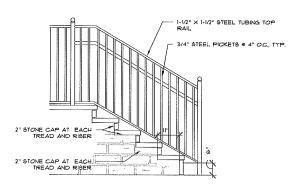

STAIR SIDE ELEVATION

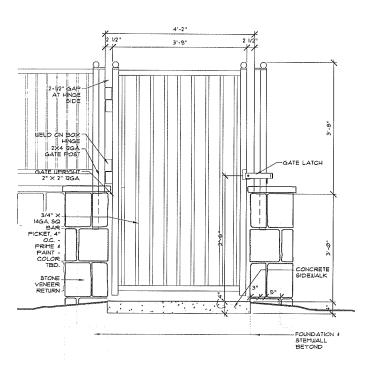

GATE ELEVATION

GIØ3 GCALE: 3/4"«1'-@"

GENERAL NOTES

2. EXTERIOR MASONRY TO MATCH COLOR COURSE 4
BOND OF BRICK AT EXTERIOR CORNERS.
CONTRACTOR TO FIELD VERIFY EXTENT OF MASONRY
WORK PRIOR TO BID - ALL CRACKS AND/OR
DETERIORATED AREAS TO BE REPAIRED/RESTORED
TO ORIGINAL COURSE AND BOND.

1. ALL DIMENSIONS ARE TO NEW OR EXISTING FACE
OF FINISHED WALL.
2. EXTERIOR MASONRY TO MATCH COLOR COURSE
BOND OF BRICK AT EXTERIOR CORNERS.
10 THE QUARK AS SEPARATION WATER WITHIN THE BASE
BOND OF BRICK AT EXTERIOR CORNERS.
10 THE QUARK AS SEPARATION AS WASONRY
10 THE QUARK AS SEPARATION AS WASONRY
11 THE MASONRY TO THE PROPERTY OF MASONRY
12 THE COURSE AS SEPARATION AS WASONRY
13 THE COURSE AS SEPARATION AS WASONRY
14 SCOPE.

5. CONTRACTOR TO PROVIDE AS A LINE ITEM TO IN THE BASE BID A DESIGN BUILD LIGHTING PROTECTION SYSTEM IN ACCORDANCE WITH UL 364, NFPA 186, 4 LP ITS - ELEMENTS TO BE CONCEALED WITH THE EXCEPTION OF STRIKE TERMINATION DEVICES (LIGHTIN RODS). PROVIDE SPECIFICATION TO GUNER OF SYSTEM WITH BID PACKET FOR REVIEW.

LEGEND

EXISTING WALL

NEW INTERIOR PARTITION NEW Ø HOUR PARTITION

(01) RE: SHEET A501 FOR DOOR SCHEDULE

A---RE: SHEET A401 FOR PARTITION TYPES

RE: SHEET A502 FOR WINDOW TYPES 4 WINDOW SCHEDULE

SIKES ABERNAT 406 S. BOULDER AVENUE. 918.599.0541 FAX: 918.599.0983

Ш Ш



One Phase

Cherokee Nation Capitol

Tahlequah, DRAWN BY: CHECKED BY: MOS BSUED:

Details Site

REVISIONS

C103

NORTH

DEMOLITION LEGEND

EXISTING WALLS, DOORS, ETC. TO REMAIN, REMOVE MISC. FINISHES WHICH CONFLICT WITH NEW CONSTRUCTION

EXISTING WALLS, DOORS, ETC. TO BE REMOVED FROM FINISH FLOOR TO ROOP. CONTRACTOR SHALL INCLUDE IN SCOPE OF WORK MISC.

DEMOLITION OF ITEMS NOT SHOWN ON THESE DRAWINGS TO PROVIDE THE INTENT OF THE DESIGN.

CONTRACTOR SHALL NOTIFY THE ARCHITECT OF ALL ITEMS NOT SHOWN WHICH CONFLICT WITH DEMOLITION FOR ADDITIONAL NISTRICTIONS, ALL DOORS, FRAMES, MILLWORK, ETC TO BE SALVAGED (STOCKPILED.

Ī ΤY

Z ¾ α Ш

 $_{\Omega}$

⋖

S

Ш

 $\frac{S}{X}$

One

Phase

-

Capitol

엉

406 S. BOULDER AVENUE, SUITE 700 918 599:0541 FAX: 918.599.0983

DEMO KEYNOTE LEGEND

- COORDINATE LOCATION WITH QUINER ARCHITECT FOR TEST AREAS TO REMOVE PAINT FROM BRICK. TEST POSSIBLE METHODS TO REMOVE PAINT SAND-BLASTIN IS NOT AN ACCEPTABLE SOLUTION TO REMOVING PAINT, CONTRACTOR IS TO ACCEPTABLE OF THE CUNIERY ARCHITECT. AS TO THE CONTRACTOR TO AND THE CONTRACTOR TO A THE CONTR

- REMOVE EXISTING WINDOW SASH 4
 DETERIORATED PORTIONS OF FRAME, ETC.
 THAT CANNOT BE RESTORED, RE: NP3
 PRESERVATION BRIEFS.
- REMOVE CONCRETE SLAB.
- REMOVE EXISTING SHINGLES REMOVE DETERIORATED DECKING SALVAGE EXISTING DECK FOR RE-USE IN NEU CONSTRUCTION PROTECT STRUCTURE FOR NEW CONSTRUCTION PROTECT STRUCTURE FOR SUPPORTS, ROOF RAFTERS 1 SUBSTRATE.
- REMOVE EXISTING STEPS- PREPARE AREA FOR INFILL.
- REMOVE ABANDONED MASONRY CHASE FROM GROUND TO TOP SHORE ALL ADJACENT SURFACES/MEMBERS STORE THASONRY FOR RE-USE IF IT MATCHES THE HISTORIC,
- REMOVE ALL LOOSE MASONRY & MORTAR -PREP FOR REINSTALL W IN-KIND MASONRY & MORTAR, RE: SPEC SECTIONS 04860, 04900 04901, NPS PRESERVATION BRIEF 24 NEW CONST.
- IÓ. CAREFULLY REMOVE CEMENTITIOUS STUCCO MATERIAL FROM STONE WATER TABLE, GENTLY CLEAN STONE SURFACE OF ANY ADDITIONAL STUCCO IN THE CRACKS AND CREVASSES, THEN REPAIR THE DETERIORATED STONES AS NECESSARY, LASTLY, REMOVE DETERIORATED ANY AND RE-TUCK POINT THESE AREAS.
- EXCAVATE SOIL AT EXTERIOR WALL TO BOTTOM OF FOUNDATIONS, PREPARE WALL SURFACE TO APPLY WATERPROOFING MEMBRANE WITH PROTECTION COURSE.
- PREPARE AREA FOR NEW ROOF CONSTRUCTION, RE: STRUCTURAL FOR SUPPORTS, ROOF RAFTERS & SUBSTRATE.
- DEMO EXISTING CONCRETE LANDING, RAMP, STEPS, GUARDRAILS AND HANDRAILS. SALVAGE GUARDRAILS AND HANDRAILS FOR OWNER.



- EXISTING DOOR TO BE REMOVED 4 EXISTING FRAME TO REMAIN.
- REMOVE EXISTING DOOR & FRAME, PREPARE OPENING FOR NEW DOOR & FRAME.

- REMOVE EXIBITING METAL GUTTER AND DOUNSPOUTS PRIME 4 PAINT, COLOR TO B DETERMINED,

- REMOVE EXISTING BASEMENT WALLS, FLOORS, DOORS, WINDOWS, FOUNDATIONS, ELECTRICAL, PLUTBING, MECHANICAL, ETC. TO FREPARE FOR NEW CONSTRUCTION, RE: NEW CONSTRUCTION FROVIDE FOR SHORING OF EXISTING TO REMAIN REPORT TO CUNER UNDERGROUND CONDITIONS.

Cherokee Nation Tahlequah, (CHECKED BY: ISSUED: REVISIONS

Basement Level Demolition Plan

NORTH

FIRST LEVEL FLOOR PLAN DIDI SCALE: 1/4" : 1'-0"

DEMOLITION LEGEND


EXISTING WALLS, DOORS, ETC. TO REMAIN. REMOVE MISC. FINISHES WHICH CONFLICT WITH NEW CONSTRUCTION

EXISTING MALLS, DOORS, ETC. TO BE REPOYED FROM FINISH FLOOR TO ROOF CONTRACTOR SHALL INCLUDE IN SCOPE OF BURNEY HISC. DEPOLITION OF ITEMS NOT SHOUN ON THESE DRAWINGS TO PROVIDE THE INTENT OF THE DESIGN. CONTRACTOR SHALL NOTIFY THE ARCHITECT OF ALL ITEMS NOT SHOUN WHICH CONFLICT WITH DEPOLITION FOR ADDITIONAL INSTRUCTIONS FOR ADDITIONAL INSTRUCTIONS FOR ADDITIONAL INSTRUCTIONS FOR ADDITIONAL STRUCTIONS, ALL DOORS, FRAMES, MILLWORK, ETC TO BE SALVAGED 1 STOCKPILED.

DEMO KEYNOTE LEGEND

- COORDINATE LOCATION WITH OWNER/
 ARCHITECT FOR TEST AREAS TO REMOVE
 PAINT FROM BRICK. TEST POSSIBLE
 METHODS TO REMOVE PAINT, SAND-BLASTII
 IS NOT AN ACCEPTABLE SOLUTION, TO
 REMOVING PAINT, CONTRACTOR IS TO
 REMOVING PAINT, CONTRACTOR IS TO
 REFERRATE AND THE CANDEL ARCHITECT,
 REFER TO NEPA TECHNICAL BRIEFS FOR
 ADDITIONAL MASONEY RESTORATION AND
 TUCK PONTING REQUIREMENTS.
- REMOVE EXISTING DOOR 4 FRAME, PREPARE OPENING FOR NEW DOOR 4 FRAME.
- REMOVE EXISTING WINDOW SASH 4
 DETERIORATED PORTIONS OF FRAME, ETC.
 THAT CANNOT BE RESTORED, RE: NPS
 PRESERVATION BRIEFS.
- REMOVE CONCRETE SLAB.
- REMOVE EXISTING SHINGLES REMOVE DETERIORATED DECKING SALVAGE EXISTING DECK FOR RE-USE IN NEW CONSTRUCTION PROTECT STRUCTURE FOR SIMPORTS, ROOF RAFTERS 1 SUBSTRATE.
- REMOVE ABANDONED MABONRY CHASE FROM GROUND TO TOP SHORE ALL ADJACENT SURFACESMEMBERS STORE MASONRY FOR RE-USE IF IT MATCHES THE HISTORIC.
- REMOVE ALL LOOSE MASONRY 4 MORTAR -PREP FOR REINSTALL BY IN-KIND MASONRY 4 MORTAR, RE: SPEC SECTIONS 24862, 24922, 24921, NPS PRESERVATION BRIEF 24 NEW CONST.
- Ø. CAREFULLY REMOVE CEMENTITIOUS STUCCO MATERIAL FROM STONE BURFACE OF ANY ADDITIONAL STUCCO IN THE CRACKS AND CREVASSES, THEN REPAIR THE DETERIORATED STONES AS NECESSARY. LASTLY, REMOVE DETERIORATED MORTAR AND RE-TUCK POINT THESE AREAS.
- EXCAVATE SOIL AT EXTERIOR WALL TO BOTTOM OF FOUNDATIONS, PREPARE WALL SURFACE TO APPLY WATERPROOFING MEMBRANE WITH PROTECTION COURSE.
- 12. REMOVE EXISTING METAL GUTTER AND DOUNSPOUTS PRIME 4 PAINT, COLOR TO BE DETERMINED.
- PREPARE AREA FOR NEW ROOF CONSTRUCTION. RE: STRUCTURAL FOR SUPPORTS, ROOF RAFTERS & SUBSTRATE.

- 16. REMOVE EXISTING BASEMENT WALLS, FLOORS, DOORS, WINDOWS, FOUNDATIONS, ELECTRICAL, FLUTBING, MECHANICAL, ETC. TO PREPARE FOR NEW CONSTRUCTION, RE: NEW CONSTRUCTION, RE: NEW CONSTRUCTION OF SHORING OF EXISTING TO REMAIN REPORT TO OWNER UNDERSKOND CONDITIONS.

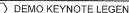

- EXISTING DOOR TO BE REMOVED 4 EXISTING FRAME TO REMAIN,
- REMOVE EXISTING STEPS- PREPARE AREA FOR INFILL.

E



SECOND LEVEL FLOOR PLAN

DEMOLITION LEGEND

EXISTING MALLS, DOORS, ETC. TO BE REMOVED FROM FINISH FLOOR TO ROOF. CONTRACTORS SHALL INCLUDE IN SCOPE OF WORK MISC. DEMOLITION OF ITEMS NOT SHOUN ON THESE DRAWINGS TO FROVIDE THE INTENT OF THE DESIGN. CONTRACTOR SHALL NOTIFY THE ARCHITECT OF ALL ITEMS NOT SHOWN WHICH CONFLICT WITH DEMOLITION FOR ADDITIONAL INSTRUCTIONS, ALL DOORS, FRAMES, MILLWORK, ETC TO BE SALVAGED \$

STOCKPILED.

DEMO KEYNOTE LEGEND

- REMOVE EXISTING DOOR 1 FRAME, PREPAR OPENING FOR NEW DOOR 1 FRAME.
- REMOVE EXISTING WINDOW 9ASH &
 DETERIORATED PORTIONS OF FRAME, ETC.
 THAT CANNOT BE RESTORED, RE; NPS
 PRESERVATION BRIEFS.
- REMOVE CONCRETE SLAB.
- REMOVE EXISTING SHINGLES REMOVE DETERIORATED DECKING SALVAGE EXISTING DECK FOR RE-USE IN NEW CONSTRUCTION PROTECT STRUCTURE FOR NEW CONSTRUCTION RE: STRUCTURAL FOR SUPPORTS, ROOF RAFTERS 4 SUBSTRATE,
- REMOVE EXISTING STEPS- PREPARE AREA FOR INFILL.
- REMOVE ABANDONED MASONRY CHASE FROM GROUND TO TOP SHORE ALL ADJACENT SURFACES/MEMBERS STORE MASONRY FOR RE-USE IF IT MATCHES THE HISTORIC,
- REMOVE ALL LOOSE MASONRY 4 MORTAR -PREP FOR REINSTALL W IN-KIND MASONRY 4 MORTAR RE: SPEC SECTIONS Ø4860, Ø4900, Ø4901, NPS PRESERVATION BRIEF 24 NEW CONST.
- 12. CAREFULLY REMOVE CEMENTITIOUS STUCCO MATERIAL REOM STONE BUSFACE OF ANY ACTIVITY CLEAN STONE SUSFACE OF ANY ADDITIONAL STUCCO IN THE CRACKS AND CREVASSES, THEN REPAIR THE DETERIORATED STONES AS NECESSARY, LASTLY, REMOVE DETERIORATED MORTAR AND RE-TUCK POINT THESE AREAS.
- EXCAVATE SOIL AT EXTERIOR WALL TO BOTTOM OF FOUNDATIONS, PREPARE WALL SURFACE TO APPLY WATERPROOFING MEMBRANE WITH PROTECTION COURSE.
- PREPARE AREA FOR NEW ROOF CONSTRUCTION, RE: STRUCTURAL FOR SUPPORTS, ROOF RAFTERS 4 SUBSTRATE.
- DEMO EXISTING CONCRETE LANDING, RAMP, STEPS, GUARDRAILS AND HANDRAILS. SALVAGE GUARDRAILS AND HANDRAILS FOR OWNER.
- 16. REMOVE EXISTING BASEMENT WALLS, FLOORS, DOORS, WINDOWS, FOUNDATIONS, ELECTRICAL, FLUYBING, MECHANICAL, ETC. TO PREPARE FOR NEW CONSTRUCTION, PER, NEW CONSTRUCTION PROVIDE FOR SHORING OF EXISTING TO REMAINS TO REMAIN REPORT TO OWNER UNDERGROUND CONDITIONS.



- CORDINATE LOCATION WITH OWNER/
 ARCHITECT FOR 1551 AREAS TO REMOVE
 PAINT FROM BRICK. 1551 POSSIBLE
 METHODS TO REMOVE PAINT, SAND-BLASTIN
 IS NOT AN ACCEPTABLE SOLUTION. TO
 REMOVING PAINT, CONTRACTOR IS TO
 REMOVING PAINT, CONTRACTOR IS TO
 REPOVED ST THE CUNREY ARCHITECT.
 REPREVED BY THE CUNREY ARCHITECT.
 REPREVED BY A TEAM TO BE REES FOR
 ACCEPTABLE OF THE CUNREY ARCHITECT.
 ACCEPTABLE OF THE CONTRACTOR AND
 LUCK POINTING REQUIREMENTS.
- EXISTING DOOR TO BE REMOVED 4 EXISTING FRAME TO REMAIN.

- REMOVE EXISTING METAL GUTTER AND DOWNSPOUTS PRIME 4 PAINT, COLOR TO BE DETERMINED,

I ∢ ° Z α Ш \mathbf{m} \forall

Ш≝

406 S. BOULDER AVENUE. 918.599.0541 FAX: 918.599.0983 S Ш \preceq S




O Phase Capitol

Nation Տ Cherokee Tahlequah,

DRAWN BY: CHECKED BY: 12/15/12

SSUED: REVISIONS

Second Level Demolition Plan

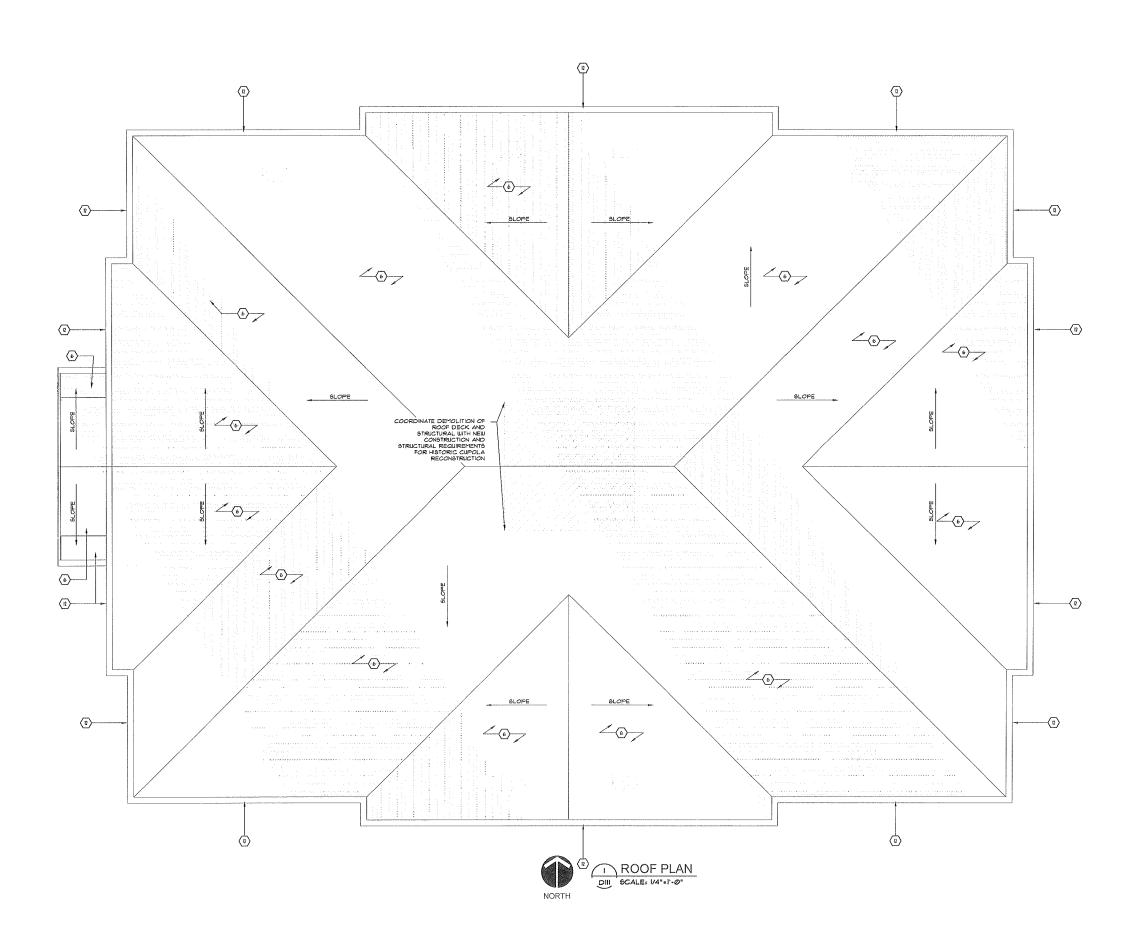

DEMOLITION LEGEND

CONSTRUCTION

EXISTING WALLS, DOORS, ETC. TO BE
REPOVED FROM FINISH FLOOR TO
REPOVED FROM FINISH FLOOR TO
ROOF CONTRACTOR SHALL INCLUDE
IN SCOPE OF BURK MISC.
DEPIOLITION OF ITEMS NOT SHOUN ON
THESE DRAWINGS TO PROVIDE THE
INTENT OF THE DESIGN.
CONTRACTOR SHALL NOTIFY THE
ARCHITECT OF ALL ITEMS NOT
SHOUN WHICH CONFLICT WITH
DEMOLITION FOR ADDITIONAL
INSTRUCTIONS, ALL DOORS, FRAMES,
MILLWORK, ETC TO BE SALVAGED 4
STOCKPILED.

DEMO KEYNOTE LEGEND

- REMOVE EXISTING STEPS- PREPARE AREA FOR INFILL.
- REMOVE ABANDONED MASONRY CHASE FROM GROUND TO TOP SHORE ALL ADJACENT SURFACES/MEMDERS STORE HASONRY FOR RE-USE IF IT MATCHES THE HISTORIC.
- REMOVE ALL LOOSE MASONRY 4 MORTAR -PREP FOR REINSTALL W IN-KIND MASONRY 4 MORTAR, RE: SPEC SECTIONS Ø4360, Ø4900 Ø4901, NPS PRESERVATION BRIEF 24 NEW CONST.
- IO. CAREFULLY REMOVE CEMENTITIOUS STUCCO MATERIAL FROM STONE BURFACE OF ANY ADDITIONAL STUCCO IN THE CRACKS AND CREVASSES, THEN REPAIR THE DETERIORATED STONES AS NECESSARY, LASTLY, REMOVE DETERIORATED MORTAR AND RE-TUCK POINT THESE AREAS.
- PREPARE AREA FOR NEW ROOF CONSTRUCTION. RE: STRUCTURAL FOR SUPPORTS, ROOF RAFTERS & SUBSTRATE.
- DEMO EXISTING CONCRETE LANDING, RAMP, STEPS, GUARDRAILS AND HANDRAILS, SALVAGE GUARDRAILS AND HANDRAILS FOR CUNER.
- EXISTING STAIRS TO REMAIN PROTECT DURING CONSTRUCTION,

- COORDINATE LOCATION WITH OWNER/
 ARCHITECT FOR TEST AREAS TO REMOVE
 PAINT FROM BRICK. TEST POSSIBLE
 METHODS TO REMOVE PAINT, SAND-BLASTII
 IS NOT AN ACCEPTABLE SOLUTION. TO
 REMOVIN'S PAINT. CONTRACTOR IS TO
 PROVIDE A TEN TEST AREAS TO BE
 AFFROVED BY THE OWNER/ ARCHITECT.
 RETER TO NUMER/ ARCHITECT.
 ACT TO THE CONTRACTOR ATTON
 AND THE CONTRACT PORTION AND
 THICK POINTING REQUIREMENTS.
- EXISTING DOOR TO BE REMOVED 4 EXISTING FRAME TO REMAIN,
- REMOVE EXISTING WINDOW SASH I DETERIORATED PORTIONS OF FRAME, ETC. THAT CANNOT BE RESTORED, RE: NPS PRESERVATION BRIEFS.
- REMOVE CONCRETE SLAB.
- REMOVE EXISTING SHINGLES REMOVE DETERIORATED DECKING SALVAGE EXISTING DECK FOR RE-USE IN NEW CONSTRUCTION PROTECT STRUCTURE FOR NEW CONSTRUCTION RE- STRUCTURAL FOR SUPPORTS, ROOF RAFTERS 1 SUBSTRATE.

- EXCAVATE 90IL AT EXTERIOR WALL TO BOTTOM OF FOUNDATIONS, PREPARE WALL SURFACE TO APPLY WATERPROOFING MEMBRANE WITH PROTECTION COURSE.
- REMOVE EXISTING METAL GUTTER AND DOUNSPOUTS PRIME 4 PAINT, COLOR TO BE DETERMINED,

- REMOVE EXISTING BASEMENT WALLS, FLOORS, DOORS, WHOOUS, FOUNDATIONS, ELECTRICAL, FLUTIENS, HECHANICAL, FLC. TO PERPARE FOR NEW CONSTRUCTION, RE TO THE MORNING OF EXISTING TO REMAIN. REPORT TO CUNER UNDERGROUND CONDITIONS.



Ш≗

I : R N A Ш Ω

406 S BOULDER AVENUE. 918.599.0541 FAX: 918.599.0983 \triangleleft S Ш \preceq S



One

Phase E \bigcirc Nation 엉

Cherokee Tahlequah, DRAUN BY: KPG CHECKED BY: ISSUED: 10/15/13

Demolition Roof Plan

EVISIONS

3. CONTRACTOR SHALL REMOVE 4 DELIVER TO OWNER FOR STORAGE ALL ITEMS DEEMED TO BE REUSED IN NEW CONSTRUCTION OR HISTORIC FABRIC.

4. CONTRACTOR TO FIELD VERIFY EXTENT OF SIDEWALK THAT WILL NEED TO BE REFLACED DO TO SITE WORK 4 FOUNDAMEN WATERPROOFING. PROVIDE TO THE CUMER AS SEPARATE NUMBER WITHIN THE BASED WITH GUARTITY 4 SECOPE.

5. CONTRACTOR TO PROVIDE AS A LINE ITEM TO IN THE BASE BID A DESIGN BUILD LIGHTING PROTECTION SYSTEM IN ACCORDANCE WITH UI. SAO, AFPA 180, 4 LF ITS - ELEMENTS TO BE CONCEALED WITH THE EXCEPTION OF STRIKE TERMINATION DEVICES (LIGHTIN RODS). PROVIDE SPECIFICATION TO OWNER OF SYSTEM WITH BID PACKET FOR REVIEW.

LEGEND

EXISTING WALL

NEW INTERIOR PARTITION NEW Ø HOUR PARTITION




RE: SHEET A501 FOR DOOR SCHEDULE






- NEW ACCESSIBLE CONCRETE RAMP NOT TO EXCEED 1:12 SLOPE.
- NEW CONG RETAINING WALL W/ STONE VENEER & TOP CAP TO MATCH EXISTING STONE BASE ON BUILDING, RE: STRUCTURAL.
- NEW CONC BASEMENT WALL W/ STONE VENEER & TOP CAP TO MATCH EXISTING STONE BASE ON BUILDING, RE: STRUCTURAL,
- NEW CONCRETE SLAB MATCH EXISTING BASEMENT ELEVATION FINAL EXTENT OF WORK TO BE FIELD VERIFIED PRIOR TO COMMENCING WORK, RE: STRUCTURAL.
- 6. EXISTING TREADS AND RISERS PROTECT DURING CONST.
- NEW CONCRETE SIDEWALK, RE: CIDI.
- NEW METAL GUARDRAILS/ HANDRAILS EACH SIDE PRIME 4 PAINT, RE: X-A412.
- REMOVE ALL LOOSE MASONRY 4 MORTAR AT WINDOW, DOOR OPENINGS INCLUDING HEAD, JAMI 5 ILLI) 4 LOCATIONS OF SETTLEMENT CRACKING REINSTALL W/ IN-KIND MASONRY 4 MORTAR TO MATCH, RE. SPEC SECTIONS Ø480, Ø480, Ø480, Ø480 Ø480 Ø480
- 10. NEW WOOD FRONT ENTRY 4 TRANSOM WITH RESTORED SURROUND REPLACE ALL ITEMS NO ABLE TO BE USE IN KIND TO HATCH EXISTING PROFILES, FILED VERIFY REPLACE MISSING ELEMENTS TO COMPLETE HILLIOPRIC
- NEW WOOD WINDOW, \$484, FRAME, I INTERIOR SILL/TRIM FIELD VERBY OPENING CONDITION REPAIRE SISTING FRAME/TRIM TO MAXIMUM EXTENT POSSIBLE NOTIFY OWNER PRIOR TO COMMENCEM WORK IN HISTORIC OR NEW FRAME I TRIM BILL BE USED FOR ADDITIONAL INSTRUCTION.
- NEW WOOD WINDOW IN EXISTING RESTORED WOOD FRAMES 4 TRIM PER NPS GUIDELINES, RE. A591 -REPAIR OR REPLACE IN-KIND ALL ITEMS NOT ABLE TO BE RESTORED TO MATCH EXISTING PROFILES, FIELD VERIFY.
- 9Q CUT FRT CEDAR SHINGLES OVER "30 ASPHAL SATURATE FELT UNDERLAYMENT OVER EXISTING/ NEW DECKING REPLACE ALL DETERIORATED EXISTING DECKING IN-KIND, RE: STRUCT.
- AREA OF FUTURE MASONRY CHIMNEY BLOCK OUT PER STRUCTURAL FOR FUTURE ADDITION OF CHIMNEY IN PHASE II, SEAL TOP OF EXISTING FLUE, RE: STRUCT.
- IB. NEW AREA DRAIN TIGHTLINE TO STORM SEWER.
- FLUID APPLIED WATERPROOFING WITH I/2" COVER BOARD FROM GRADE TO BOTTOM OF FOUNDATIONS BACKFILL WITH GRAVEL INSIDE FILTER FABRIC TO I" BELOW GRADE BACK FILL REMAINING WITH TOPSOIL TO GRADE PROVIDING POSITIVE DRAINAGE AWAY FROM BUILDING ON ALL SIDES GRAVEL WILL CONTAIN PERIMETER DRAINAGE TIGHTLINED TO STORM.
- NEW WOOD ENTRY DOOR, FRAME, TRANSOM SASH IN RESTORED WOOD SURROUND REPAIR OR PLACE IN-KIND ALL DETERIORATED EXISTING ELEMENTS .
- NEW PRE-FINISHED METAL GUTTER 4 DOWNSPOUTS TIGHTLINE TO STORM SEWER CUSTOM COLOR COLOR TBD.
- NEW WOOD OPERABLE SHITTERS PROVIDE 4
 INSTALL HISTORIC REPLICA HARDWARE COORDINATE WITH GUNERY ARCHITECT PRIOR TO
 ORDERING FINISH TO MATCH ALL EXTERIOR
 HARDWARE, RE: ASO;
- 20. RESTORED WOOD BRACKET, USE IN-KIND MATERIALS, DIMENSIONS, AND CONSTRUC MATCH EXISTING HISTORIC BRACKETS.
- NEW CONCRETE STAIR.
- 22. NEW METAL GJARDRAILS FRIME 4 PAINT COLOR TO MATCH ALL OTHER EXTERIOR
 HARDWARE COORDINATE WITH THE OWNER/
 ARCHITECT PRIOR TO PAINTING.
- 23. NEW METAL 90° 9WING GATE, POWDERCOAT COLOR TRD.
- 24. NEW SOFFIT VENTS SPACED EQUALLY ON EACH SIDE OF THE ROOF- PAINT TO MATCH SOFFIT COLOR TBD.
- 25. NEW CEDAR RIDGE CAP OVER CONTINUOUS LOW PROFILE RIDGE/HIP VENT,
- 26. EXISTING BEAD BOARD SOFFIT OVER 3/8" SHEATHING REPAIR OR REPLACE DETERIORATED BEAD BOARD PRIME 4 PAINT, COLOR TBD.
- 27. EXISTING IX WOOD FASCIA OVER NEW SUBFASCIA REPÁIR OR REPLACE DETERIORATED FASCIA PRIME 4 PAINT, COLOR TBD.
- 28. AUTOMATIC DOOR OPENER/ PUSH PAD.
- 29. NEW WOOD CLAPBOARD SIDING PRIME & PAINT COLOR TBD,
- 30. NEW WOOD TRIM PRIME 4 PAINT COLOR TBD.
- 31. NEW WOOD BRACKET, CORNICE 4 DENTILS TO MATCH HISTORIC PROFILES SIZE 4 EXACT SHAPE MAY VARY TO MEET SPECIFIC CONDITIONS OF NEW CUPOLA.

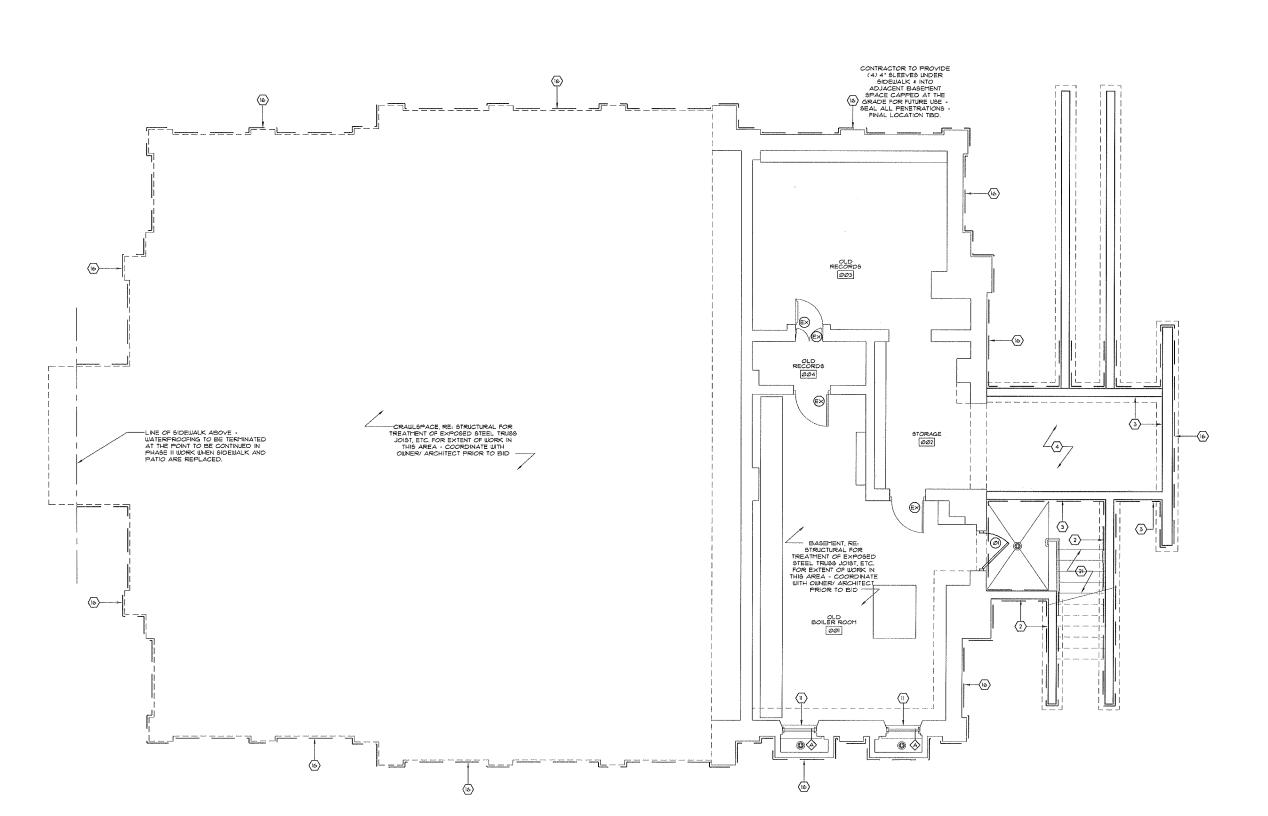



BASEMENT FLOOR PLAN ALOO SCALE: 1/4"=1"-0"

RE: SHEET A401 FOR PARTITION TYPES

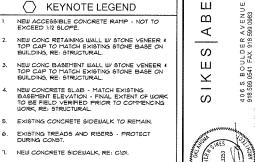

Ш≝

工

 Ω

 \triangleleft

S

Ш

ر ۾ Z \propto Ш

> 9 Ō 0 (V) <u>a</u> Ω

10 $\overline{\sigma}$

 \circ lation O eroke

0 DRAWN BY: KPG HECKED BY SUED: 10/15

ō

 Ω loor 墨血正

. ALL DIMENSIONS ARE TO NEW OR EXISTING FACE OF FINISHED WALL.

3. CONTRACTOR SHALL REMOVE 4 DELIVER TO OWNER FOR STORAGE ALL ITEMS DEEMED TO BE REUSED IN NEW CONSTRUCTION OR HISTORIC FABRIC.

4. CONTRACTOR TO FIELD VERIFY EXTENT OF SIDEULALK THAT BILL NEED TO BE REPLACED DO TO SITE LUDRY 4 FOUNDATION WATERFROOFING. PROVIDE TO THE OUNER AS SEPARATE NUMBER WITHIN THE BAS BID WITH QUANTITY 4 SCOPE.

5. CONTRACTOR TO PROVIDE AS A LINE ITEM TO IN THE BASE BID A DESIGN BUILD LIGHTING PROTECTION SYSTEM IN ACCORDANCE WITH UL 364, NPA 180, 4 LP 115 - ELEMENTS TO BE CONCEALED WITH THE EXCEPTION OF STRIKE TERMINATION DEVICES (LIGHTIN RODS). PROVIDE SPECIFICATION TO OWNER OF SYSTEM WITH BID PACKET FOR REVIEW.

LEGEND

EXISTING WALL

NEW INTERIOR PARTITION

NEW Ø HOUR PARTITION RE: SHEET ASOI FOR DOOR SCHEDULE

RE: SHEET A401 FOR PARTITION TYPES

NEW ACCESSIBLE CONCRETE RAMP - NOT TO EXCEED 1:12 9LOPE.

NEW CONG RETAINING WALL W/ STONE VENEER 4 TOP CAP TO MATCH EXISTING STONE BASE ON BUILDING, REI STRUCTURAL.

NEW CONC BASEMENT WALL W/ STONE VENEER 4 TOP CAP TO MATCH EXISTING STONE BASE ON BUILDING, RE: STRUCTURAL.

NEW CONCRETE 9LAB - MATCH EXISTING BASEMENT ELEVATION - FINAL EXTENT OF WORK TO BE FIELD VERIFIED PRIOR TO COMMENCING WORK, RE: STRUCTURAL.

EXISTING CONCRETE BIDEWALK TO REMAIN.

EXISTING TREADS AND RISERS - PROTECT DURING CONST.

NEW CONCRETE SIDEWALK, RE: CIOI.

NEW METAL GUARDRAILS/ HANDRAILS EACH SIDE- PRIME & PAINT, RE: X-A412.

REMOVE ALL LOOSE MASONRY & MORTAR AT WINDOW, DOOR OPENINGS INCLUDING HEAD, JAM & SILL) & LOCATIONS OF SETTLEMENT CRACKING REINSTALL W/ N-KIND MASONRY & MORTAR TO MATCH, RE. SPEC SECTIONS Ø4800, Ø4800, Ø4800, Ø4800, Ø481

NEW WOOD FRONT ENTRY 4 TRANSOM WITH RESTORED SURROUND - REPLACE ALL ITEMS NO ABLE TO BE USE IN-KIND TO MATCH EXISTING PROFILES, FIELD VERIFY - REPLACE MISSING ELEMENTS TO COMPLETE MILLUMPSK.

NEW WOOD WINDOW, 949H, FRAME, 4 INTERIOR SILL/TRIM - FIELD VERIFY OPENING CONDITION, REPAIR EXISTING FRAME/TRIM/TO MAXIMUM EXTENT FOSSIBLE - NOTIFY OWNER PRIOR TO COMMENCING WORK IN HISTORIC OR NEW FRAME TRIM WILL BE USED FOR ADDITIONAL NOTICE TO MAINTENANCE.

NEW WOOD WINDOW IN EXISTING RESTORED WOOD FRAMES & TRIM FER NPS GUIDELINES, RE, ASDI -- REPAIR OR REPLACE IN-KIND ALL ITEMS NOT ABLE TO BE RESTORED TO MATCH EXISTING PROFILES, FIELD VERIFY.

SQ CUT FRT CEDAR SHINGLES OVER "30 ASPHAL SATURATE FELT UNDERLAYMENT OVER EXISTING/ NEW DECKING - REPLACE ALL DETERIORATED EXISTING DECKING IN-KIND, RE: STRUCT.

AREA OF FUTURE MASONRY CHIMNEY - BLOCK OUT PER STRUCTURAL FOR FUTURE ADDITION OF CHIMNEY IN PHASE II, SEAL TOP OF EXISTING FLUE, RE: STRUCT.

NEW AREA DRAIN - TIGHTLINE TO STORM SEWER. FLUID APPLIED WATERPROOFING WITH I/A* COVER BOARD FROM GRADE TO BOTTOM OF FOUNDATIONS - BACKFILL WITH GRAVEL INSIDE FILTER FABRIC TO I BELOW GRADE BACK FILL REMAINING WITH TOPBOLT TO GRADE - PROVIDING FOSITIVE DRAINAGE AWAY FROM BUILDING ON ALL SIDES - GRAVEL WILL CONTAIN PERMETER DRAINAGE TIGHTLINED TO STORM.

NEW WOOD ENTRY DOOR, FRAME, TRANSOM SASH IN RESTORED WOOD SURROUND - REPAIR OR PLACE IN-KIND ALL DETERIORATED EXISTING ELEMENTS.

NEW WOOD OPERABLE SHITTERS - FROVIDE (
NOTALL HISTORIC REPLICA HARDWARE COORDINATE WITH OWNER! ARCHITECT PRIOR TO
ORDERING - FINISH TO MATCH ALL EXTERIOR
HARDWARE, RE: A592.

20. RESTORED WOOD BRACKET, USE IN-KIND MATERIALS, DIMENSIONS, AND CONSTRUCTION TO MATCH EXISTING HISTORIC BRACKETS.

NEW CONCRETE STAIR,

NEW METAL GUÁRDRAILS - PRIME & PÁINT -COLOR TO MATCH ALL OTHER EXTERIOR HARDWARR - COORDINATE WITH THE OWNER/ ARCHITECT PRIOR TO PAINTING.

23. NEW METAL 90' SWING GATE, POWDERCOAT COLOR TBD.

24. NEW SOFFIT VENTS SPACED EQUALLY ON EACH SIDE OF THE ROOF- PAINT TO MATCH SOFFIT - COLOR TBD.

NEW CEDAR RIDGE CAP OVER CONTINUOUS LOW PROFILE RIDGE/HIP VENT.

26. EXISTING BEAD BOARD SOFFIT OVER 3/8" SHEATHING - REPAIR OR REPLACE DETERIORATED BEAD BOARD - PRIME 4 PAINT, COLOR 1BD.


27. EXISTING IX WOOD FASCIA OVER NEW SUBFASCIA - REPAIR OR REPLACE DETERIORATED FASCIA - FRIME 4 PAINT, COLOR TBD.

28. AUTOMATIC DOOR OPENER/ PUSH PAD.

29. NEW WOOD CLAPBOARD SIDING - PRIME & PAINT - COLOR TBD.

30. NEW WOOD TRIM - PRIME 4 PAINT - COLOR TBD

NEW WOOD BRACKET, CORNICE 4 DENTILS TO MATCH HISTORIC PROFILES - SIZE 4 EXACT SHAPE MAY VARY TO MEET SPECIFIC CONDITION OF NEW CUPOLA.

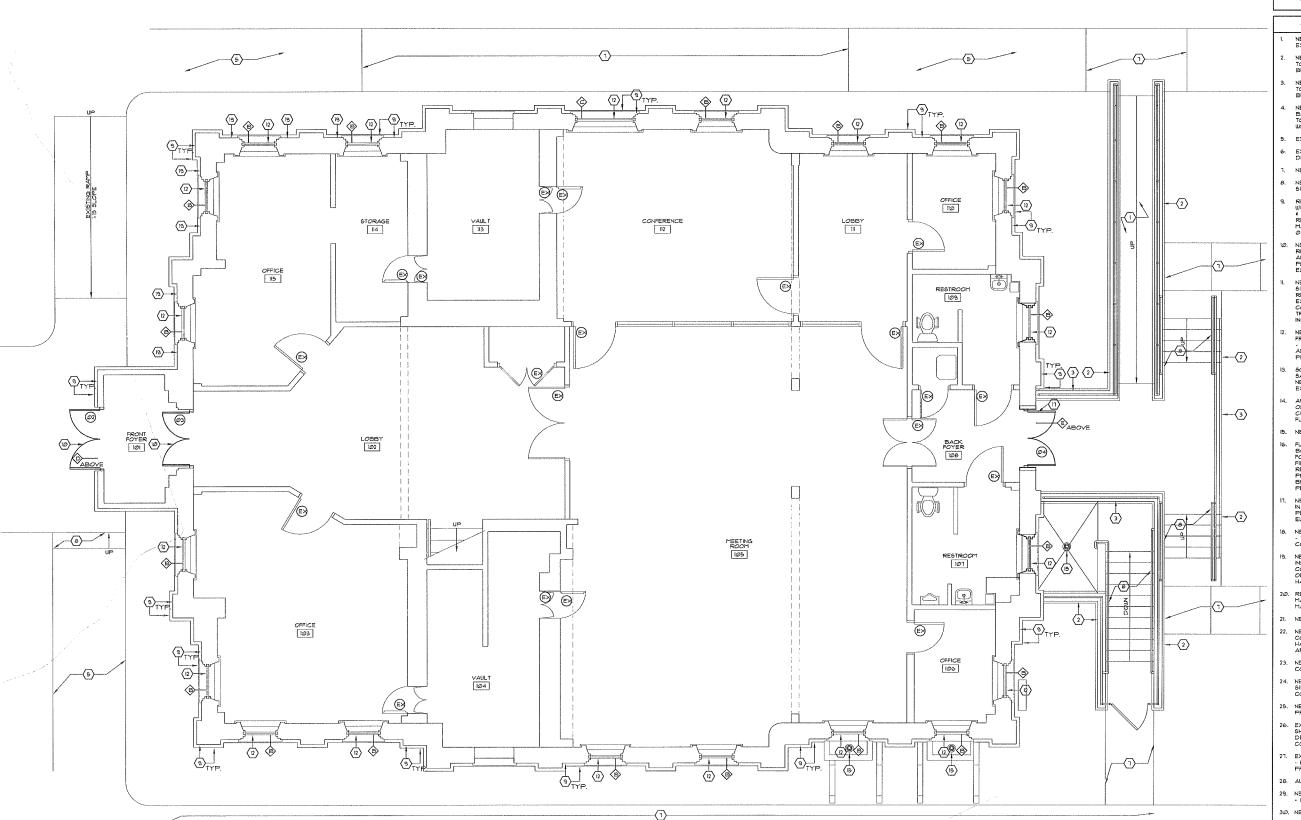



FIRST LEVEL FLOOR PLAN Ale SCALE: 1/4" | 1'-0"

Nation 0 Cherok

엉

ш≝ 工工

∢ ' Z α Ш

 \Box

⋖

S

Ш \times

ഗ

One

hase

Ω

apitol

 \bigcirc

4 0 6 S BOULDER AVENU 918:599.0541 FAX: 918.599.0983

Tahlequah, CHECKED BY: MOS ISSUED: 10/15/17

匸 ē

irst Ian 证瓦

2. EXTERIOR MASCHEY TO MAIGH COLOR COURSE (ECNIC) OF BIECK AT EXPERIENC CORNELS CONTRACTOR TO RIELD VERIFY EXTENT OF MASCHRY WORK PRIOR TO BID - ALL CRACKS AND/OR DETERIORATED AREAS TO BE REPAIRED/RESTORED TO ORIGINAL COURSE AND BOND.

I. ALL DIMENSIONS ARE TO NEW OR EXISTING FACE
OF FINISHED WALL.

2. EXTERIOR MASONRY TO MAICH COLOR COURSE 4
BOND OF BRICK AT EXTERIOR CORNERS.

1. CONTRACTOR TO FIELD VERIFY EXTENT OF
SIDEWAK THAT WILL NEED TO BE REFLACED DO TO
SITE WORK AFOLDATION WATERPROCEDUS.
10 THE CURREN AS SEPARATE NUMBER WITHIN THE BAT
BOND OF BRICK AT EXTERIOR CORNERS.

5. CONTRACTOR TO PROVIDE AS A LINE ITEM TO IN THE BASE BID A DESIGN BUILD LIGHTING PROTECTION SYSTEM IN ACCORDANCE WITH UL 96A, NPA 180, 1 LPI 115 - BLEMENTS TO BE CONCEALED WITH THE EXCEPTION OF STRIKE TERMINATION DEVICES (LIGHTING RODS), PROVIDE SPECIFICATION TO OWNER OF SYSTEM WITH BID PACKET FOR REVIEW.

LEGEND


EXISTING WALL

RE: SHEET A502 FOR WINDOW TYPES 4 WINDOW SCHEDULE

- NEW ACCESSIBLE CONCRETE RAMP NOT TO EXCEED 1:12 SLOPE.
- NEW CONCRETE SLAB MATCH EXISTING BASEMENT ELEVATION FINAL EXTENT OF WORK TO BE FIELD VERIFIED PRIOR TO COMMENCING WORK, RE: STRUCTURAL.
- EXISTING TREADS AND RISERS PROTECT DURING CONST.
- NEW CONCRETE SIDEWALK, RE: CIØI.
- NEW METAL GUARDRAILS/ HANDRAILS EACH SIDE- PRIME 4 PAINT, RE: X-A412.
- REMOVE ALL LOOSE MASONRY & MORTAR AT WINDOW, DOOR OPENINGS/INCLUDING HEAD, JAHNE & SILL) & LOCATIONS OF SETILLENIST CRACKING REINSTALL W/ IN-KIND MASONRY & MORTAR TO MATCH, RE. SPEC SECTIONS Ø48/0, Ø48/0, Ø49/0, Ø49/1 NPS PRESERVATION BRIEF 2.

- FLUID APPLIED WATERPROOFING WITH I/2* COVER BOARD FROM GRADE TO BOTTOM OF FOUNDATIONS BACKFILL WITH GRAVEL INSIDE FILTER FABRIC TO I BELOW GRADE BACK FILL REMAINING WITH TOPBOIL TO GRADE PROVIDING POSITIVE DRAINAGE AWAY FROM BUILDING ON ALL SIDES GRAVEL WILL CONTAIN PERIMETER DRAINAGE TIGHTLINED TO STORM.

- 21. NEW CONCRETE STAIR.
- 23. NEW METAL 90* 9WING GATE, POWDERCOAT COLOR TBD.
- 24. NEW SOFFIT VENTS SPACED EQUALLY ON EACH SIDE OF THE ROOF+ PAINT TO MATCH SOFFIT + COLOR TBD.
- NEW CEDAR RIDGE CAP OVER CONTINUOUS LOW PROFILE RIDGE/HIP VENT.
- 26. EXISTING BEAD BOARD SOFFIT OVER 3/8" SHEATHING REPAIR OR REPLACE DETERIORATED BEAD BOARD PRIME 4 PAINT, COLOR TBD.
- 27. EXISTING IX WOOD FASCIA OVER NEW SUBFASCIA REPAIR OR REPLACE DETERIORATED FASCIA PRIME 4 PAINT, COLOR TBD.
- 28. AUTOMATIC DOOR OPENER/ PUSH PAD
- 29. NEW WOOD CLAPBOARD SIDING PRIME & PAINT COLOR TBD.
- 30. NEW WOOD TRIM PRIME 4 PAINT COLOR TED
- 31. NEW WOOD BRACKET, CORNICE 4 DENTILS TO MATCH HISTORIC PROFILES SIZE 4 EXACT SHAPE MAY VARY TO MEET SPECIFIC CONDITIONS OF NEW CUPOLA.

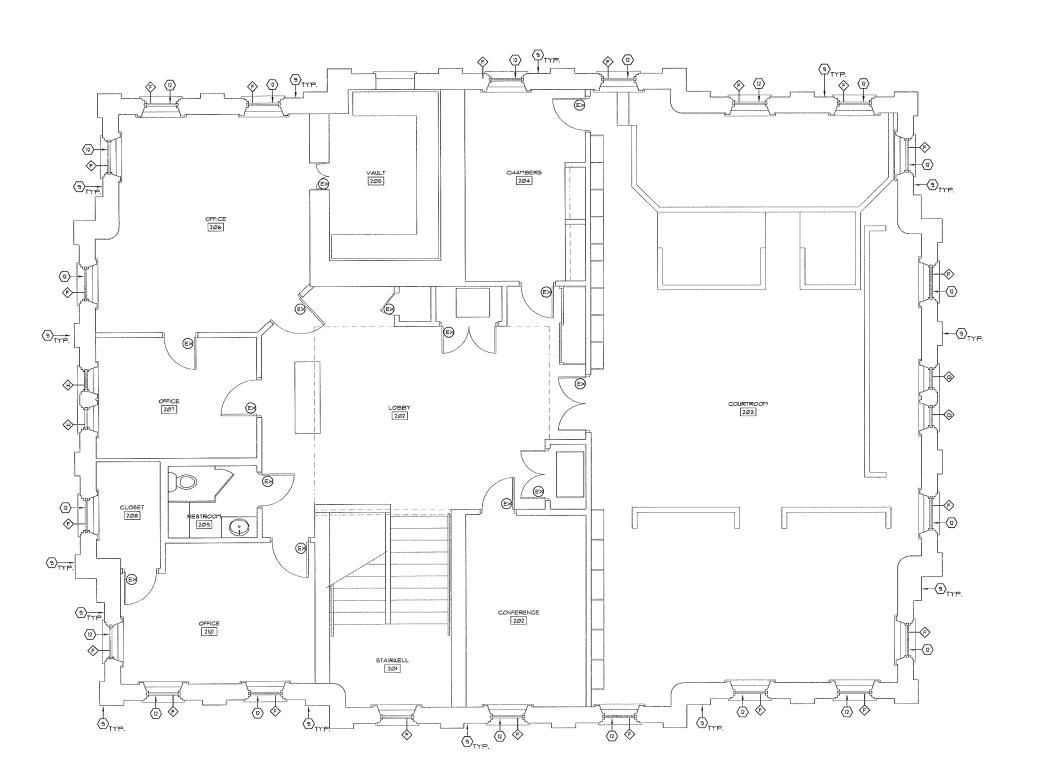



SECOND LEVEL FLOOR PLAN Al@2 SCALE: 1/4"=1'-@"

E 工

NEW INTERIOR PARTITION NEW Ø HOUR PARTITION

(a)

RE: SHEET ASOI FOR DOOR SCHEDULE RE: SHEET A401 FOR PARTITION TYPES

NEW CONC RETAINING WALL W/ STONE VENEER & TOP CAP TO MATCH EXISTING STONE BASE ON BUILDING, RE: STRUCTURAL. NEW CONC BASEMENT WALL W/ STONE VENEER 4 TOP CAP TO MATCH EXISTING STONE BASE ON BUILDING, RE: STRUCTURAL.

EXISTING CONCRETE SIDEWALK TO REMAIN

NEW WOOD FRONT ENTRY 4 TRANSOM WITH RESTORED SURROUND - REPLACE ALL ITEMS NO ABLE TO BE USE IN-KIND TO MATCH EXISTING PROFILES, PIELD VERIFY - REPLACE MISSING ELEMENTS TO COMPLETE MILLWORK

- NEW WOOD WINDOW, SASH, FRAME, (INTERIOR SILL) TRIM FIELD VERIFY OPENING CONDITION REPAIR EXISTING FRAME / TRIM TO MAXIMUM EXTENT FOSSIBLE NOTIFY OWNER FRIOR TO COMMENCE WORK WORK WIS WINDOWS OF RICH WILL BE USED FOR ADDITIONAL MORK IN FINDOWS OR NEW FRAME / TRIM WILL BE USED FOR ADDITIONAL MOSTRUCTION.
- NEW WOOD WINDOW IN EXISTING RESTORED WOOD FRAMES & TRIM PER NPS GUIDELINES, RE: ASO! -REPAIR OR REFLACE IN-KIND ALL ITEMS NOT ABLE TO BE RESTORED TO MATCH EXISTING PROFILES, PIELD VERIFY.
- SQ CUT FRT CEDAR SHINGLES OVER "30 ASPHAL SATURATE FELT UNDERLAYMENT OVER EXISTING/ NEU DECKING REPLACE ALL DETERIORATED EXISTING DECKING IN-KIND, RE; STRUCT.
- AREA OF FUTURE MASONRY CHIMNEY BLOCK OUT PER STRUCTURAL FOR FUTURE ADDITION OF CHIMNEY IN PHASE II, SEAL TOP OF EXISTING FLUE, RE: STRUCT.
- NEW AREA DRAIN TIGHTLINE TO STORM SEWER.
- NEW WOOD ENTRY DOOR, FRAME, TRANSOM SASH IN RESTORED WOOD SURROUND REPAIR OR PLACE IN-KIND ALL DETERIORATED EXISTING ELEMENTS :
- 18. NEW PRE-FINISHED METAL GUTTER & DOWNSPOUTS TIGHTLINE TO STORM SEWER CUSTOM COLOR COLOR TED.
- NEW WOOD OPERABLE SHITTERS PROVIDE 4
 INSTALL HISTORIC REPLICA HARDWARD
 COORDINATE WITH OUNER/ ARCHITECT PRIOR TO
 ORDERING FINISH TO MATCH ALL EXTERIOR
 HARDWARE, RE: A520.
- RESTORED WOOD BRACKET, USE IN-KIND MATERIALS, DIMENSIONS, AND CONSTRUC MATCH EXISTING HISTORIC BRACKETS.
- 22. NEW METAL GUARDRAILS FRIME 4 PAINT COLOR TO MATCH ALL OTHER EXTERIOR
 HARDWARE COORDINATE WITH THE OWNER/
 ARCHITECT PRIOR TO PAINTING.

 α Ш 4 0 6 S. BOULDER AVENU 918:599:0541 FAX: 918:599:0983 \mathbf{m} ⋖ S Ш \times

 \forall Z

S

ODO

<u>5</u>

1

apitol

Ö

ation 엉

Cherokee

DRAWN BY: KPG CHECKED BY: ISSUED: 12/15/

Ō Lev

REVISIONS

second loor Pla SIL

EXTERIOR MASONRY TO MATCH COLOR COURSE 4 BOND OF BRICK AT EXTERIOR CORNERS.
 CONTRACTOR TO FIELD VERIFY EXTENT OF MASONRY WORK PRIOR TO BID - ALL CRACKS AND/OR DETERIORATED AREAS TO BE REPAIRED/RESTORED TO ORIGINAL COURSE AND BOND.

I. ALL DIMENSIONS ARE TO NEW OR EXISTING FACE
OF FINISHED WALL.

SET BY A SHORT OF BILL NEED TO BE REPLACED DO TO
SITE WORK & FOUNDATION WASTERPROOFING. PROVIDE
BOND OF BRICK AT EXTERIOR CORNERS.

BOND OF BRICK AT EXTERIOR CORNERS.

BOND INF QUANTITY 4 SCOPE.

BOND INF QUANTITY 4 SCOPE.

5. CONTRACTOR TO PROVIDE AS A LINE ITEM TO IN THE BASE BID A DESIGN BUILD LIGHTING PROTECTION SYSTEM IN ACCORDANCE WITH UL 96A, PPA 182, I LPI 115 - BLEMENTS TO BE CONCEALED WITH THE EXCEPTION OF STRIKE TERMINATION DEVICES (LIGHTIMS RODS). PROVIDE SPECIFICATION TO CUNER OF SYSTEM WITH BID PACKET FOR REVIEW.

LEGEND

EXISTING WALL

NEW Ø HOUR PARTITION

RE: SHEET ADDI FOR DOOR SCHEDULE

RE: SHEET A401 FOR PARTITION TYPES

RE: SHEET A502 FOR WINDOW TYPES & WINDOW SCHEDULE

NEW ACCESSIBLE CONCRETE RAMP - NOT TO EXCEED I:12 SLOPE.

NEW CONC RETAINING WALL W STONE VENEER OF CAP TO MATCH EXISTING STONE BASE ON BUILDING, RE: STRUCTURAL.

NEW CONC BASEMENT WALL W/ STONE VENEER 4 TOP CAP TO MATCH EXISTING STONE BASE ON BUILDING, RE: STRUCTURAL.

NEW CONCRETE SLAB - MATCH EXISTING BASEMENT ELEVATION - FINAL EXTENT OF WORK TO BE FIELD VERIFIED PRIOR TO COMMENCING WORK, RE: STRUCTURAL. EXISTING CONCRETE SIDEWALK TO REMAIN.

EXISTING TREADS AND RISERS - PROTECT DURING CONST.

NEW CONCRETE SIDEWALK, RE: CIØI.

NEW METAL GUARDRAILS/ HANDRAILS EACH SIDE- PRIME 4 PAINT, RE: X-A412.

NEW WOOD FRONT ENTRY 4 TRANSOM WITH RESTORED SURROUND - REPLACE ALL ITEMS N ABLE TO BE USE IN-KIND TO MATCH EXISTING PROFILES, FIELD VERIFY - REPLACE MISSING ELEMENTS TO COMPLETE MILLWORK.

NEW WOOD WINDOW, 949H, FRAME, 4 INTERIOR SILLY TRIM - FIELD VERIET OPENING CONDITION, REPAIR EXISTIVE FAMILY TRIM TO MAXIMUM EXTENT POSSIBLE - NOTIFY OWNER PRIOR TO COMMENCEN WORK IN HISTORIC OR NEW FRAME TRIM WILL BE USED FOR ADDITIONAL INSTRUCTION.

NEW WOOD WINDOW IN EXISTING RESTORED WOOD FRANES I TRIN FER NPS GUIDELINES, RE. ASDI -REPAIR OR REFLACE IN-KIND ALL ITEMS NOT ABLE TO BE RESTORED TO MATCH EXISTING PROFILES, FIELD VERIFY.

SQ CUT FRT CEDAR SHINGLES OVER "30 ASPHAL" SATURATE FELT UNDERLAYMENT OVER EXISTING/ NEU DECKING - REPLACE ALL DETERIORATED EXISTING DECKING IN-KIND, RE: STRUCT.

AREA OF FUTURE MASONRY CHIMNEY - BLOCK OUT PER STRUCTURAL FOR FUTURE ADDITION OF CHIMNEY IN PHASE II, SEAL TOP OF EXISTING FLUE, RE: STRUCT.

NEW AREA DRAIN - TIGHTLINE TO STORM SEWER.

FLUID APPLIED WATERPROOFING WITH I/2" COVER BOARD FROM GRADE TO BOTTOM OF FOUNDATIONS - BACKFILL WITH GRAVEL INSIDE FILTER FABRIC TO! BELOW GRADE BACK FILL REHAINING WITH TOPBOLI TO GRADE - PROVIDING POSITIVE DRAINAGE AWAY FROM BUILDING ON ALL SIDES - GRAVEL WILL CONTAIN PERIMETER DRAINAGE TIGHTLINED TO STORM.

NEW WOOD ENTRY DOOR FRAME, TRANSOM SASHIN RESTORED WOOD SURROUND - REPAIR OR PLACE IN-KIND ALL DETERIORATED EXISTING ELEMENTS.

NEW PRE-FINISHED METAL GUTTER 4 DOWNSPOUTS - TIGHTLINE TO STORM SEWER - CUSTOM COLOR COLOR TBD.

NEW WOOD OPERABLE SHITTERS - PROVIDE (
INSTALL HISTORIC REPLICA HARDWARE - COORDINATE WITH OUNERV ARCHITECT PRIOR TO
ORDERING - FINISH TO MATCH ALL EXTERIOR
HARDWARE, RE: A522.

RESTORED WOOD BRACKET, USE IN-KIND MATERIALS, DIMENSIONS, AND CONSTRUCTION TO MATCH EXISTING HISTORIC BRACKETS.

21. NEW CONCRETE STAIR.

22. NEW METAL GUARDRAILS - PRIME & PAINT - COLOR TO MATCH ALL OTHER EXTERIOR HARDWARE - COORDINATE WITH THE OWNER/ARCHITECT PRIOR TO PAINTING.

24. NEW SOFFIT VENTS SPACED EQUALLY ON EACH SIDE OF THE ROOF- PAINT TO MATCH SOFFIT -COLOR TBD.

NEW CEDAR RIDGE CAP OVER CONTINUOUS LOW PROFILE RIDGE/HIP VENT.

26. EXISTING BEAD BOARD SOFFIT OVER 3/8" SHEATHING - REPAIR OR REPLACE DETERIORATED BEAD BOARD - PRIME 4 PAINT, COLOR TBD.

27. EXISTING IX WOOD FASCIA OVER NEW SUBFASCIA - REPAIR OR REPLACE DETERIORATED FASCIA PRIME 4 PAINT, COLOR TBD.

28. AUTOMATIC DOOR OPENER/ PUSH PAD.

29, NEW WOOD CLAPBOARD SIDING - PRIME & PAINT - COLOR TBD.

30. NEW WOOD TRIM - PRIME 4 PAINT - COLOR TBD,

NEW WOOD BRACKET, CORNICE 4 DENTILS TO MATCH HISTORIC PROFILES - SIZE 4 EXACT SHAPE MAY VARY TO MEET SPECIFIC CONDITIONS OF NEW CUPOLA,



(D)

Щ" = : = :

∢ :

Z \propto

Ш

 $^{\circ}$

⋖

S

Ш \leq

> hase Ω pito Ca ation

Ž


0

Tahlequah Cherok

웅

CHECKED BY: MOS SSUED: REVISIONS

 \Box $\overline{\Omega}$ Roof

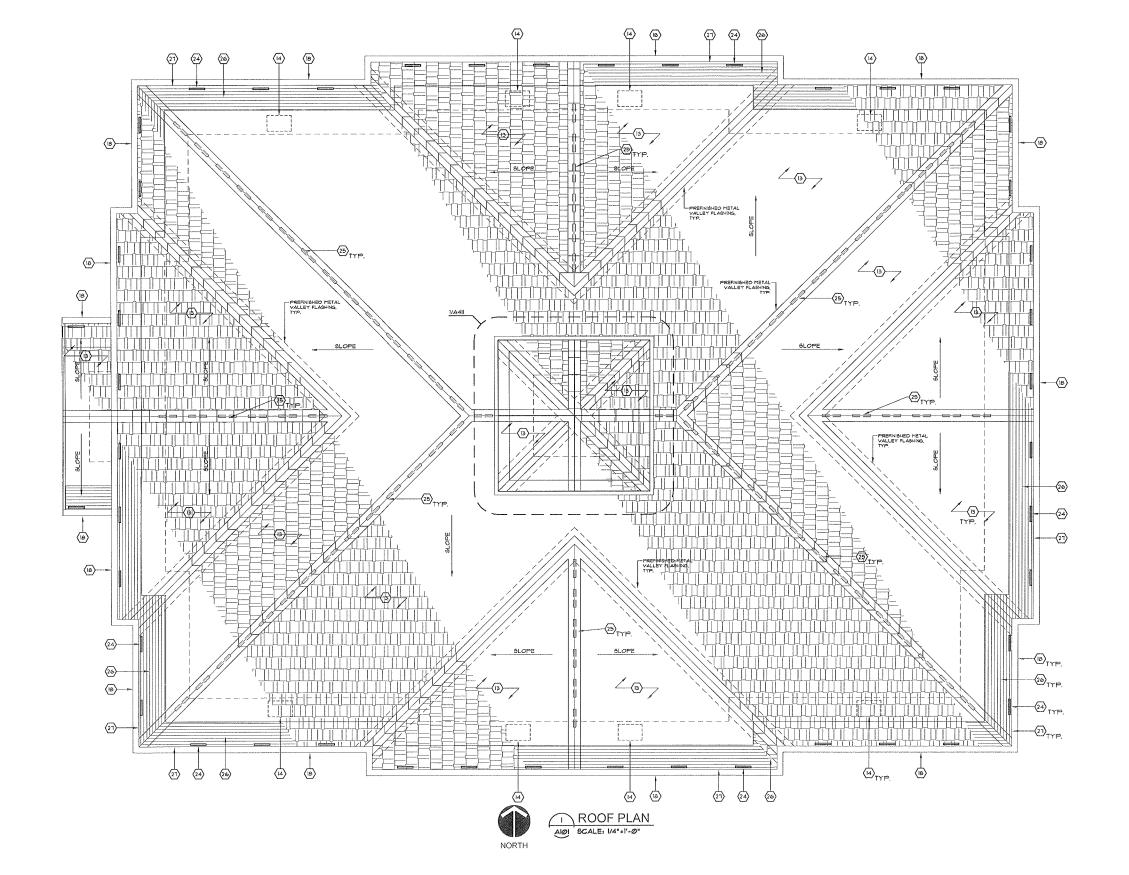

I ⋖

Z α Ш

 Ω

⋖


S Ш 云 S

4 0 6 S. BOULDER AVENUE 918.599.0541 FAX: 918.599.0983

DEMO KEYNOTE LEGEND

- REMOVE EXISTING WINDOW SASH
- REMOVE CONCRETE SLAB.
- REMOVE EXISTING SHINGLES REMOVE DETERIORATED DECKING SALVAGE EXISTING DECK FOR RE-USE IN NEW CONSTRUCTION PROTECT STRUCTURE FOR NEW CONSTRUCTION RE- STRUCTURAL FOR SUPPORTS, ROOF RAFTERS 4 SUBSTRATE.
- REMOVE EXISTING STEPS- PREPARE AREA FOR INFILL.

- DEMO EXISTING CONCRETE LANDING, RAMP, STEPS, GUARDRAILS AND HANDRAILS, SALVAGE GUARDRAILS AND HANDRAILS FOR CUNER.
- REMOVE EXISTING BASEMENT WALLS, FLOORS DOORS, WINDOWS, FOUNDATIONS, ELECTRICAL FULLMEING, MECHANICAL, ETC. TO PREPARE FOR NEW CONSTRUCTION PROVIDE FOR SHORING OF EXISTING TO RETAIN REPORT TO GUNER UNDERSENDED CONDITIONS.

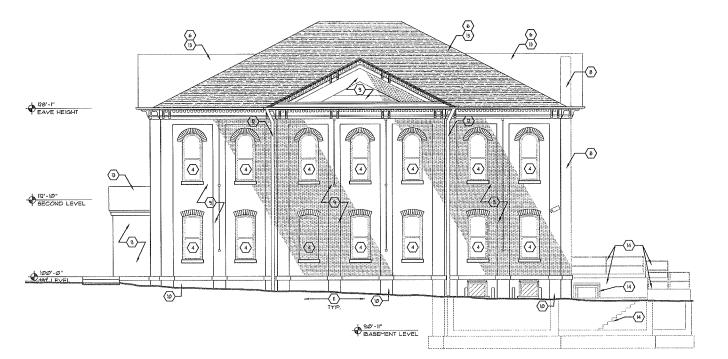

WEST ELEVATION A211 SCALE: 1/8" 11-0"

43

7 4

(6) (B)

4

4

(4)

(<u>a</u>

(b) (3)

O

4

@J


40X


EAVE HEIGHT

SECOND LEVEL \$

EVAE HERRIT

SOUTH ELEVATION A211 SCALE: 1/8" 1'-0"

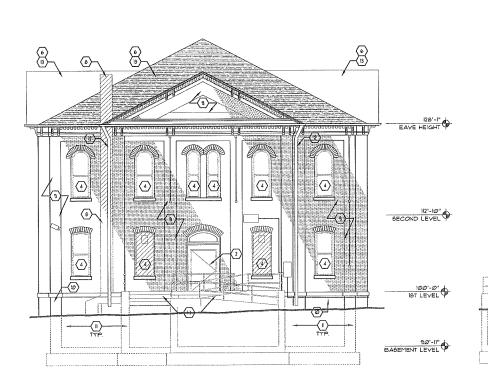

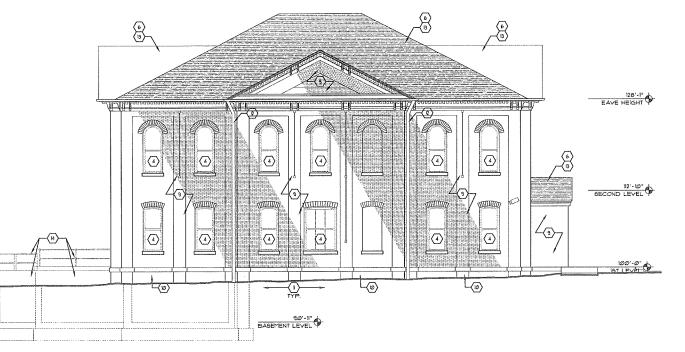

EAST ELEVATION A211 6CALE: 1/8" : 1"-0"

NORTH ELEVATION A211 '6CALE: 1/8"=1'-@"

DEMOLITION LEGEND

EXISTING WALLS, DOORS, ETC. TO REMAIN. REMOVE MISC. FINISHES WHICH CONFLICT WITH NEW CONSTRUCTION

- COORDINATE LOCATION WITH OWNER/
 ARCHITECT FOR TEST AREAS TO REMOVE
 PAINT FROM BRICK. TEST POSSIBLE
 METHODS TO REMOVE PAINT, SAND-BLASTI
 IS NOT AN ACCEPTABLE SOLUTION. TO
 REMOVING PAINT, CONTRACTOR IS TO
 REMOVING PAINT, CONTRACAS TO BE
 APPROVIDED THE OWNER/
 ARCHITECTURE OF THE OWNER/
 APPROVIDED THE OWNER/
 APPROVIDED THE OWNER/
 APPROVIDED TO THE OWNER/
 APPROVIDED THE OWNER/
 APP
- EXISTING DOOR TO BE REMOVED 4 EXISTING FRAME TO REMAIN.

- REMOVE ALL LOOSE MASONRY 1 MORTAR -PREP FOR REINSTALL W/ IN-KIND MASONRY / MORTAR, RE. SPEC SECTIONS Ø4860, Ø4200 Ø4201, NPS PRESERVATION BRIEF 21 NEW CONST.
- I.O. CAREFULLY REMOVE CEMENTITIOUS STUCCO MATERIAL FROM STONE WATER TABLE, GENTLY CLEAN STONE SWIFACE OF ANY ADDITIONAL STUCCO IN THE CRACKS AND CREVASSES, THEN REPAIR THE DETERIORATED STONES AS NECESSARY, LASTLY, REMOVE DETERIORATED MORTAR AND RE-TUCK POINT THESE AREAS.
- EXCAYATE SOIL AT EXTERIOR WALL TO BOTTOM OF FOUNDATIONS, PREPARE WALL SUFFACE TO APPLY WATERPROOFING MEMBRANE WITH PROTECTION COURSE.
- REMOVE EXISTING METAL GUTTER AND DOWNSPOUTS FRIME 4 PAINT, COLOR TO BE DETERMINED.
- PREPARE AREA FOR NEW ROOF CONSTRUCTION, RE: STRUCTURAL FOR SUPPORTS, ROOF RAFTERS & SUBSTRATE.

One


Phase

.

엉

5. CONTRACTOR TO PROVIDE AS A LINE ITEM TO IN THE BASE BID A DESIGN BUILD LIGHTING PROTECTION SYSTEM IN ACCORDANCE WITH UL SAA, NEPA 180, I. LP! ITS - ELEMENTS TO BE CONCEALED WITH IT BECKEPTION OF STRIKE TERMINATION DEVICES (LIGHTIM RODS). PROVIDE SPECIFICATION TO OWNER OF SYSTEM WITH BID PACKET FOR REVIEW.

- NEW ACCESSIBLE CONCRETE RAMP NOT TO EXCEED 1:12 SLOPE.
- NEW CONC RETAINING WALL W STONE VENEER 4 TOP CAP TO MATCH EXISTING STONE BASE ON BUILDING, RE; STRUCTURAL.
- NEW CONC BASEMENT WALL W/ STONE VENEER 4 TOP CAP TO MATCH EXISTING STONE BASE ON BUILDING, RE: STRUCTURAL.
- NEW CONCRETE BLAB MATCH EXIBITING BASEMENT ELEVATION FINAL EXTENT OF WORK TO BE FIELD VERIFIED PRIOR TO COMMENCING WORK, RE: STRUCTURAL,
- EXISTING CONCRETE SIDEWALK TO REMAIN. EXISTING TREADS AND RISERS - PROTECT DURING CONST.
- NEW CONCRETE SIDEWALK, RE: CIØI.
- NEW METAL GUARDRAILS/ HANDRAILS EACH SIDE PRIME 4 PAINT, RE: X-A412,
- REMOVE ALL LOGSE MASONRY 4 MORTAR AT UNDOUG DOOR OPENINGÉR INCLUDING HEAD, JAM 4 SILL) 4 LOCATIONS OF BETTLEMENT CRACKING REINSTALL UV IN-KIND MASONRY 4 MORTAR TO MATCH, REI-SPEC SECTIONS Ø480, Ø4800, Ø4900, Ø4911 NPS PRESERVATION BRIEF 2.
- NEW WOOD FRONT ENTRY & TRANSOM WITH RESTORED SURROUND REFLACE ALL ITEMS NI ABLE TO BE USE IN KIND TO MATCH EXISTING PROFILES, FIELD VERIFY REFLACE MISSING ELEMENTS TO COMPLETE MILLUOPSK.
- NEW WOOD WINDOW, \$48H, FRAME, 4 INTERIOR SILL/ TRIM FIELD VERIFY OPENING CONDITION REPAIR EXISTING FRAME/ TRIM TO MAXINUM EXTENT POSSIBLE NOTIFY OWNER PRIOR TO COMMENCING WORK IF HISTORIC OR NEW FRAME (TRIM WILL BE USED FOR ADDITIONAL INSTRUCTION. NEW WOOD WINDOW IN EXISTING RESTORED WOOD FRANCES 4 TRUN PER NPG GUIDELINES, RE: A501 - REPAIR OR REPLACE IN-KIND ALL LITERS FOR ABLE TO BE RESTORED TO MATCH EXISTING PROFILES, PIELD VERIFY.
- SQ CUT FRT CEDAR SHINGLES OVER *30 ASPHAL SATURATE FELT UNDERLAYMENT OVER EXISTING/ NEW DECKING REPLACE ALL DETERIORATED EXISTING DECKING IN-KIND, REI STRUCT.
- AREA OF FUTURE MASONRY CHIMNEY BLOCK OUT PER STRUCTURAL FOR FUTURE ADDITION OF CHIMNEY IN PHASE II, SEAL TOP OF EXISTING FLUE, RE: STRUCT.
- NEW AREA DRAIN TIGHTLINE TO STORM SEWER.
- FLUID APPLIED WATERPROOFING WITH 1/2" COVER BOARD FROM GRADE TO BOTTOM OF FOUNDATION BACKFILL WITH GRAVEL INSIDE FILTER FABRIC TO I BELOW GRADE BACK FILL REMAINED, WITH 1079-601. TO GRADE PROVIDING POSITIVE DRAINAGE AWAY FROM BUILDING ON ALL SIDES GRAVEL WILL CONTAIN FERIMETER DRAINAGE TIGHTLINED TO STORM.
- NEW WOOD ENTRY DOOR, FRAME, TRANSON BASH IN RESTORED WOOD SURROUND REPAIR OR PLACE IN-KIND ALL DETERIORATED EXISTING ELEMENTS.
- NEW WOOD OPERABLE SHITTERS FROVIDE 4
 INSTALL HISTORIC REPLICA HARDWARE COORDINATE WITH OUNER/ ARCHITECT FRIOR TO
 ORDERING FRISH TO MATCH ALL EXTERIOR
 HARDWARE, RE: A522.
- 20. RESTORED WOOD BRACKET, USE IN-KIND MATERIALS, DIMENSIONS, AND CONSTRUCTION TO MATCH EXISTING HISTORIC BRACKETS.
- NEW CONCRETE STAIR.
- 22. NEW METAL GUARDRAILS PRIME 4 PAINT COLOR TO MATCH ALL OTHER EXTERIOR
 HARDWARE COORDINATE WITH THE CUNER/
 ARCHITECT PRIOR TO PAINTING.
- 23. NEW METAL 90° SWING GATE, POWDERCOAT COLOR TBD. 24. NEW SOFFIT VENTS SPACED EQUALLY ON EACH SIDE OF THE ROOF- PAINT TO MATCH SOFFIT - COLOR TBD.
- NEW CEDAR RIDGE CAP OVER CONTINUOUS LOW PROFILE RIDGE/HIP VENT. 26. EXISTING BEAD BOARD SOFFIT OVER 3/8" SHEATHING - REPAIR OR REPLACE DETERIORATED BEAD BOARD - PRIME 4 PAINT, COLOR TBD.
- 21. EXISTING IX WOOD FASCIA OVER NEW SUBFASCIA REPAIR OR REPLACE DETERIORATED FASCIA PRIME 4 PAINT, COLOR TBD.
- 28. AUTOMATIC DOOR OPENER/ PUSH PAD.
- 29. NEW WOOD CLAPBOARD SIDING PRIME 4 PAINT COLOR TBD.
- 30. NEW WOOD TRIM PRIME 4 PAINT COLOR TBD.
- NEW WOOD BRACKET, CORNICE 4 DENTILS TO MATCH HISTORIC PROFILES SIZE 4 EXACT SHAPE MAY VARY TO MEET SPECIFIC CONDITION OF NEW CUPOLA.

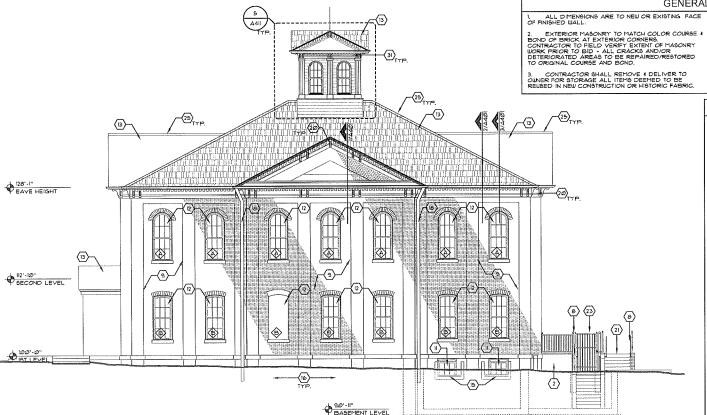

WEST ELEVATION A212 SCALE: 1/8" +1'-0"

EAVE HEIGHT

SECOND LEVEL 10'-1" EAVE HEIGHT

76)

₩

~(ē)÷

~25)_{TYP.}


VILLER


(12)-

(a)


-⟨e}-

(13)

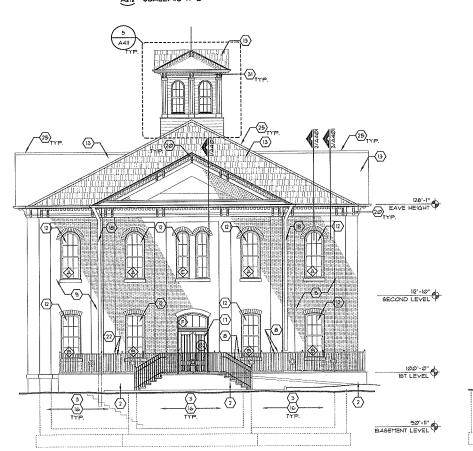

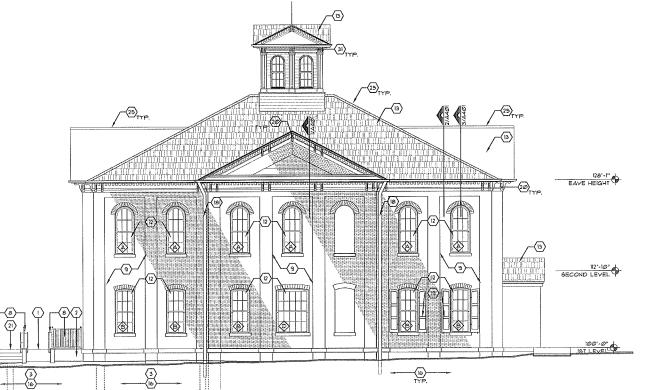

SOUTH ELEVATION A212 SCALE: 1/8" - 1'-0"

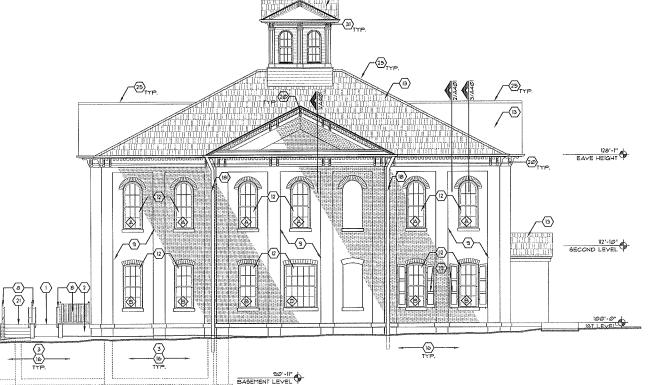

Шυ _ ; ├--⋖ Z \propto

Ш Ω ⋖ S Ш

 \prec

406 S. BOULDER AVENUE. 918:599:0541 FAX: 918:599:0983

 $\frac{1}{2}$

0

Φ Phase apitol

Nation


Cherokee Tahlequah, MOS

CHECKED BY: ISSUED: REVISIONS

Che

evations xterior

ய் ய

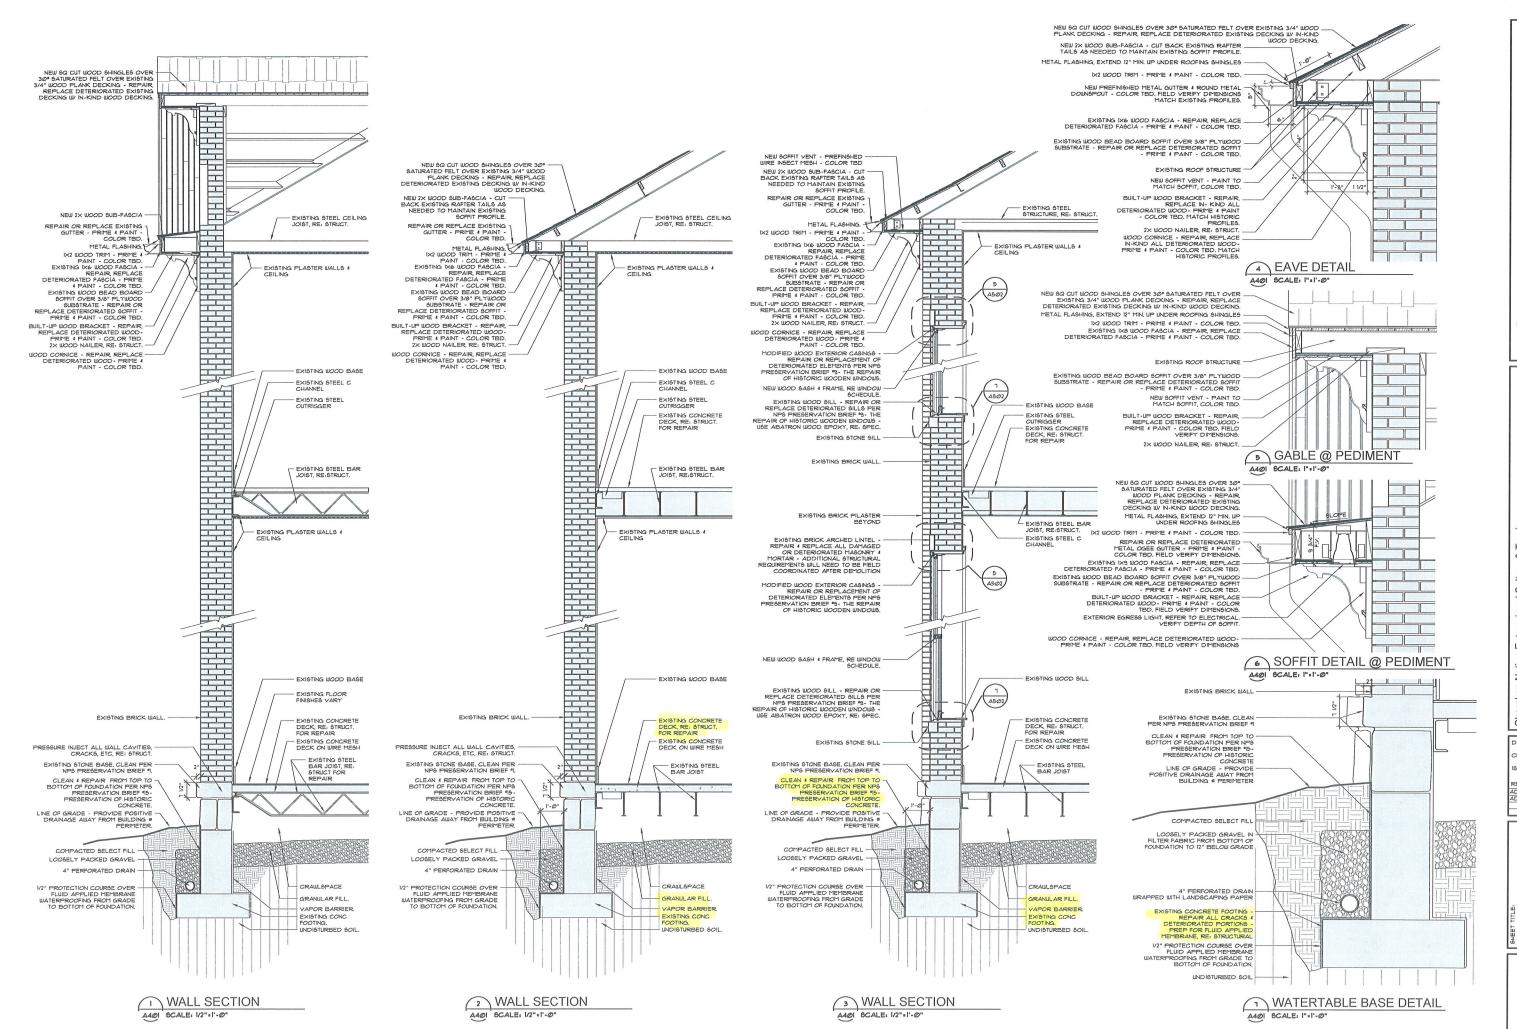

Ш 工 < ° Z \propto Ш A V E N U 599.0983 $\mathbf{\Omega}$ \triangleleft S Ш \leq

S

One

0

BOULDER A 0541 FAX: 918.5


4 0 6 S. 918.599.0

S Pha apitol 0 lation Z Φ heroke

ahlequah 0 RAUN BY KPG 10/15/1

SUED:

ంర ctions Se S Wall Detai

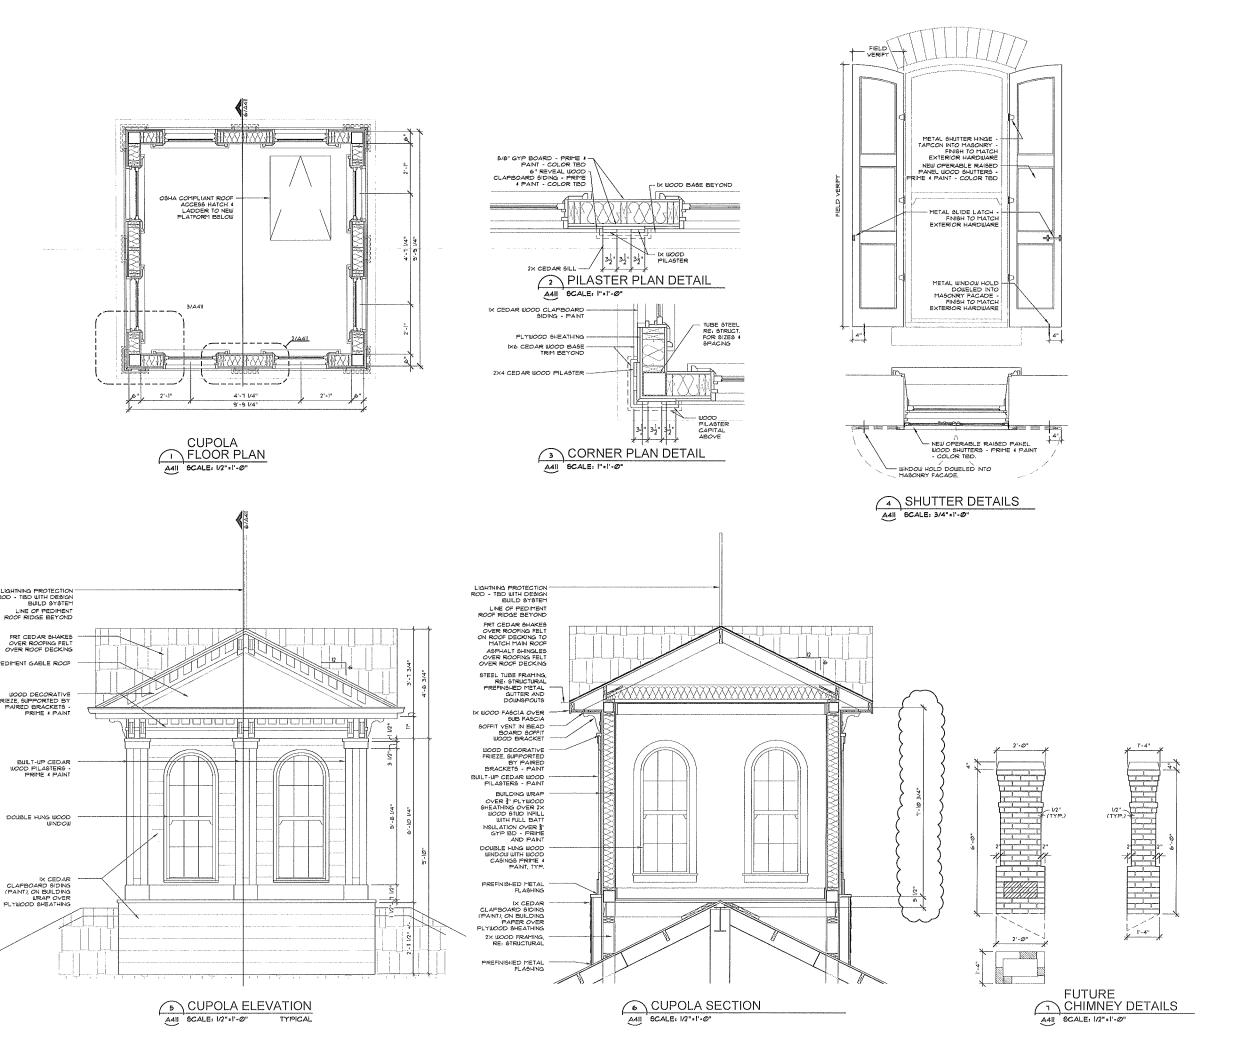

LIGHTNING PROTECTION ROD - TBD WITH DESIGN BUILD 9Y9TEM

PEDIMENT GABLE ROOF

BUILT-UP CEDAR WOOD PILASTERS -PRIME 4 PAINT

DOUBLE HING WOOD WINDOW

LINE OF PEDIMENT ROOF RIDGE BEYOND


RNATHIE Ш 406 S. BOULDER AVENU 918,599,0541 FAX: 918,599,0983 AB S Ш SIK

One

Phase Capitol Cherokee Nation

Tahlequah, RAWN BY: CHECKED BY ISSUED:

and Cupola a Details

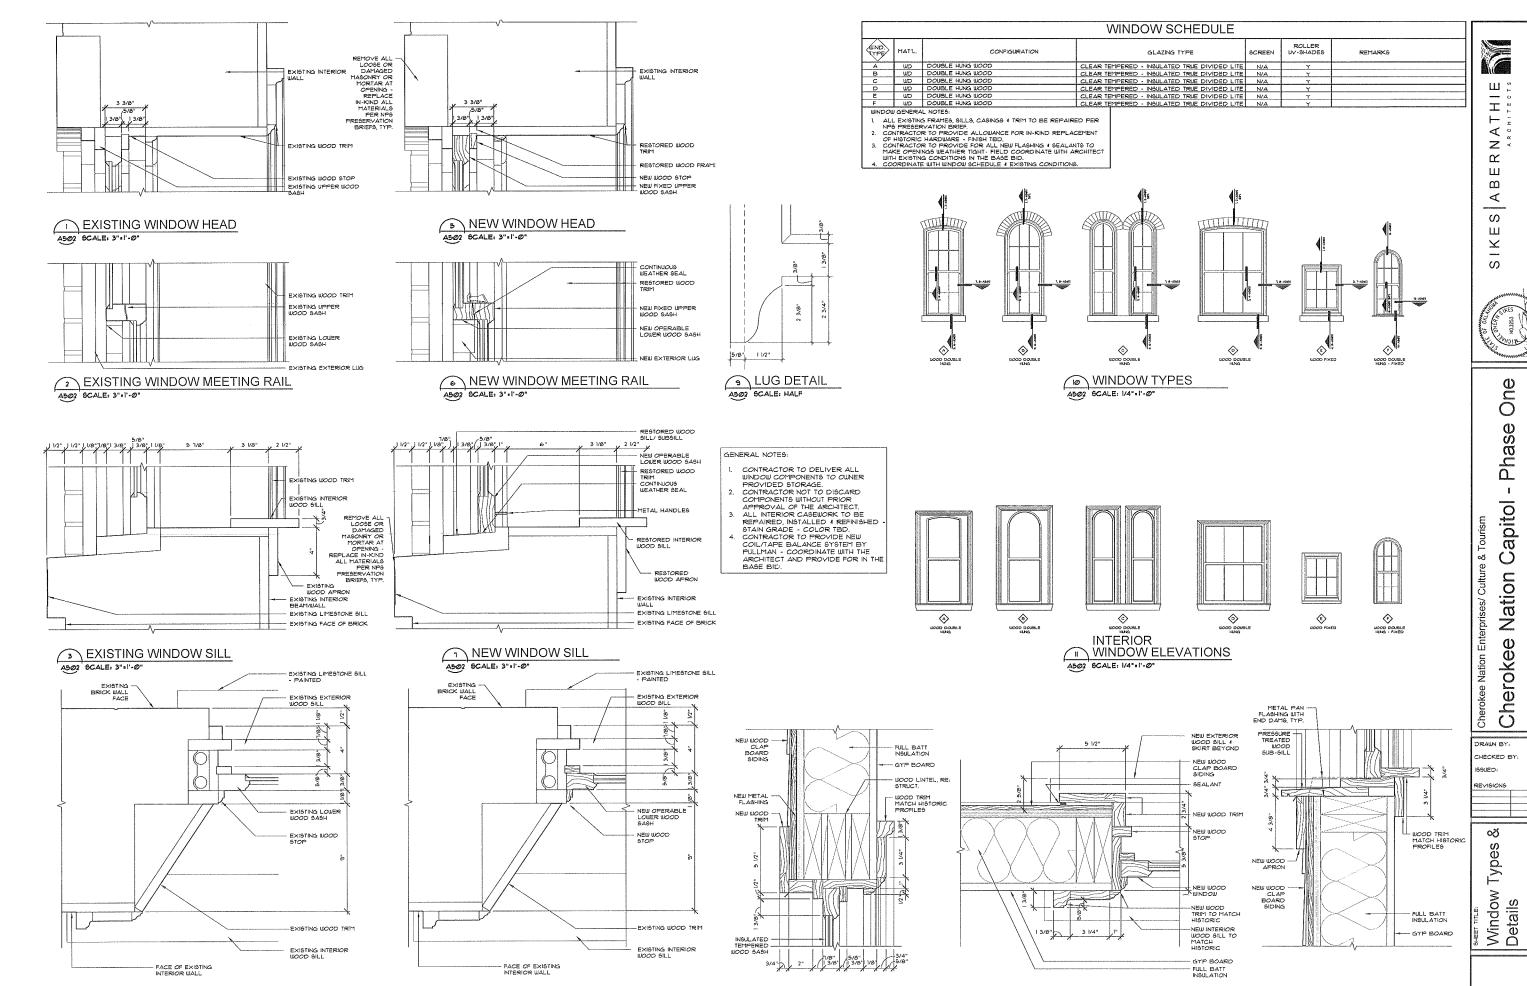

NEW WINDOW HEAD

4502 8CALE: 3"+1'-0"

NEW WINDOW JAMB

A5@2 SCALE: 3":1'-@"

NEW WINDOW JAMB

A502 SCALE: 3"+1'-0"

EXISTING WINDOW JAMB

A502 GCALE: 3"+1'-0"

A502

NEW WINDOW SILL


A502 SCALE: 3" #1'-0'

Tahlequah,


KPG

10/15/12

406 S. BOULDER AVENU 918:599:0541 FAX: 918:599:0983

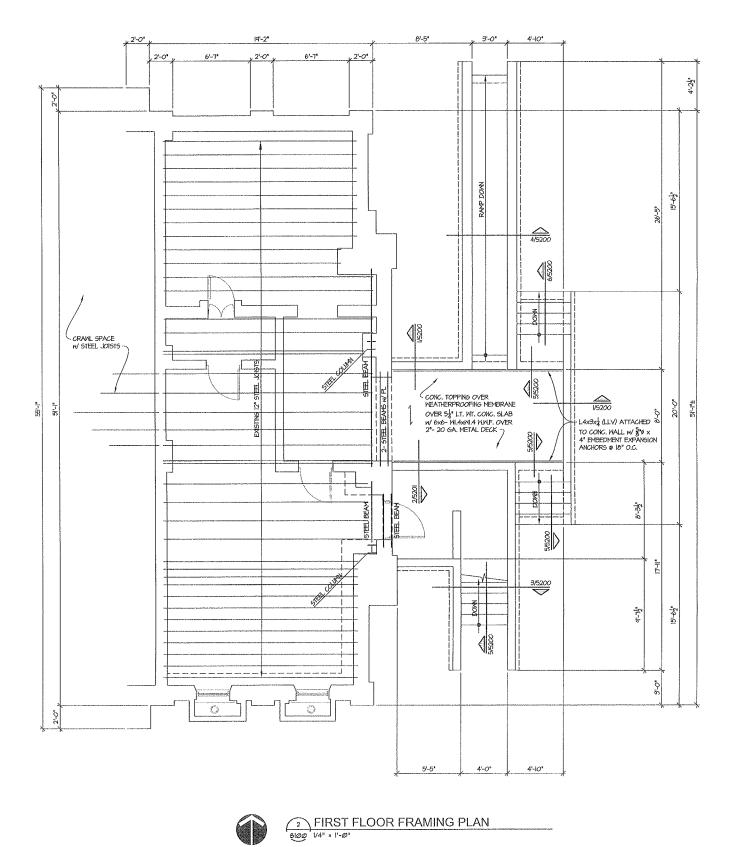


NORTH

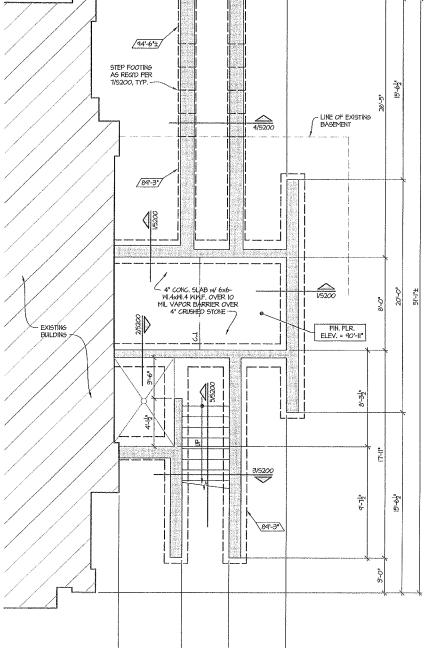

3'-0°

4'-10"

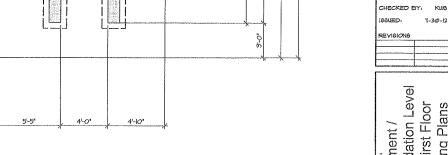



BASEMENT LEVEL FOUNDATION PLAN

LEGEND

89-37 - INDICATES BOTTOM OF FOOTING ELEVATION

Basement /
Basement /
Foundation Level
and First Floor
Framing Plans

ERNATHIE

SIKES AB

Capio

Z Z O


Cherokee I

7-30-12

DRAWN BY:

Cherokee Nation Enterprises/ Culture & Tourism

406 S. BOULDER AVENUE, SUITE 700 918.599.0541 FAX: 918.599.0983

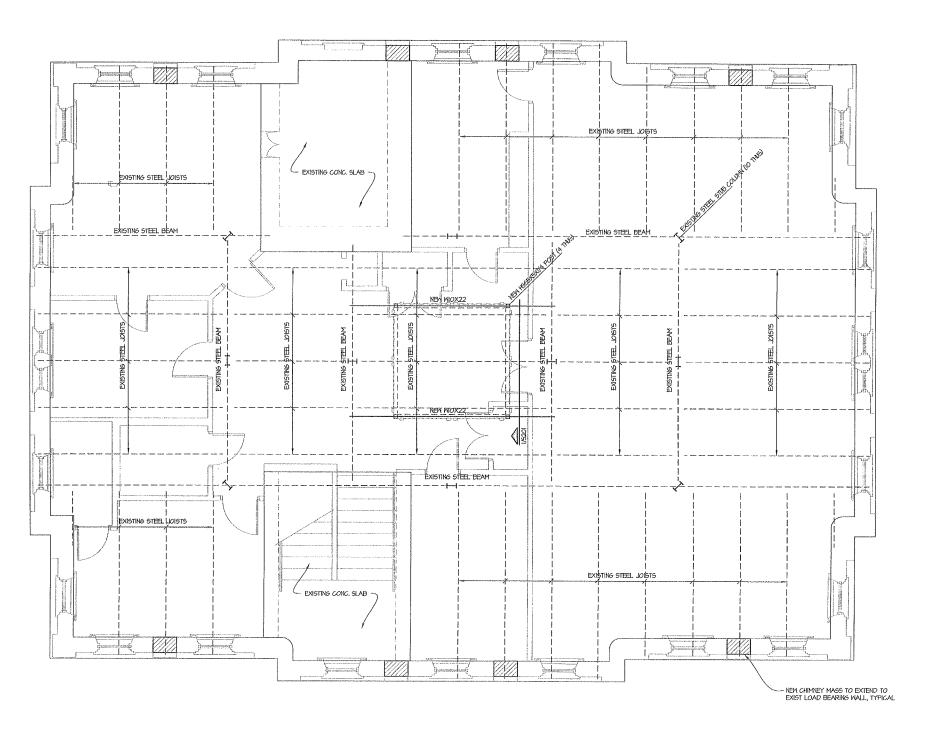








SIKES ABERNATHIE

406 S. BOULDER AVENUE, SUITE 700 TULSA, 918.599.0541 FAX: 918.599.0983

Cherokee Nation Capitol Cherokee Nation Enterprises/ Culture & Tourism

CHECKED BY: KING 7-3Ø-12 REVISIONS

eer m.e. Ceiling Framing Plan

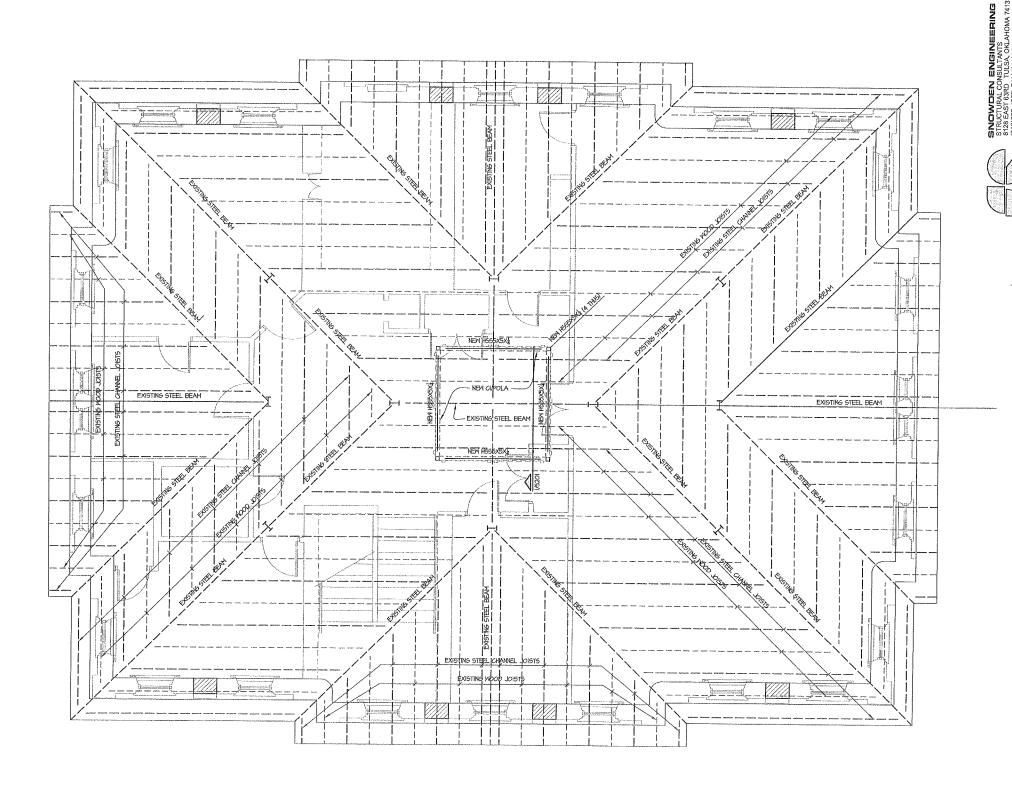





Cherokee Nation Capitol Cherokee Nation Enterprises/ Culture & Tou


406 S. BOULDER AVENUE, SUITE 700 TULSA, OK 74103 918.589.6541 FAX: 918.599.0883


SIKES ABERNATHIE

PROFESS/ON W. KEVIN W. 18264

DRAWN BY: ssued: 7-30-12

Roof Framing Plan

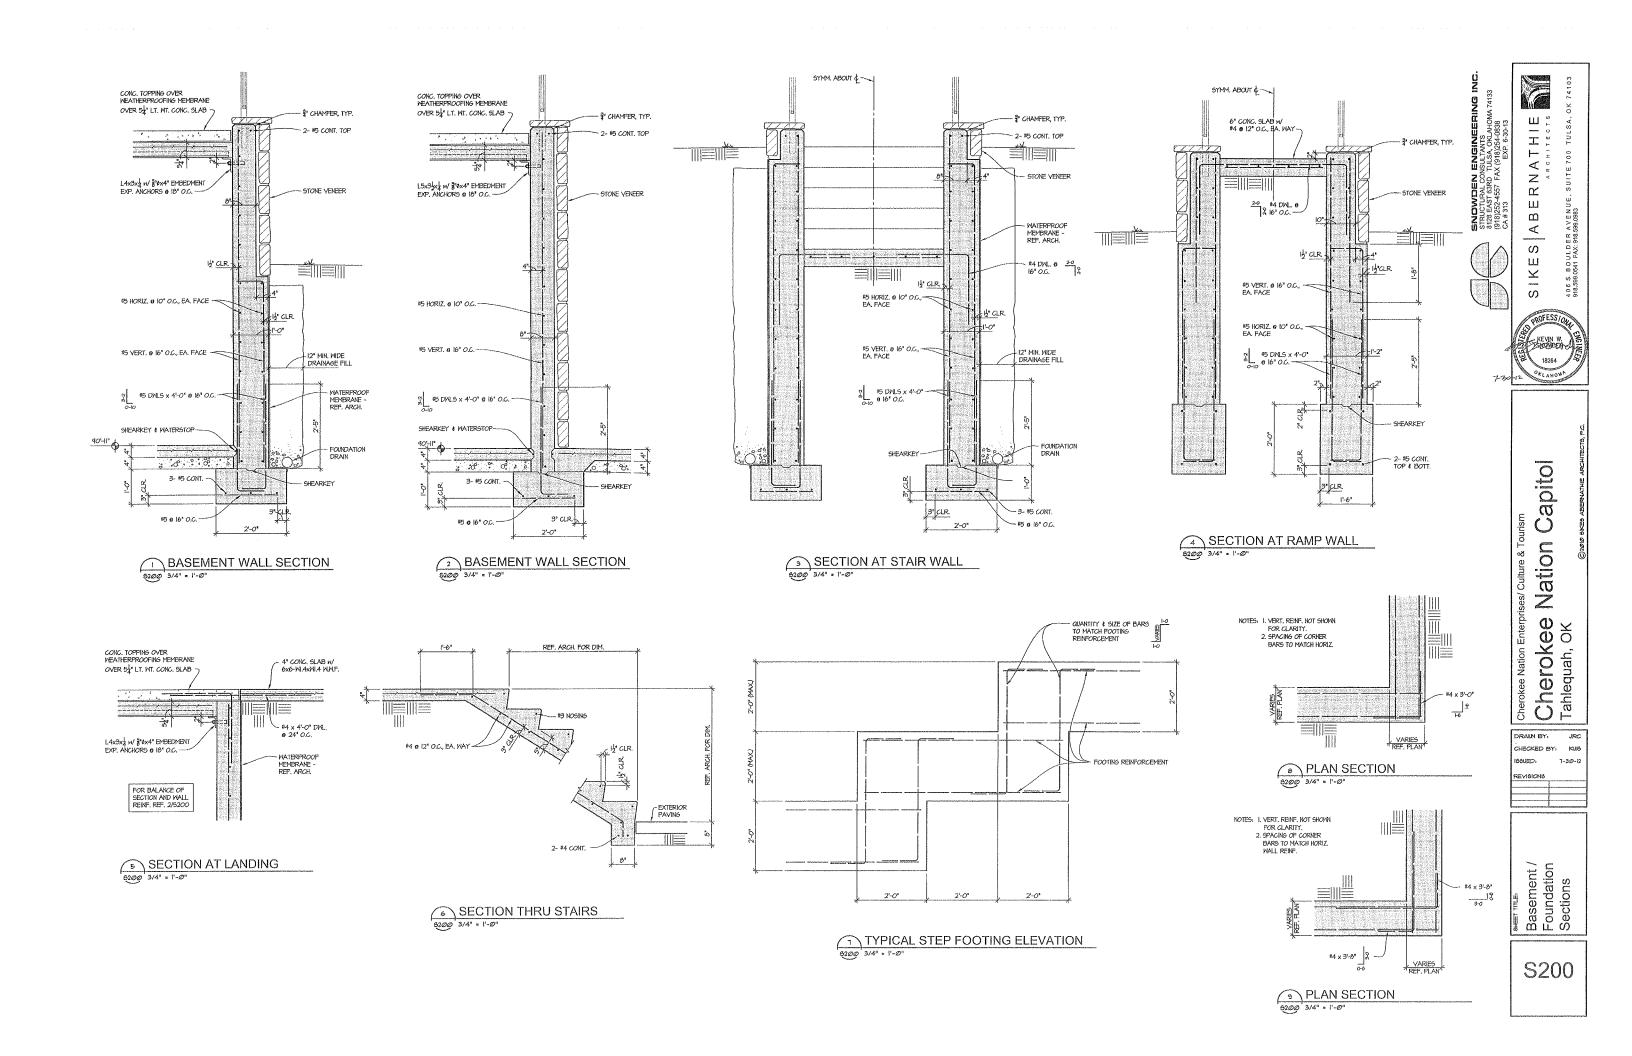

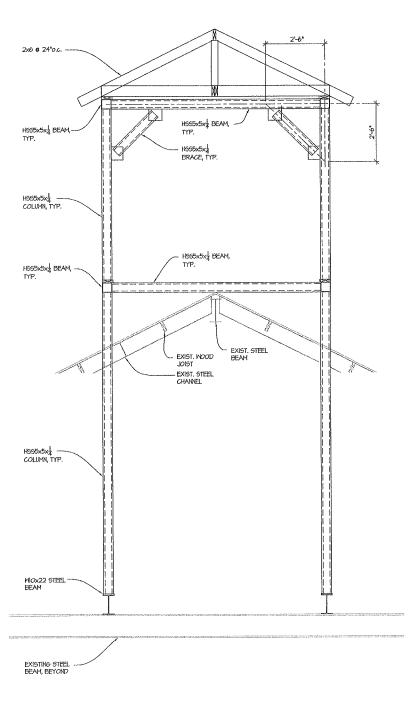

FRAME ELEVATION

SIKES ABERNATHIE

406 S. BOULDER AVENUE, SUITE 700 918,599,0541 FAX: 918,599,0983

Cherokee Nation Capitol Tahlequah, OK Cherokee Nation Enterprises/ Culture & Tourism

7-30-12

DRAWN BY: CHECKED BY: KINS ISSUED:

жет тп.е. Frame Elevation