



Modification Bulletin

**Project Name: Cherokee Hard Rock Casino 4
777 W CHEROKEE ST
CATOOSA, OK 74344**

Project No:

Modification Bulletin No: 02

To: Flintco, LLC

Date: 06/14/2018

Description:

This bulletin provides revisions to the structural drawings as described below.

1. S-111 - FOUNDATION PLAN - AREA 1
 - a. Foundation plan revised at Porte Cochere
 - b. Dimensions at overhead door along grid line A revised
2. S-112 - FOUNDATION PLAN - AREA 2
 - a. Foundation plan revised at stage and at kitchen/safer room CMU walls
 - b. E'-7' pier type revised and relocated
3. S-114 - CONCRETE SLAB PLANS
 - a. Plan A1 revised.
4. S-121 - MEZZANINE/LOW ROOF FRAMING PLAN - AREA 1
 - a. Framing revised at Porte Cochere
 - b. Dimensions at overhead door along grid line A revised
5. S-143 - TOWER ROOF FRAMING PLAN - AREA 1
 - a. Plan A2 - dimensions added.
6. S-302 - WALL SECTIONS
 - a. Wall sections A2 and A3 revised at Porte Cochere
7. S-313 - FOUNDATION SECTIONS
 - a. Sections A3, B3, C3, A2, B2, D2, A1, B1, D1, E1 added.
8. S-321 - FLOOR FRAMING SECTIONS
 - a. Sections A1, B1, C1, D1 added
9. S-501 - FRAMING DETAILS
 - a. Sections B2, C2, and A1 added
10. S-601 - SCHEDULES
 - a. Pier mark P27 and P28 added to schedule
11. S-602 - SCHEDULES
 - a. Base plate type J added
 - b. Base plate mark BP23 added

1. M-211
 - a. Re-route and resize chilled water supply/return system to serve kitchen equipment.
 2. M-212
 - a. Re-route and resize chilled water supply/return system to serve kitchen equipment.
 3. M-221
 - a. Re-route and resize chilled water supply/return system to serve kitchen equipment.
 4. M-222
 - a. Re-route and resize chilled water supply/return system to serve kitchen equipment.
-
1. P-111
 - a. Added storm routing and termination and lower porte cochere roof drains.
 2. P-211
 - a. Added east side porte cochere roof drains.
 3. P-161
 - a. Added note on plans referring to roof drains on floor below.

Attachments:


Structural sheets S-111, S-112, S-114, S-121, S-143, S-302, S-313, S-321, S-501, S-601, S-602

Mechanical sheets M-211, M-212, M-221, M-222

Plumbing sheets P-111, P-121, P-161

Issued by:

cc: Flintco – Matt Croll
Flintco -
Flintco –
RK & A- Rick Kosman
CG - Nicholas Torres
MSA – Robbie Jones
MSA - Shane Savoy
M/E – Rob Radlly
ERA – Doug Huber
ERA – Shannon Henson
ERA – Bryan Broaddrick
JCJ – Grace Fabian

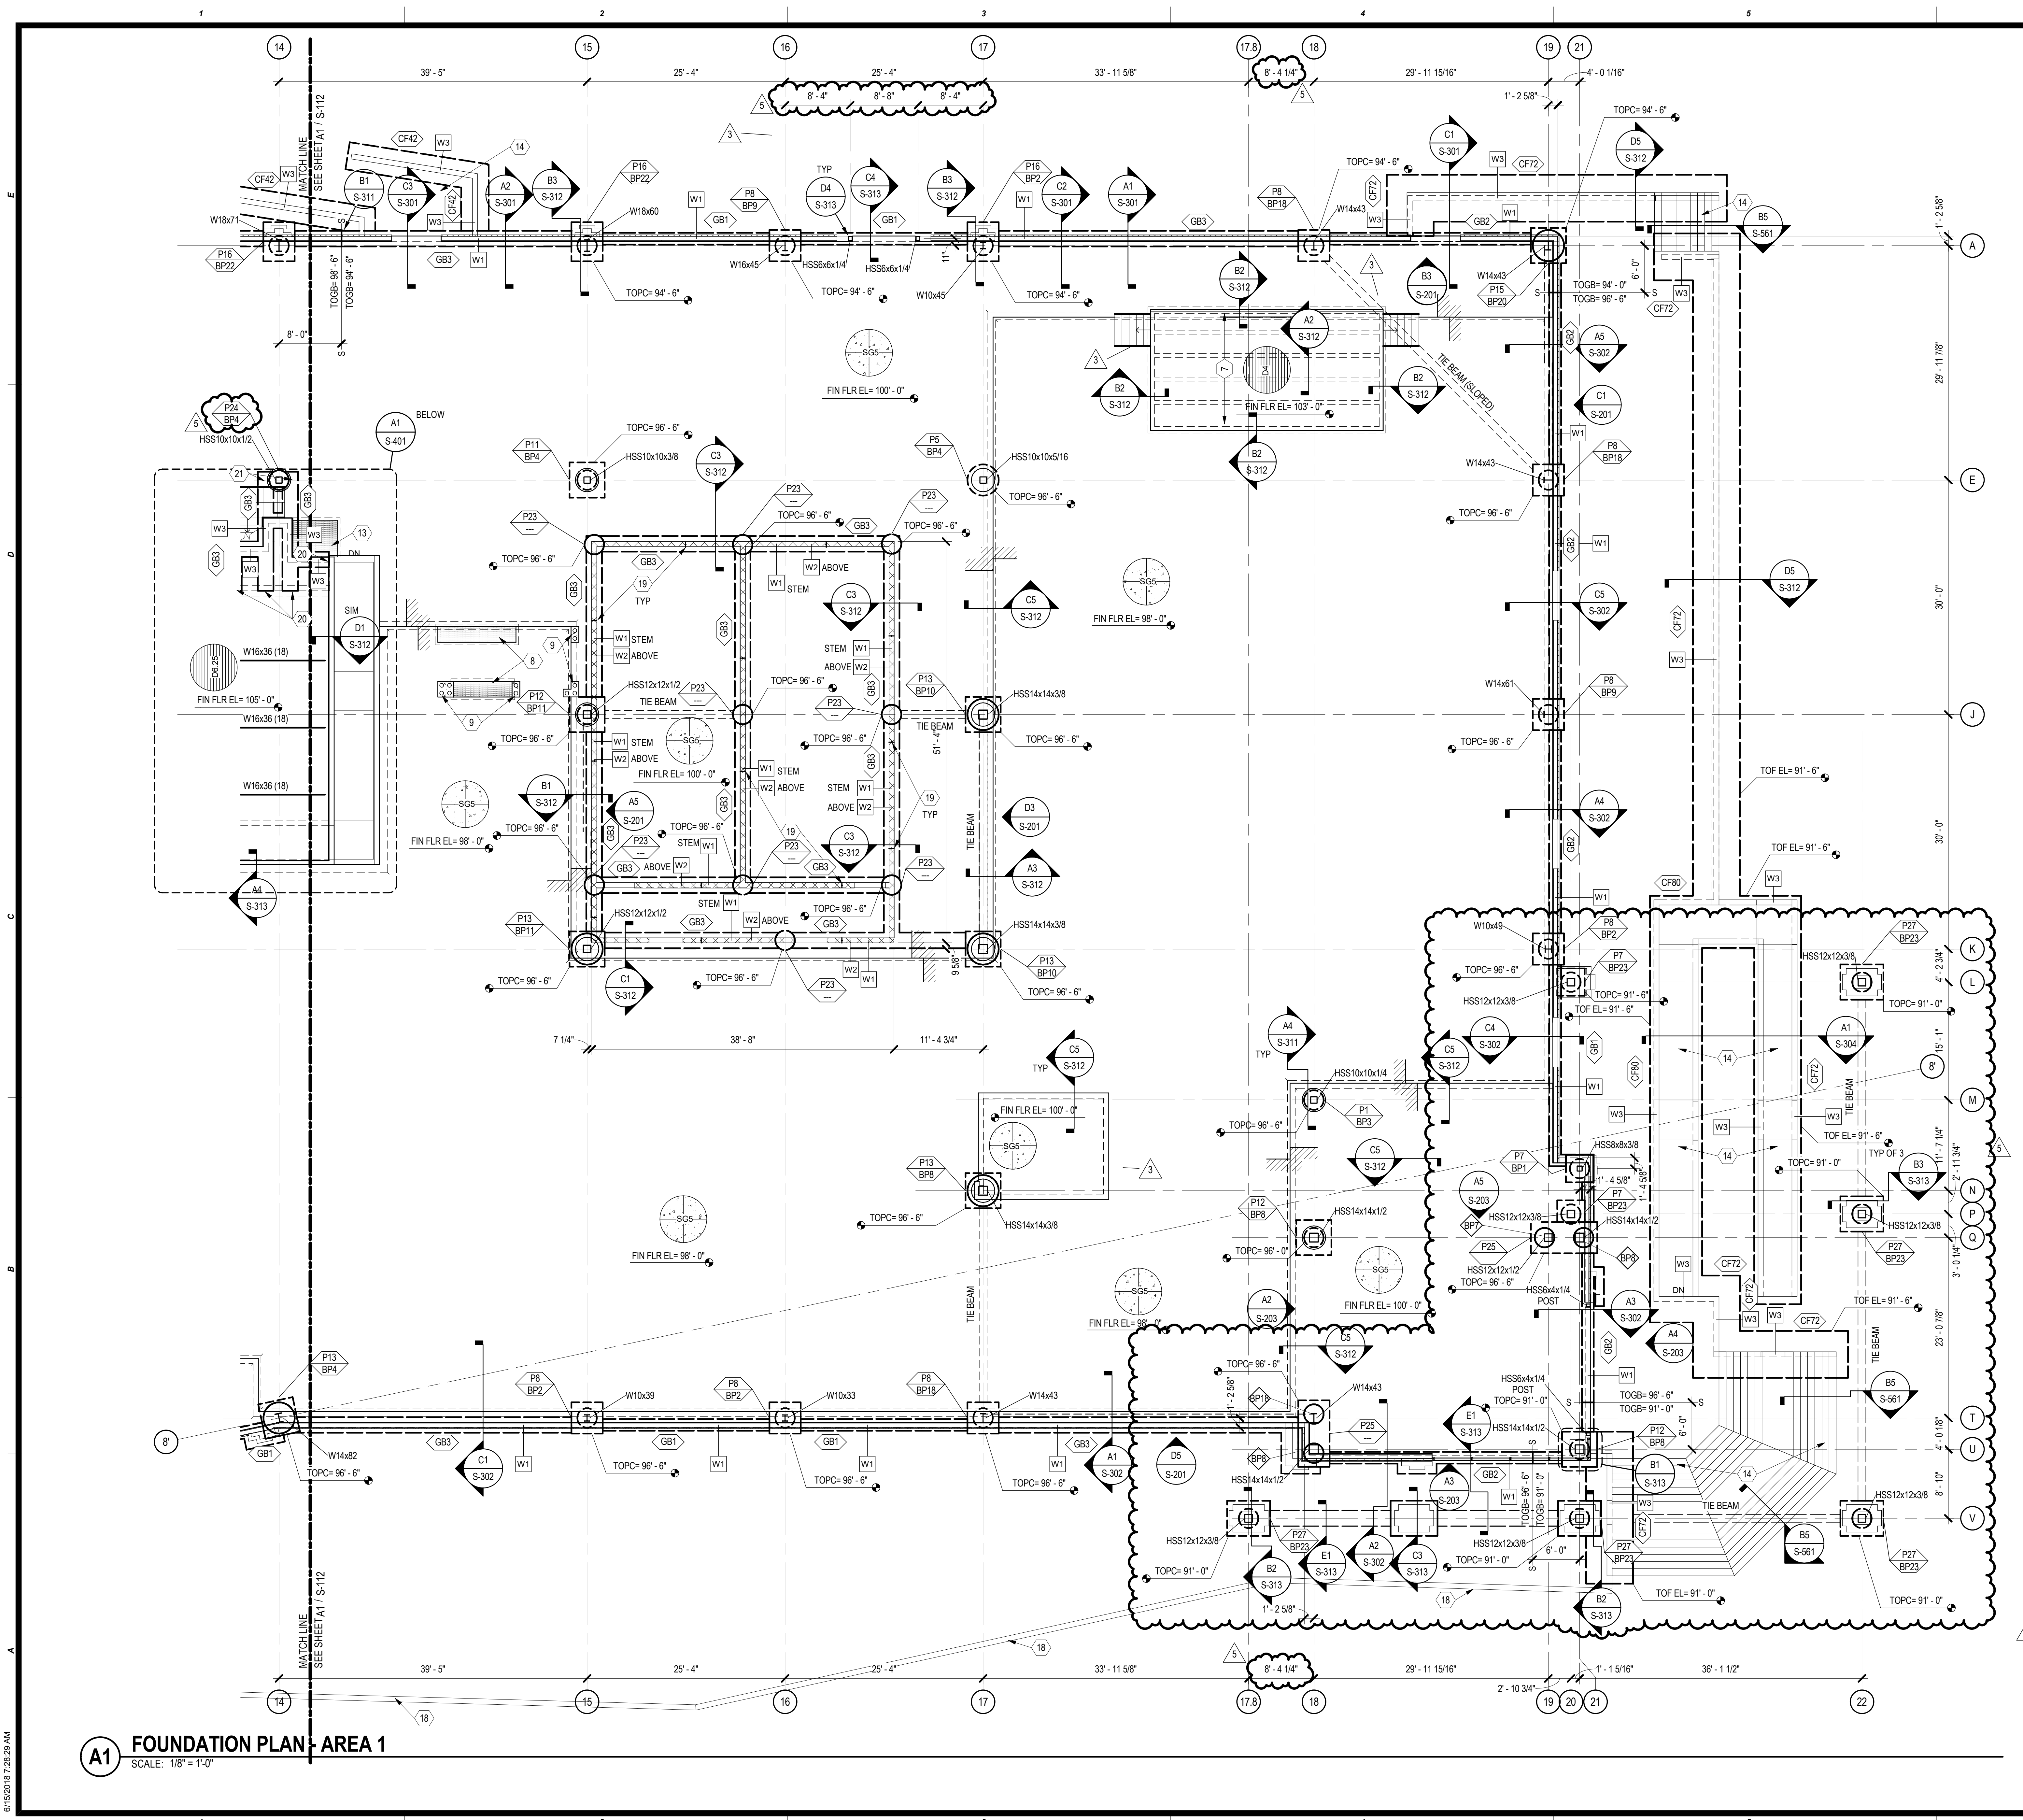

GENERAL SHEET NOTES

- SOME SHEET KEYNOTES MAY NOT APPLY TO THIS SHEET.
- REFERENCE FINISH FLOOR ELEVATION 100'-0" MEAN SEA FINISH FLOOR ELEVATION. SEE CIVIL DRAWINGS.
- TOP OF PIER CAP AND TOP OF PIER WITHOUT CAP ELEVATION = 98'-6", UNLESS NOTED OTHERWISE.
- TOP OF GRADE BEAM ELEVATION = 98'-6", UNLESS NOTED OTHERWISE.
- TOP OF THE BEAM ELEVATION = TOP OF PIER CAP OR GRADE BEAM ELEVATION IT IS CONNECTING TO.
- GRADE BEAMS SHALL BE DOWELED INTO PIER CAPS. SEE D1 / S-311
- EXTEND THE BEAM REINFORCING INTO PIER CAPS AND TERMINATE WITH STANDARD HOOKS.
- PROVIDE COLUMN BLOCKOUTS IN SLAB. SEE C5 / S-711
- NOTE TO CONTRACTOR: ENLARGED SLAB BLOCKOUTS MAY BE REQUIRED AT FRAME COLUMNS FOR BRACED FRAME GUSSET PLATE CLEARANCE.
- NOTE TO ERECTOR: LATERAL STABILITY OF THE STEEL FRAME IS DEPENDENT UPON THE BRACED FRAMES. THE ERECTOR SHALL PROVIDE TEMPORARY BRACING OF THE STEEL FRAME IN ACCORDANCE WITH SECTION 7.10 OF THE AISC CODE OF STANDARD PRACTICES.
- DIMENSIONS ARE TO THE FACE OF CONCRETE, MASONRY, OR GRID LINE, UNLESS NOTED OTHERWISE.
- SEE ARCHITECTURAL DRAWINGS FOR MASONRY DIMENSIONS NOT SHOWN.
- EXISTING CONSTRUCTION IS PER AVAILABLE EXISTING DRAWINGS. ALL EXISTING CONSTRUCTION AND DIMENSIONS SHALL BE VERIFIED PRIOR TO CONSTRUCTION. SHOULD CONDITIONS VARY FROM THOSE SHOWN, CONTACT ENGINEER BEFORE PROCEEDING.
- PROVIDE SLAB JOINTS AT 15'-0" ON CENTER MAXIMUM. THE AREA OF THE CONTROL JOINT SHALL NOT EXCEED A 2:1 RATIO. CONTROL JOINTS SHALL BE LOCATED AT COLUMN LINES WHERE THE LAYOUT PERMITS. AT RE-ENTRANT CORNERS THAT DO NOT HAVE CONTROL JOINTS, PROVIDE 2#4 x 3'-0" DIAGONAL TO THE RE-ENTRANT CORNER.
- SEE SHEET S-311, S-312 FOR TYPICAL FOUNDATION SECTIONS AND DETAILS.
- SEE SHEETS S-711 THRU S-741 FOR TYPICAL DETAILS.
- SEE SHEET S-601 AND S-602 FOR SCHEDULES.

SHEET KEYNOTE

- FLOOR DRAIN. SLOPE SLAB TO DRAIN 1/8" PER FOOT. COORDINATE EXACT SIZE AND LOCATION WITH ARCHITECTURAL AND MECHANICAL DRAWINGS.
- ELEVATOR SUMP PIT. COORDINATE EXACT SIZE AND LOCATION WITH ELEVATOR MANUFACTURER. SEE A4 / S-561
- NOT USED
- RECESSED SLAB. COORDINATE EXACT SIZE, LOCATION, AND DEPTH WITH ARCHITECTURAL DRAWINGS.
- DOWEL PIT WALL REINFORCING 18" INTO GRADE BEAM. PROVIDE STANDARD HOOK.
- EXISTING FOOTING AND COLUMN TO BE DEMOLISHED IN THEIR ENTIRETY. FIELD VERIFY.
- 6" GOLD-FORMED METAL STUD WALLS BY OTHERS AT 24" ON CENTER MAXIMUM.
- RECESSED SLAB. COORDINATE EXACT SIZE, LOCATION AND DEPTH WITH FOOD SERVICE AND ARCHITECTURAL DRAWINGS. SEE C4 / S-711
- CONCRETE CURB AROUND PIPE DUCT. COORDINATE EXACT SIZE, LOCATION, AND DETAILING WITH FOOD SERVICE AND ARCHITECTURAL DRAWINGS.
- TRENCH DRAIN. COORDINATE EXACT SIZE AND LOCATION WITH FOOD SERVICE AND ARCHITECTURAL DRAWINGS.
- HATCHED AREA INDICATES EXTENT OF INSULATED FREEZER SLAB. COORDINATE EXACT SIZE, LOCATION, AND DEPTH WITH FOOD SERVICE DRAWINGS AND FREEZER MANUFACTURER.
- COORDINATE DIMENSIONS TO STAGE SLAB EDGE WITH ARCHITECTURAL DRAWINGS.
- HATCHED AREA INDICATES EXTENT OF WHEELCHAIR LIFT PIT. COORDINATE EXACT SIZE, LOCATION AND DEPTH OF PIT WITH ARCHITECTURAL DRAWINGS AND WHEELCHAIR LIFT MANUFACTURER. SEE C4 / S-711
- EXTERIOR STAIR OR RAMP. COORDINATE EXACT SIZE, LOCATION, AND DIMENSIONS WITH ARCHITECTURAL AND CIVIL DRAWINGS.
- PORTION OF EXISTING WALL TO BE REMOVED. SEE ARCHITECTURAL DRAWINGS FOR EXACT SIZE AND LOCATION OF OPENING.
- EXISTING STAIRS, COLUMNS AND FOUNDATIONS TO BE REMOVED AS REQUIRED FOR NEW CONSTRUCTION.
- HSS14x3/8 ELEVATOR RAIL SUPPORT POST. COORDINATE LOCATION WITH ELEVATOR MANUFACTURER. SEE B4 / S-561
- CONCRETE SITE RETAINING WALL. COORDINATE ALL DIMENSIONS AND ELEVATIONS WITH ARCHITECTURAL AND CIVIL DRAWINGS. SEE RETAINING SCHEDULE C3 / S-602 FOR ADDITIONAL INFORMATION.
- MASONRY CONTROL JOINT. PLACE AT A MAXIMUM SPACING OF 12'-0" FROM CORNERS AND 20'-0" OC MAX IN THE FIELD OF THE WALL. NOTE: CONTROL JOINTS TO ALLOW FOR A MINIMUM OF ONE FULL CELL ADJACENT TO OPENINGS FOR JAM. SEE ARCH DRAWINGS FOR EXACT MASONRY DIMS.
- DOWEL GRADE BEAM AND STEIN WALL REINFORCING INTO BASEMENT WALL. SEE A3 / S-313
- EXTEND GRADE BEAMS AND DOWEL GRADE BEAM REINFORCING INTO PIER CAP.

EDMUNDSON REED ASSOCIATES
1401 S. Denver Ave., Suite B
Tulsa, OK 74119
Tel: (918) 884-6007
Fax: (972) 278-1242

This document, and the ideas and designs incorporated herein, are an instrument of professional service, and are the property of EDMUNDSON REED ASSOCIATES, and are not to be used, in whole or in part, for any other project, without the written authorization of EDMUNDSON REED ASSOCIATES.

INTERIOR ARCHITECTURE
JCJ Architecture
120 Hayslope Avenue
Suite 400
Hartford, CT 06106
860-247-9226

STRUCTURAL ENGINEERING
Chavez-Grievos Consulting Engineers, Inc.
4700 Lincoln Road NE
Suite 102
Albuquerque, NM 87109
505-344-4080

MEP ENGINEERING
MSA Engineering Consultants
370 E. Windmill Ln.
Suite 100
Las Vegas, NV 89123
702-996-1100

CIVIL ENGINEERING / SURVEYING
Native Plans Surveying and Mapping / RK & Associates PLC
5807 S. Garnett Rd.
Suite K
Tulsa, OK 74146
918-234-7596

LOW VOLTAGE / THEME LIGHTING
M/E Engineering
60 Lakewood Boulevard
Suite 300
Buffalo, NY 14202
716-845-5092

FOOD SERVICES
Hestman Group, LLC
7645 E. 83rd St.
Suite 201
Tulsa, OK 74133
918-935-5036

CHEROKEE HARD ROCK CASINO 4

CASINO 4

FOUNDATION PLAN - AREA 1

CONSTRUCTION SET


PROJECT NO: 201704
DRAWN BY: J. ANDERSON
CHECKED BY: C. ROMERO
ISSUE DATE: 5/4/2018


DATE: 05/16/2018
06/14/2018

Scale: As indicated

A1 FOUNDATION PLAN - AREA 1
SCALE: 1/8" = 1'-0"

6/15/2018 7:28:29 AM

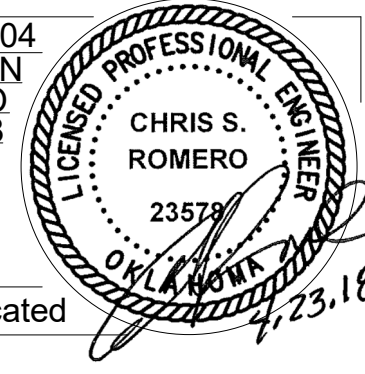

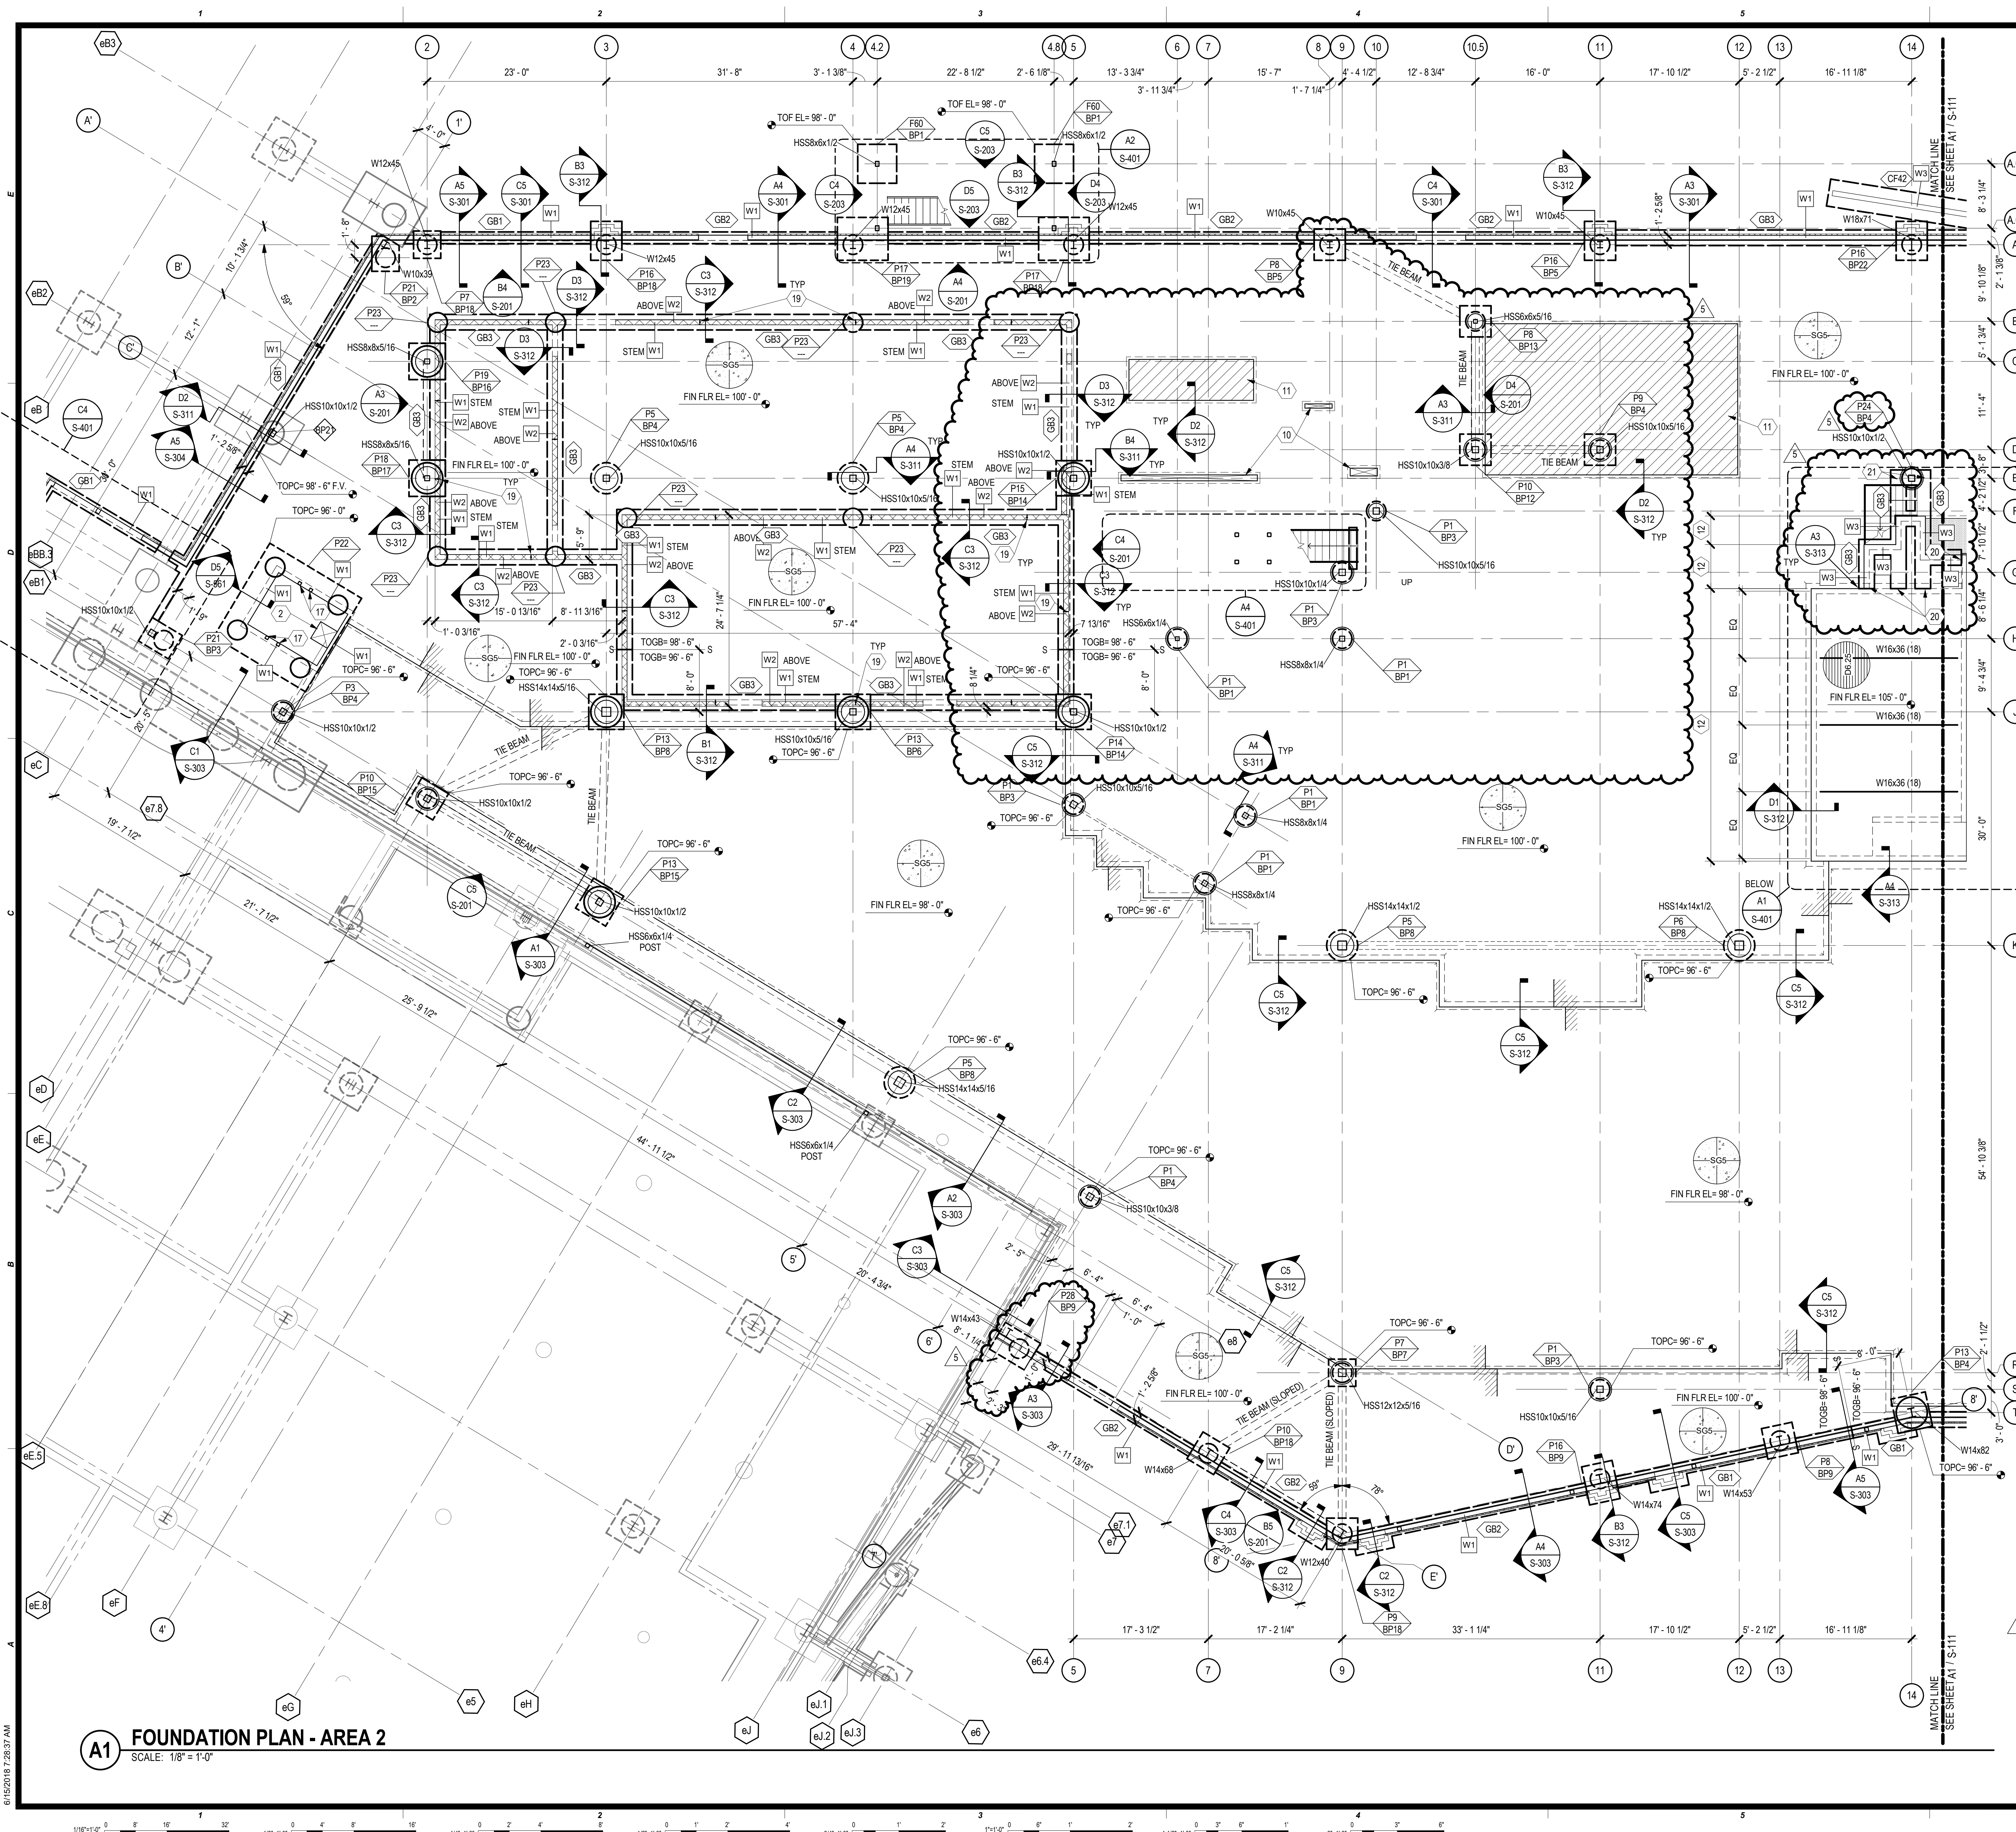

GENERAL SHEET NOTES

- SOME SHEET KEYNOTES MAY NOT APPLY TO THIS SHEET.
- REFERENCE FINISH FLOOR ELEVATION 100'-0" MEAN SEA FINISH FLOOR ELEVATION. SEE CIVIL DRAWINGS.
- TOP OF PIER CAP AND TOP OF PIER WITHOUT CAP ELEVATION = 98'-6", UNLESS NOTED OTHERWISE.
- TOP OF GRADE BEAM ELEVATION = 98'-6", UNLESS NOTED OTHERWISE.
- TOP OF THE BEAM ELEVATION = TOP OF PIER CAP OR GRADE BEAM ELEVATION IT IS CONNECTING TO.
- GRADE BEAMS SHALL BE DOWELED INTO PIERS. SEE D1 / S-311
- EXTEND THE BEAM REINFORCING INTO PIER CAPS AND TERMINATE WITH STANDARD HOOKS.
- PROVIDE COLUMN BLOCKOUTS IN SLAB. SEE C5 / S-711
- NOTE TO CONTRACTOR: ENLARGED SLAB BLOCKOUTS MAY BE REQUIRED AT FRAME COLUMNS FOR BRACED FRAME GUSSET PLATE CLEARANCE.
- NOTE TO ERECTOR: LATERAL STABILITY OF THE STEEL FRAME IS DEPENDENT UPON THE BRACED FRAMES. THE ERECTOR SHALL PROVIDE TEMPORARY BRACING OF THE STEEL FRAME IN ACCORDANCE WITH SECTION 7.10 OF THE AISI CODE OF STANDARD PRACTICES.
- DIMENSIONS ARE TO THE FACE OF CONCRETE, MASONRY, OR GRID LINE, UNLESS NOTED OTHERWISE.
- SEE ARCHITECTURAL DRAWINGS FOR MASONRY DIMENSIONS NOT SHOWN.
- EXISTING CONSTRUCTION IS PER AVAILABLE EXISTING DRAWINGS. ALL EXISTING CONSTRUCTION AND DIMENSIONS SHALL BE VERIFIED PRIOR TO CONSTRUCTION. SHOULD CONDITIONS VARY FROM THOSE SHOWN, CONTACT ENGINEER BEFORE PROCEEDING.
- PROVIDE SLAB JOINTS AT 15'-0" ON CENTER MAXIMUM. THE AREA OF THE CONTROL JOINT SHALL NOT EXCEED A 2:1 RATIO. CONTROL JOINTS SHALL BE LOCATED AT COLUMN LINES WHERE THE LAYOUT PERMITS. AT RE-ENTRANT CORNERS THAT DO NOT HAVE CONTROL JOINTS, PROVIDE 2#4 x 3'-0" DIAGONAL TO THE RE-ENTRANT CORNER.
- SEE SHEET S-311, S-312 FOR TYPICAL FOUNDATION SECTIONS AND DETAILS.
- SEE SHEETS S-711 THRU S-741 FOR TYPICAL DETAILS.
- SEE SHEET S-601 AND S-602 FOR SCHEDULES.

SHEET KEYNOTE

- FLOOR DRAIN. SLOPE SLAB TO DRAIN 1/8" PER FOOT. COORDINATE EXACT SIZE AND LOCATION WITH ARCHITECTURAL AND MECHANICAL DRAWINGS.
- ELEVATOR SUMP PIT. COORDINATE EXACT SIZE AND LOCATION WITH ELEVATOR MANUFACTURER. SEE A4 / S-561
- NOT USED
- RECESSED SLAB. COORDINATE EXACT SIZE, LOCATION, AND DEPTH WITH ARCHITECTURAL DRAWINGS.
- DOWEL PIT WALL REINFORCING 18" INTO GRADE BEAM. PROVIDE STANDARD HOOK.
- EXISTING FOOTING AND COLUMN TO BE DEMOLISHED IN THEIR ENTIRETY. FIELD VERIFY.
- COLD-FORMED METAL STUD WALLS BY OTHERS AT 24" ON CENTER MAXIMUM.
- RECESSED SLAB. COORDINATE EXACT SIZE, LOCATION AND DEPTH WITH FOOD SERVICE AND ARCHITECTURAL DRAWINGS. SEE C4 / S-711
- CONCRETE CURB AROUND PIPE DUCT. COORDINATE EXACT SIZE, LOCATION, AND DETAILING WITH FOOD SERVICE AND ARCHITECTURAL DRAWINGS.
- TRENCH DRAIN. COORDINATE EXACT SIZE AND LOCATION WITH FOOD SERVICE AND ARCHITECTURAL DRAWINGS.
- HATCHED AREA INDICATES EXTENT OF INSULATED FREEZER SLAB. COORDINATE EXACT SIZE, LOCATION, AND DEPTH WITH FOOD SERVICE DRAWINGS AND FREEZER MANUFACTURER.
- COORDINATE DIMENSIONS TO STAGE SLAB EDGE WITH ARCHITECTURAL DRAWINGS.
- HATCHED AREA INDICATES EXTENT OF WHEELCHAIR LIFT PIT. COORDINATE EXACT SIZE, LOCATION AND DEPTH OF PIT WITH ARCHITECTURAL DRAWINGS AND WHEELCHAIR LIFT MANUFACTURER. SEE C4 / S-711
- EXTERIOR STAIR OR RAMP. COORDINATE EXACT SIZE, LOCATION, AND DIMENSIONS WITH ARCHITECTURAL AND CIVIL DRAWINGS.
- PORTION OF EXISTING WALL TO BE REMOVED. SEE ARCHITECTURAL DRAWINGS FOR EXACT SIZE AND LOCATION OF OPENING.
- EXISTING STAIRS, COLUMNS AND FOUNDATIONS TO BE REMOVED AS REQUIRED FOR NEW CONSTRUCTION.
- HSS5x3/8 ELEVATOR RAIL SUPPORT POST. COORDINATE LOCATION WITH ELEVATOR MANUFACTURER. SEE B4 / S-561
- CONCRETE SITE RETAINING WALL. COORDINATE ALL DIMENSIONS AND ELEVATIONS WITH ARCHITECTURAL AND CIVIL DRAWINGS. SEE RETAINING SCHEDULE C3 / S-602 FOR ADDITIONAL INFORMATION.
- MASONRY CONTROL JOINT. PLACE AT A MAXIMUM SPACING OF 12'-0" FROM CORNERS AND 20'-0" OC MAX IN THE FIELD OF THE WALL. NOTE: CONTROL JOINTS TO ALLOW FOR A MINIMUM OF ONE FULL CELL ADJACENT TO OPENINGS FOR JAM. SEE ARCH DRAWINGS FOR EXACT MASONRY DIMS.
- DOWEL GRADE BEAM AND STEM WALL REINFORCING INTO BASEMENT WALL. SEE A3 / S-313
- EXTEND GRADE BEAMS AND DOWEL GRADE BEAM REINFORCING INTO PIER CAP.

ERA
EDMONSON REED ASSOCIATES
1401 S. Denver Ave., Suite B
Tulsa, OK 74119
Tel: (918) 884-6007
Fax: (918) 278-1342

This document, and the ideas and designs incorporated herein, are an instrument of professional service, and are the property of EDMONSON REED ASSOCIATES, and shall not be used, in whole or in part, for any other project, without the written authorization of EDMONSON REED ASSOCIATES.

INTERIOR ARCHITECTURE
JCJ Architecture
1200 Highway Avenue
Suite 400
Hartford, CT 06106
860-247-9226

STRUCTURAL ENGINEERING
Chavez-Grievos Consulting Engineers, Inc.
4700 Lincoln Road NE
Suite 102
Albuquerque, NM 87109
505-344-4080

MEP ENGINEERING
MSA Engineering Consultants
370 E. Windmill Ln.
Suite 100
Las Vegas, NV 89123
702-996-1100

CIVIL ENGINEERING / SURVEYING
Native Plans Surveying and Mapping / RK & Associates PLLC
5807 S. Garnett Rd.
Suite K
Tulsa, OK 74146
918-234-7596

LOW VOLTAGE / THEME LIGHTING
M/E Engineering
60 Lakeland Boulevard
Suite 303
Buffalo, NY 14202
716-845-5092

FOOD SERVICES
Heimann Group, LLC
7645 E. 63rd St.
Suite 201
Tulsa, OK 74133
918-935-5036

CASINO 4

FOUNDATION PLAN - AREA 2

CONSTRUCTION SET

No.	Description	Date
5	BULLETIN #2	06/14/2018

PROJECT NO: 201704
DRAWN BY: J. ANDERSON
CHECKED BY: C. ROMERO
ISSUE DATE: 5/4/2018

Scale: As indicated

S-112

A1 FOUNDATION PLAN - AREA 2
SCALE: 1/8" = 1'-0"

CHEROKEE HARD ROCK CASINO 4

GENERAL SHEET NOTES

- SOME SHEET KEYNOTES MAY NOT APPLY TO THIS SHEET.
- REFERENCE FINISH FLOOR ELEVATION 100'-0" =MEAN SEA FINISH FLOOR ELEVATION. SEE CIVIL DRAWINGS.
- PROVIDE COLUMN BLOCKOUTS IN SLAB. SEE C5 / S-711
- NOTE TO ERECTOR: LATERAL STABILITY OF THE STEEL FRAME IS DEPENDENT UPON THE BRACED FRAMES. THE ERECTOR SHALL PROVIDE TEMPORARY BRACING OF THE STEEL FRAME IN ACCORDANCE WITH SECTION 7.10 OF THE AISC CODE OF STANDARD PRACTICES.
- DIMENSIONS ARE TO THE FACE OF CONCRETE, MASONRY, OR GRID LINE, UNLESS NOTED OTHERWISE.
- SEE SHEETS S-711 THRU S-741 FOR TYPICAL DETAILS.
- SEE SHEET S-601 AND S-602 FOR SCHEDULES.



This document, and the ideas and designs incorporated herein, as an instrument of professional service, is the property of EDMONDSON REED ASSOCIATES, and is not to be used, in whole or in part, for any other project, without the written authorization of EDMONDSON REED ASSOCIATES.

INTERIOR ARCHITECTURE

ICI Architecture
120 Hayshepe Avenue
Suite 400
Hartford, CT 06106
860-247-9226

STRUCTURAL ENGINEERING

Chavez-Grieves Consulting Engineers, Inc.
4700 Lincoln Road NE
Suite 102
Albuquerque, NM 87109
505-344-4080

MEP ENGINEERING

MSA Engineering Consultants
370 E. Windmill Ln.
Suite 100
Las Vegas, NV 89123
702-896-1100

CIVIL ENGINEERING / SURVEYING

Native Plans Surveying and Mapping / RK & Associates PLC
5807 S. Garnett Rd.
Suite K
Tulsa, OK 74146
918-234-7596

LOW VOLTAGE / THEME LIGHTING


M/E Engineering
60 Lakefront Boulevard
Suite 303
Buffalo, NY 14202
716-845-5092

FOOD SERVICES


Hestman Group, LLC
7645 E. 63rd St.
Suite 201
Tulsa, OK 74133
918-935-5036

SHEET KEYNOTE

- ADD #6 @ 16" OC TOP X 12'-0", CENTER OVER WALL
- ADD #6 @ 16" OC TOP X 8'-0", HOOK INTO WALL
- ADD #6 @ 16 BOT X 20'-0"
- ADD #6 @ 16 BOT X 16'-0"

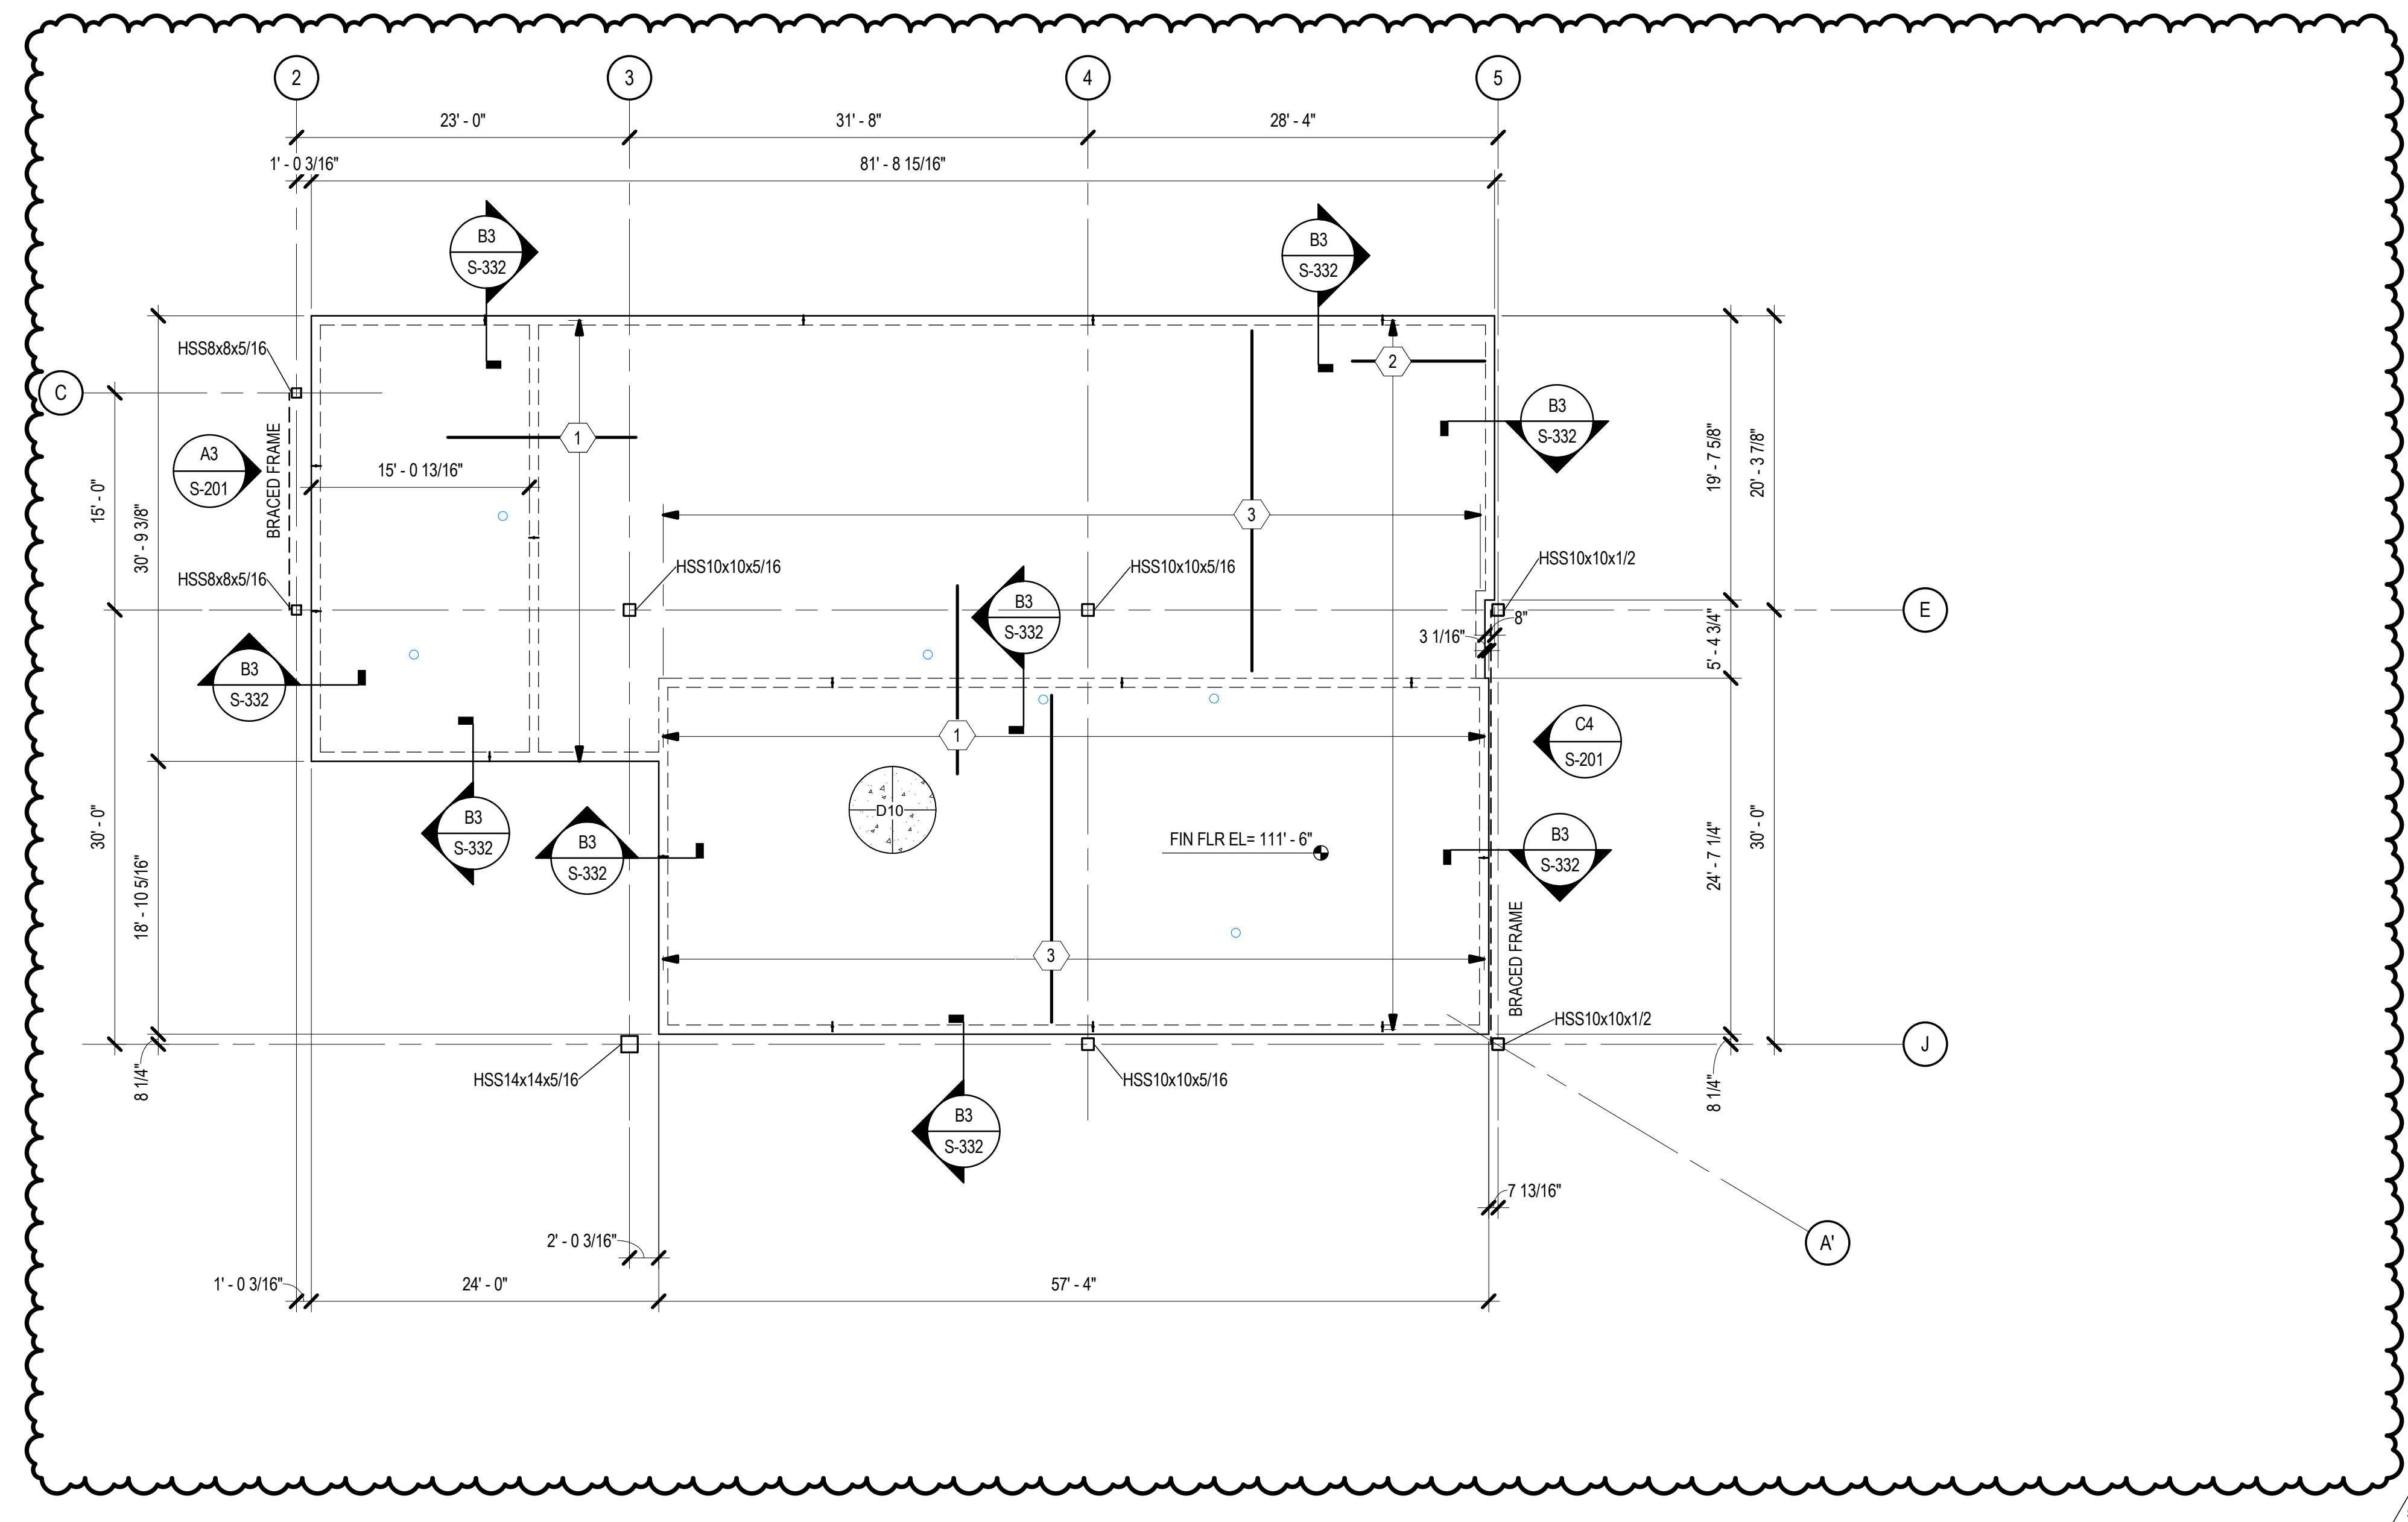

A1 WEST SAFER ROOM LID PLAN
SCALE: 1/8" = 1'-0"

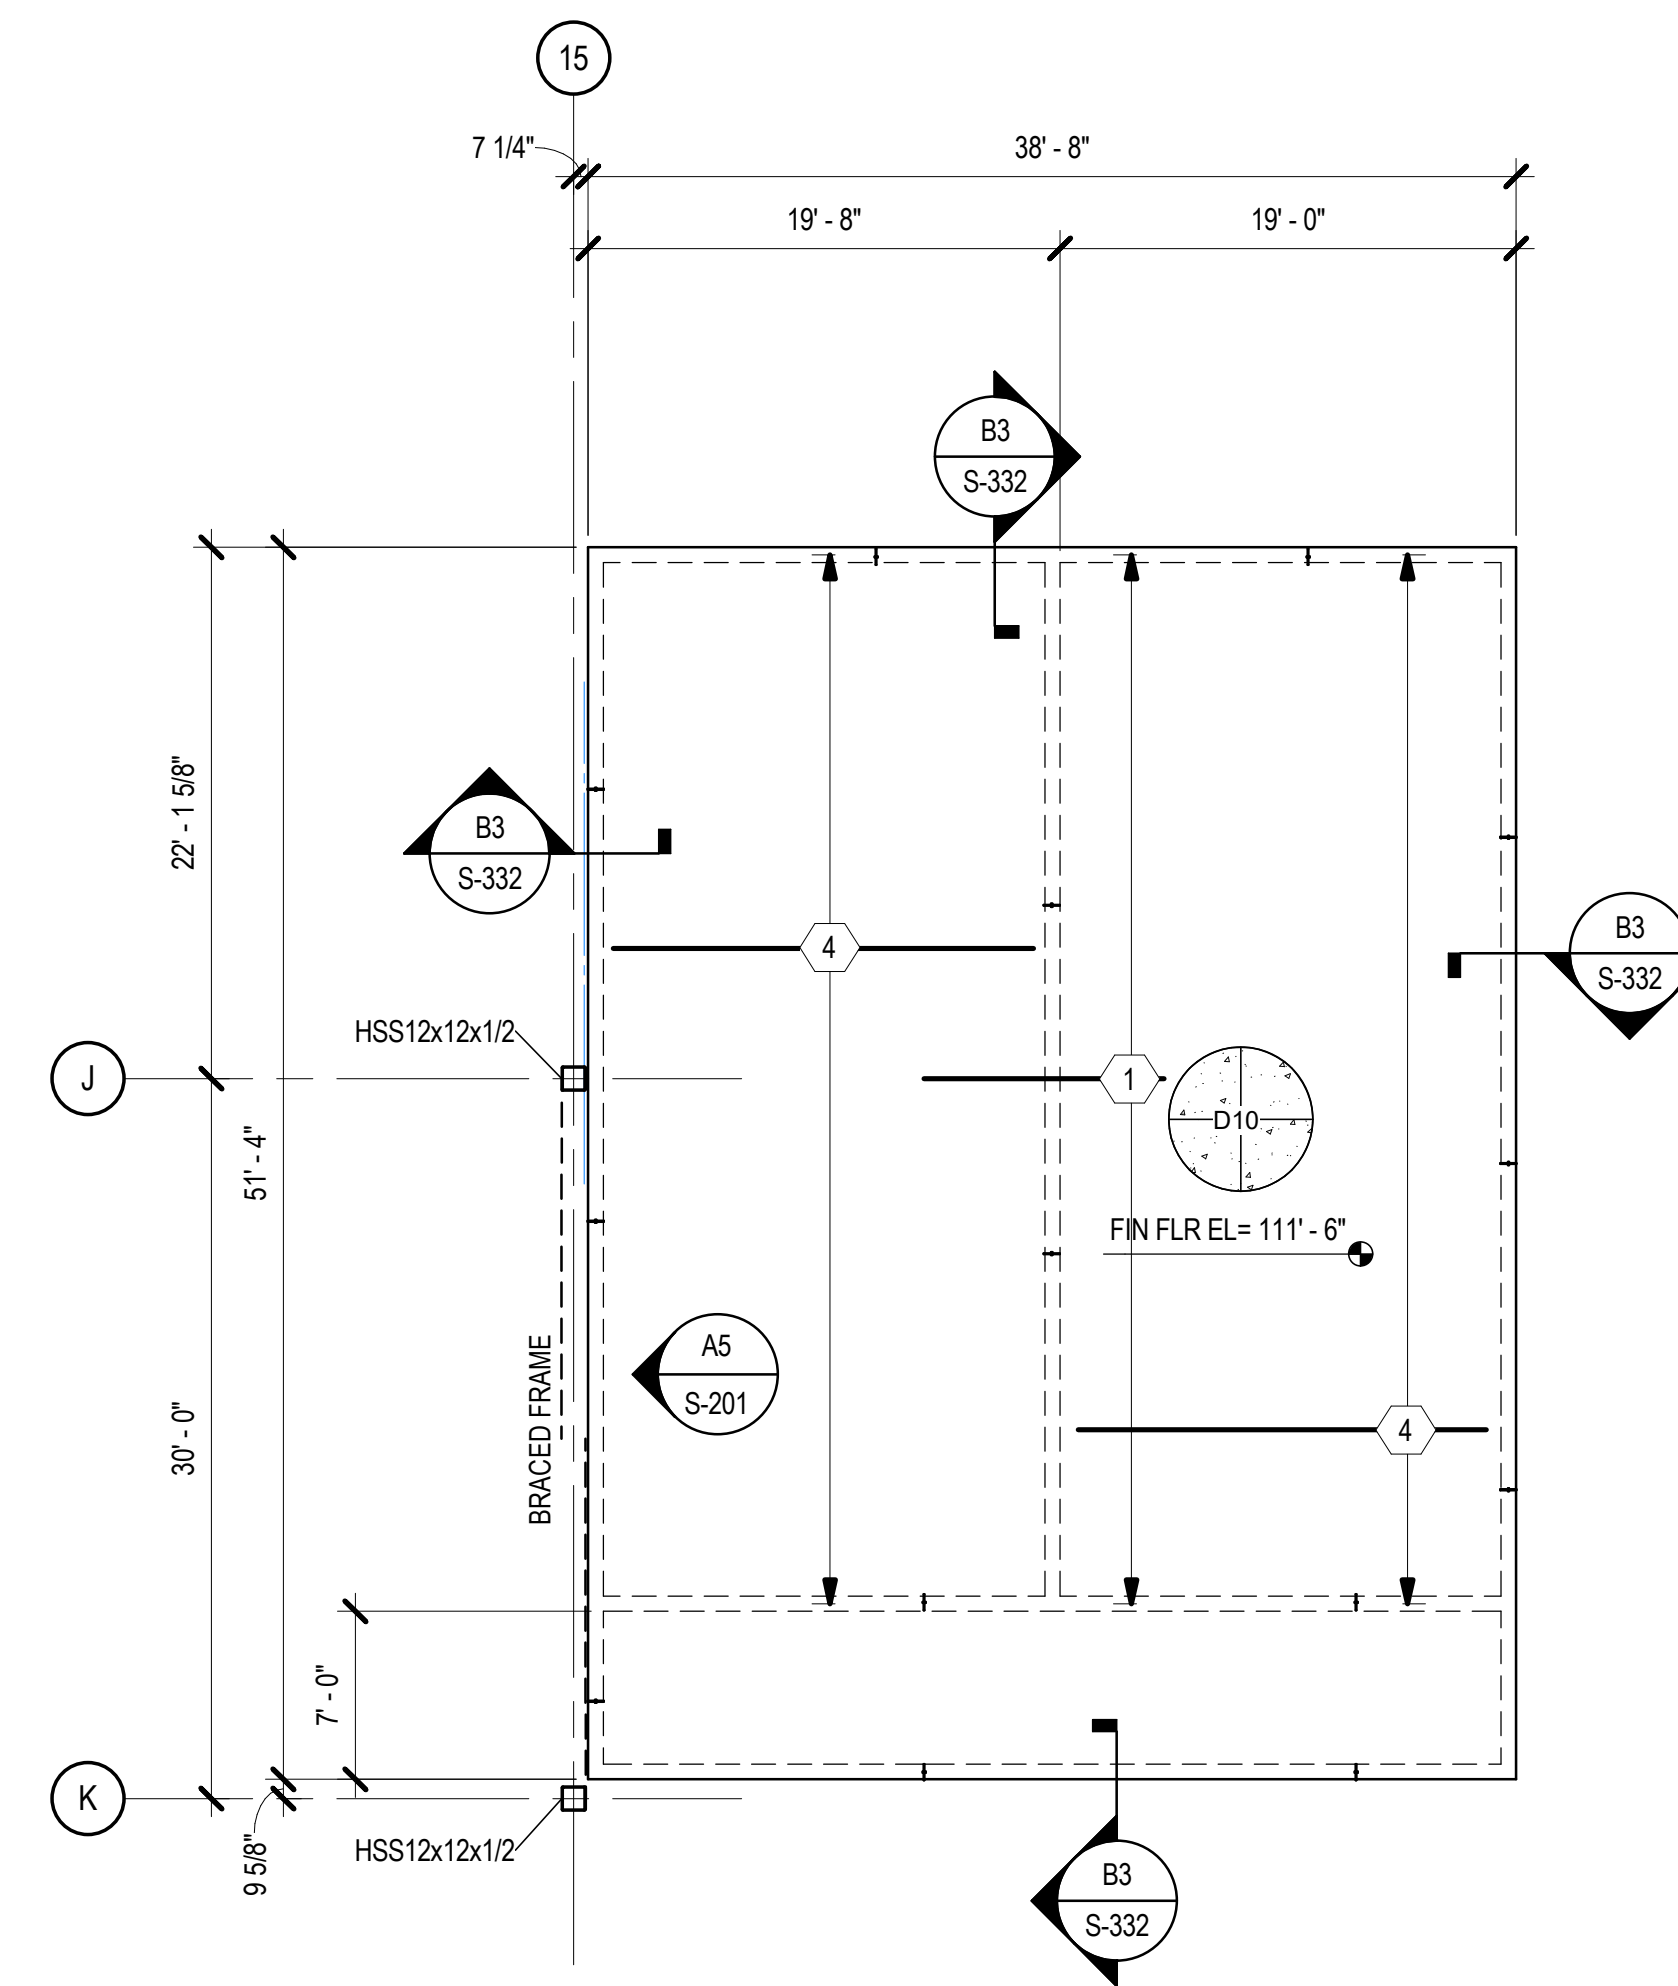


A4 EAST SAFER ROOM LID PLAN
SCALE: 1/8" = 1'-0"

CHEROKEE HARD ROCK CASINO 4



Chavez-Grieves
consulting engineers, inc.
4700 Lincoln Road NE, Suite 102, Albuquerque, NM 87109
505-344-4080 / 505-343-8759 (fax)

PROJECT: **CASINO 4**

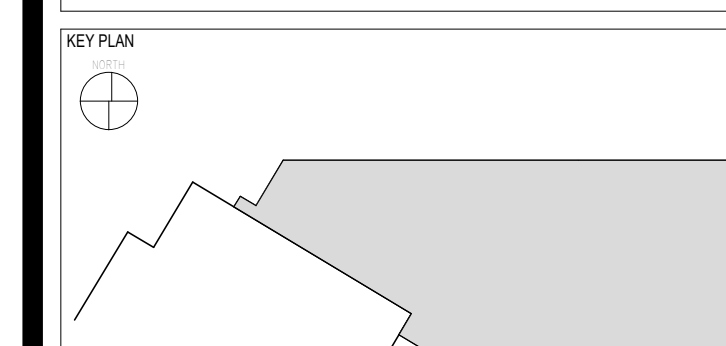


No.	Description	Date
5	BULLETIN #2	06/14/2018

SHEET TITLE: **CONCRETE SLAB PLANS**


CONSTRUCTION SET

PROJECT NO: 201704
DRAWN BY: J. ANDERSON
CHECKED BY: C. ROMERO
ISSUE DATE: 5/4/2018

S-114
Scale: As indicated

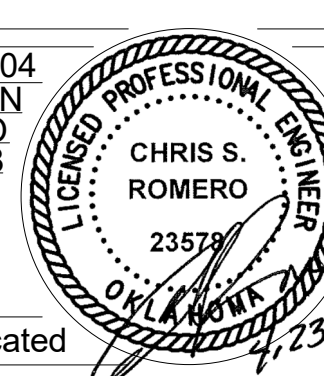

6/16/2018 7:28:43 AM

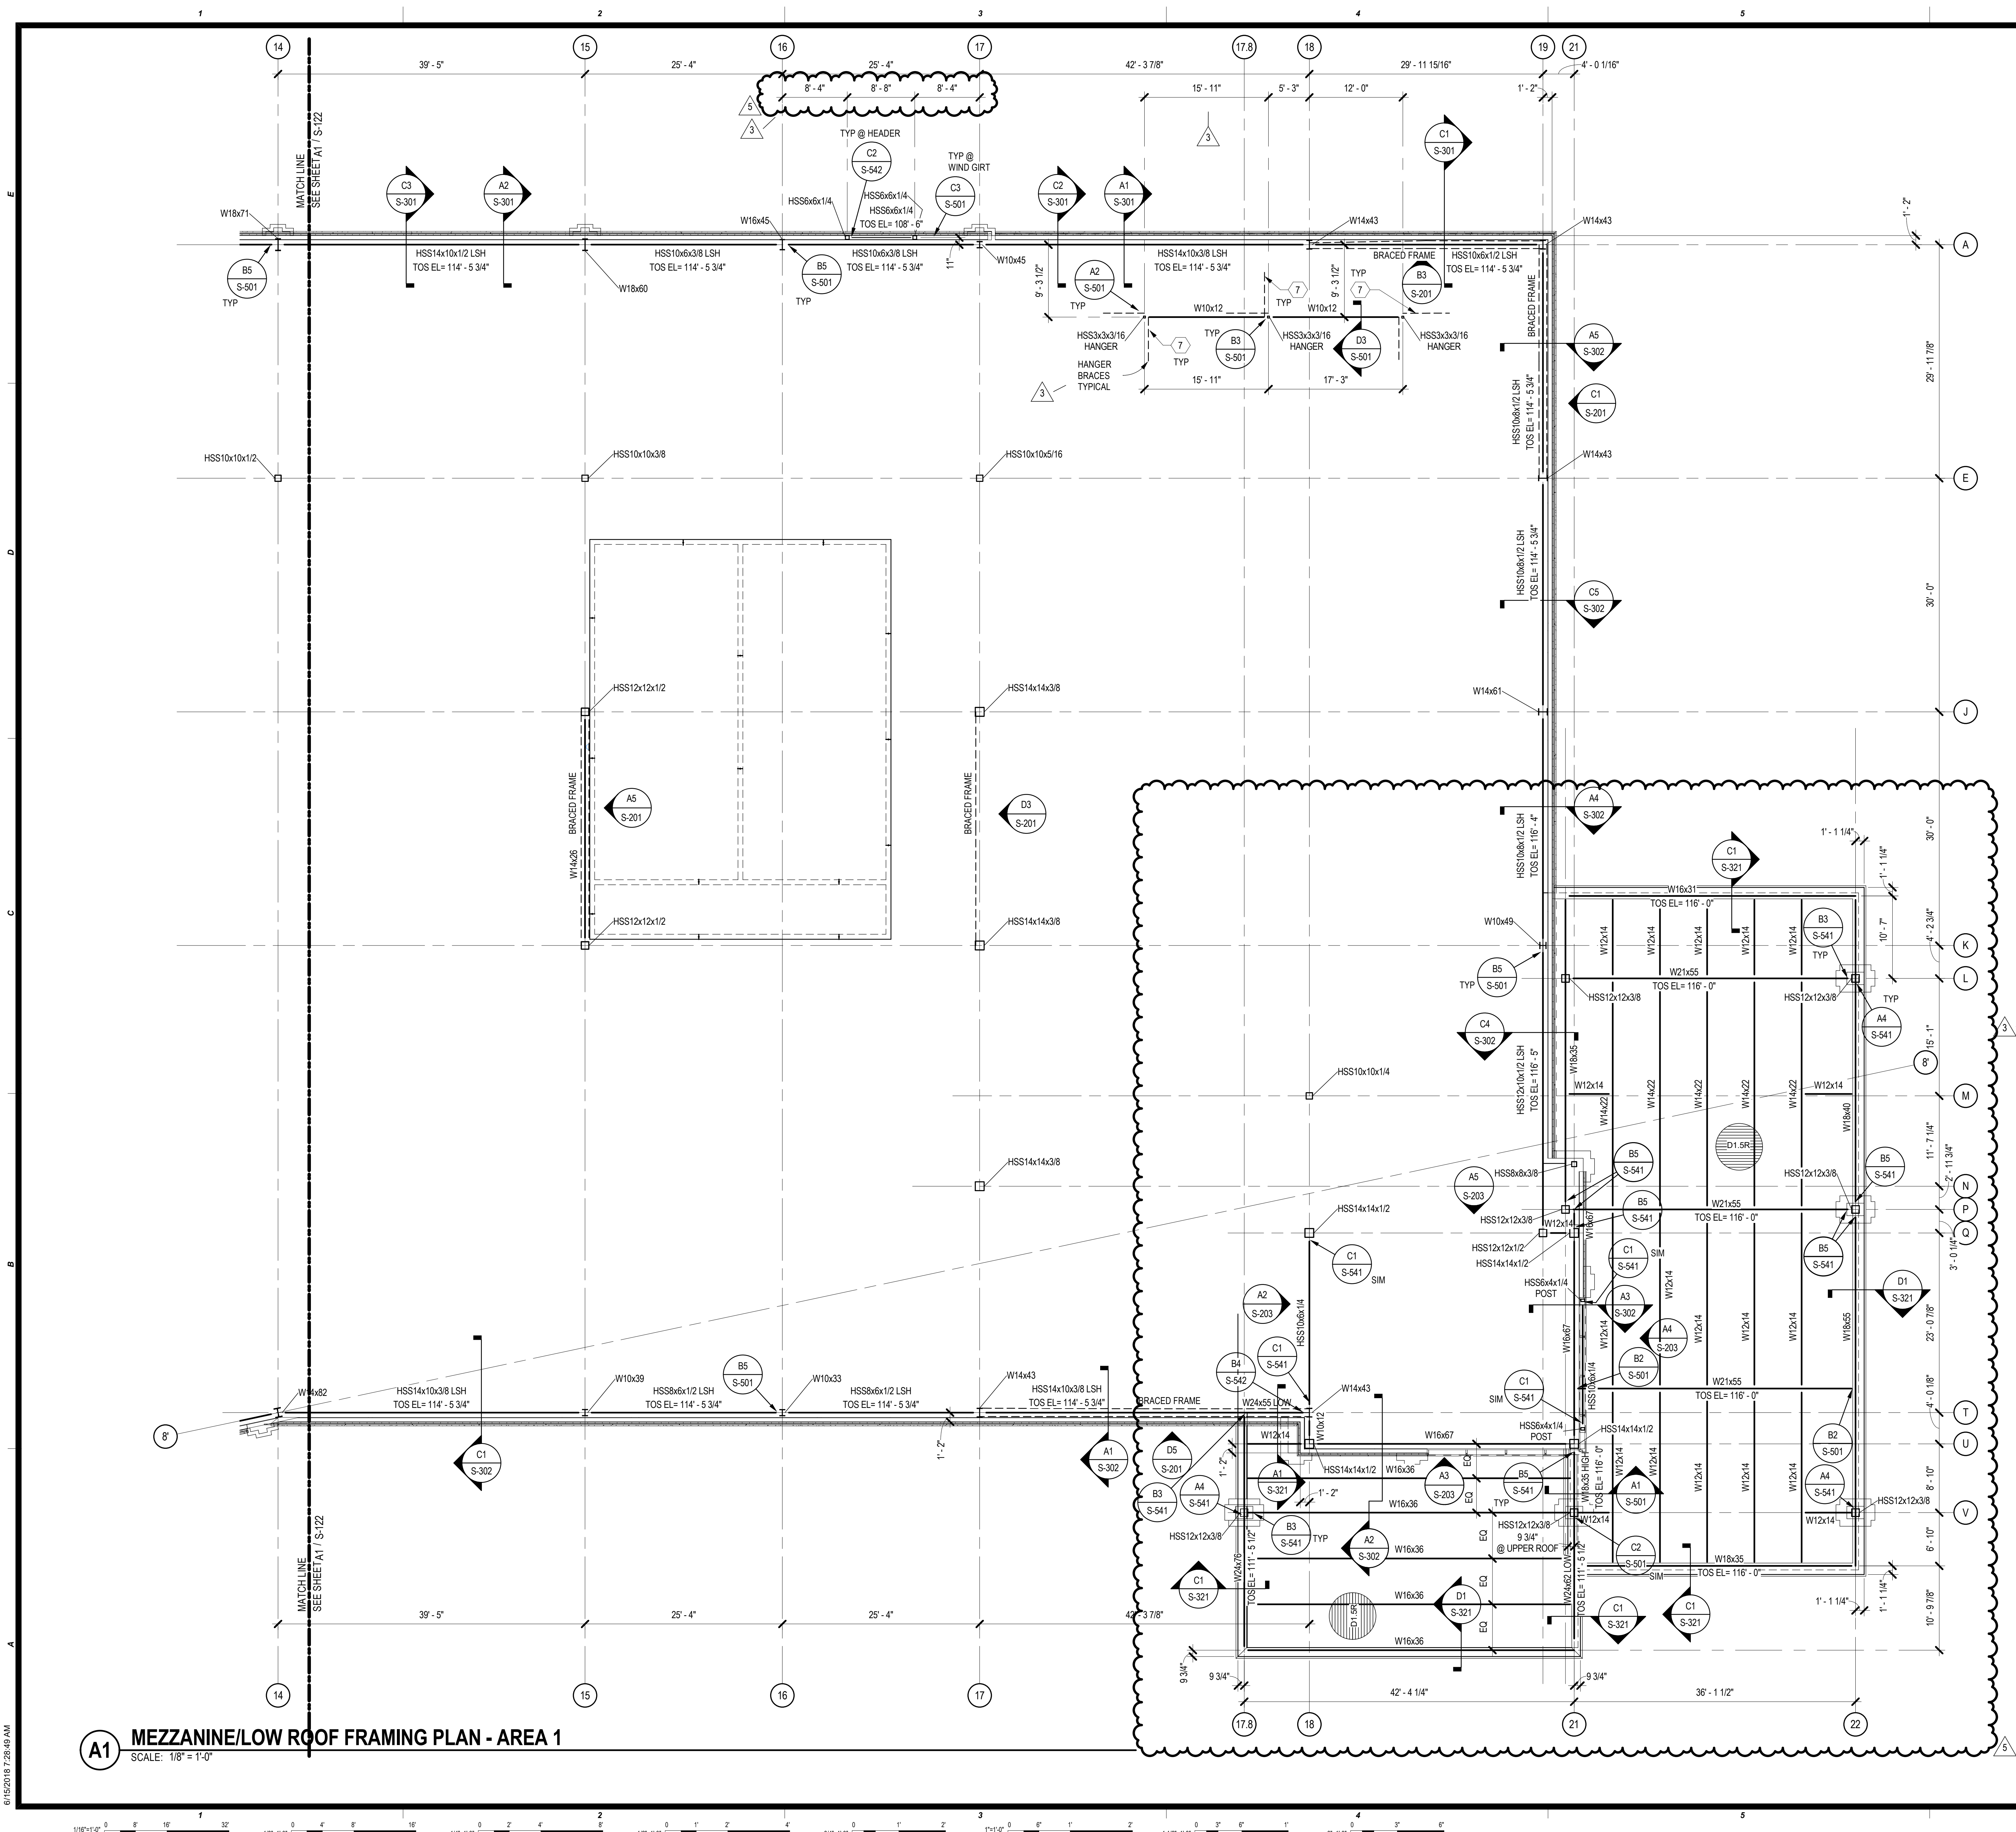

GENERAL SHEET NOTES

- SOME SHEET KEYNOTES MAY NOT APPLY TO THIS SHEET.
- NOTE TO ERECTOR: LATERAL STABILITY OF THE STEEL FRAME IS DEPENDENT UPON THE BRACED FRAMES. THE ERECTOR SHALL PROVIDE TEMPORARY BRACING OF THE STEEL FRAME IN ACCORDANCE WITH SECTION 7.10 OF THE AISC CODE OF STANDARD PRACTICES.
- DIMENSIONS ARE TO THE FACE OF STUD, OR GRID LINE, UNLESS NOTED OTHERWISE.
- SEE ARCHITECTURAL DRAWINGS FOR MASONRY DIMENSIONS NOT SHOWN.
- EXISTING CONSTRUCTION IS PER AVAILABLE EXISTING DRAWINGS. ALL EXISTING CONSTRUCTION AND DIMENSIONS SHALL BE VERIFIED PRIOR TO CONSTRUCTION. SHOULD CONDITIONS VARY FROM THOSE SHOWN, CONTACT ENGINEER BEFORE PROCEEDING.
- STRUCTURAL COLD FORMED METAL STUDS SHALL BE 6" WIDE, UNLESS NOTED OTHERWISE. STUD THICKNESS AND SPACING BY OTHERS.
- BEAMS ARE SPACED EQUALLY BETWEEN SUPPORTS AS SHOWN, UNLESS NOTED OTHERWISE.
- SEE SHEET S-321 FOR TYPICAL FLOOR FRAMING SECTIONS.
- SEE SHEET S-711 THRU S-741 FOR TYPICAL DETAILS.
- SEE SHEET S-501 THRU S-561 FOR TYPICAL FRAMING DETAILS.
- SEE SHEET S-601 AND S-602 FOR SCHEDULES.
- CONTRACTOR TO COORDINATE ALL CELLULAR DECK TRENCHES AND ACTIVATION POINT WITH ARCHITECTURAL AND ELECTRICAL DRAWINGS.

SHEET KEYNOTE

- MECHANICAL OPENING. COORDINATE EXACT SIZE AND LOCATION WITH MECHANICAL DRAWINGS. FOR TYPICAL DETAILS, SEE B2 / S-741, C2 / S-741 AND D2 / S-741
- MECHANICAL UNIT. COORDINATE EXACT SIZE AND LOCATION WITH MECHANICAL DRAWINGS.
- 3" (BETWEEN FINISHES) BUILDING EXPANSION JOINT.
- EXISTING STAIRS, COLUMNS AND FRAMING TO BE REMOVED AS REQUIRED FOR NEW CONSTRUCTION.
- PORTION OF EXISTING WALL TO BE REMOVED, SEE ARCHITECTURAL DRAWINGS FOR EXACT SIZE AND LOCATION OF OPENING.
- HSS6x6x1/4 ELEVATOR RAIL SUPPORT POST. COORDINATE EXACT LOCATION WITH ELEVATOR MANUFACTURER. SEE B2 / S-561, A2 / S-561, AND D3 / S-561
- HSS3x3x3/16 HANGER BRACE SEE DETAIL A2 / S-501

EDMUNDSON REED ASSOCIATES
 1401 S. Denver Ave., Suite B
 Tulsa, OK 74119
 Tel: (918) 884-6007
 Fax: (918) 278-1342

INTERIOR ARCHITECTURE
 CJI Architecture
 120 Haysboro Avenue
 Suite 400
 Hartford, CT 06106
 860-247-9226

STRUCTURAL ENGINEERING
 Chavez-Grievos Consulting Engineers, Inc.
 4700 Lincoln Road NE
 Suite 102
 Albuquerque, NM 87109
 505-344-4080

MEP ENGINEERING
 MSA Engineering Consultants
 370 E. Windmill Ln.
 Suite 100
 Las Vegas, NV 89123
 702-896-1100

CIVIL ENGINEERING / SURVEYING
 Native Plans Surveying and Mapping /
 RK & Associates PLC
 5807 S. Garnett Rd.
 Suite K
 Tulsa, OK 74146
 918-234-7596

LOW VOLTAGE / THEME LIGHTING
 M/E Engineering
 60 Lakeloft Boulevard
 Suite 300
 Buffalo, NY 14202
 716-845-5092

FOOD SERVICES
 Heiman Group, LLC
 7645 E. 63rd St.
 Suite 201
 Tulsa, OK 74133
 918-935-5036

CG
Chavez-Grievos
 consulting engineers, inc.
 4700 Lincoln Road NE, Suite 102, Albuquerque, NM 87109
 505-344-4080 505-343-9759 (fax)

CASINO 4

PROJECT: CASINO 4

KEY PLAN



No.	Description	Date
3	ADDENDUM #4	05/16/2018
5	BULLETIN #2	06/14/2018

MEZZANINE/LOW ROOF FRAMING PLAN - AREA 1

CONSTRUCTION SET


PROJECT NO: 201704
 DRAWN BY: J ANDERSON
 CHECKED BY: C ROMERO
 ISSUE DATE: 5/4/2018

S-121
 Scale: As indicated

PROFESSOR OF ENGINEERING
 CHRIS S. ROMERO
 23578

CHEROKEE HARD ROCK CASINO 4

A1 MEZZANINE/LOW ROOF FRAMING PLAN - AREA 1
 SCALE: 1/8" = 1'-0"

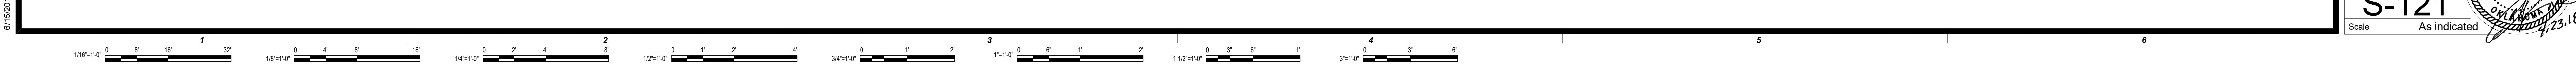


GENERAL SHEET NOTES

- SOME SHEET KEYNOTES MAY NOT APPLY TO THIS SHEET.
- NOTE TO ERECTOR: LATERAL STABILITY OF THE STEEL FRAME IS DEPENDENT UPON THE BRACED FRAMES. THE ERECTOR SHALL PROVIDE TEMPORARY BRACING OF THE STEEL FRAME IN ACCORDANCE WITH SECTION 7.10 OF THE AISC CODE OF STANDARD PRACTICES.
- DIMENSIONS ARE TO THE FACE OF STUD, UNLESS NOTED OTHERWISE.
- SEE ARCHITECTURAL DRAWINGS FOR MASONRY DIMENSIONS NOT SHOWN.
- EXISTING CONSTRUCTION IS PER AVAILABLE EXISTING DRAWINGS. ALL EXISTING CONSTRUCTION AND DIMENSIONS SHALL BE VERIFIED PRIOR TO CONSTRUCTION. SHOULD CONDITIONS VARY FROM THOSE SHOWN, CONTACT ENGINEER BEFORE PROCEEDING.
- JOISTS ARE SPACED EQUALLY BETWEEN SUPPORTS, AS SHOWN ON PLAN, UNLESS NOTED OTHERWISE.
- PROVIDE JOIST BRIDGING PER THE 42ND EDITION OF THE SJI SPECIFICATIONS AND OSHA REQUIREMENTS.
- STEEL JOIST MANUFACTURER SHALL DESIGN ROOF JOISTS AND ROOF JOIST GIRDERS SUPPORTING MECHANICAL UNITS FOR 12x MECHANICAL UNIT WEIGHTS SHOWN. USE 48 PSF DEAD LOAD AND 25 PSF LIVE LOAD UNLESS NOTED OTHERWISE. CONTRACTOR SHALL VERIFY ACTUAL MECHANICAL LOADS. NOTIFY STEEL JOIST MANUFACTURER OF ANY DISCREPANCIES.
- CONTRACTOR SHALL COORDINATE ALL STEEL JOIST SEAT DEPTHS WITH STEEL JOIST FABRICATOR. ALL BEARING ELEVATIONS SHOWN ON PLANS, ARE TO TOP OF JOISTS (DECK BEARING) AND DO NOT INCORPORATE THE DEPTH OF THE JOIST SEATS.
- STRUCTURAL COLD FORMED METAL STUDS SHALL BE 6" WIDE, UNLESS NOTED OTHERWISE. STUD THICKNESS AND SPACING BY OTHERS.
- SEE SHEET S-331 FOR TYPICAL ROOF FRAMING SECTIONS.
- SEE SHEET S-711 THRU S-741 FOR TYPICAL DETAILS.
- SEE SHEET S-501 THRU S-561 FOR FRAMING DETAILS.
- SEE SHEET S-601 FOR SCHEDULES.

SHEET KEYNOTE

- MECHANICAL OPENING. COORDINATE EXACT SIZE AND LOCATION WITH MECHANICAL DRAWINGS. FOR TYPICAL FRAMING, SEE B1 / S-741 AND A1 / S-741
- MECHANICAL UNIT. COORDINATE EXACT SIZE AND LOCATION WITH MECHANICAL DRAWINGS.
- NOT USED.
- FUTURE OPERABLE PARTITION BELOW.
- HYDRONIC PIPING - SEE MECHANICAL AND PLUMBING DRAWINGS FOR MORE INFORMATION. STRUCTURE HAS BEEN DESIGNED TO SUPPORT HYDRONIC PIPING ONLY IN THE LOCATIONS SHOWN. HYDRONIC PIPES SHALL NOT BE LOCATED ELSEWHERE UNLESS APPROVED BY THE STRUCTURAL ENGINEER OF RECORD. JOIST MANUFACTURER TO DESIGN FOR 12x THE LOAD INDICATED ON PLAN (UNFACTORED DEAD LOAD). IN ADDITION TO TABULATED CAPACITY LOADS BASED ON THE JOIST SIZE AND SPAN. LOADS SHOWN ON PLAN IS THE TOTAL WEIGHT OF THE PIPE GROUP. WHERE NO LOAD IS SHOWN, THE LOAD IS ACCOUNTED FOR IN THE ROOF DEAD LOAD. UNLESS NOTED OTHERWISE WITH THE JOIST MANUFACTURER, CONTRACTOR SHALL ATTACH PIPES TO EACH ROOF JOIST PERPENDICULAR TO PIPES, AND TO JOISTS PARALLEL TO THE PIPES AT 7'-6" ON CENTER.
- 3" (BETWEEN FINISHES) BUILDING EXPANSION JOINT.
- C8x11.5 UNDER MECHANICAL UNIT. COORDINATE EXACT SIZE AND LOCATION WITH MECHANICAL DRAWINGS.
- HSS6x1/2 MEDIA MESH SCREEN SUPPORT. COORDINATE EXACT LOCATION AND COUNT OF POSTS WITH SCREEN MANUFACTURER'S REQUIREMENTS. FINAL DESIGN TO BE COORDINATED WITH FINAL SCREEN CUT SHEETS.
- PORTION OF EXISTING WALL TO BE REMOVED. SEE ARCHITECTURAL DRAWINGS FOR EXACT SIZE AND LOCATION OF OPENING.
- HSS6x1/4 ELEVATOR RAIL SUPPORT POST. COORDINATE EXACT LOCATION WITH ELEVATOR MANUFACTURER. SEE C2 / S-561
- HSS5xJOIST SEAT DEPTHx1/4" BLOCKING BETWEEN JOIST SEATS. SEE A2 / S-741
- BEAM SPLICE. SEE D1 / S-542
- HSS3x3/16 HANGER BRACE DETAIL. SEE A2 / S-501
- ANGLE KICKER. SEE B1 / S-541 SIM

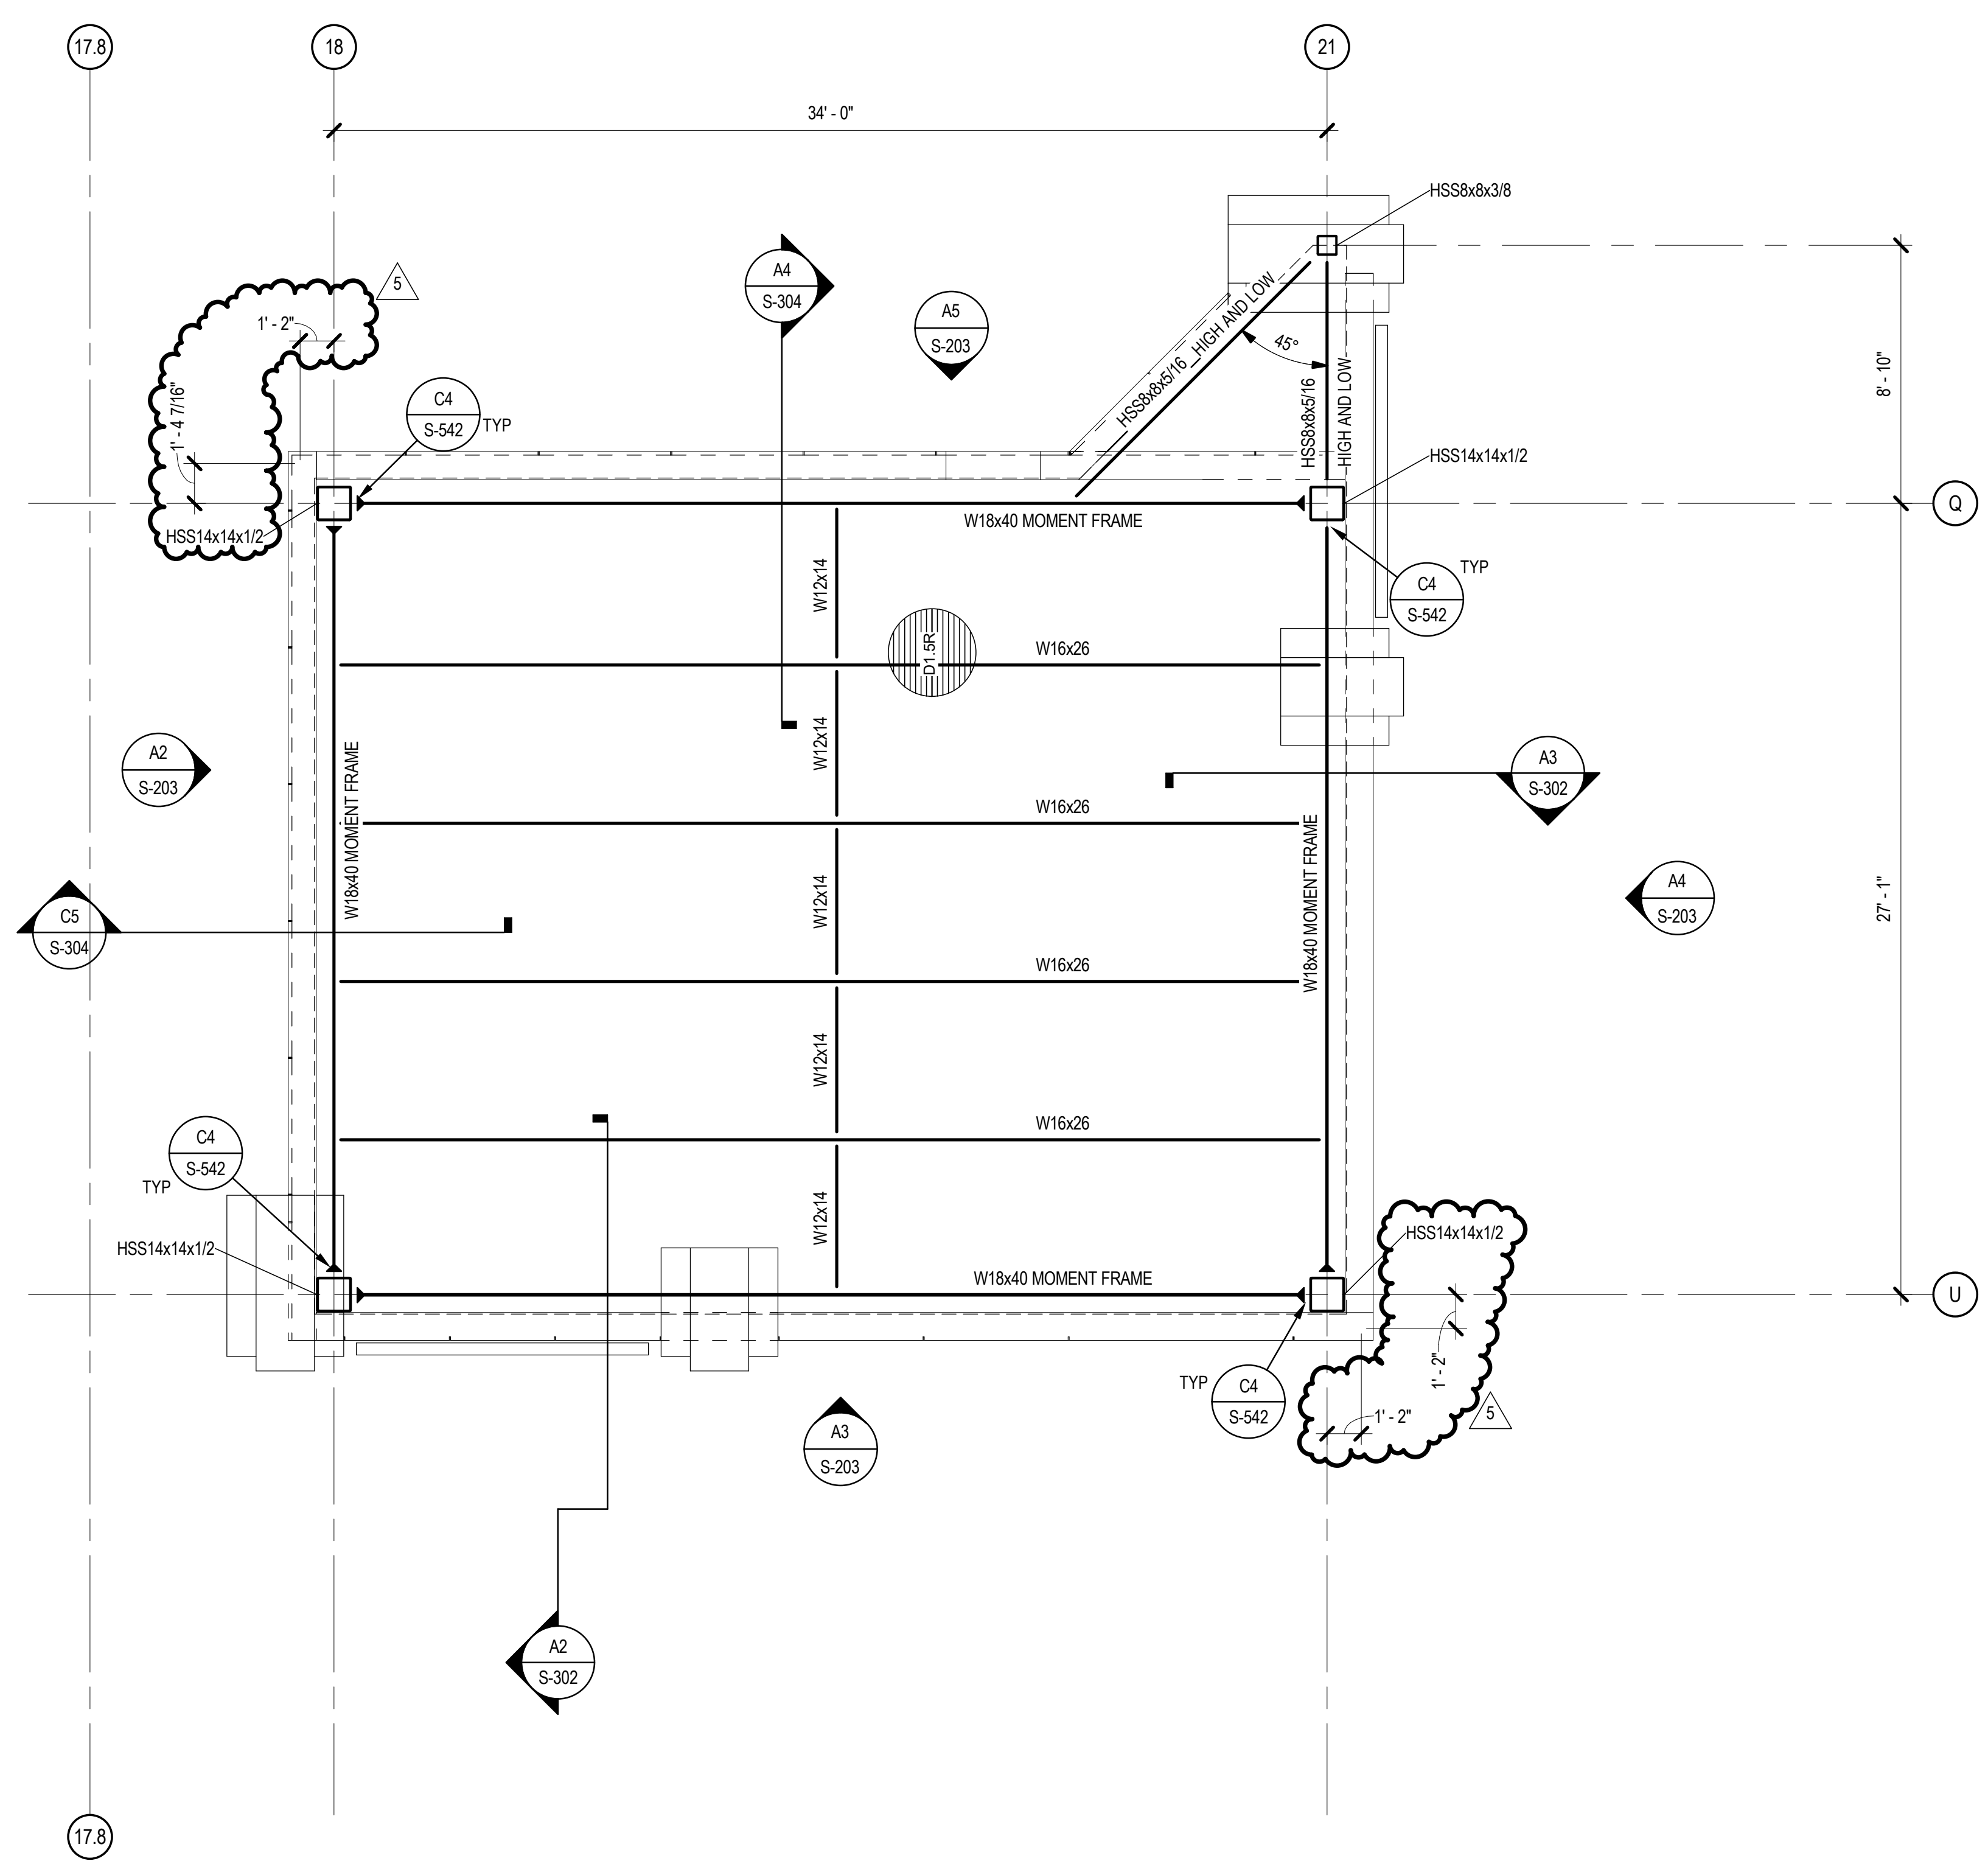

A2 TOWER ROOF FRAMING PLAN - AREA 1
SCALE: 1/4" = 1'-0"



This document, and the ideas and designs incorporated herein, as an instrument of professional service, is the property of EDWARDS REED ASSOCIATES, and is not to be used, in whole or in part, for any other project, without the written authorization of EDWARDS REED ASSOCIATES.

INTERIOR ARCHITECTURE
CJ Architecture
120 Hayslope Avenue
Suite 400
Hartford, CT 06106
860-247-9226

STRUCTURAL ENGINEERING
Chavez-Grievos Consulting Engineers, Inc.
4700 Lincoln Road NE
Suite 102
Albuquerque, NM 87109
505-344-4080

MEP ENGINEERING
MSA Engineering Consultants
370 E. Windmill Ln.
Suite 100
Las Vegas, NV 89123
702-896-1100

CIVIL ENGINEERING / SURVEYING
Native Plans Surveying and Mapping / RK & Associates PLC
5807 S. Garnett Rd.
Suite K
Tulsa, OK 74146
918-234-7596


LOW VOLTAGE / THEME LIGHTING
M/E Engineering
60 Lakefront Boulevard
Suite 303
Buffalo, NY 14202
716-845-5092

FOOD SERVICES
Hestman Group, LLC
7645 E. 63rd St.
Suite 201
Tulsa, OK 74133
918-935-5036



Chavez-Grievos
consulting engineers, inc.
4700 Lincoln Road NE, Suite 102, Albuquerque, NM 87109
505-344-4080 505-343-8759 (fax)

CASINO 4

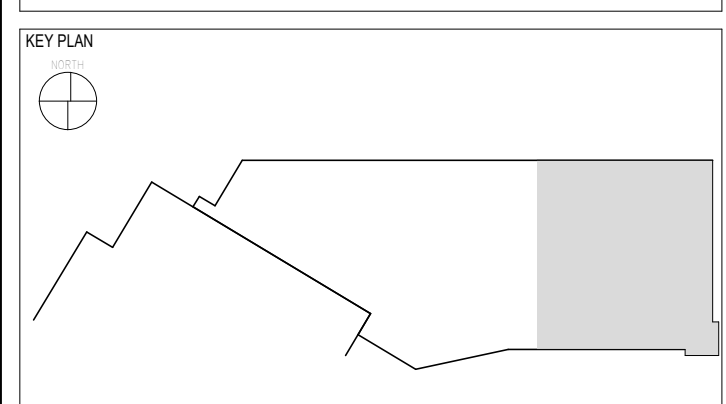


No.	Description	Date
2	ADDENDUM #2	05/04/2018
5	BULLETIN #2	06/14/2018

TOWER ROOF FRAMING PLAN - AREA 1


CONSTRUCTION SET

PROJECT NO: 201704
DRAWN BY: J ANDERSON
CHECKED BY: C ROMERO
ISSUE DATE: 5/4/2018

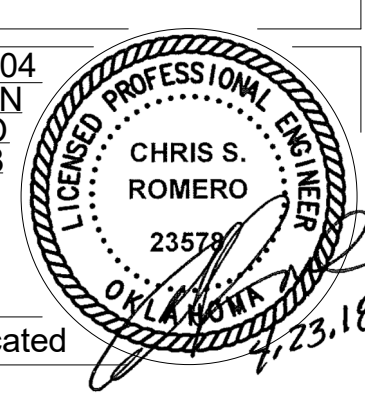

S-143
Scale: As indicated

CHEROKEE HARD ROCK CASINO 4

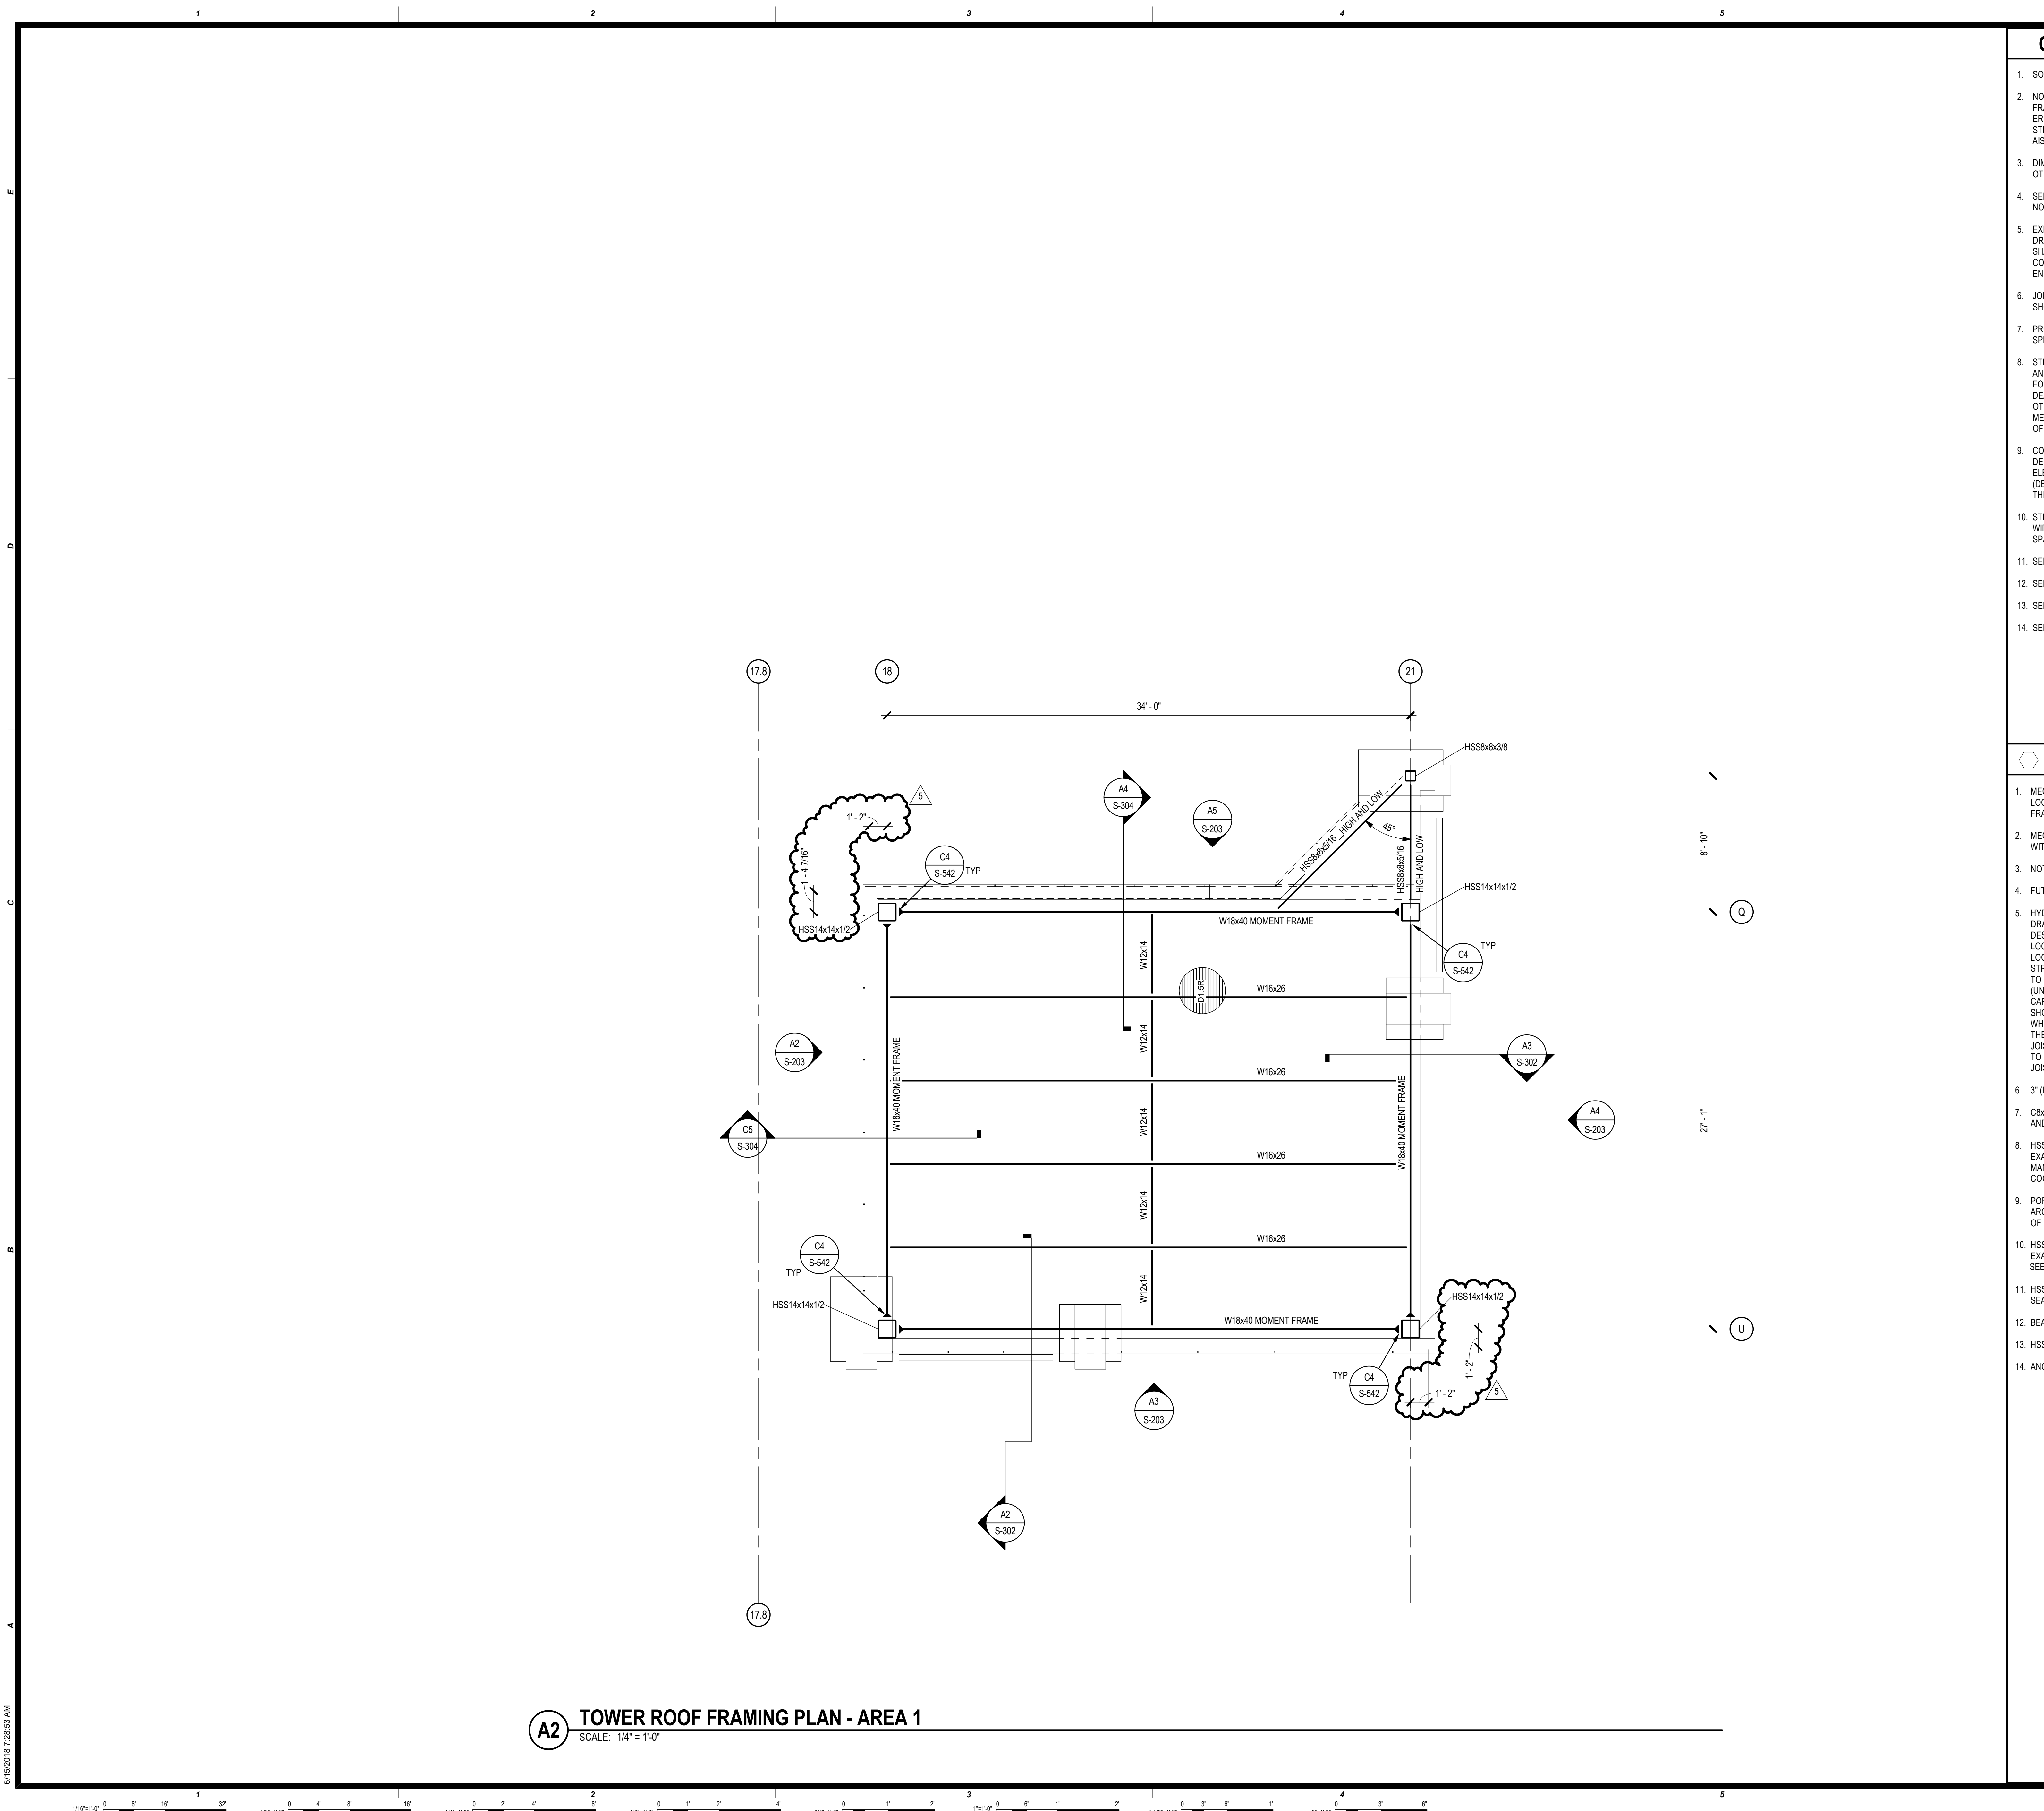

6/16/2018 7:28:53 AM

INTERIOR ARCHITECTURE

JCI Architecture
120 Hayslope Avenue
Suite 400
Hartford, CT 06106
860-247-9226

STRUCTURAL ENGINEERING

Chavez-Grievos Consulting Engineers, Inc.
4700 Lincoln Road NE
Suite 102
Albuquerque, NM 87109
505-344-4080

MEP ENGINEERING

MSA Engineering Consultants
370 E. Windmill Ln.
Suite 100
Las Vegas, NV 89123
702-896-1100

CIVIL ENGINEERING / SURVEYING

Native Plains Surveying and Mapping / RK & Associates PLC
5807 S. Garnett Rd.
Suite K
Tulsa, OK 74146
918-234-7596

LOW VOLTAGE / THEME LIGHTING

M/E Engineering
60 Lakefront Boulevard
Suite 303
Buffalo, NY 14202
716-845-5092

FOOD SERVICES

Hestman Group, LLC
7645 E. 63rd St.
Suite 201
Tulsa, OK 74133
918-935-5036




Chavez-Grievos
consulting engineers, inc.
4700 Lincoln Road NE, Suite 102, Albuquerque, NM 87109
505-344-4080 / 505-343-9799 (fax)

PROJECT

CASINO 4

KEY PLAN

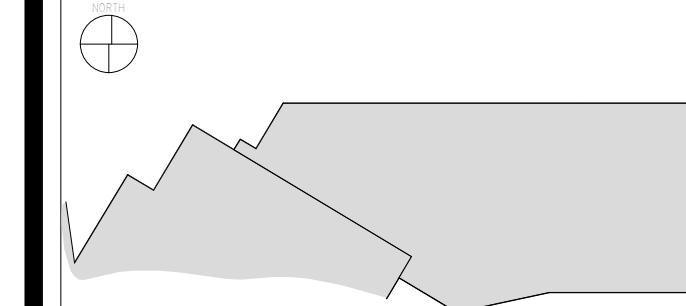


No.	Description	Date
5	BULLETIN #2	06/14/2018

THREE VIEW


WALL SECTIONS

CONSTRUCTION SET

PROJECT NO: 201704
DRAWN BY: J ANDERSON
CHECKED BY: C ROMERO
DATE: 5/4/2018

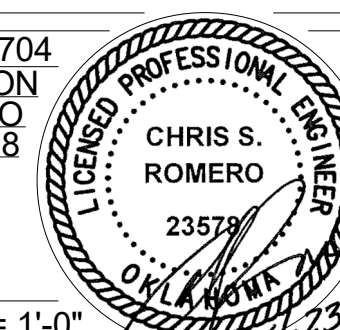

S-302
Scale: 1/4" = 1'-0"

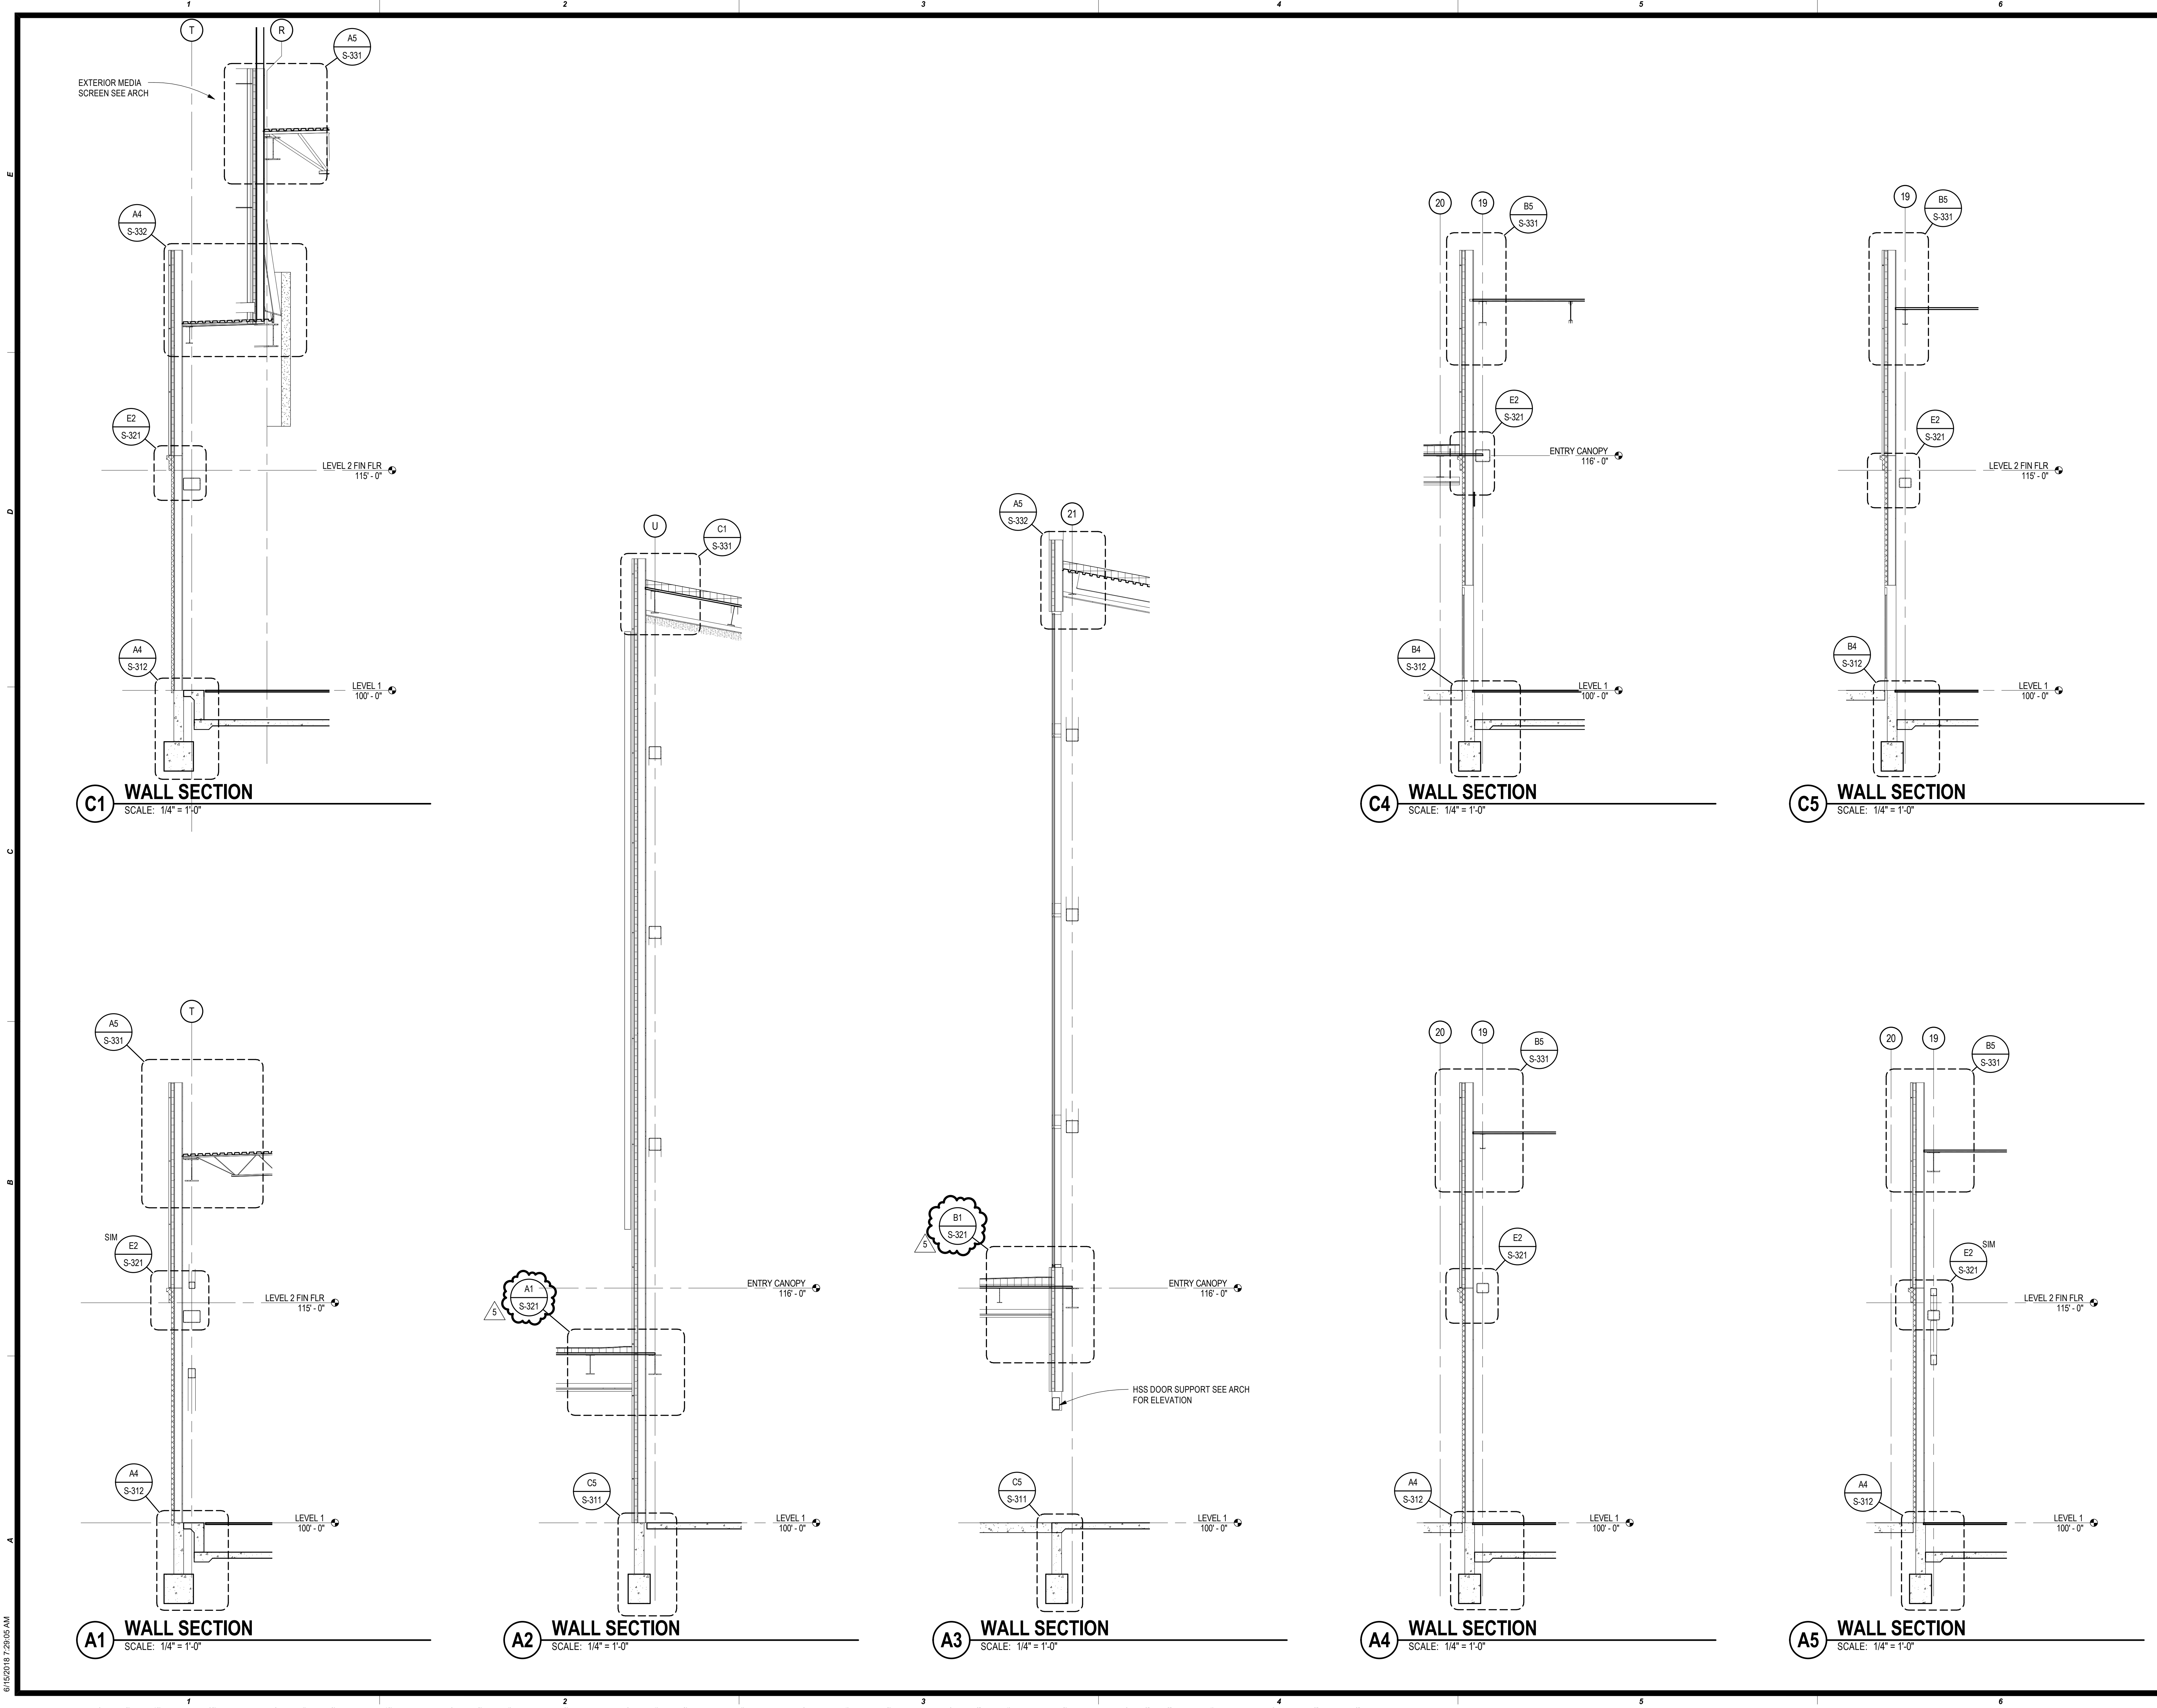

This document, and the ideas and designs incorporated herein, are an instrument of professional service, and are the property of EDMONDSON REED ASSOCIATES, and are not to be used, in whole or in part, for any other project, without the written authorization of EDMONDSON REED ASSOCIATES.

INTERIOR ARCHITECTURE

SCJ Architecture
 120 Hayshepe Avenue
 Suite 400
 Hartford, CT 06106
 860-247-9226

STRUCTURAL ENGINEERING
 Chavez-Grievos Consulting Engineers, Inc.
 4700 Lincoln Road NE
 Suite 102
 Albuquerque, NM 87109
 505-344-4080

MEP ENGINEERING
 MSA Engineering Consultants
 370 E. Windmill Ln.
 Suite 100
 Las Vegas, NV 89123
 702-896-1100

CIVIL ENGINEERING / SURVEYING
 Native Plans Surveying and Mapping /
 RK & Associates PLC
 5807 S. Garnett Rd.
 Suite K
 Tulsa, OK 74146
 918-234-7596

LOW VOLTAGE / THEME LIGHTING
 M/E Engineering
 60 Lakewood Boulevard
 Suite 303
 Buffalo, NY 14202
 716-845-5092

FOOD SERVICES
 Heintman Group, LLC
 7645 E. 63rd St.
 Suite 201
 Tulsa, OK 74133
 918-935-5036


CHEROKEE HARD ROCK CASINO 4



Chavez-Grievos
 consulting engineers, inc.
 4700 Lincoln Road NE, Suite 102, Albuquerque, NM 87109
 505-344-4080 / 505-343-9799 (fax)

CASINO 4

PROJECT

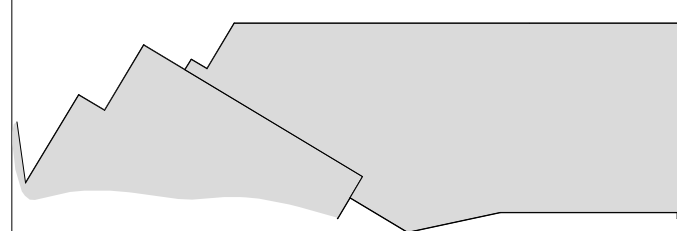


No.	Description	Date
2	ADDENDUM #2	05/04/2018
3	ADDENDUM #4	05/16/2018
5	BULLETIN #2	06/14/2018


FOUNDATION SECTIONS

CONSTRUCTION SET


PROJECT NO: 201704
 DRAWN BY: J. ANDERSON
 CHECKED BY: C. ROMERO
 ISSUE DATE: 5/4/2018

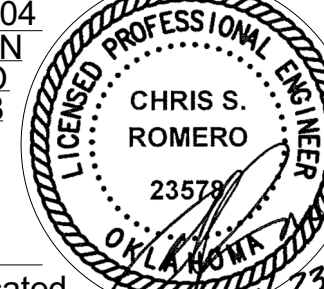


S-313
 Scale: As indicated

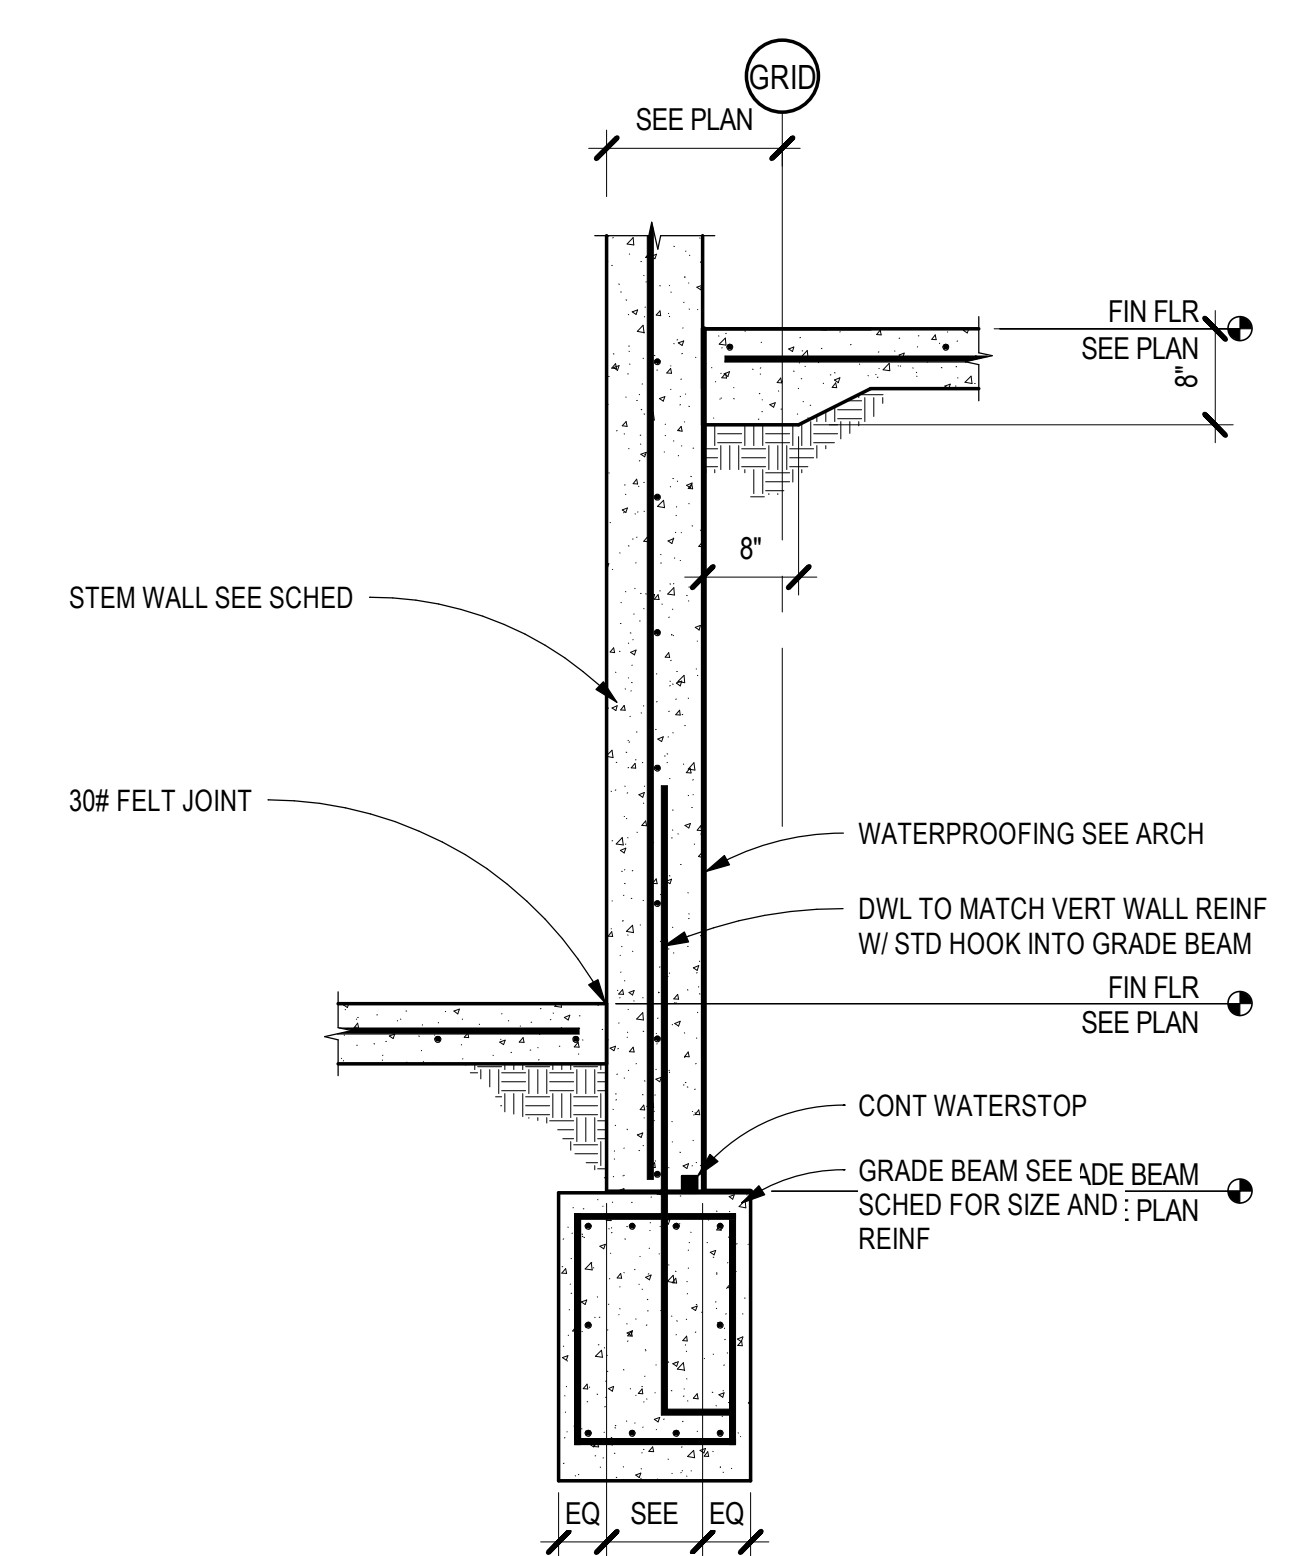


D5 BASEMENT FOUNDATION SECTION
 SCALE: 3/4" = 1'-0"

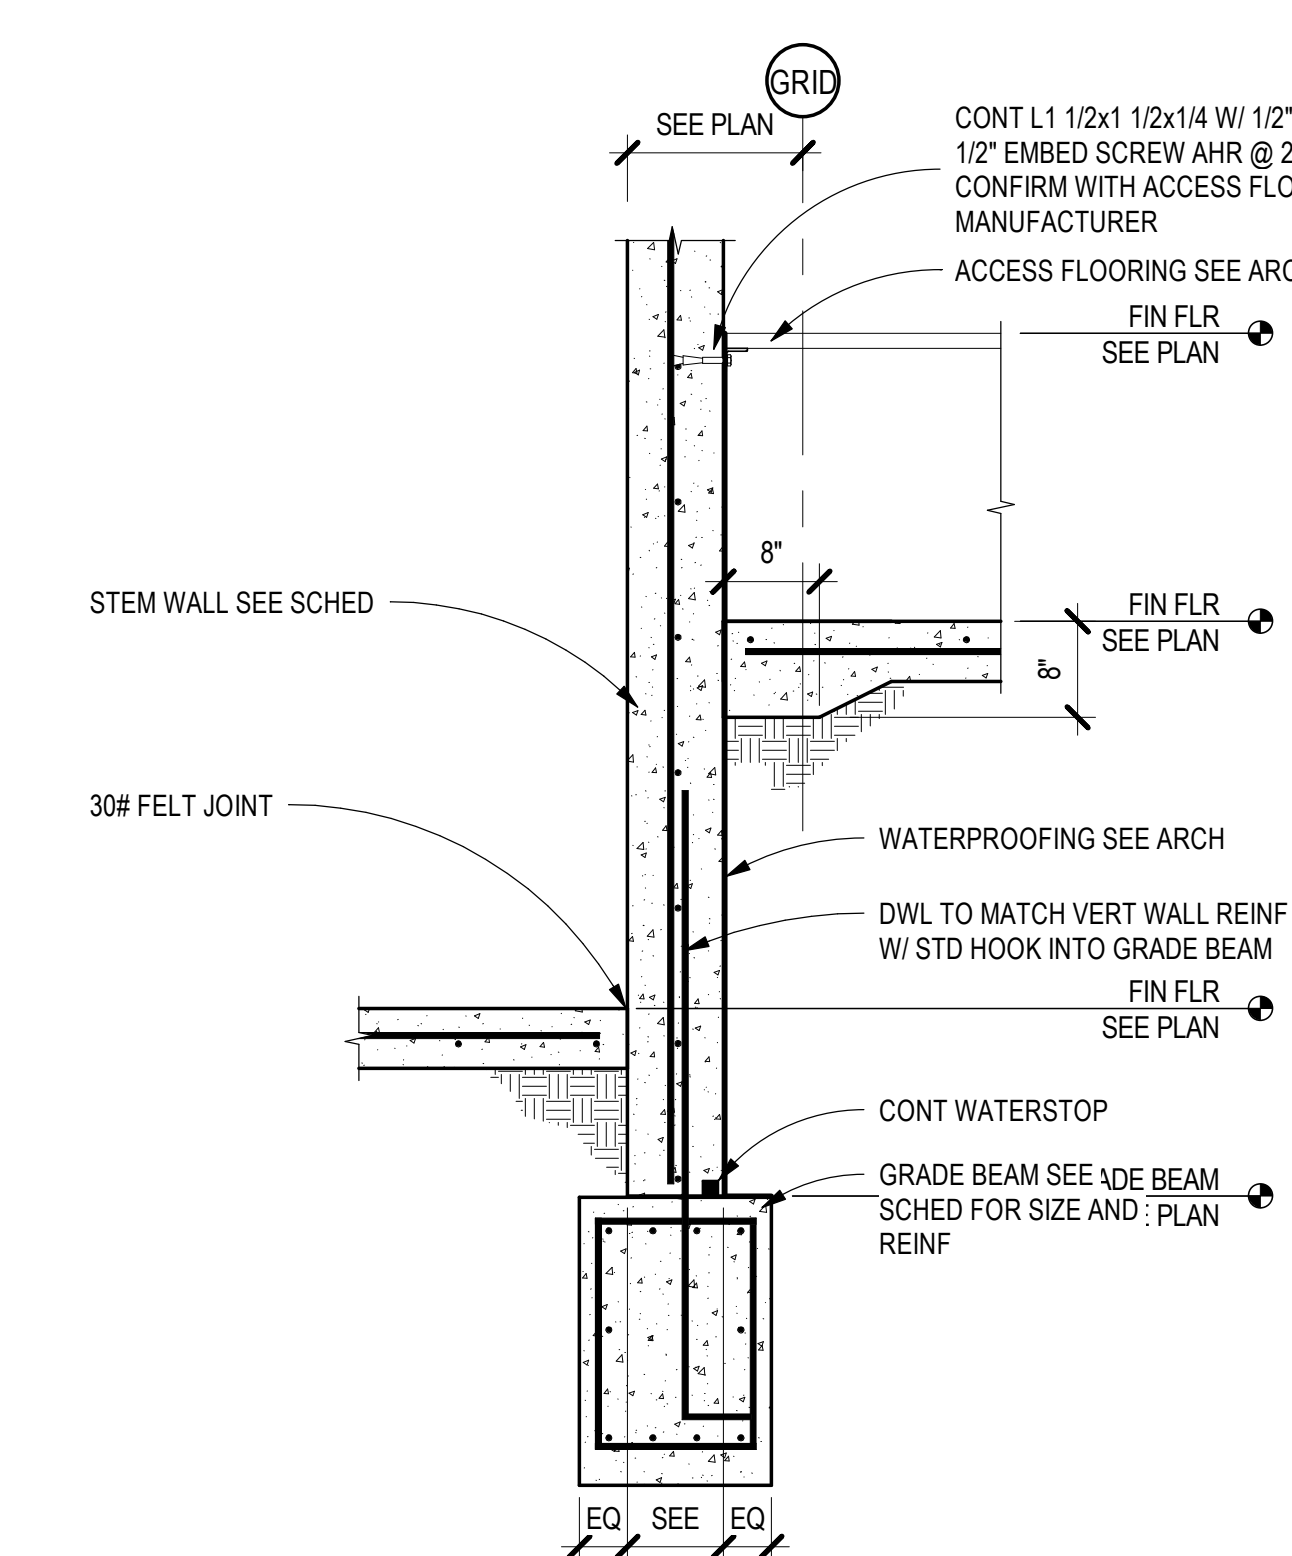


B5 BASEMENT FNDN SECT @ ACCESS FLR
 SCALE: 3/4" = 1'-0"

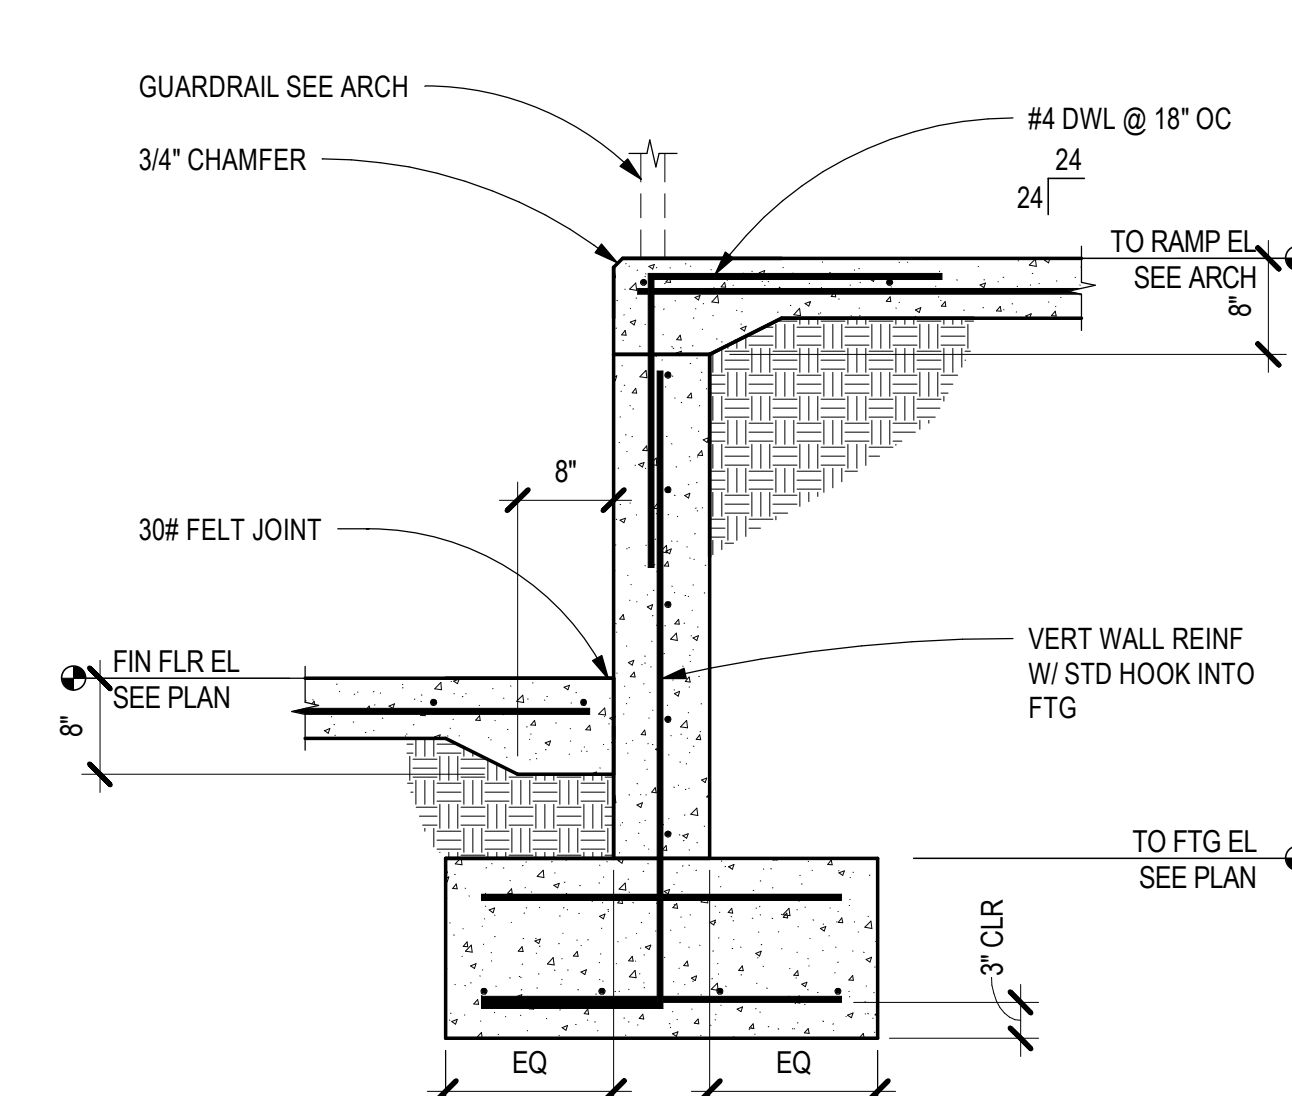


A5 EDGE OF INTERIOR RAMP SECTION
 SCALE: 3/4" = 1'-0"

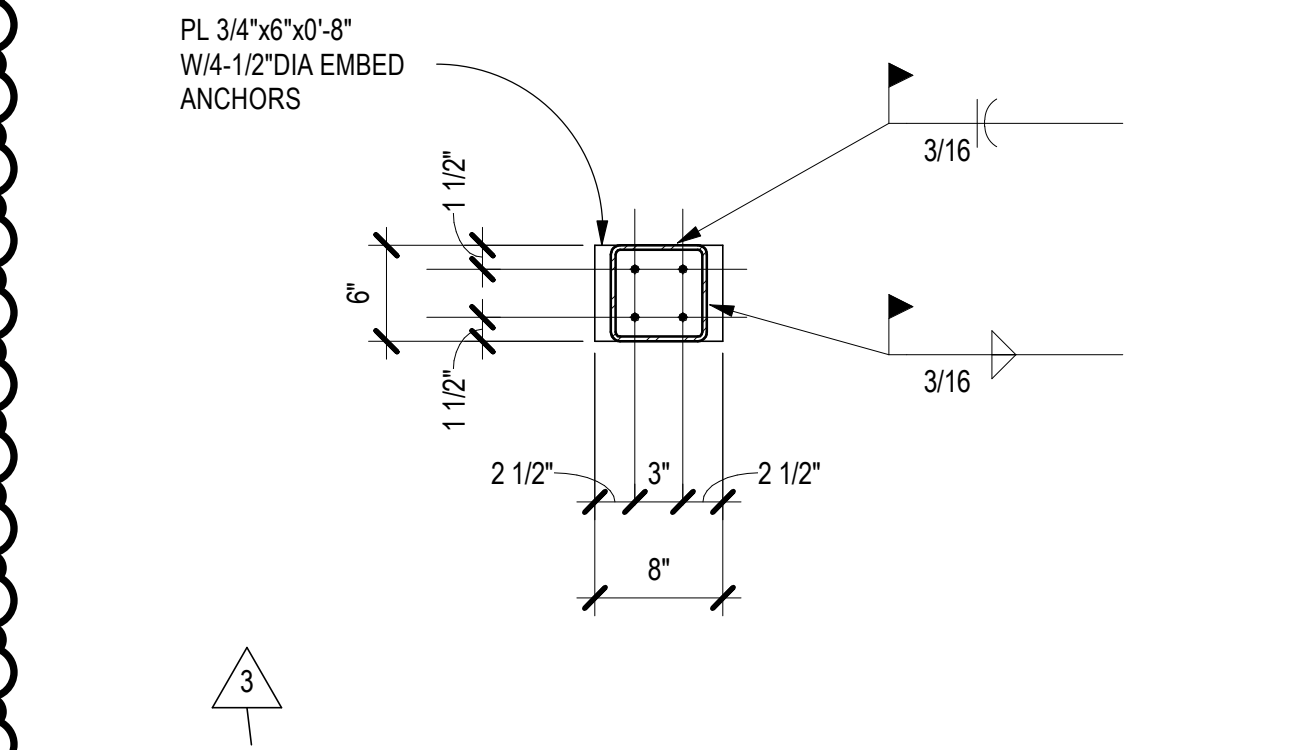


D4 POST BASE DETAIL
 SCALE: 1" = 1'-0"

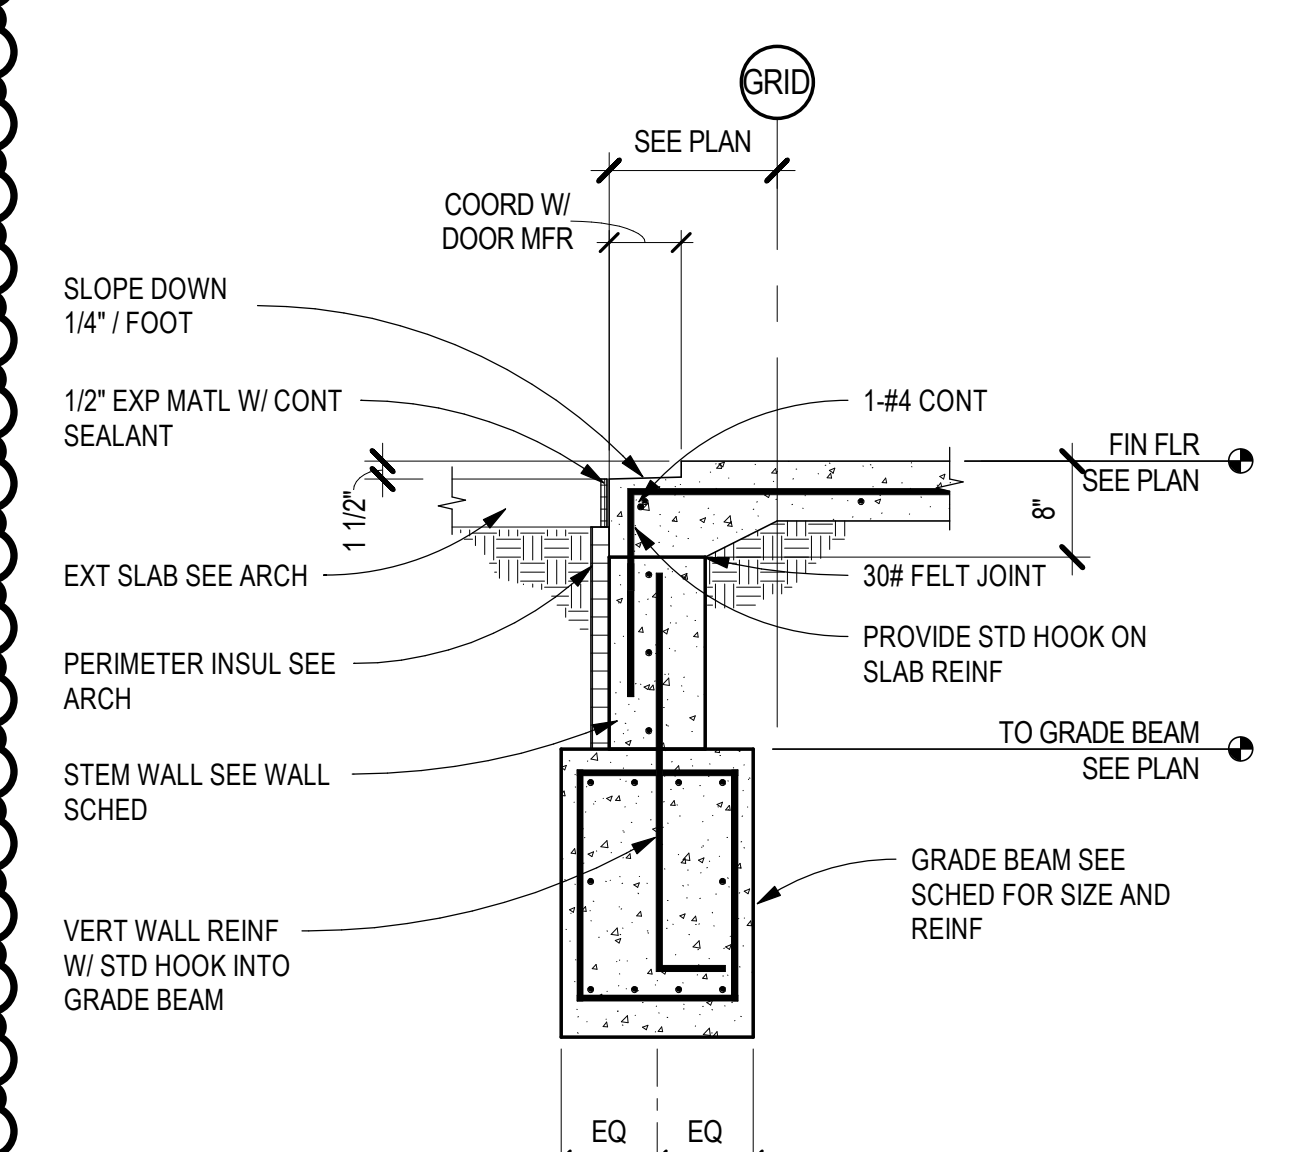


C4 PERIMETER FOUNDATION SECTION
 SCALE: 3/4" = 1'-0"

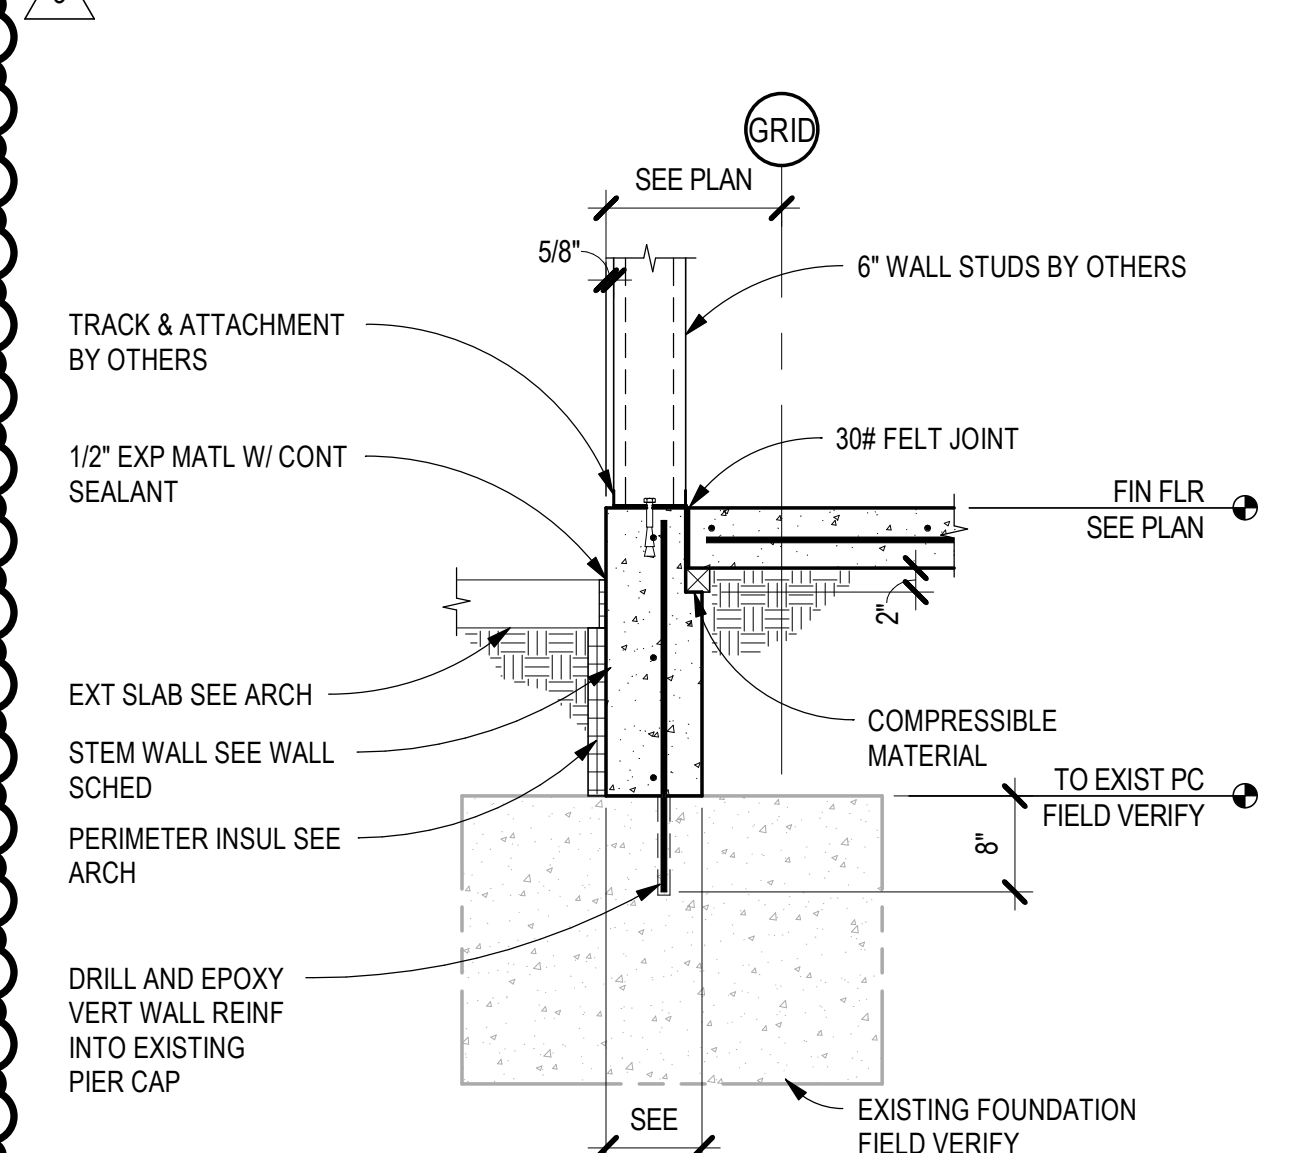


B4 PERIMETER FOUNDATION SECTION
 SCALE: 3/4" = 1'-0"

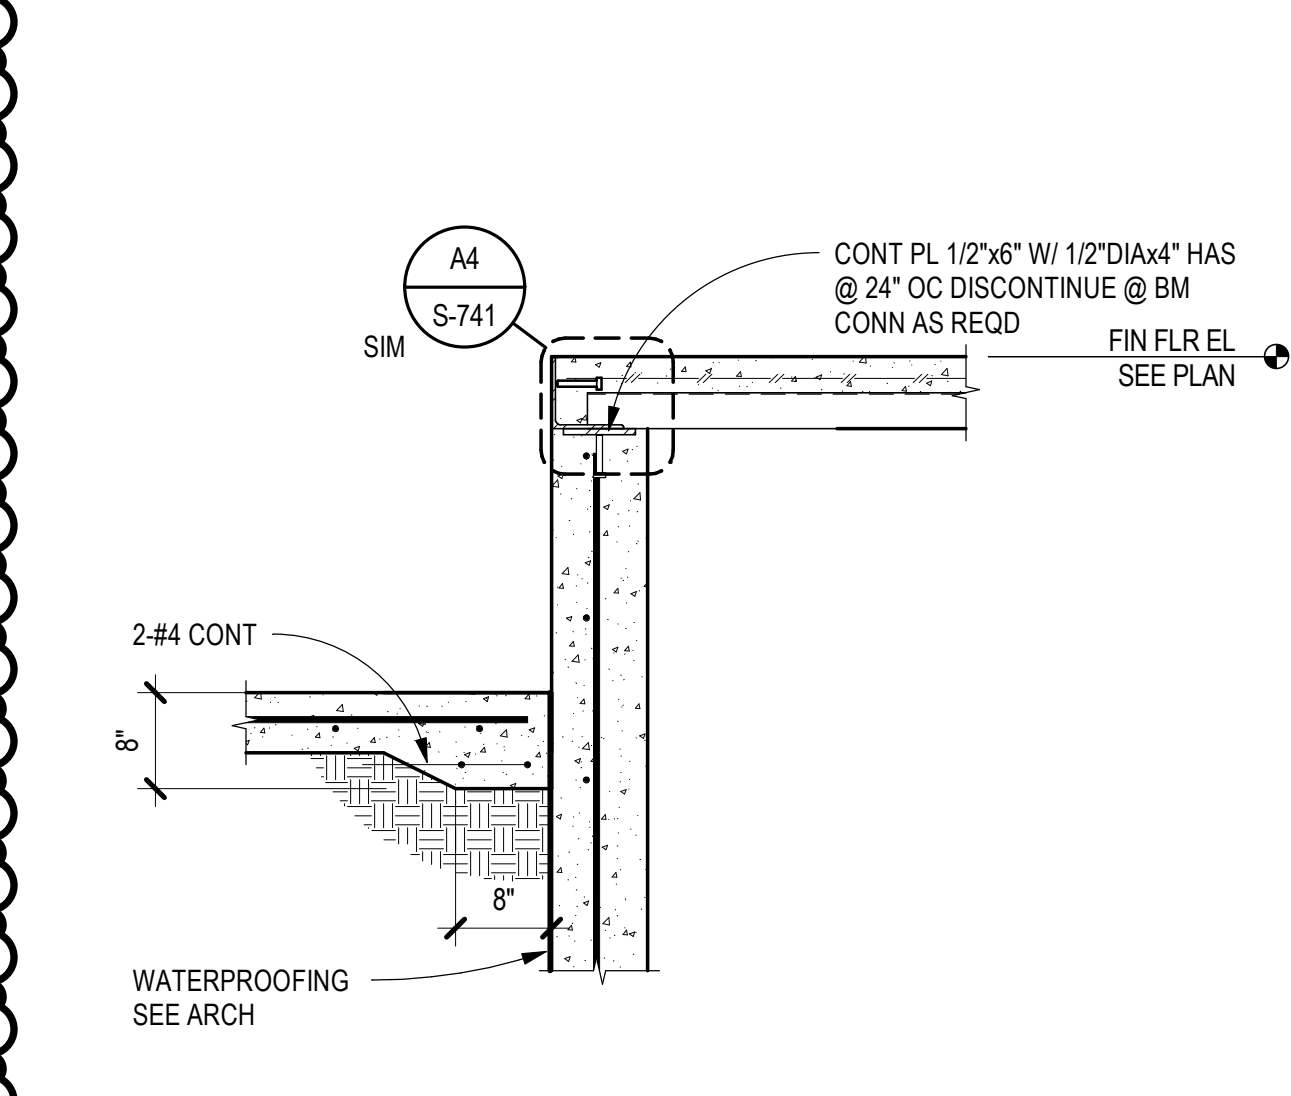


A4 FLR FRAMING DETAIL
 SCALE: 3/4" = 1'-0"

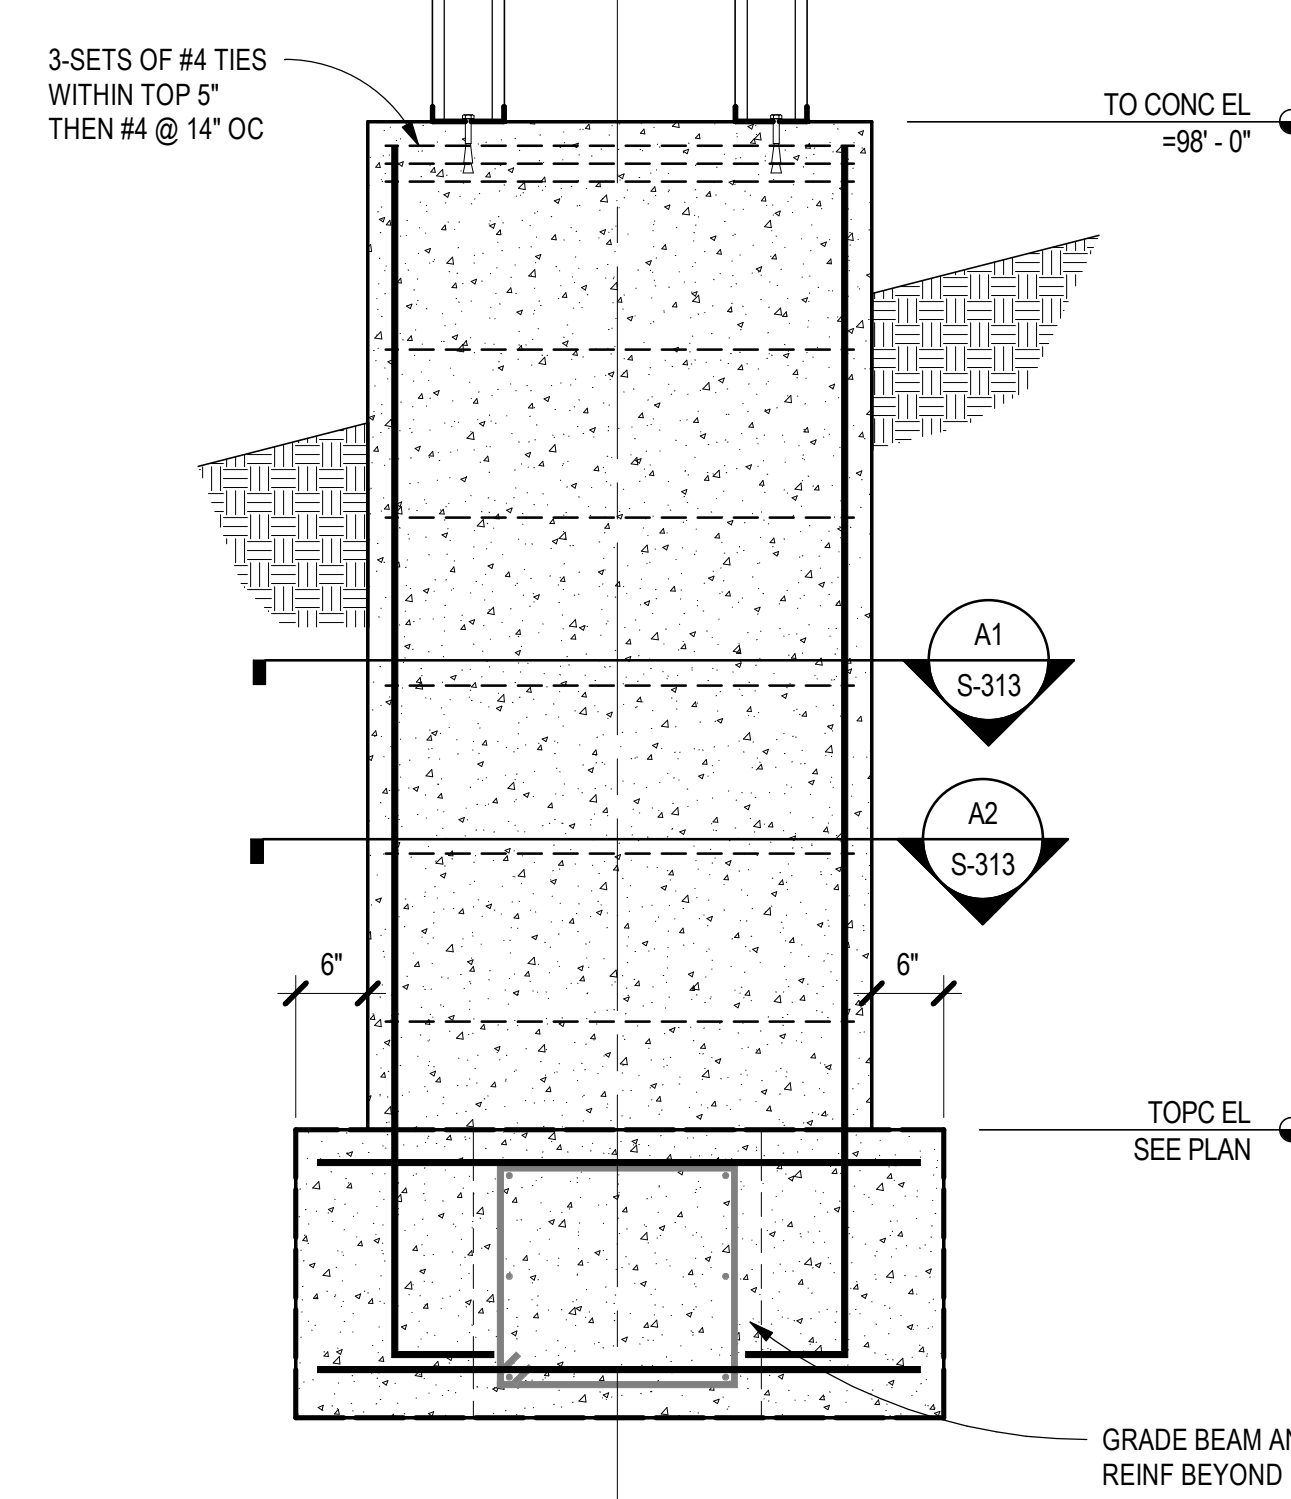


C3 COL WRAP FOUNDATION SECTION
 SCALE: 3/4" = 1'-0"

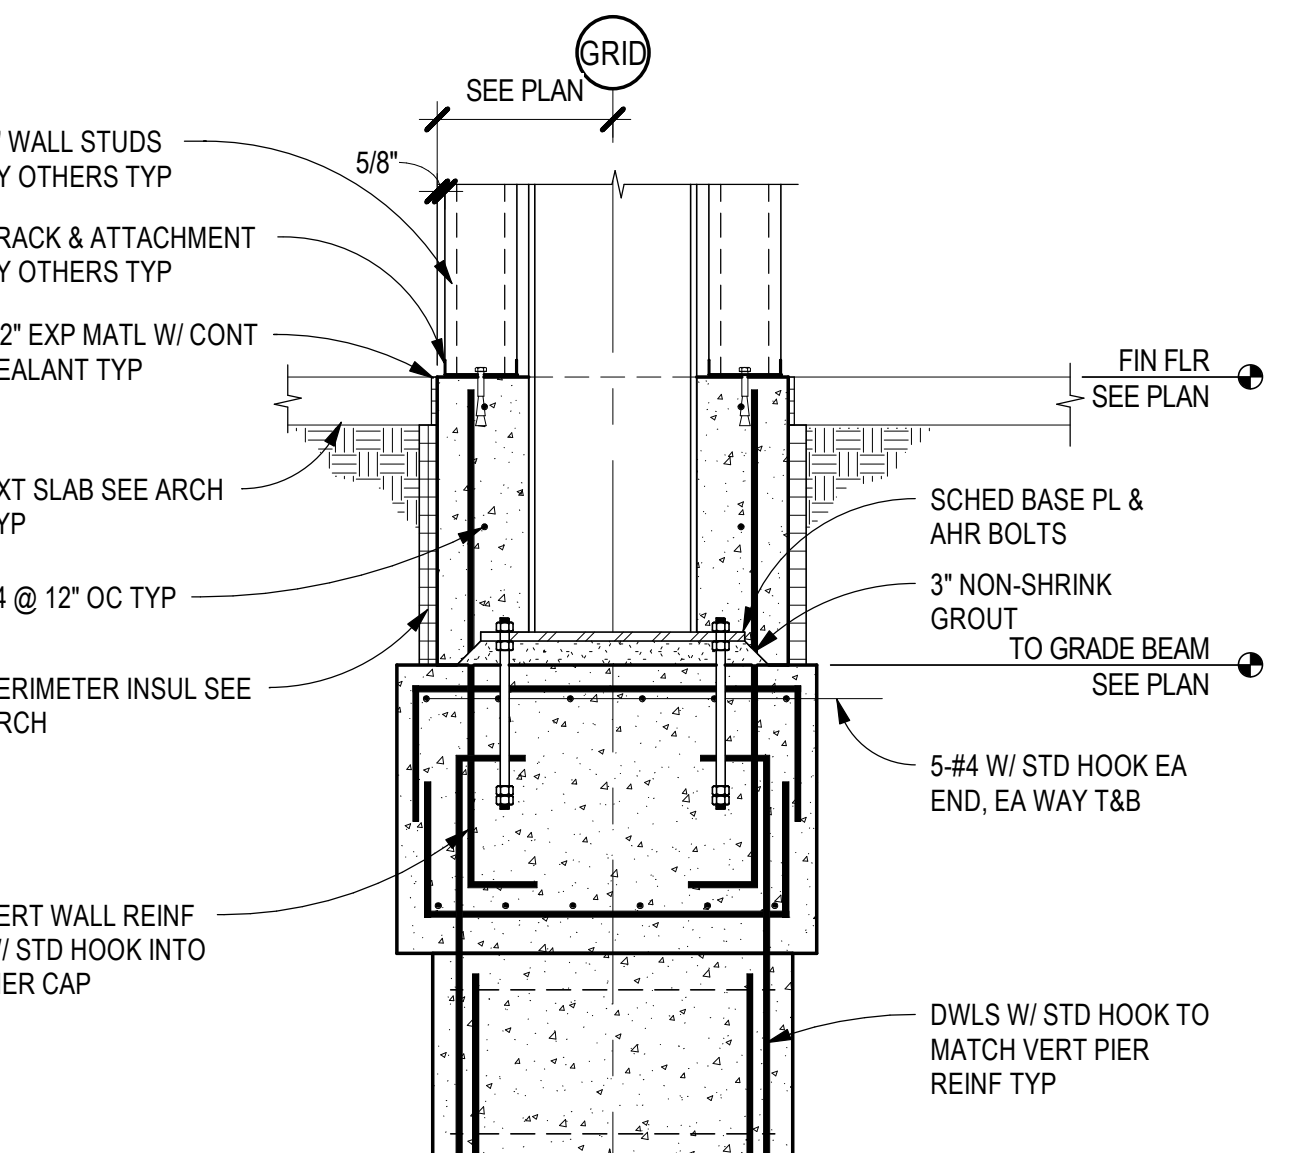


B3 PERIMETER COLUMN FDN SECTION
 SCALE: 3/4" = 1'-0"

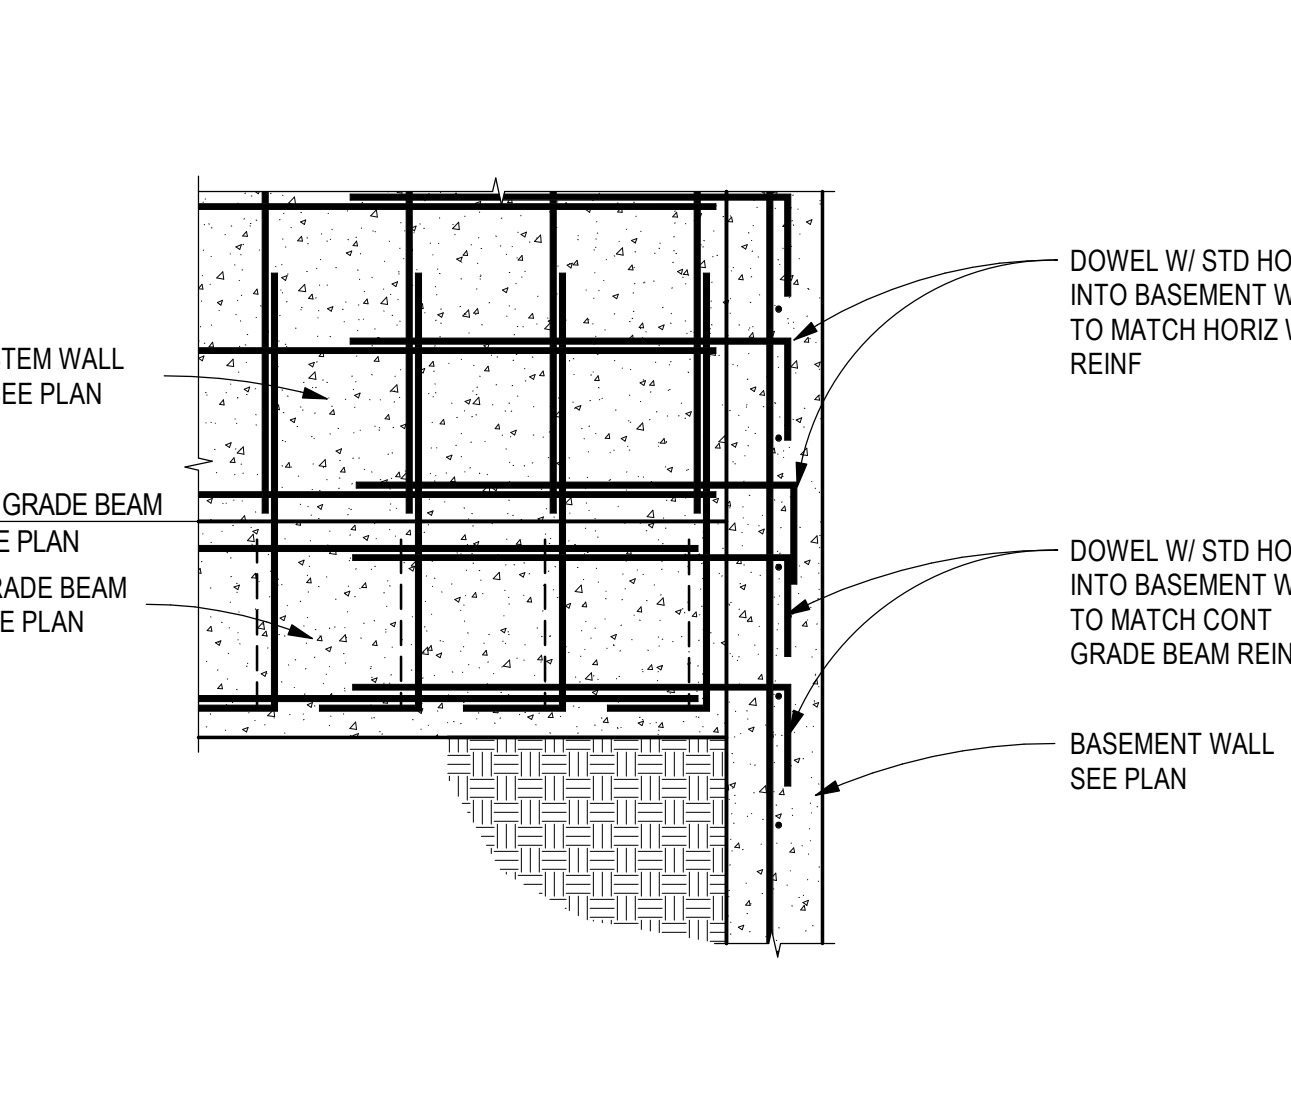


A3 GRADE BEAM TO BASEMENT WALL
 SCALE: 3/4" = 1'-0"

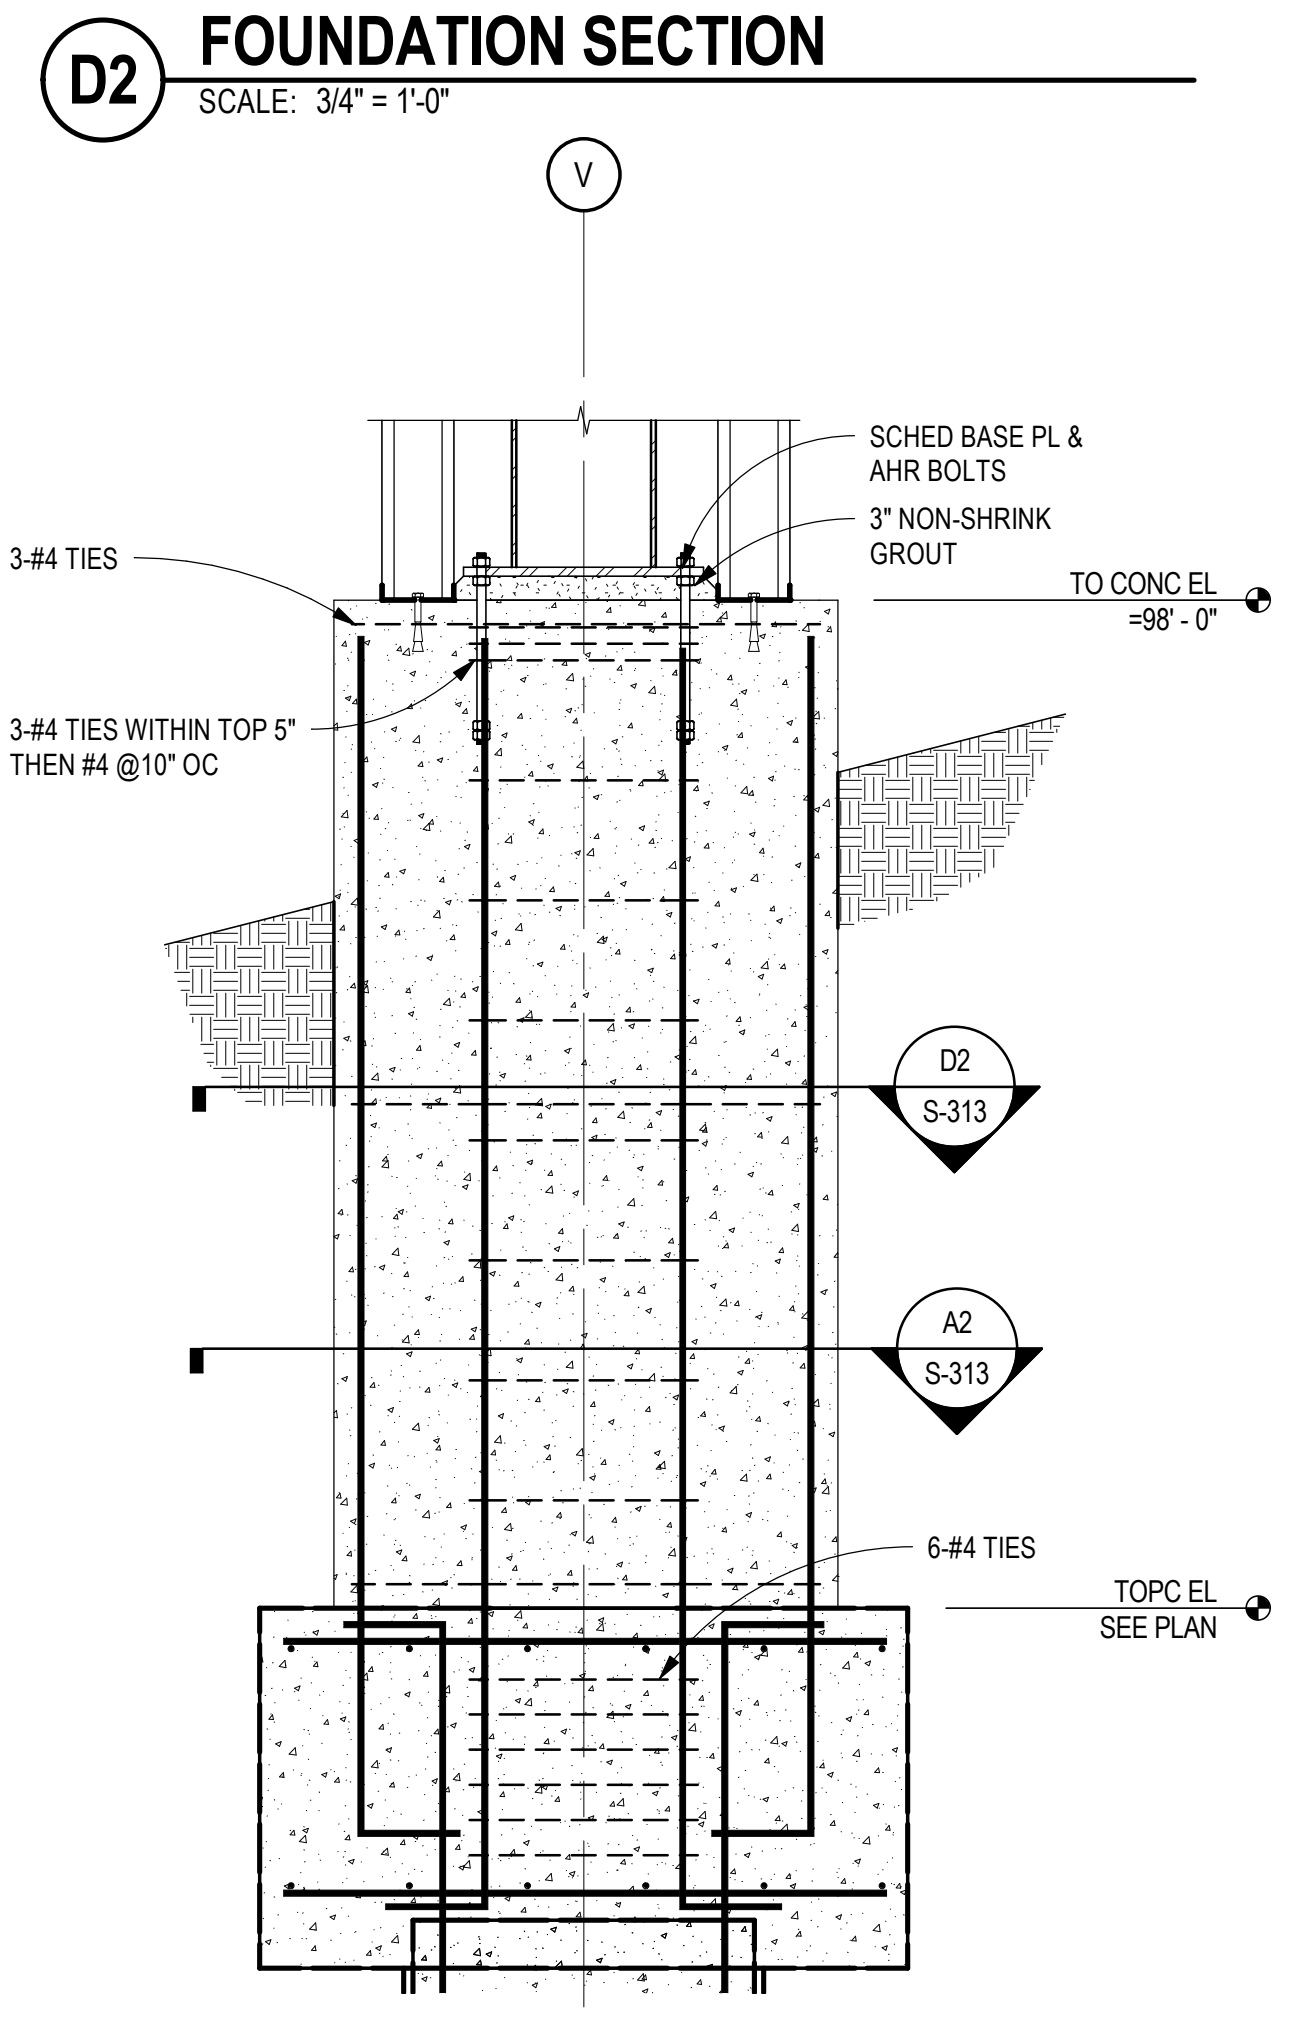


D2 FOUNDATION SECTION
 SCALE: 3/4" = 1'-0"

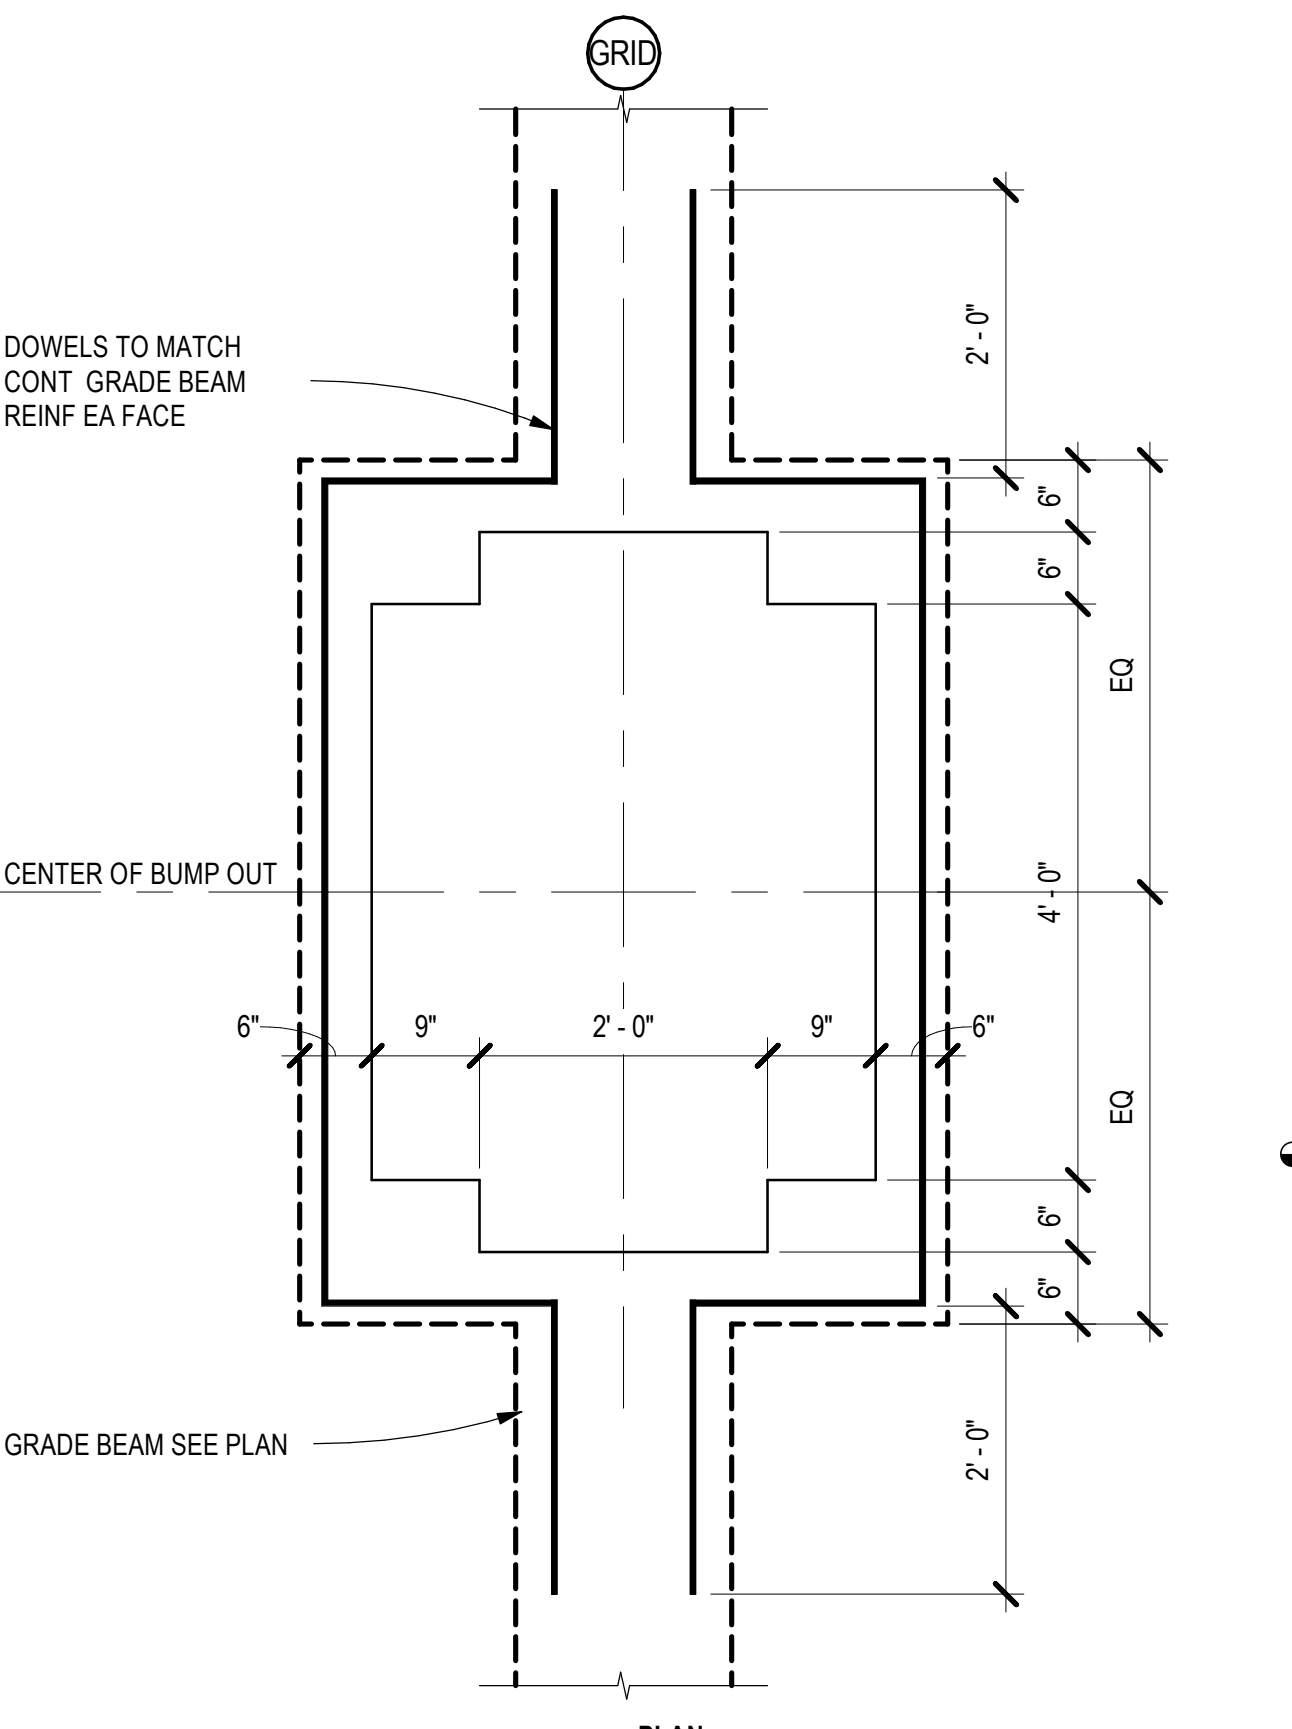


A2 GRADE BEAM AT WALL BUMPOUT
 SCALE: 3/4" = 1'-0"

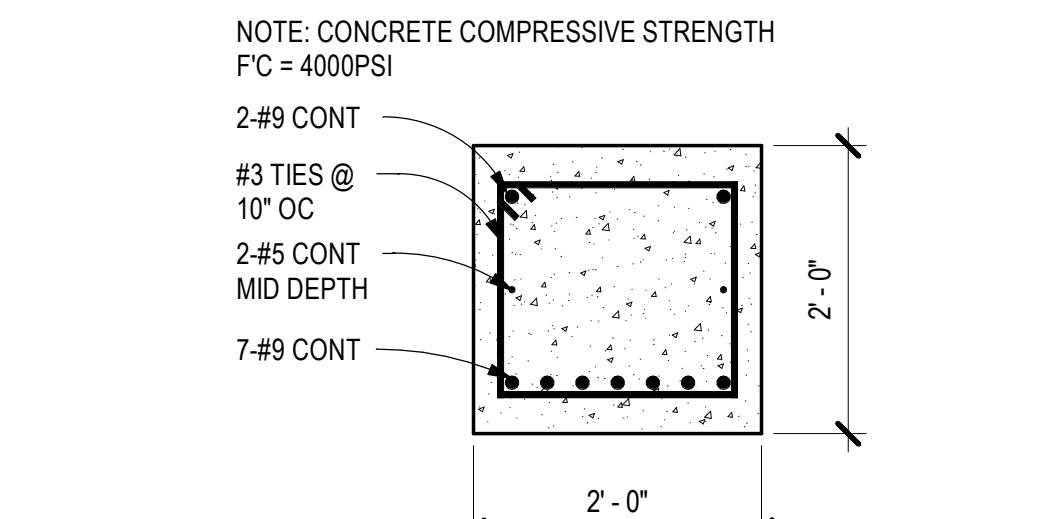


E1 GRADE BEAM SECTION
 SCALE: 3/4" = 1'-0"

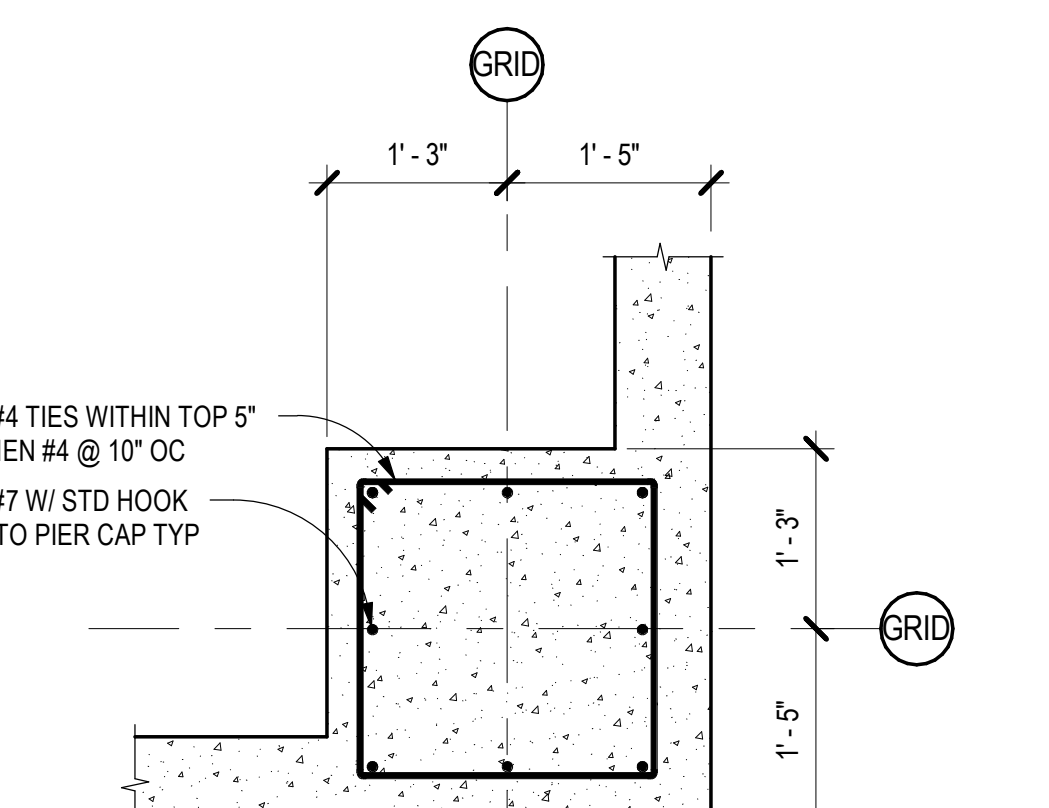

D1 PILASTER SECTION
 SCALE: 3/4" = 1'-0"

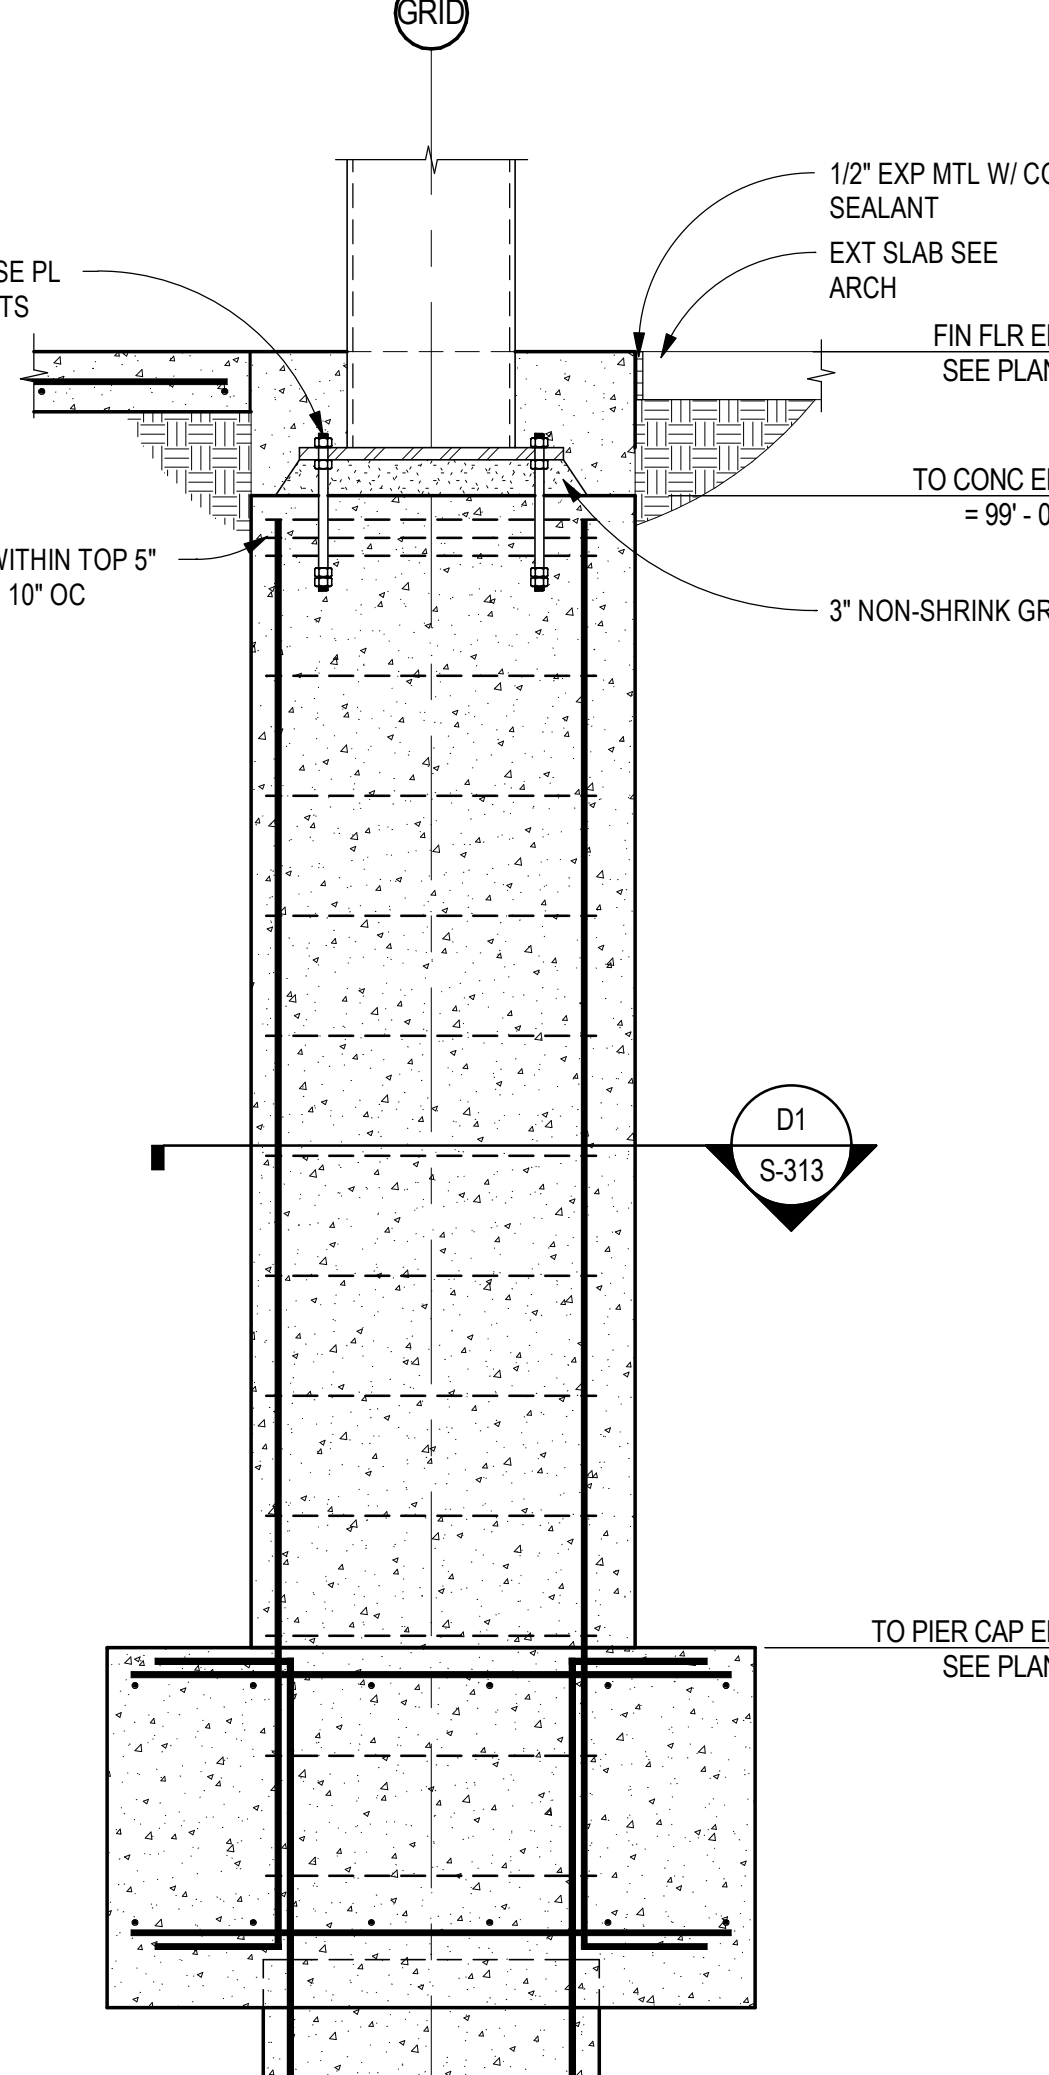


B1 PERIMETER COLUMN FDN SECTION
 SCALE: 3/4" = 1'-0"

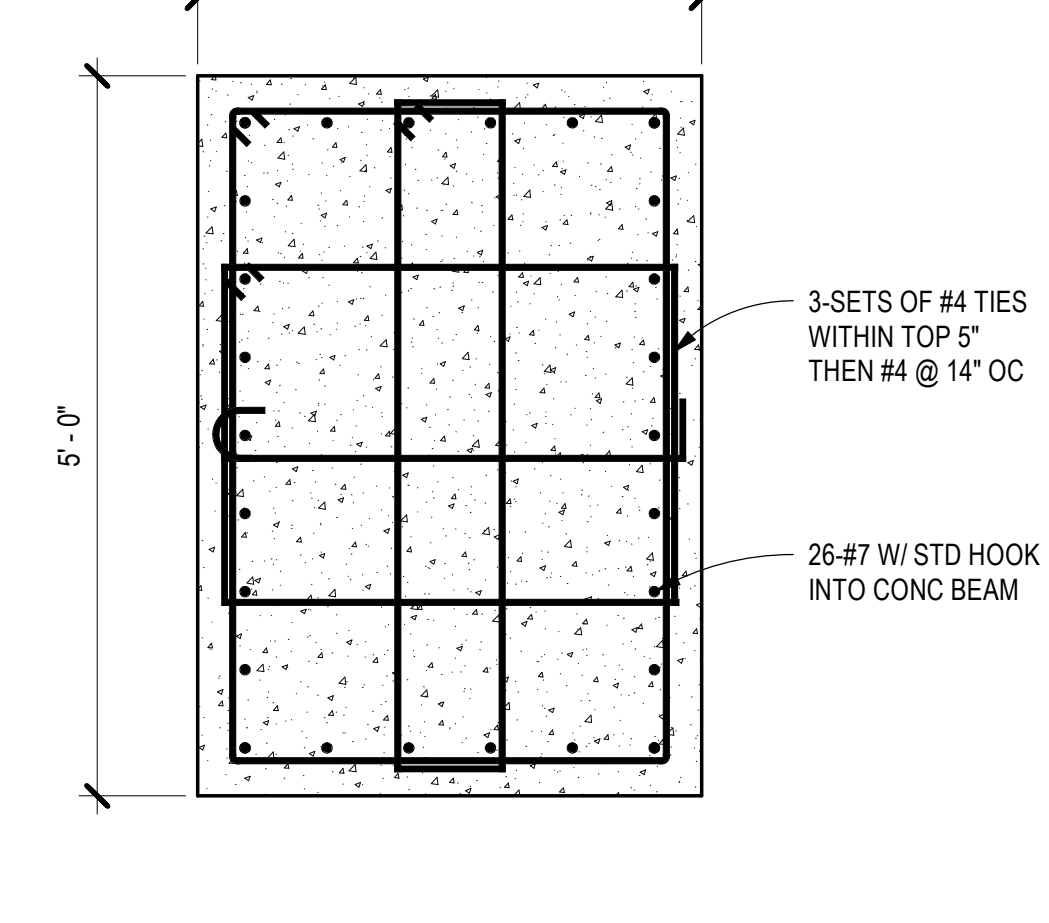

A1 FOUNDATION SECTION
 SCALE: 3/4" = 1'-0"

6/16/2018 7:28:11 AM

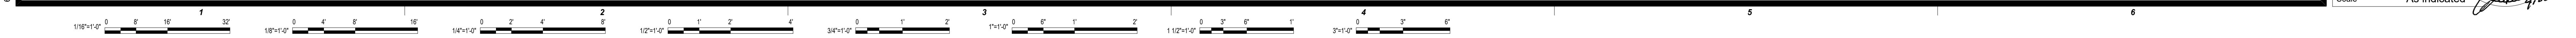

This document, and the ideas and designs incorporated herein, are an instrument of professional service, and are not to be used, in whole or in part, for any other project, without the written authorization of EDMONDSON REED ASSOCIATES.

INTERIOR ARCHITECTURE
 JCJ Architecture
 120 Hushyhope Avenue
 Suite 400
 Hartford, CT 06106
 860-247-9226

STRUCTURAL ENGINEERING
 Chavez-Grieves Consulting Engineers, Inc.
 4700 Lincoln Road NE
 Suite 102
 Albuquerque, NM 87109
 505-344-4080

MEP ENGINEERING
 MSA Engineering Consultants
 370 E. Windmill Ln.
 Suite 100
 Las Vegas, NV 89123
 702-896-1100

CIVIL ENGINEERING / SURVEYING
 Native Plans Surveying and Mapping /
 RK & Associates PLC
 5807 S. Garnett Rd.
 Suite K
 Tulsa, OK 74146
 918-234-7596

LOW VOLTAGE / THEME LIGHTING
 M/E Engineering
 60 Lakelmont Boulevard
 Suite 303
 Buffalo, NY 14202
 716-845-5092

FOOD SERVICES
 Heintman Group, LLC
 7645 E. 63rd St.
 Suite 201
 Tulsa, OK 74133
 918-935-5036



Chavez-Grieves
 consulting engineers, inc.
 4700 Lincoln Road NE, Suite 102, Albuquerque, NM 87109
 505-344-4080 / 505-343-9759 (fax)


CASINO 4

KEY PLAN

FLOOR FRAMING SECTIONS


CONSTRUCTION SET

PROJECT NO: 201704
 DRAWN BY: J. ANDERSON
 CHECKED BY: C. ROMERO
 ISSUE DATE: 5/4/2018

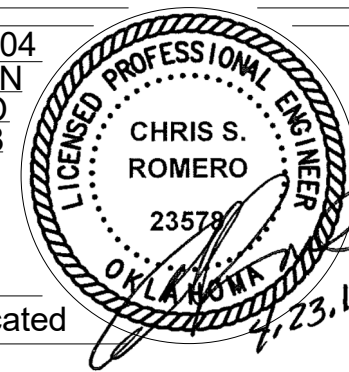


S-321
 Scale: As indicated


CHEROKEE HARD ROCK CASINO 4

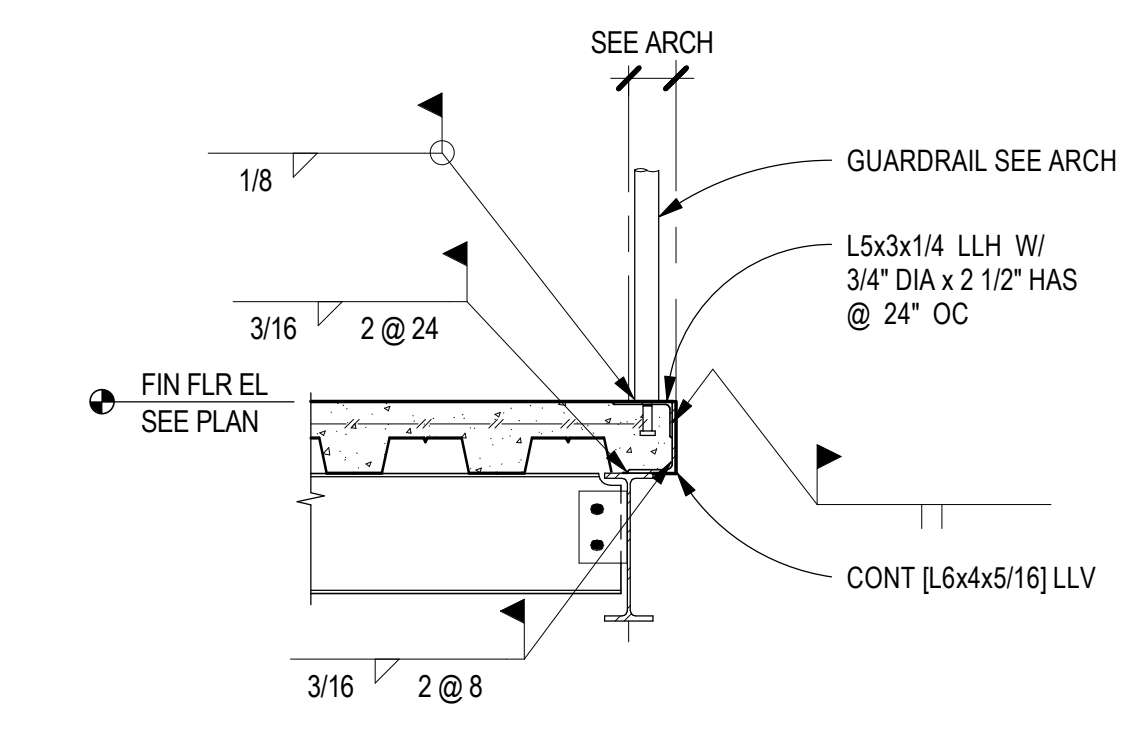


E5 FLOOR FRAMING SECTION
 SCALE: 3/4" = 1'-0"

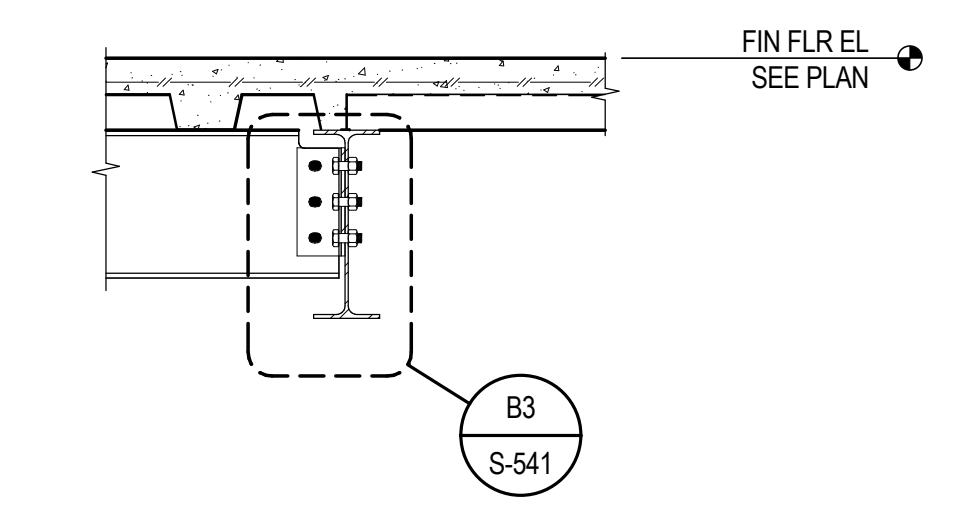


C5 FLOOR DECK TRANSITION
 SCALE: 3/4" = 1'-0"

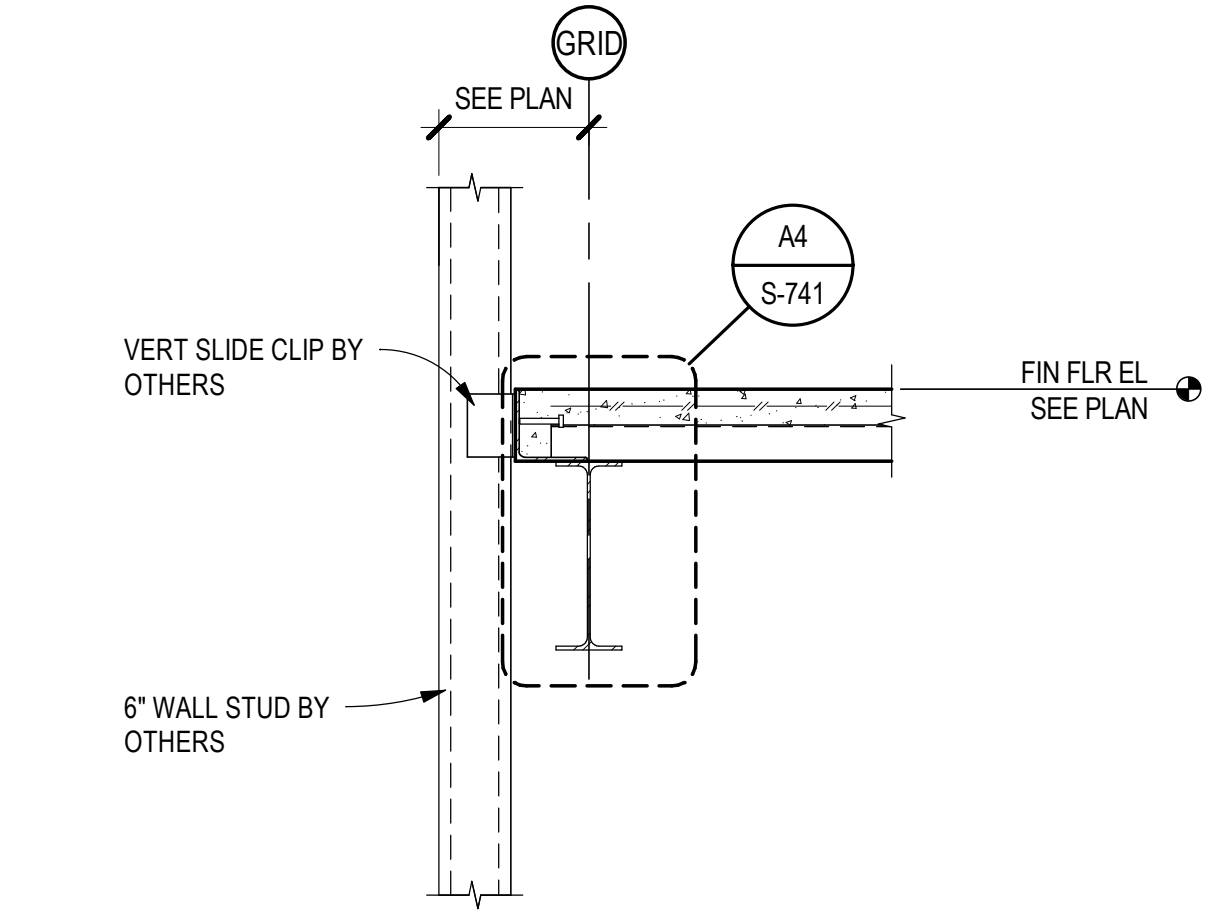


B5 FLOOR FRAMING SECTION
 SCALE: 3/4" = 1'-0"

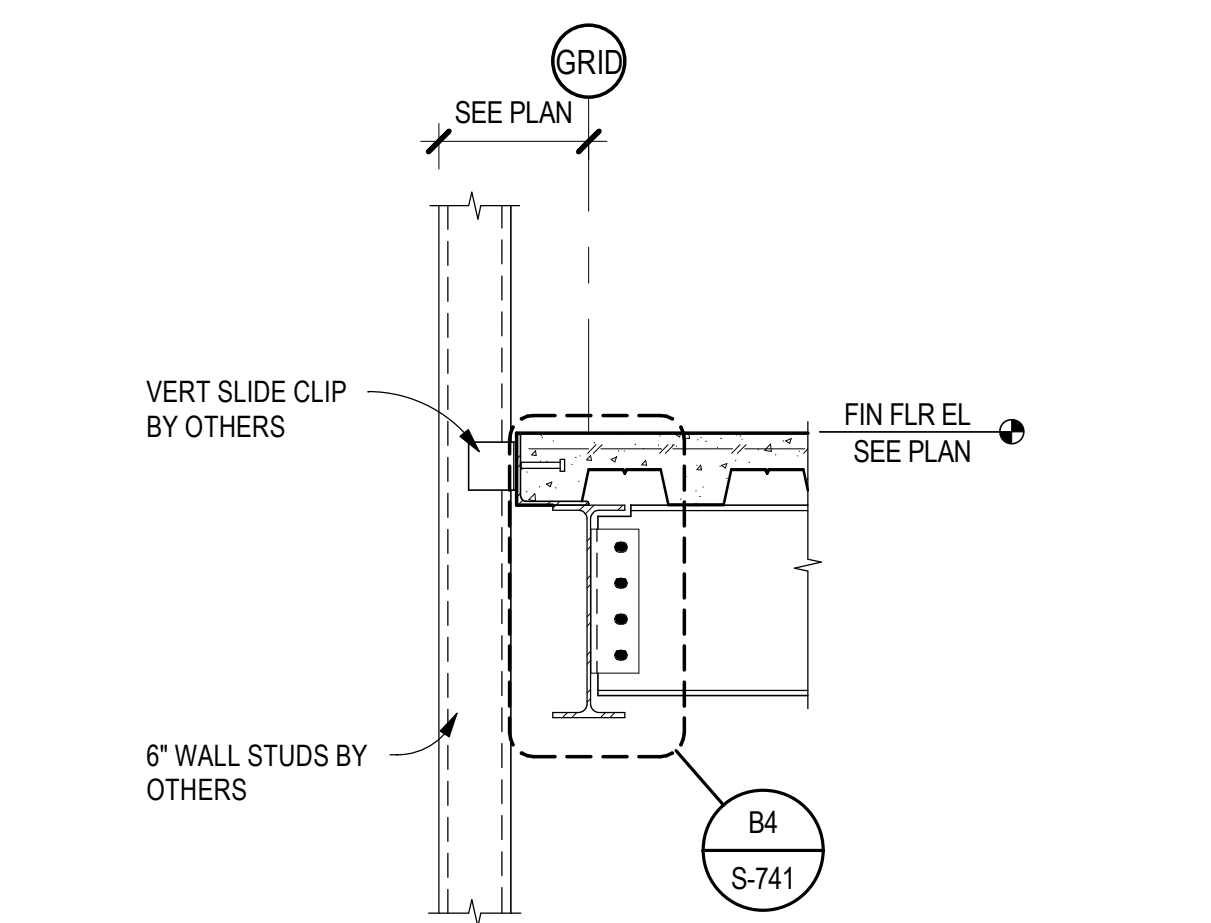


A5 FLOOR FRAMING SECTION
 SCALE: 3/4" = 1'-0"

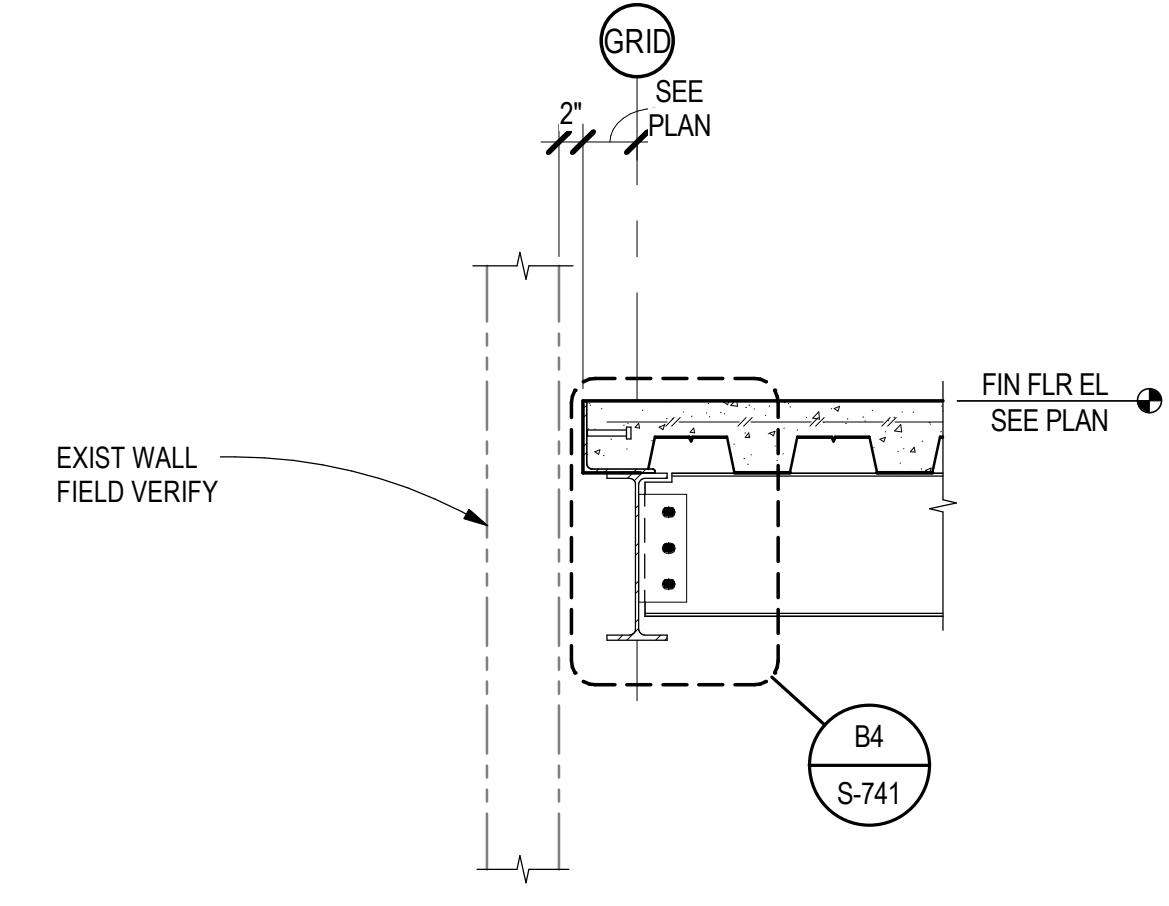


E4 FLOOR FRAMING SECTION
 SCALE: 3/4" = 1'-0"

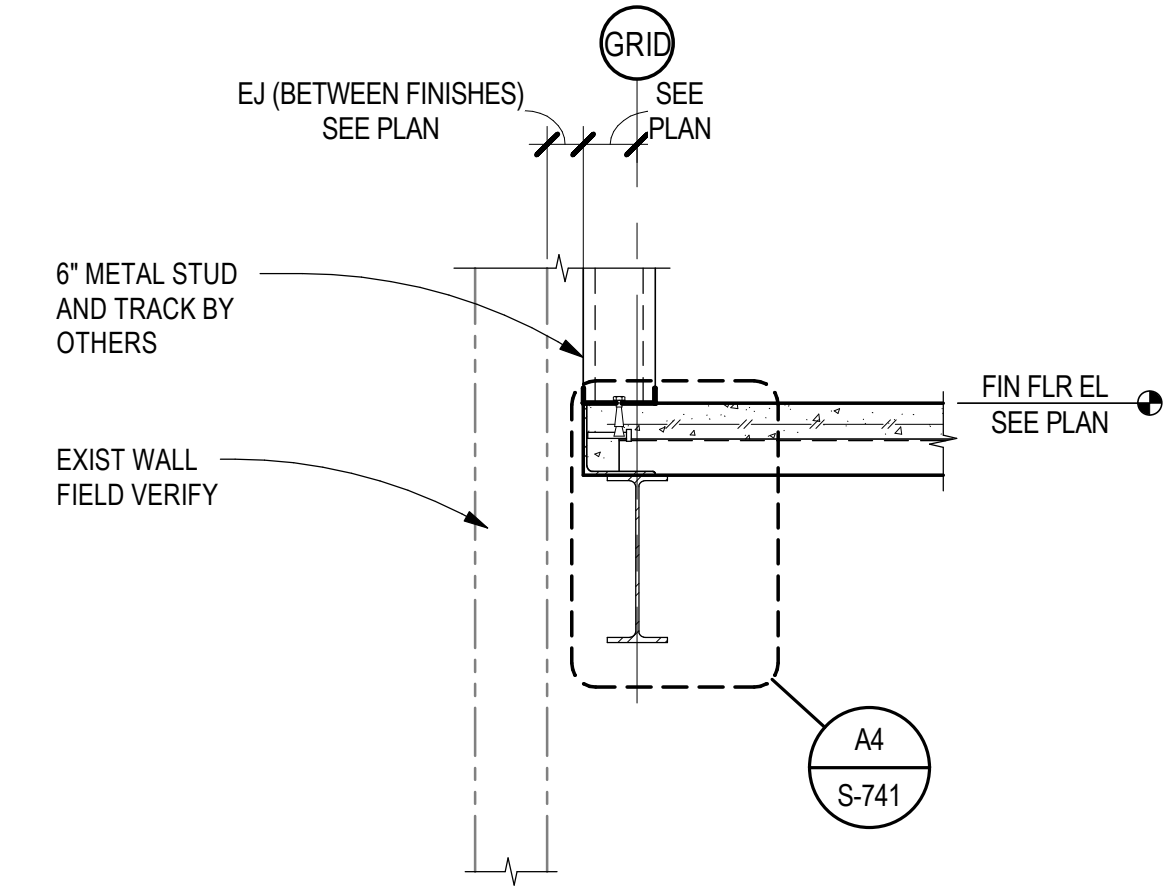


C4 FLOOR FRAMING SECTION
 SCALE: 3/4" = 1'-0"

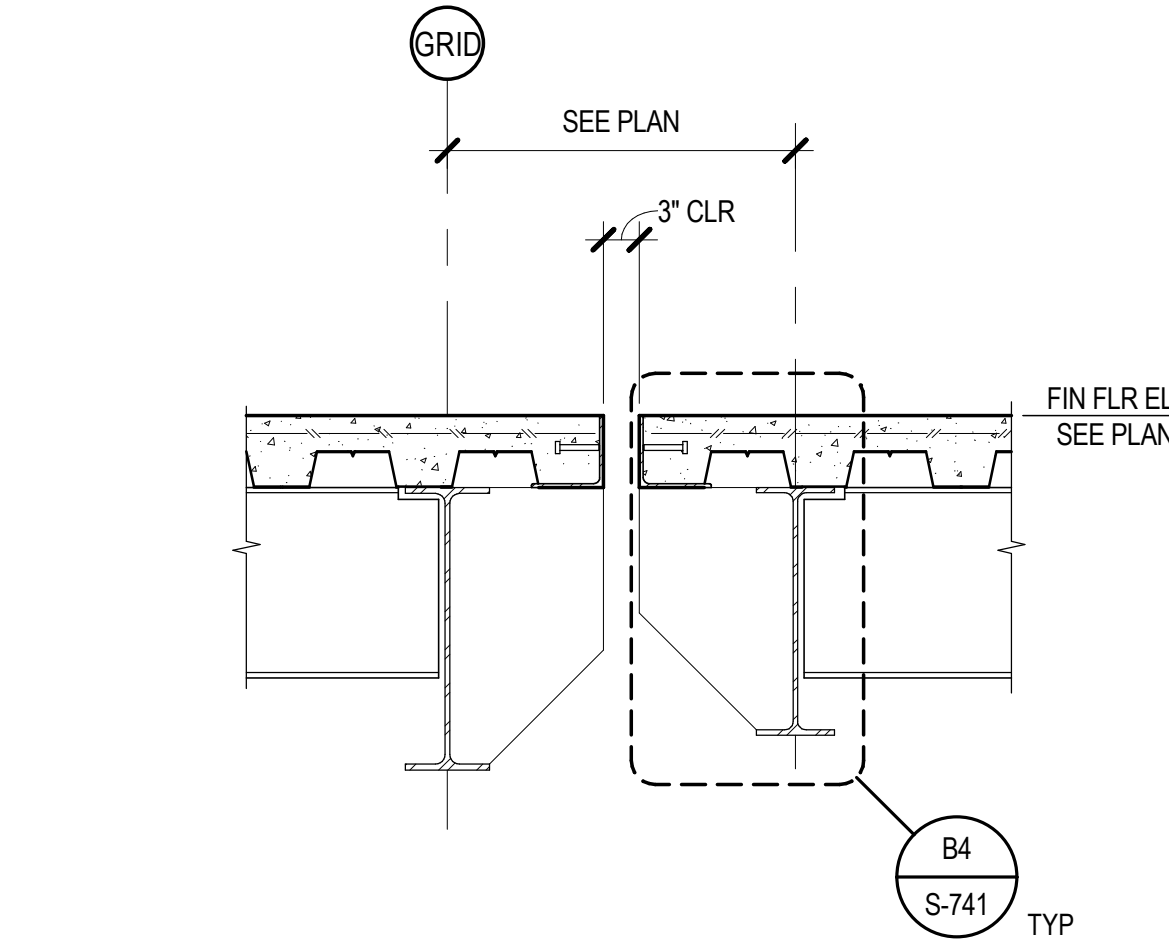


B4 FLOOR EXPANSION JOINT
 SCALE: 3/4" = 1'-0"

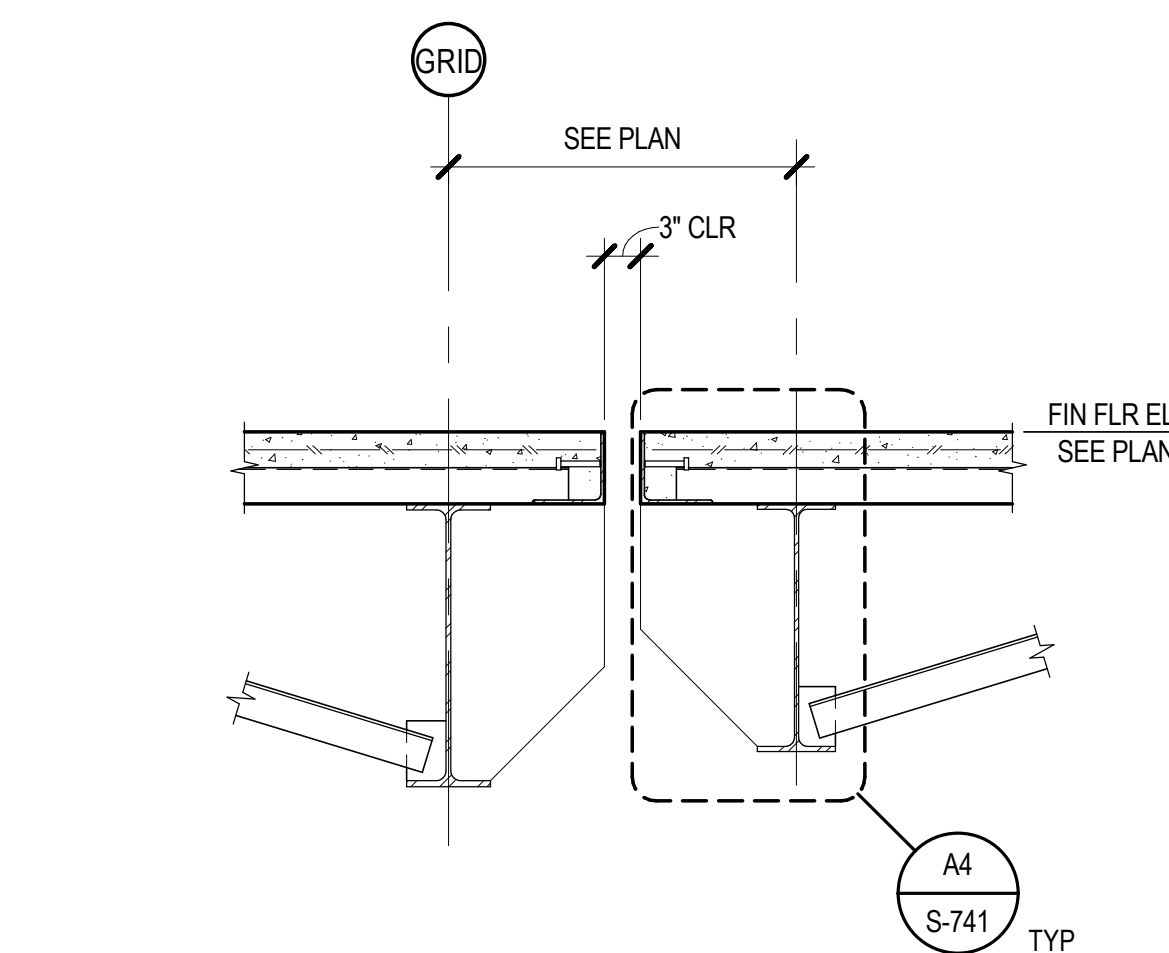


A4 FLOOR EXPANSION JOINT
 SCALE: 3/4" = 1'-0"

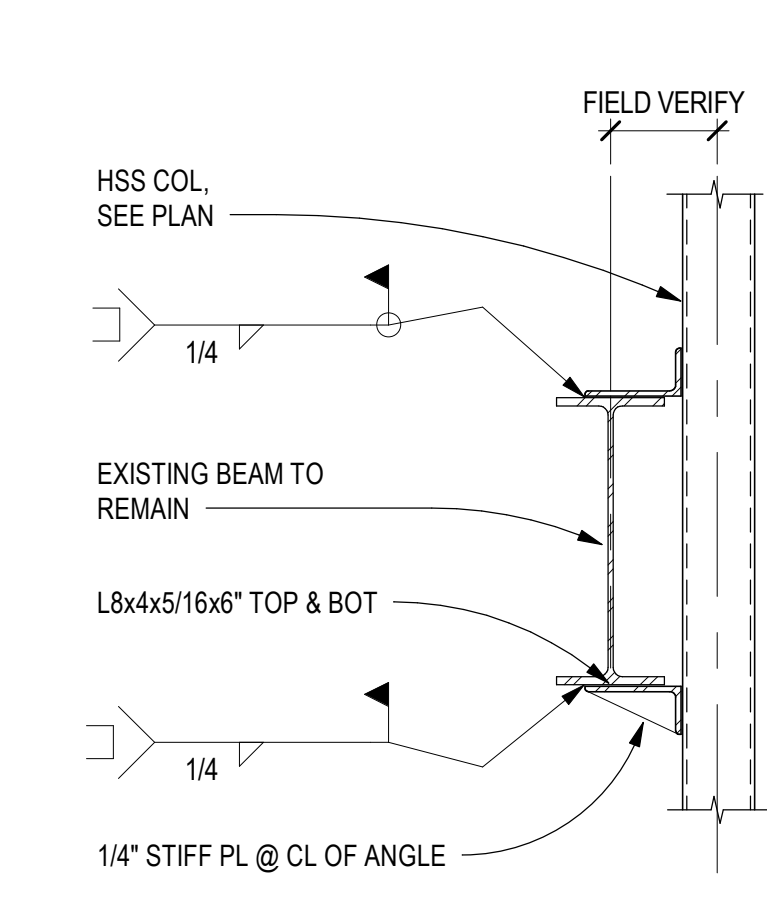


E3 EXISTING BM TO HSS COL
 SCALE: 3/4" = 1'-0"

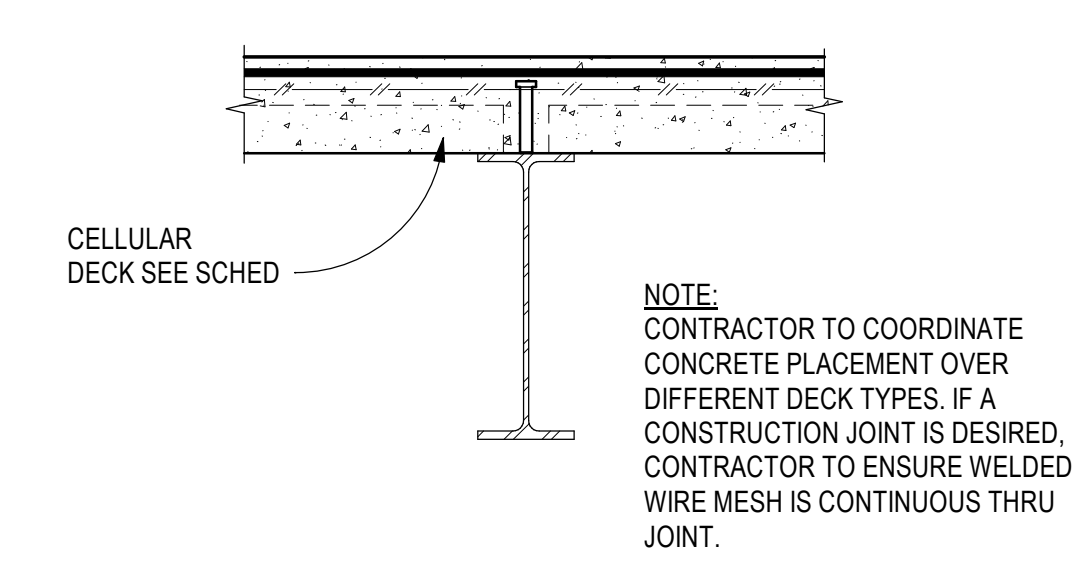


C3 SECT AT MEZZANINE DECK CHANGE
 SCALE: 1" = 1'-0"

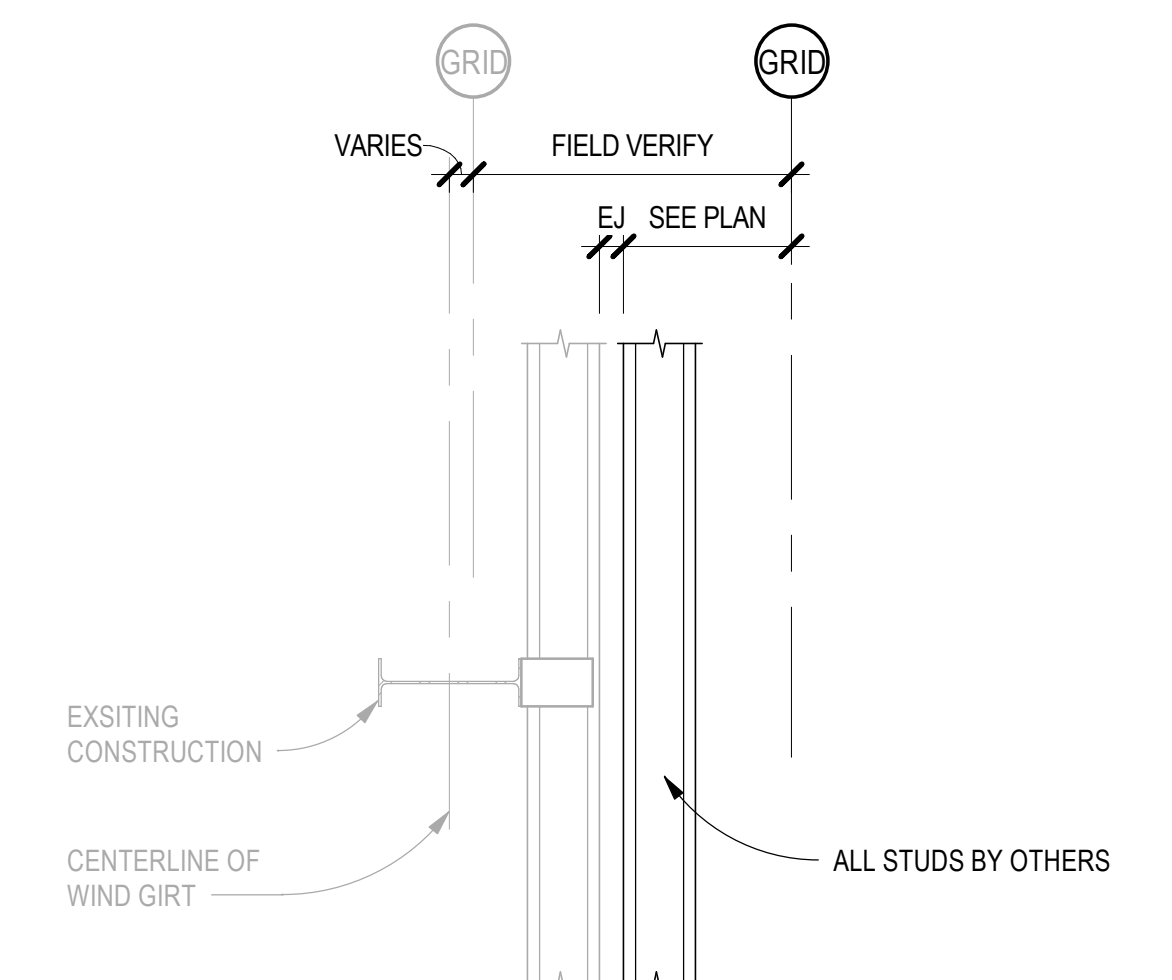


B3 SECTION AT EXISTING WIND GIRT
 SCALE: 3/4" = 1'-0"

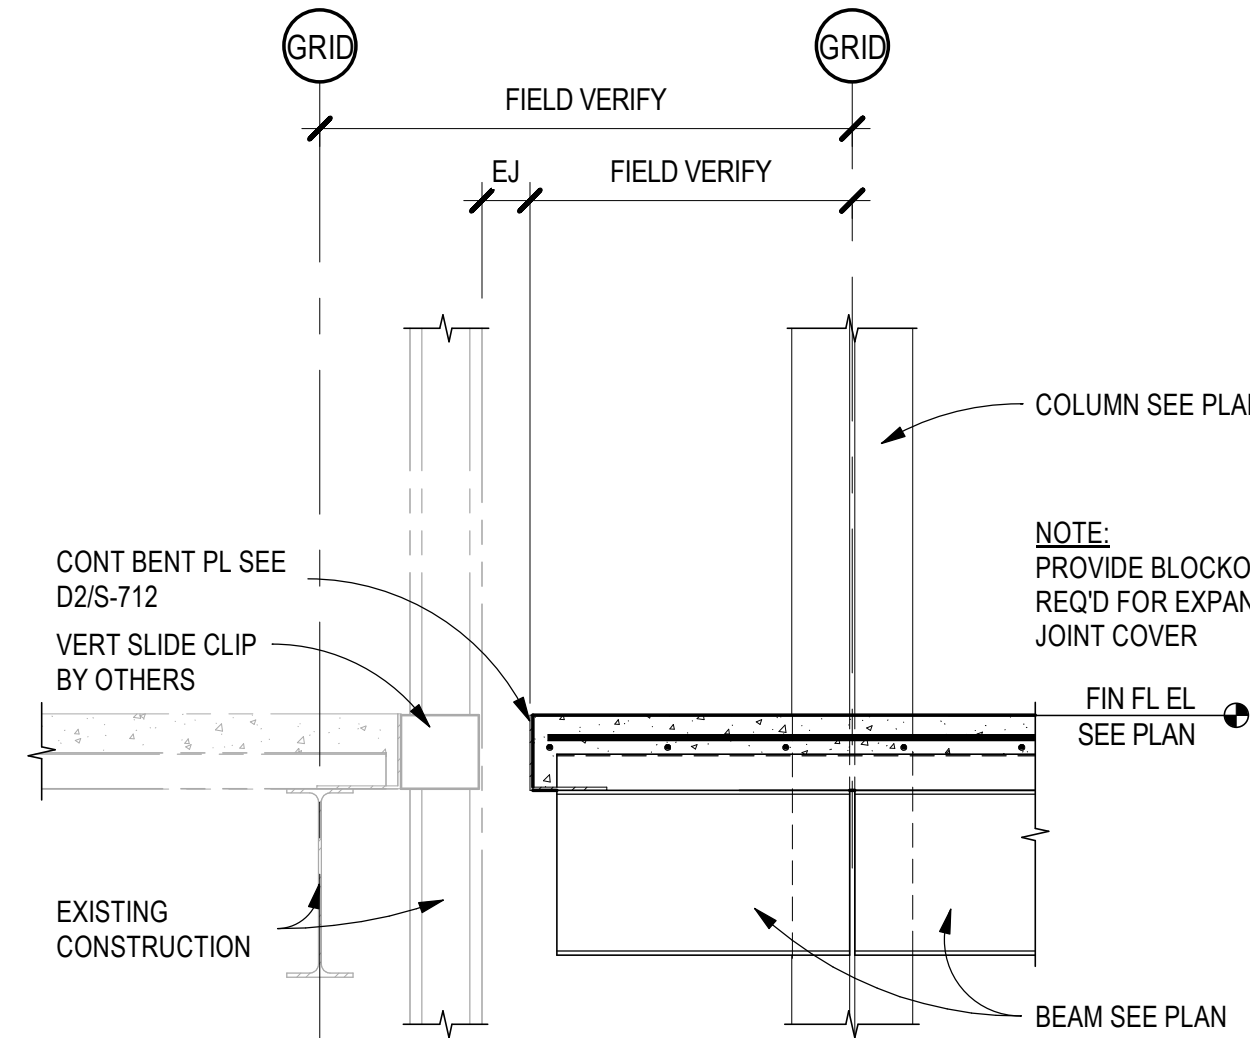


A3 SECTION AT ROOF / EXISTING
 SCALE: 3/4" = 1'-0"

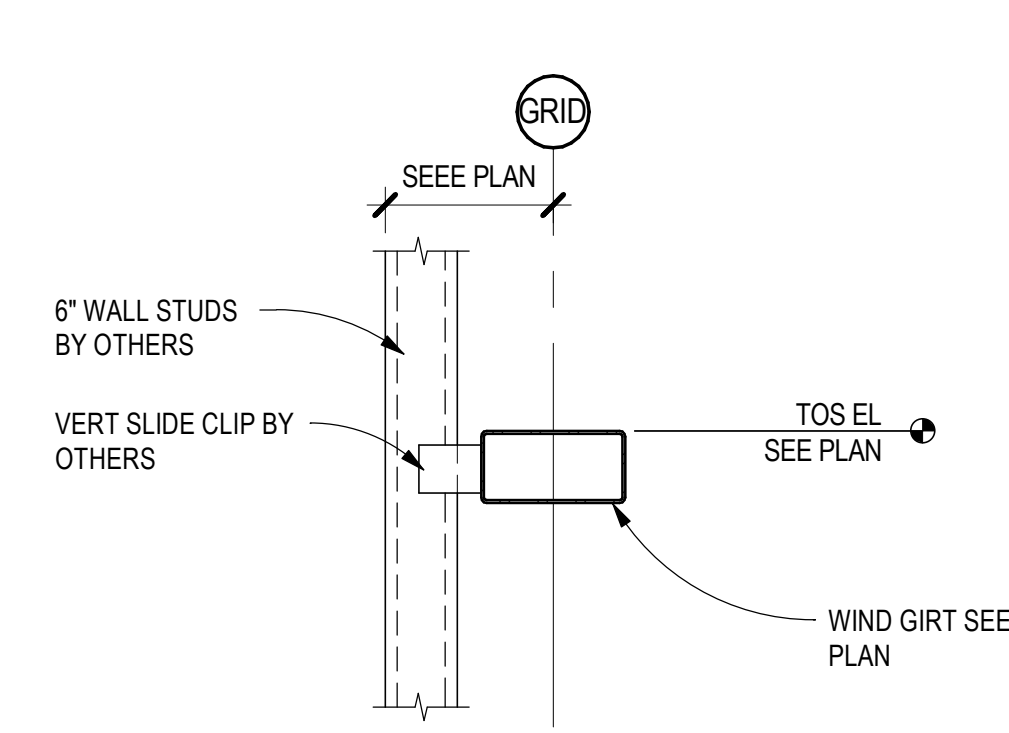


E2 FRAMING SECTION
 SCALE: 3/4" = 1'-0"

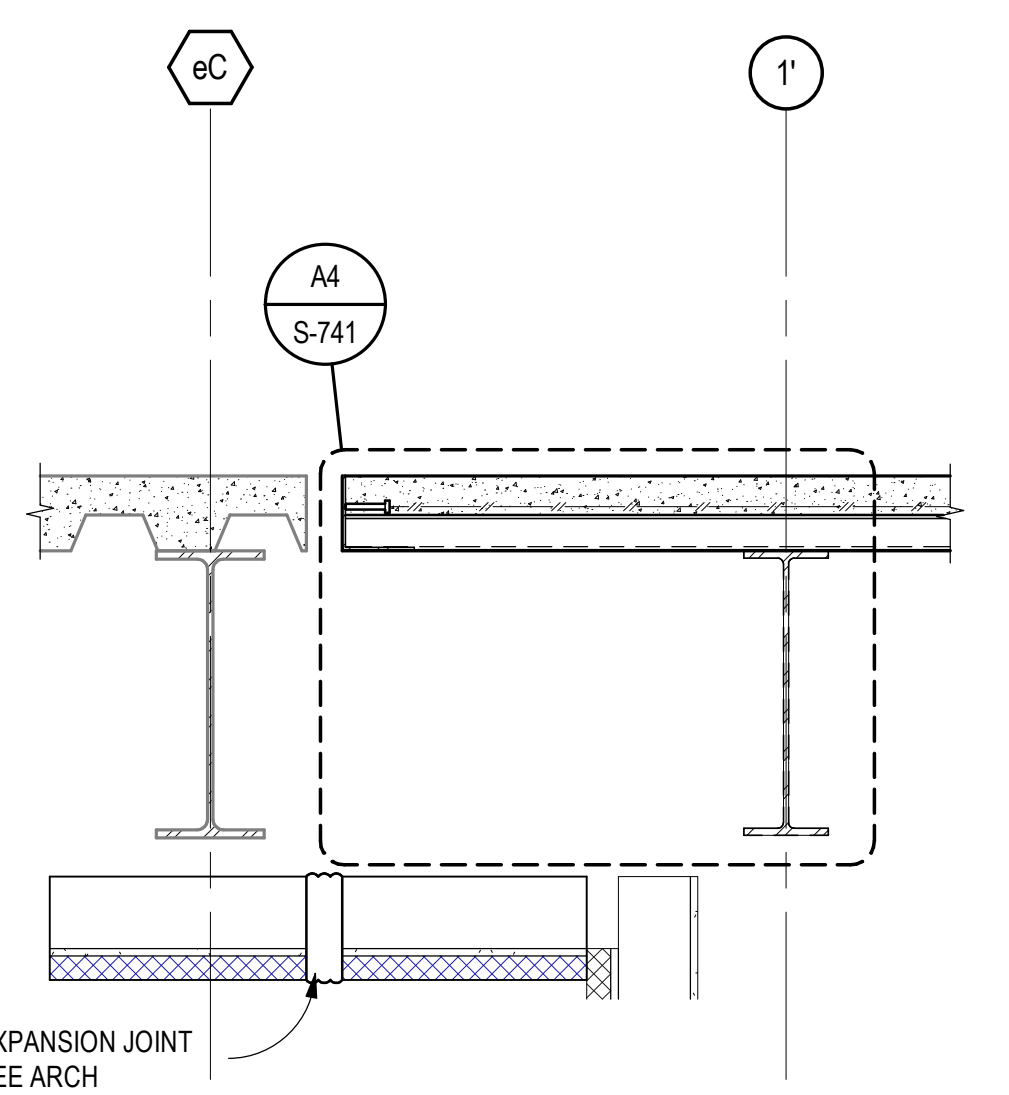


C2 FRAMING SECTION
 SCALE: 3/4" = 1'-0"

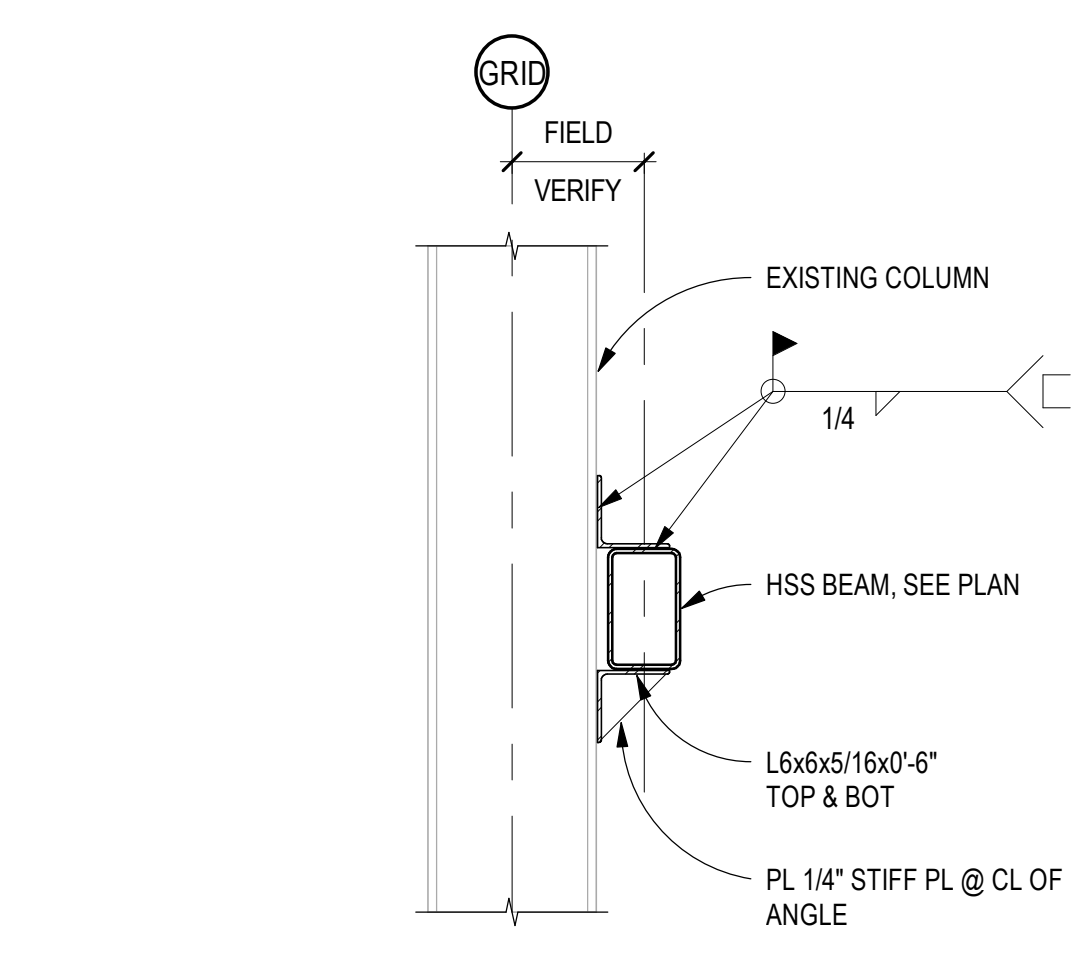


B2 HSS HEADER TO EXISTING COLUMN
 SCALE: 3/4" = 1'-0"

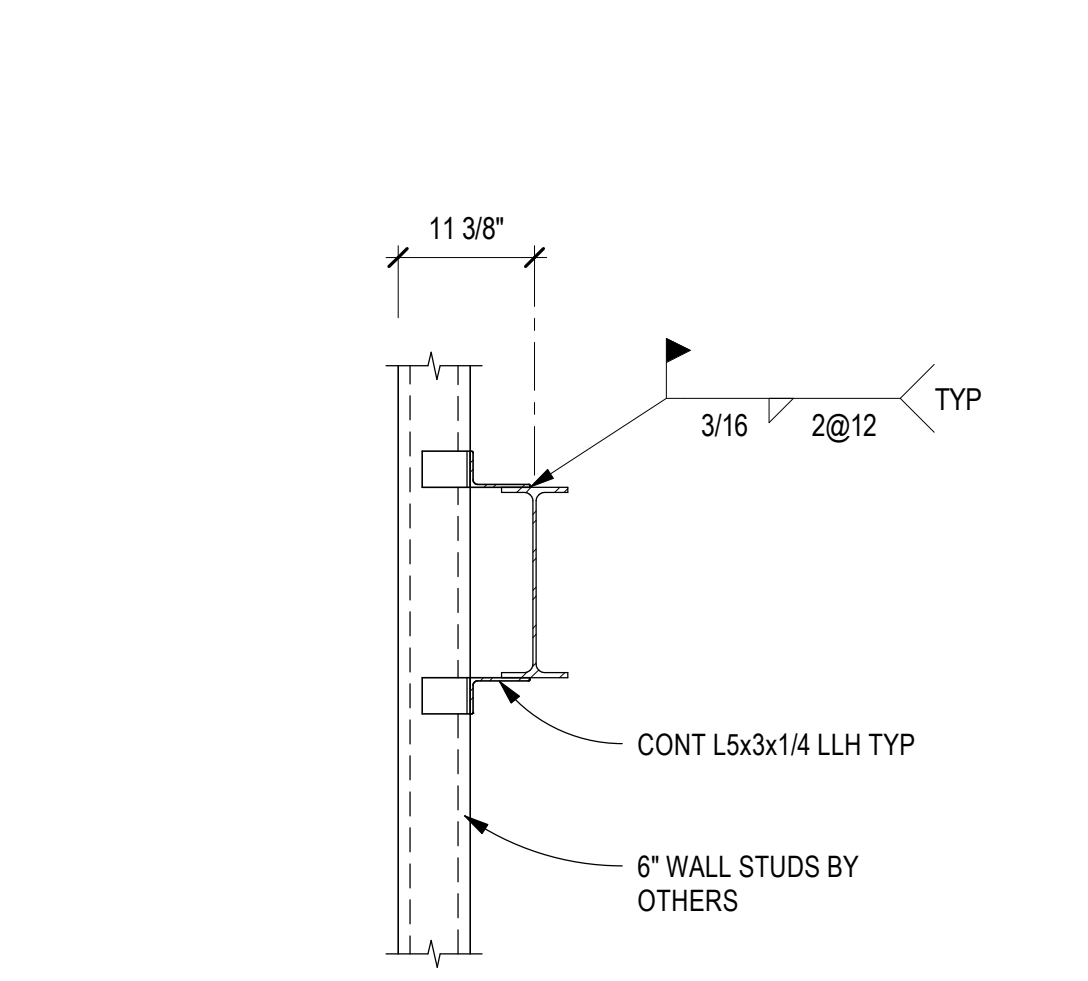


A2 FRAMING SECTION
 SCALE: 3/4" = 1'-0"

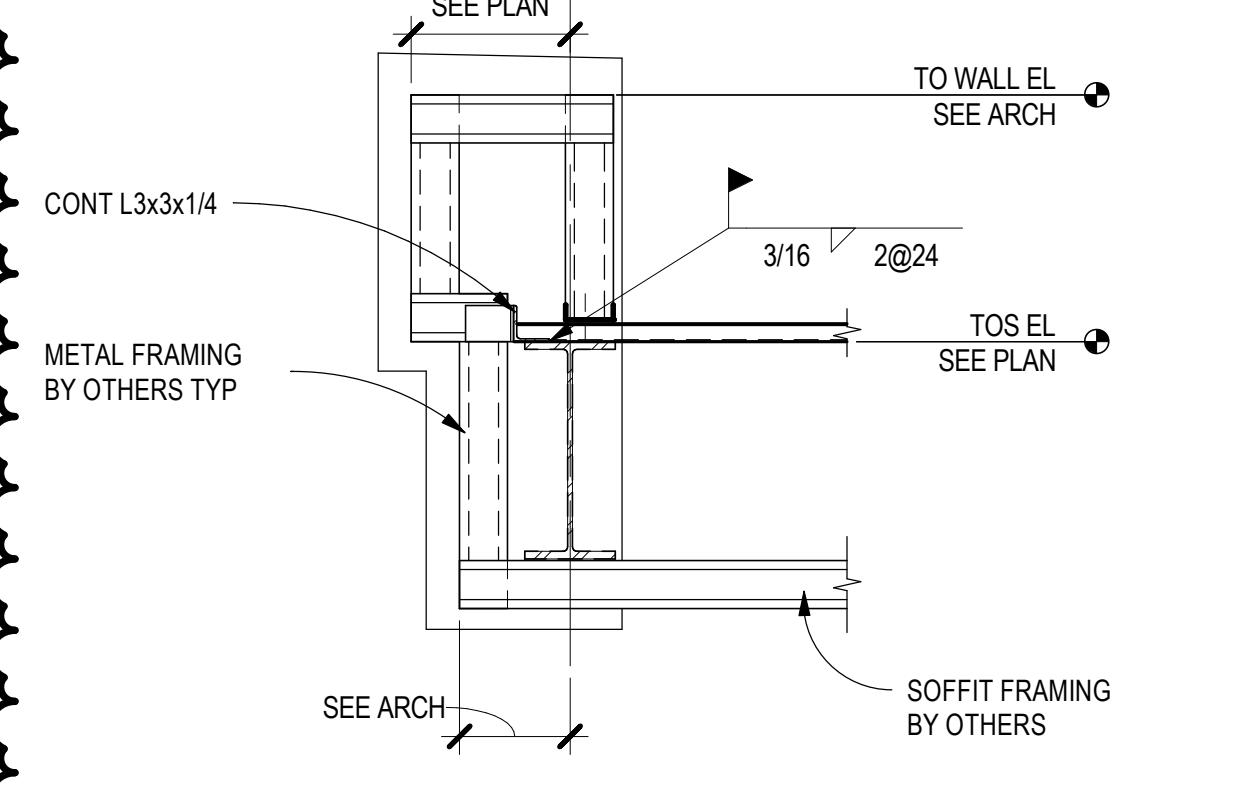


D1 ROOF FRAMING SECTION
 SCALE: 3/4" = 1'-0"

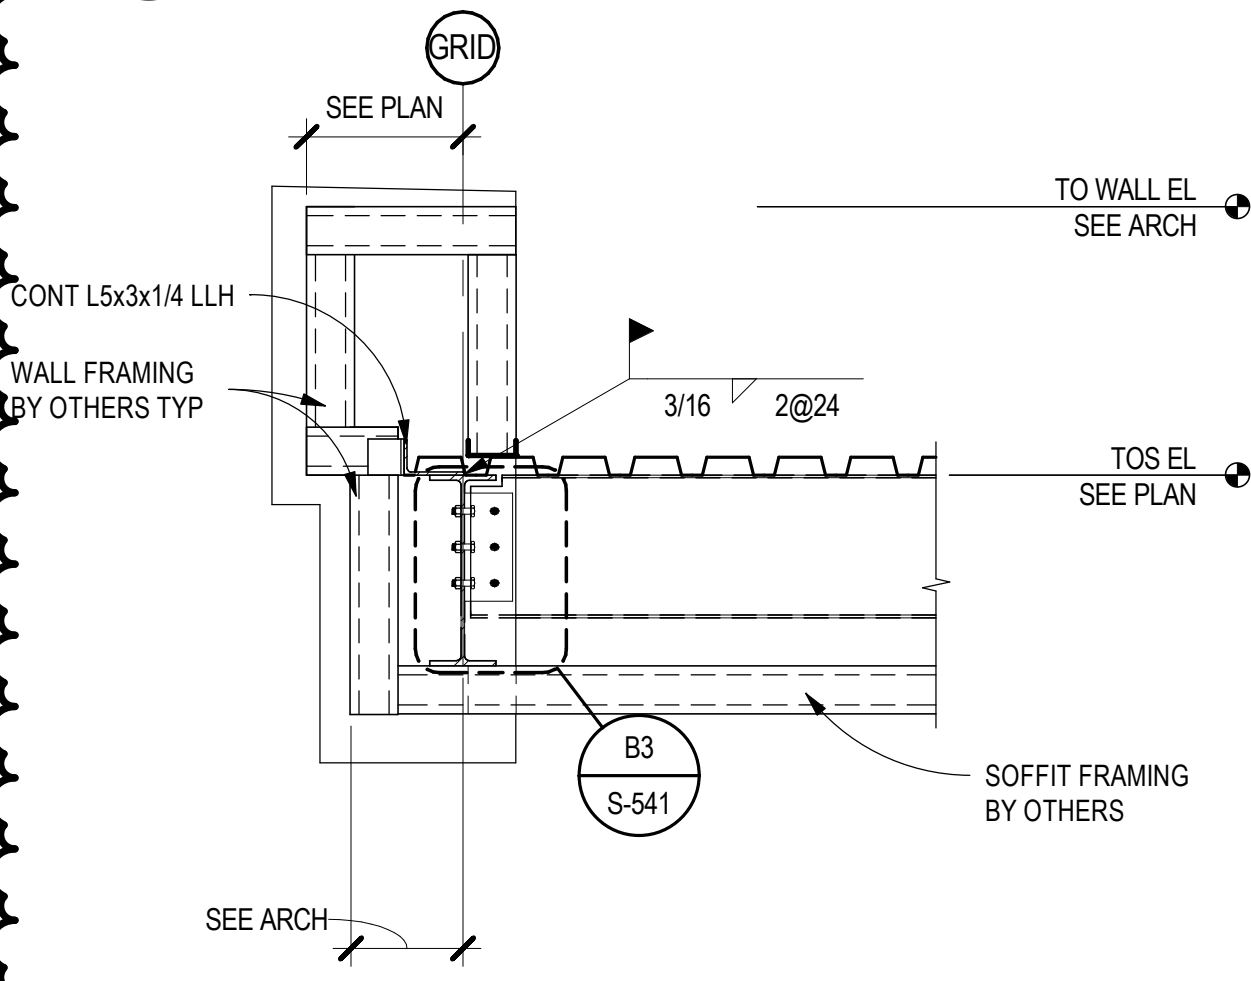


C1 PORTE COCHERE FRAMING SECTION
 SCALE: 3/4" = 1'-0"

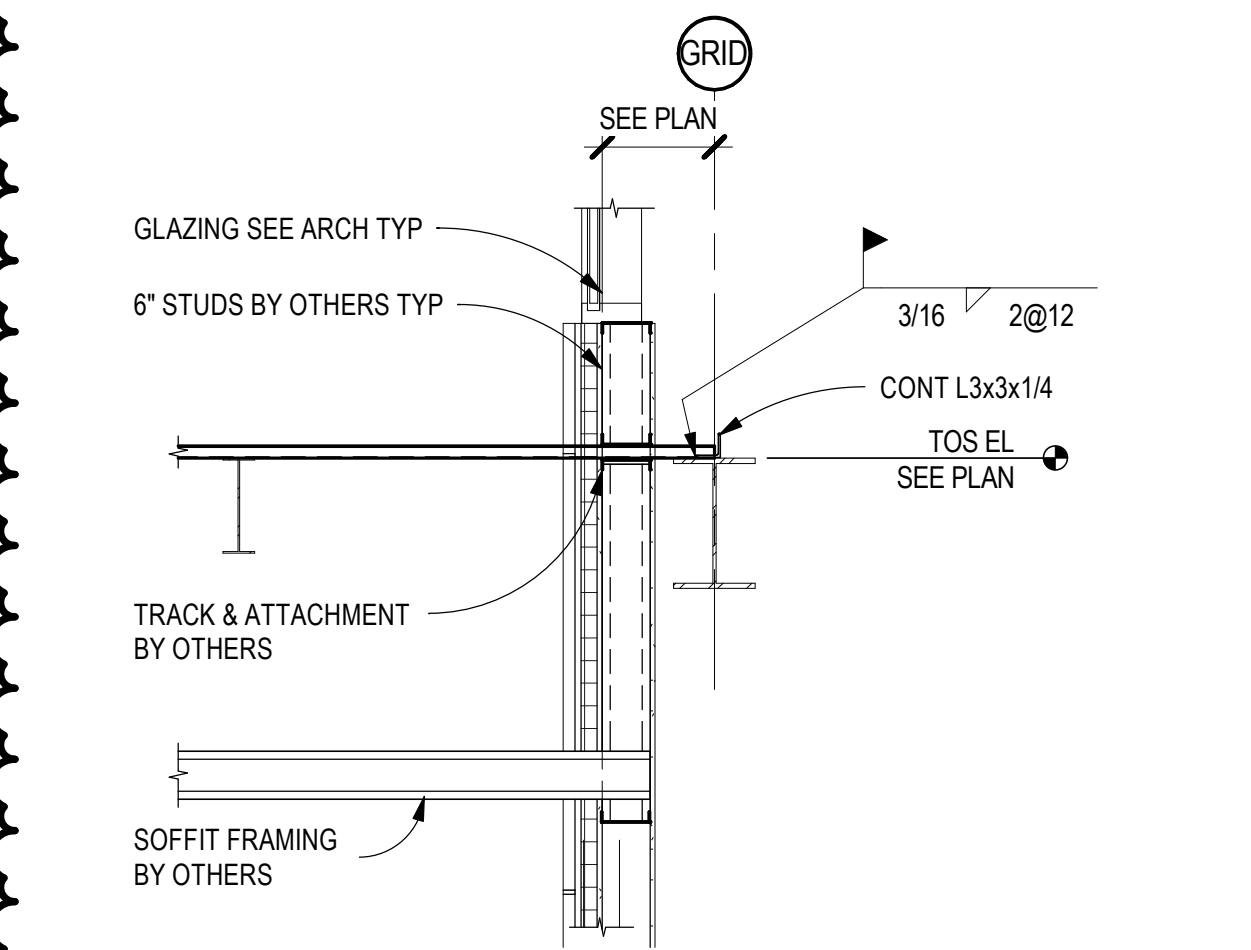

B1 ROOF FRAMING SECTION
 SCALE: 1/2" = 1'-0"

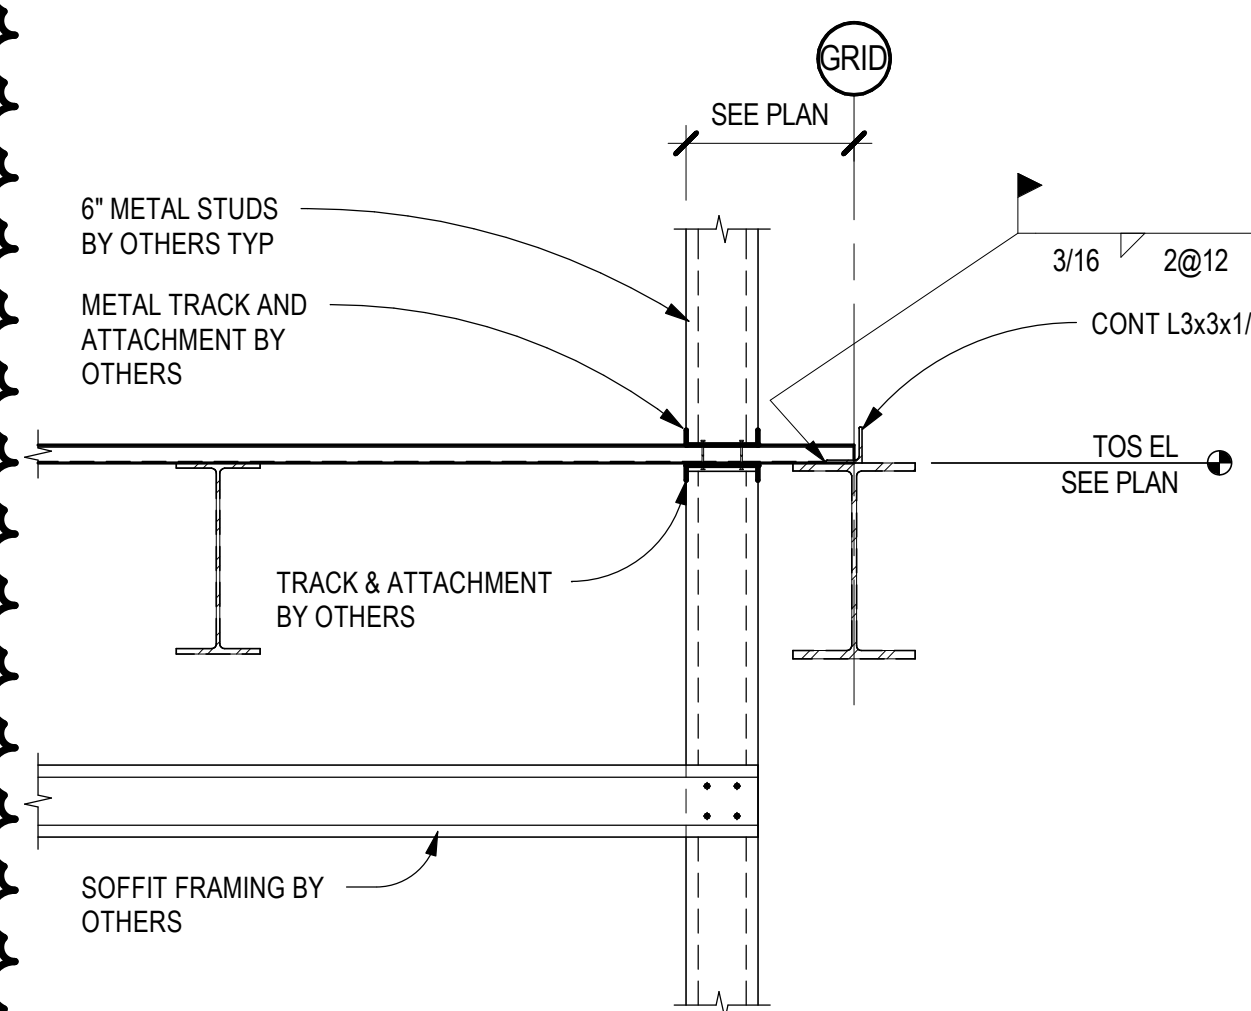

A1 ROOF FRAMING SECTION
 SCALE: 3/4" = 1'-0"

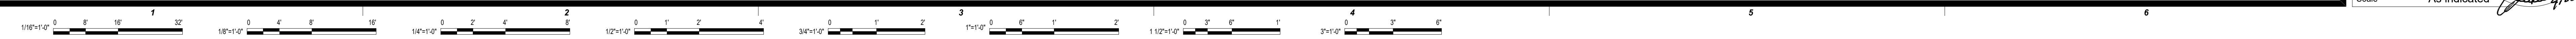

This document, and the ideas and designs incorporated herein, as an instrument of professional service, is the property of EDMONSON REED ASSOCIATES, and is not to be used, in whole or in part, for any other project, without the written authorization of EDMONSON REED ASSOCIATES.

INTERIOR ARCHITECTURE

CJ Architecture
 120 Huysheope Avenue
 Suite 400
 Hartford, CT 06106
 860-247-9226

STRUCTURAL ENGINEERING

Chavez-Grievs Consulting Engineers, Inc.
 4700 Lincoln Road NE
 Suite 102
 Albuquerque, NM 87109
 505-344-4080

MEP ENGINEERING

MSA Engineering Consultants
 370 E. Windmill Ln.
 Suite 100
 Las Vegas, NV 89123
 702-896-1100

CIVIL ENGINEERING / SURVEYING

Native Plans Surveying and Mapping / RK & Associates PLC
 5807 S. Garnett Rd.
 Suite K
 Tulsa, OK 74146
 918-234-7596

LOW VOLTAGE / THEME LIGHTING

M/E Engineering
 60 Lakefront Boulevard
 Suite 303
 Buffalo, NY 14202
 716-845-5092

FOOD SERVICES


Hestman Group, LLC
 7645 E. 63rd St.
 Suite 201
 Tulsa, OK 74133
 918-935-5036



Chavez-Grievs
 consulting engineers, inc.
 4700 Lincoln Road NE, Suite 102, Albuquerque, NM 87109
 505-344-4080 / 505-343-8759 (fax)

CASINO 4

KEY PLAN

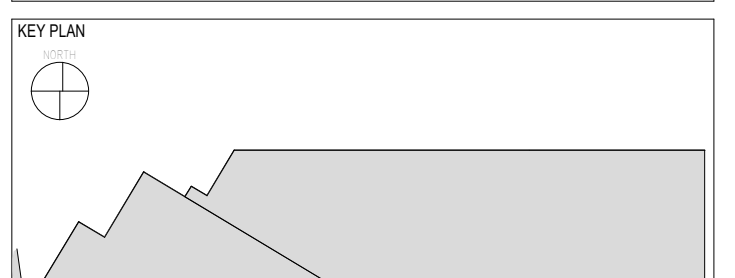

No.	Description	Date
3	ADDENDUM #4	05/16/2018
5	BULLETIN #2	06/14/2018



FRAMING DETAILS

CONSTRUCTION SET


PROJECT NO: 201704
 DRAWN BY: J ANDERSON
 CHECKED BY: C ROMERO
 ISSUE DATE: 5/4/2018

S-501


Scale: 3/4" = 1'-0"

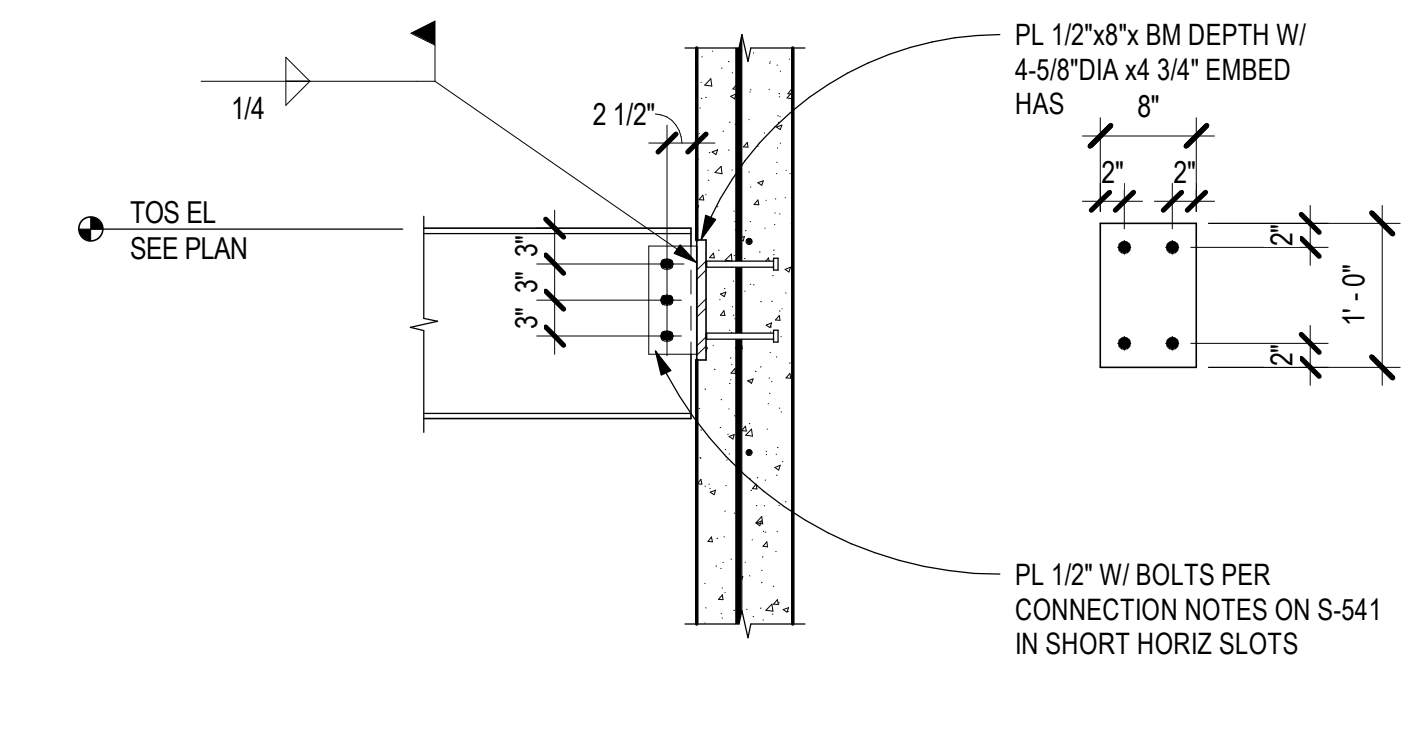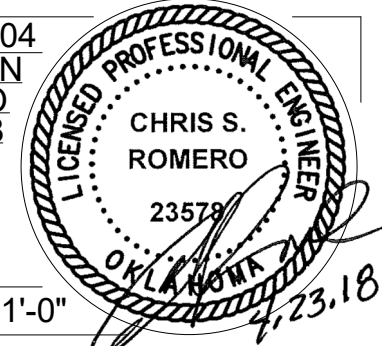


D5 BEAM TO CONC WALL DETAIL
 SCALE: 3/4" = 1'-0"

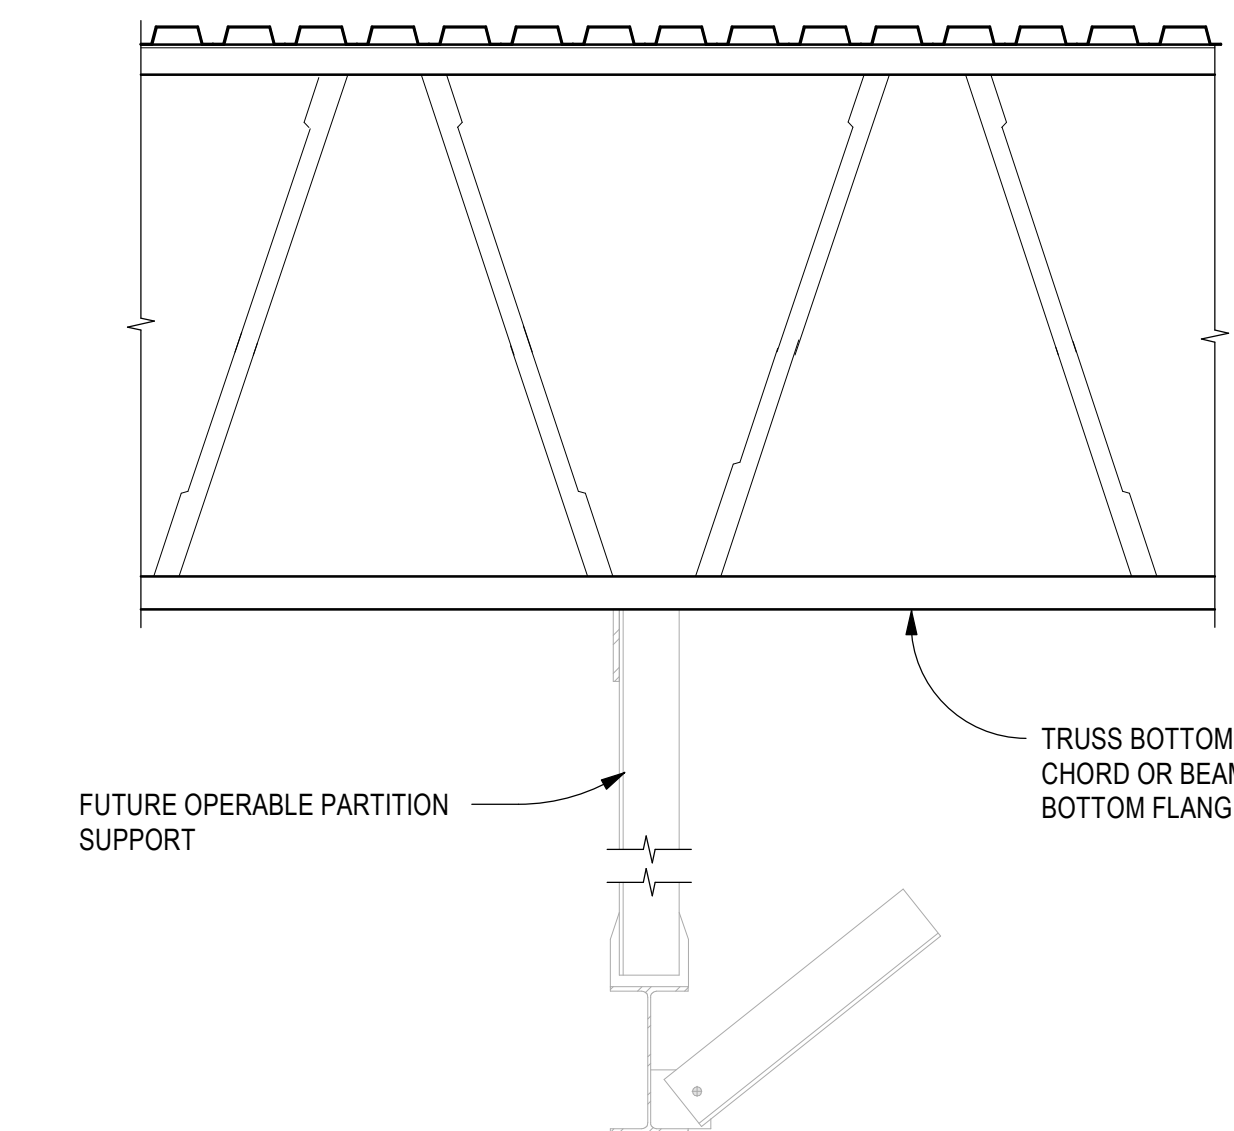

D4 HSS HANGER TO BEAM
 SCALE: 3/4" = 1'-0"

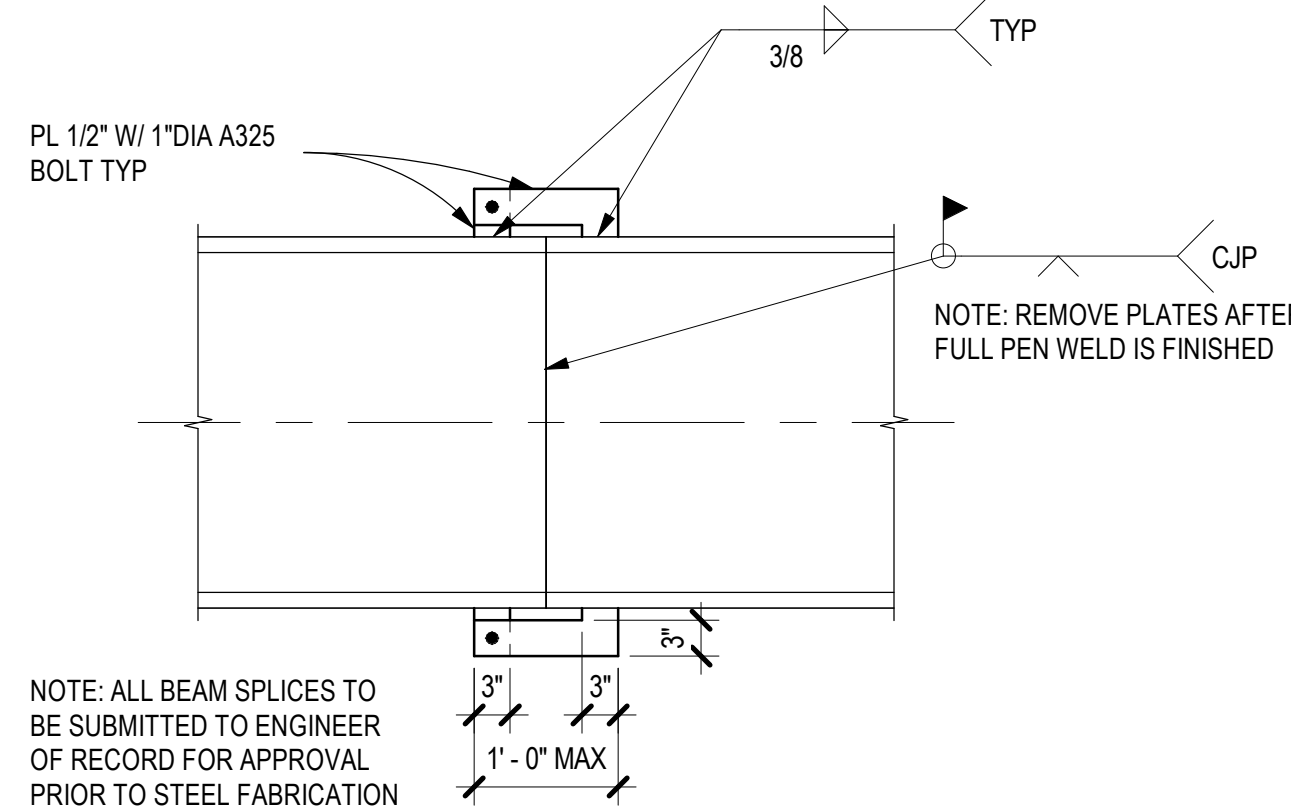


D3 BEAM AT DOOR CONNX
 SCALE: 3/4" = 1'-0"

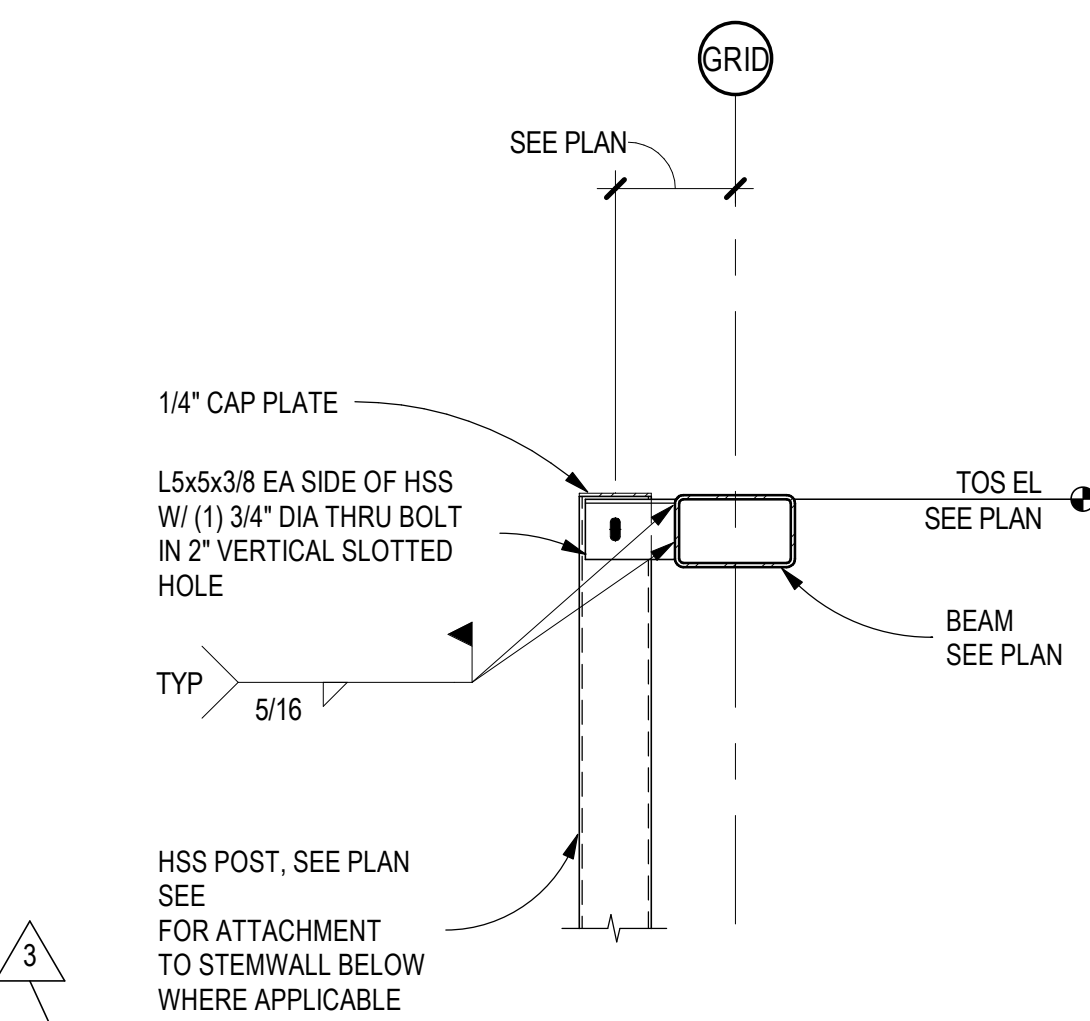


D4 WELDED BEAM SPLICE DETAIL
 SCALE: 3/4" = 1'-0"


D5 OPERABLE PARTITION SUPPORT DTL
 SCALE: 3/4" = 1'-0"

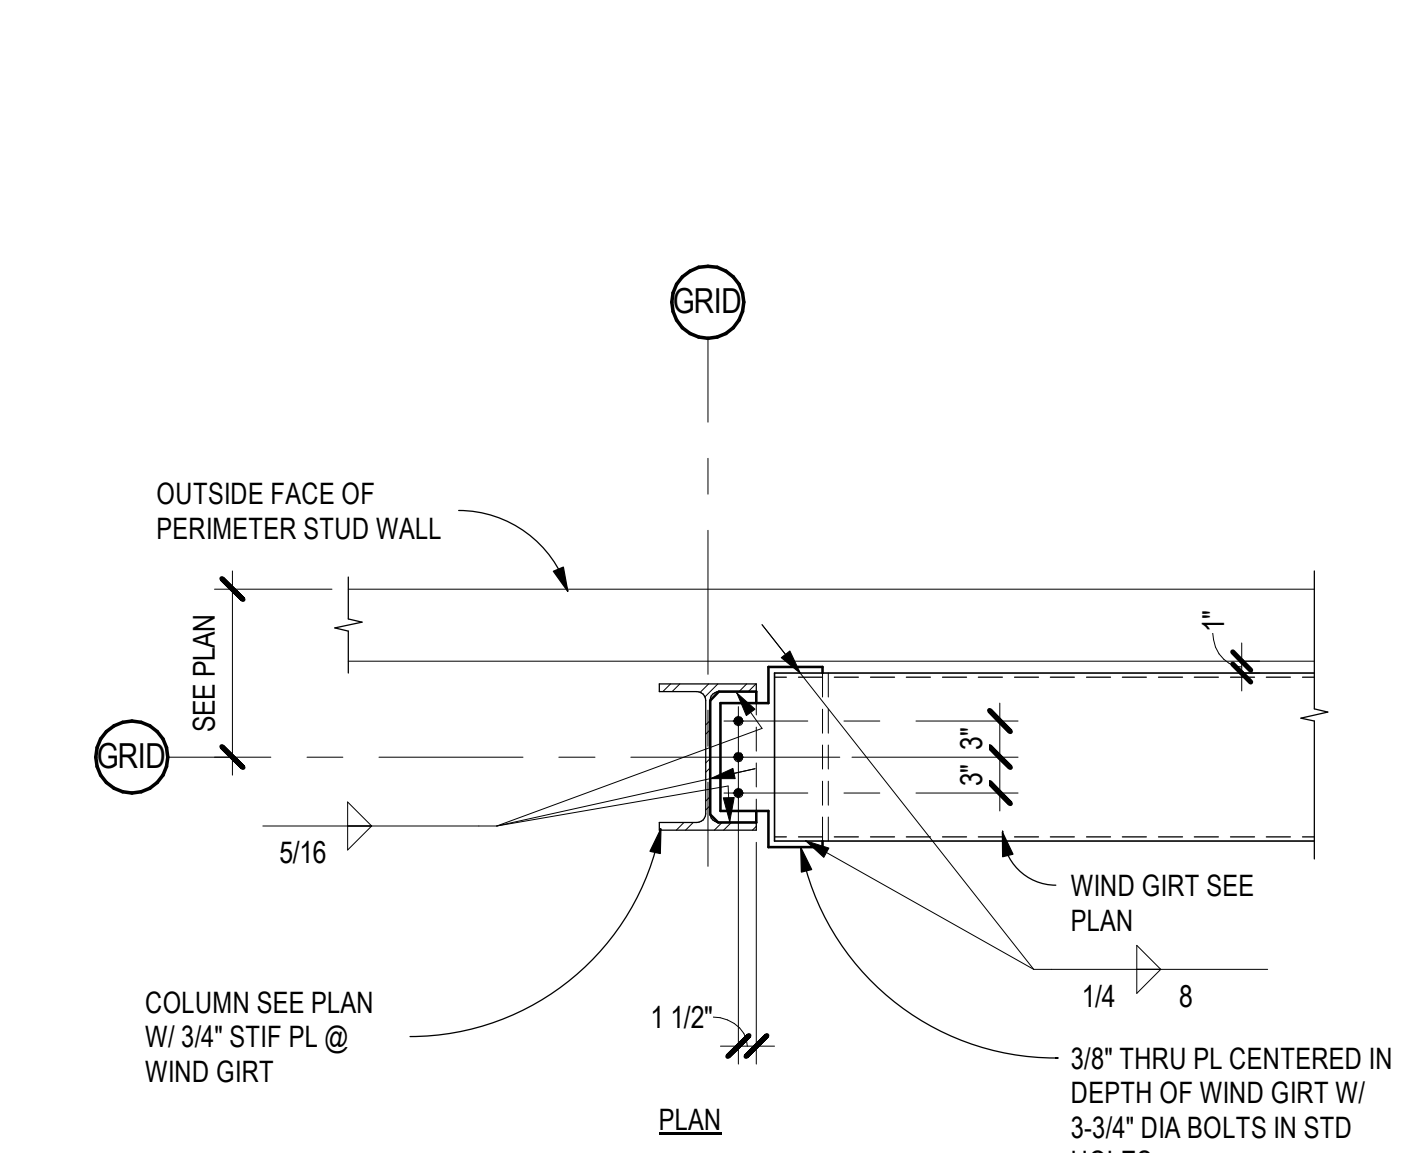


C3 TYPICAL POST TO ROOF BEAM CONN
 SCALE: 3/4" = 1'-0"

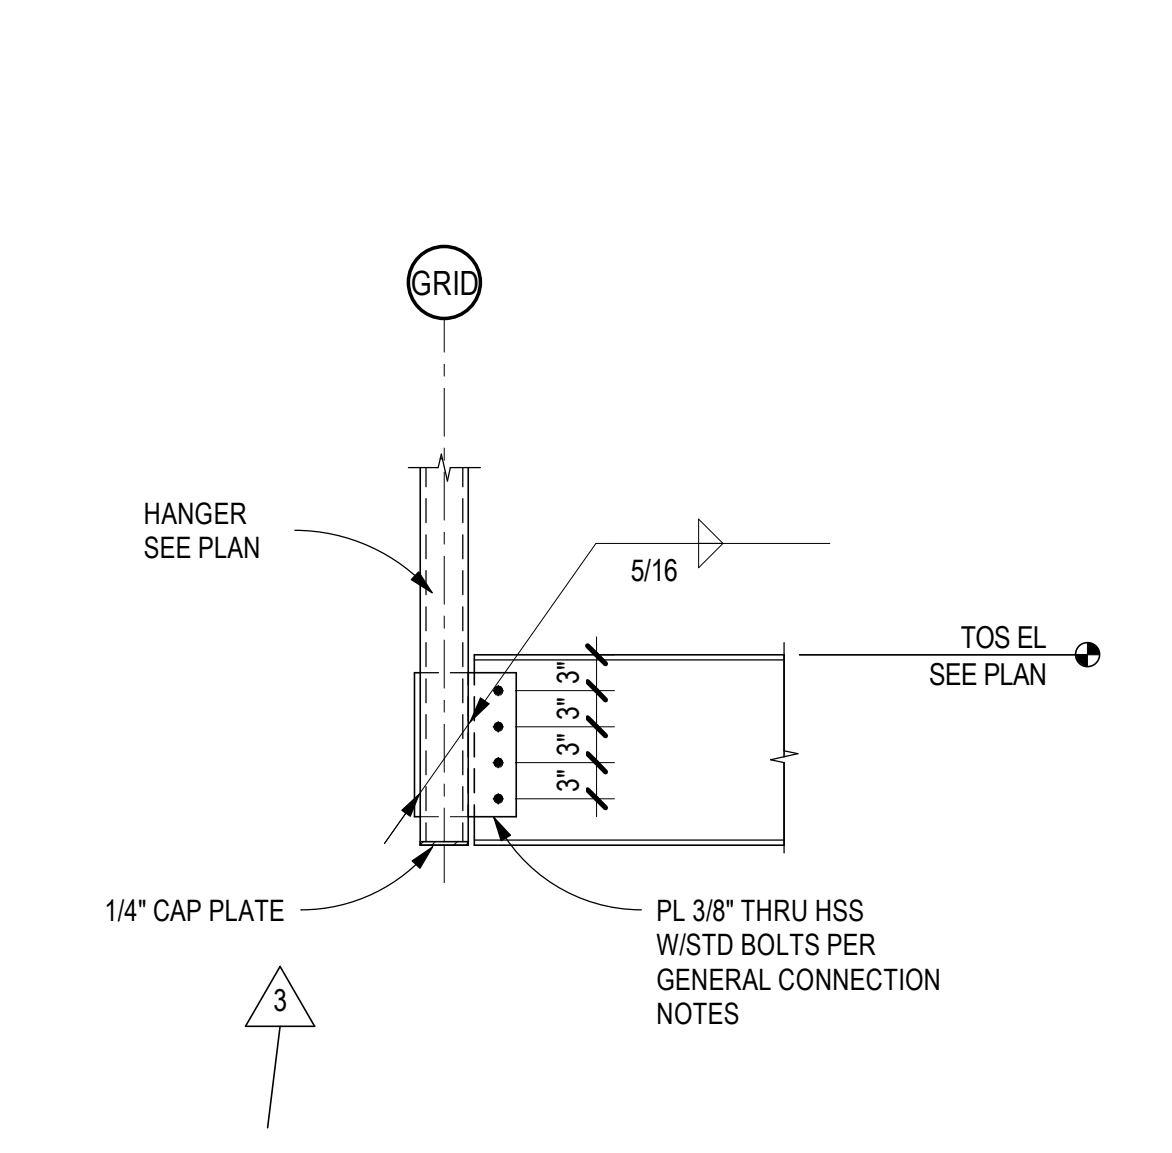


B4 NEW BEAM AND POST AT EXISTING
 SCALE: 3/4" = 1'-0"

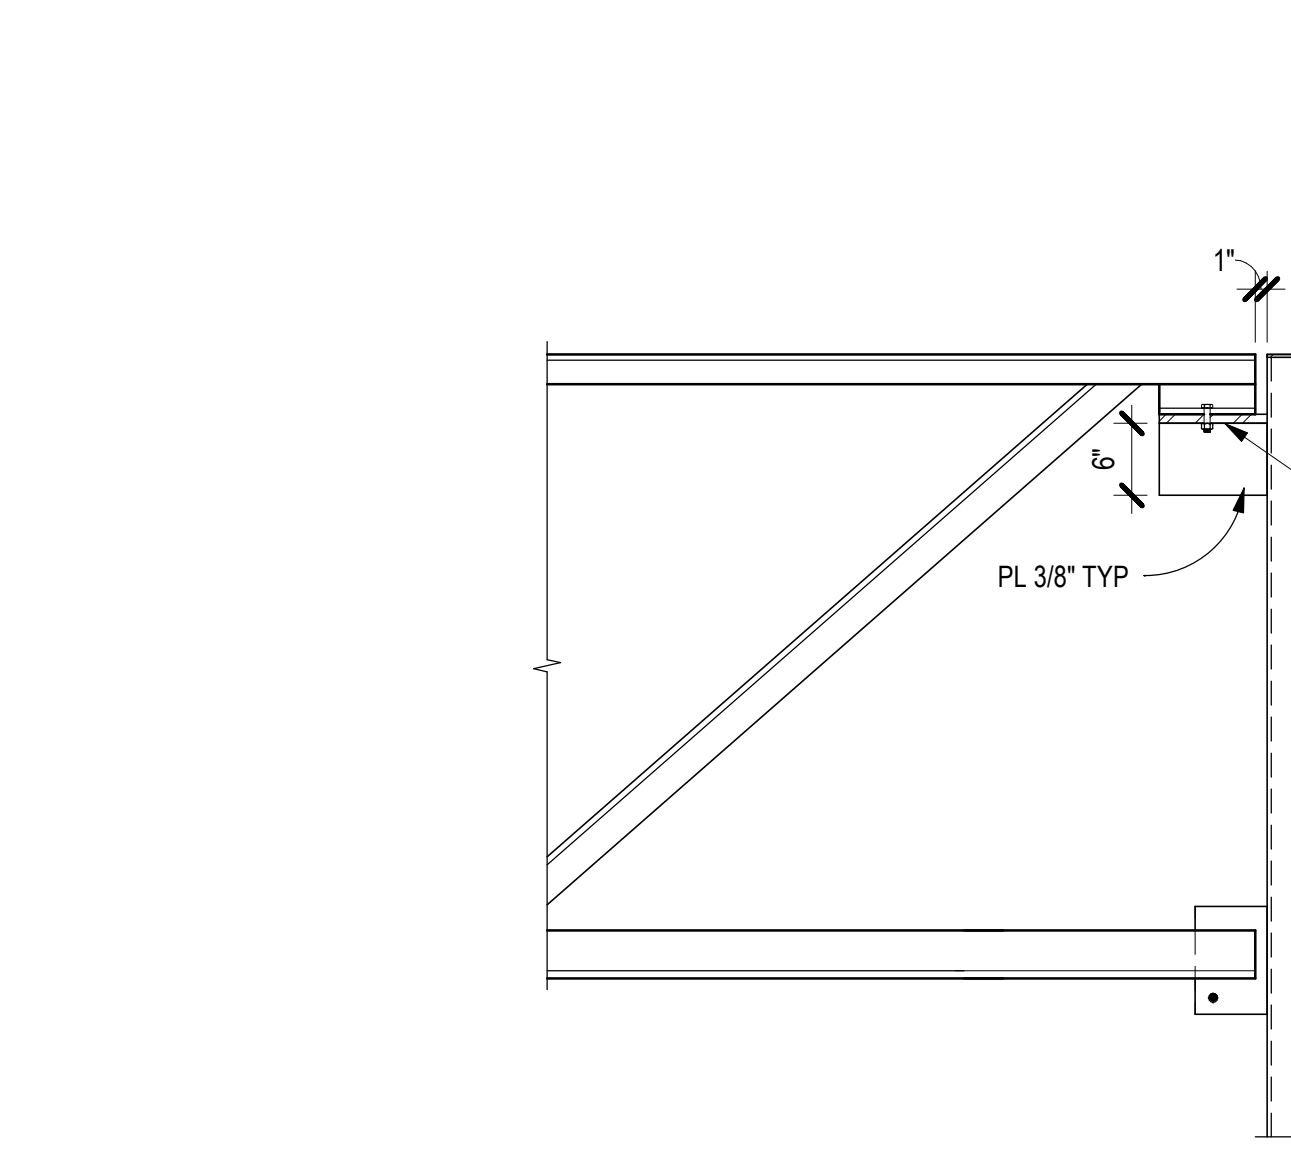


B3 STEEL BEAM TO HSS THRU PLATE
 SCALE: 3/4" = 1'-0"

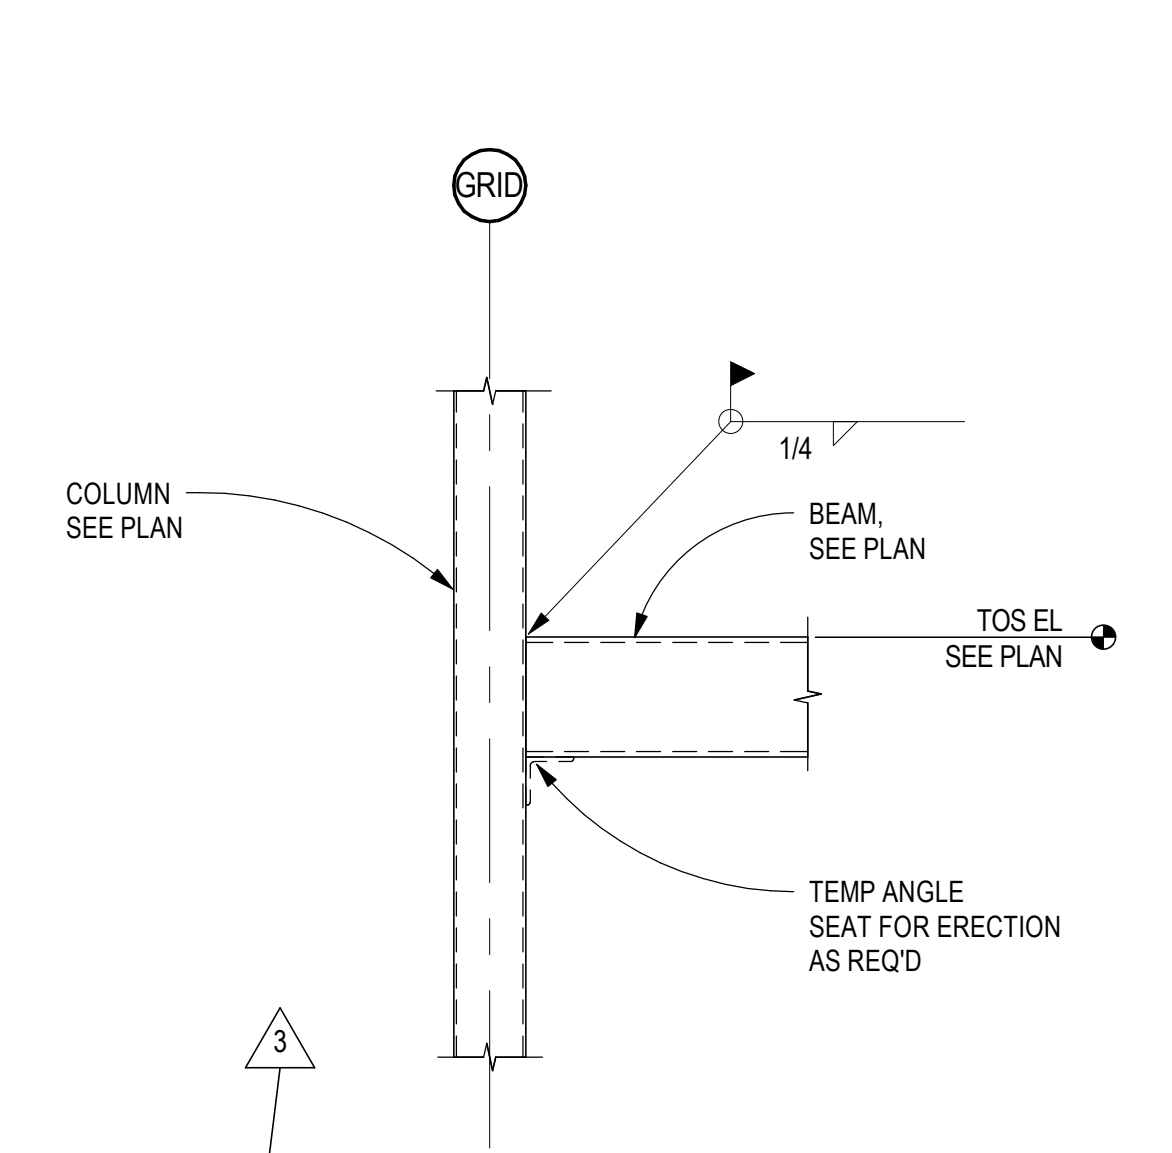


A4 JOIST GIRDERS TO HSS COL
 SCALE: 3/4" = 1'-0"

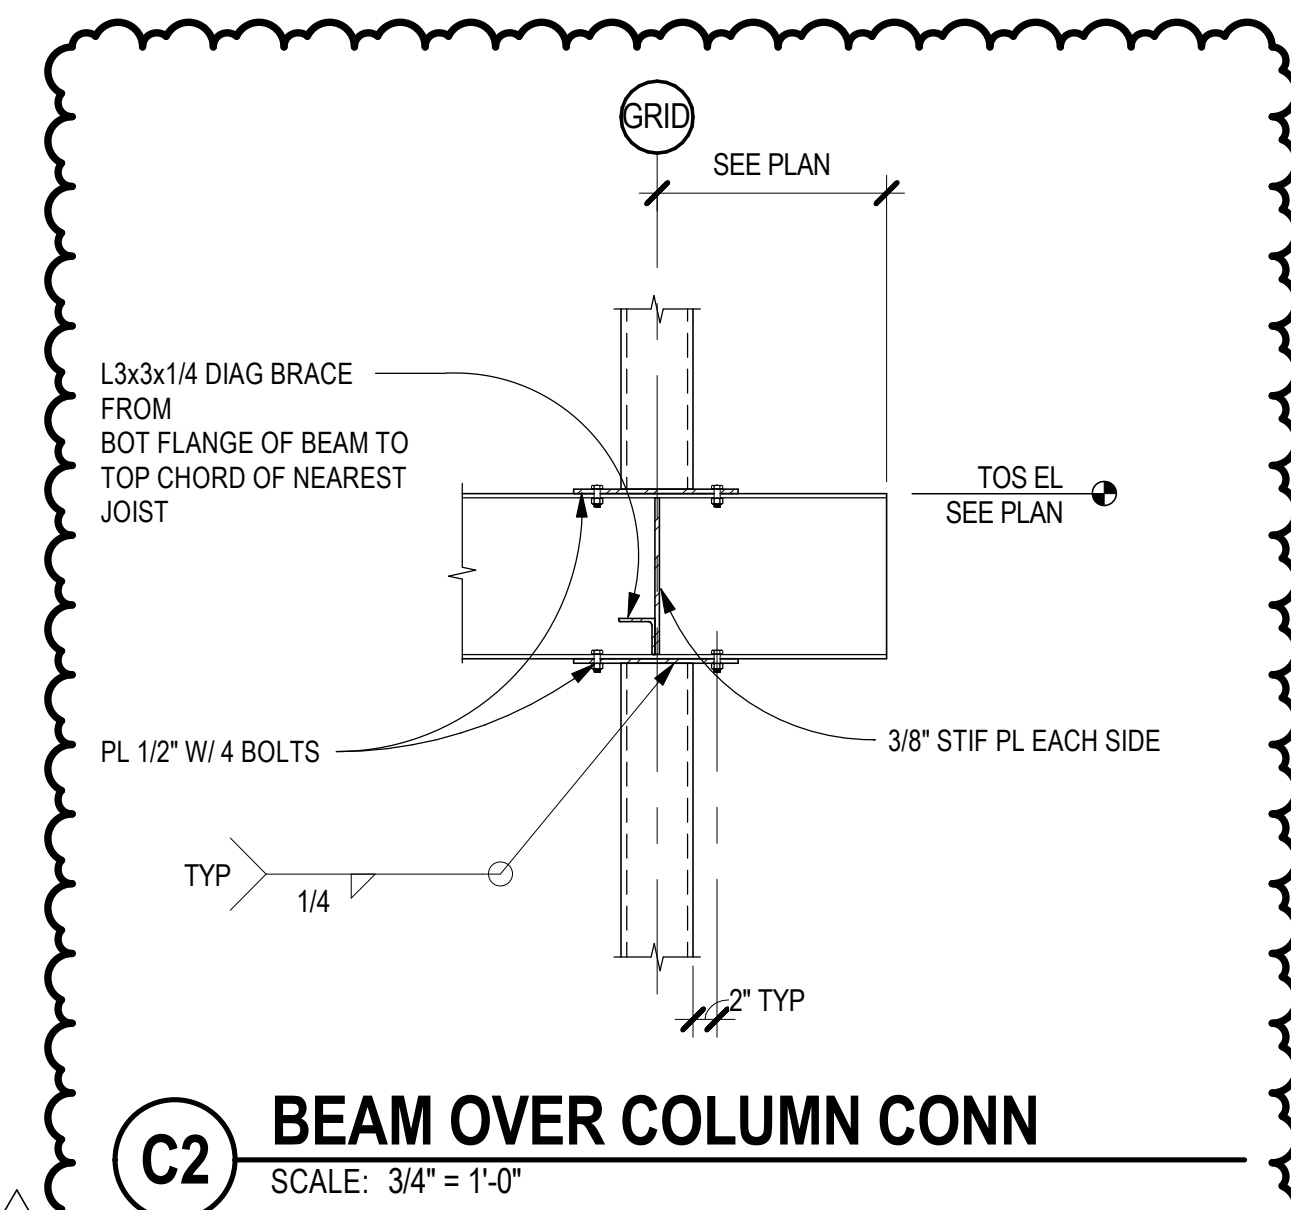


C2 BEAM OVER COLUMN CONN
 SCALE: 3/4" = 1'-0"

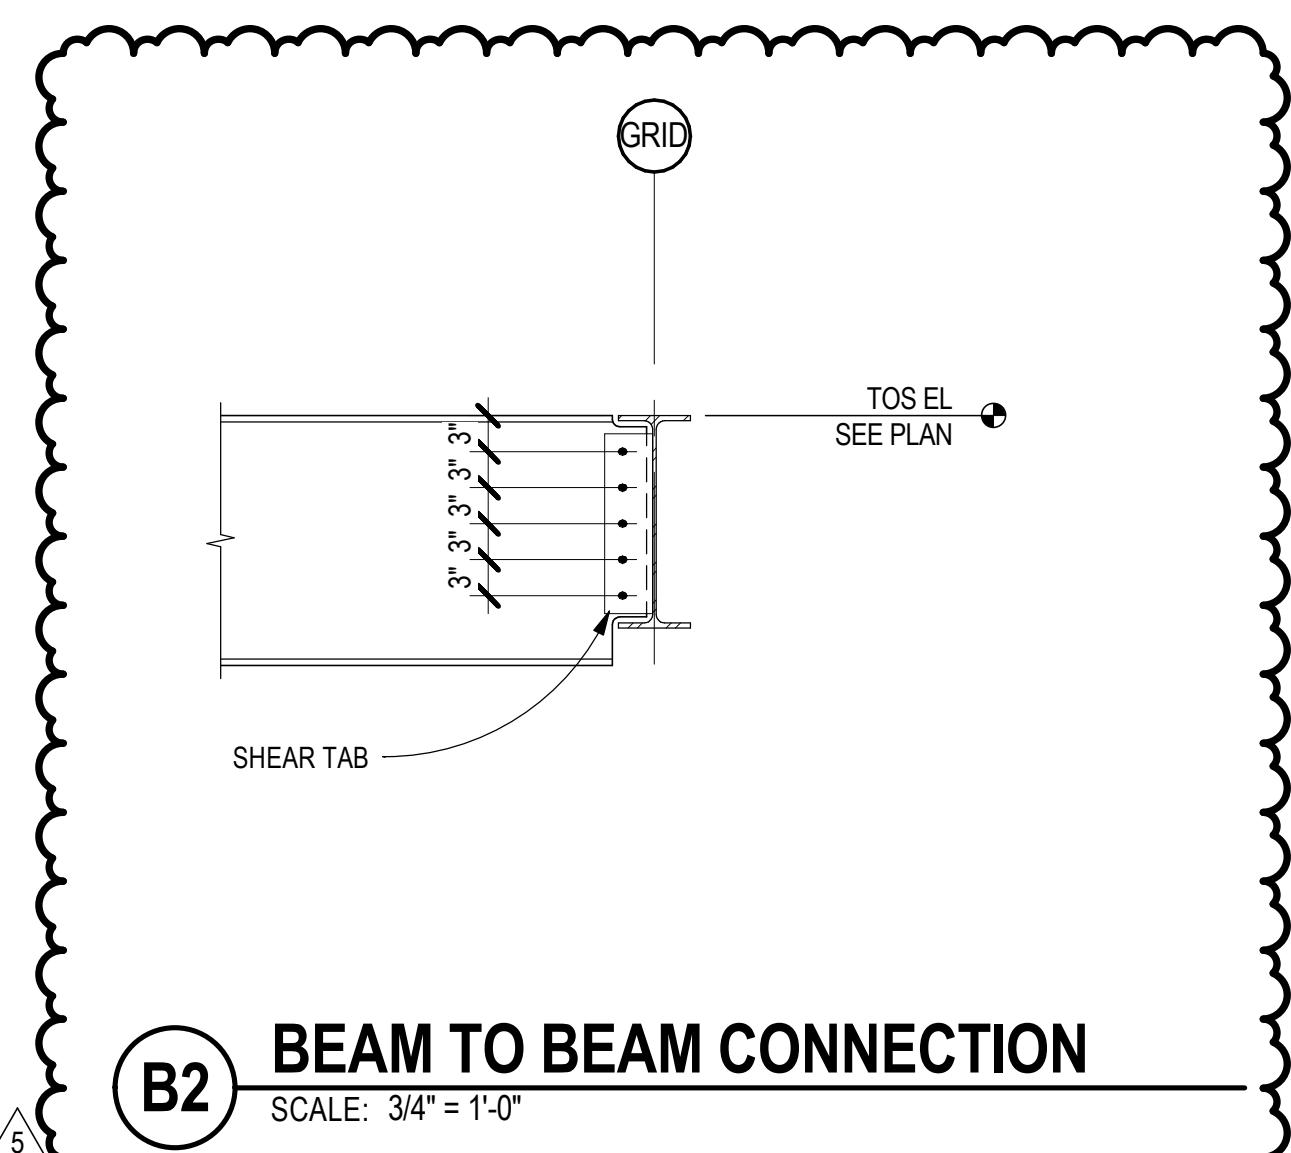


B2 BEAM TO BEAM CONNECTION
 SCALE: 3/4" = 1'-0"

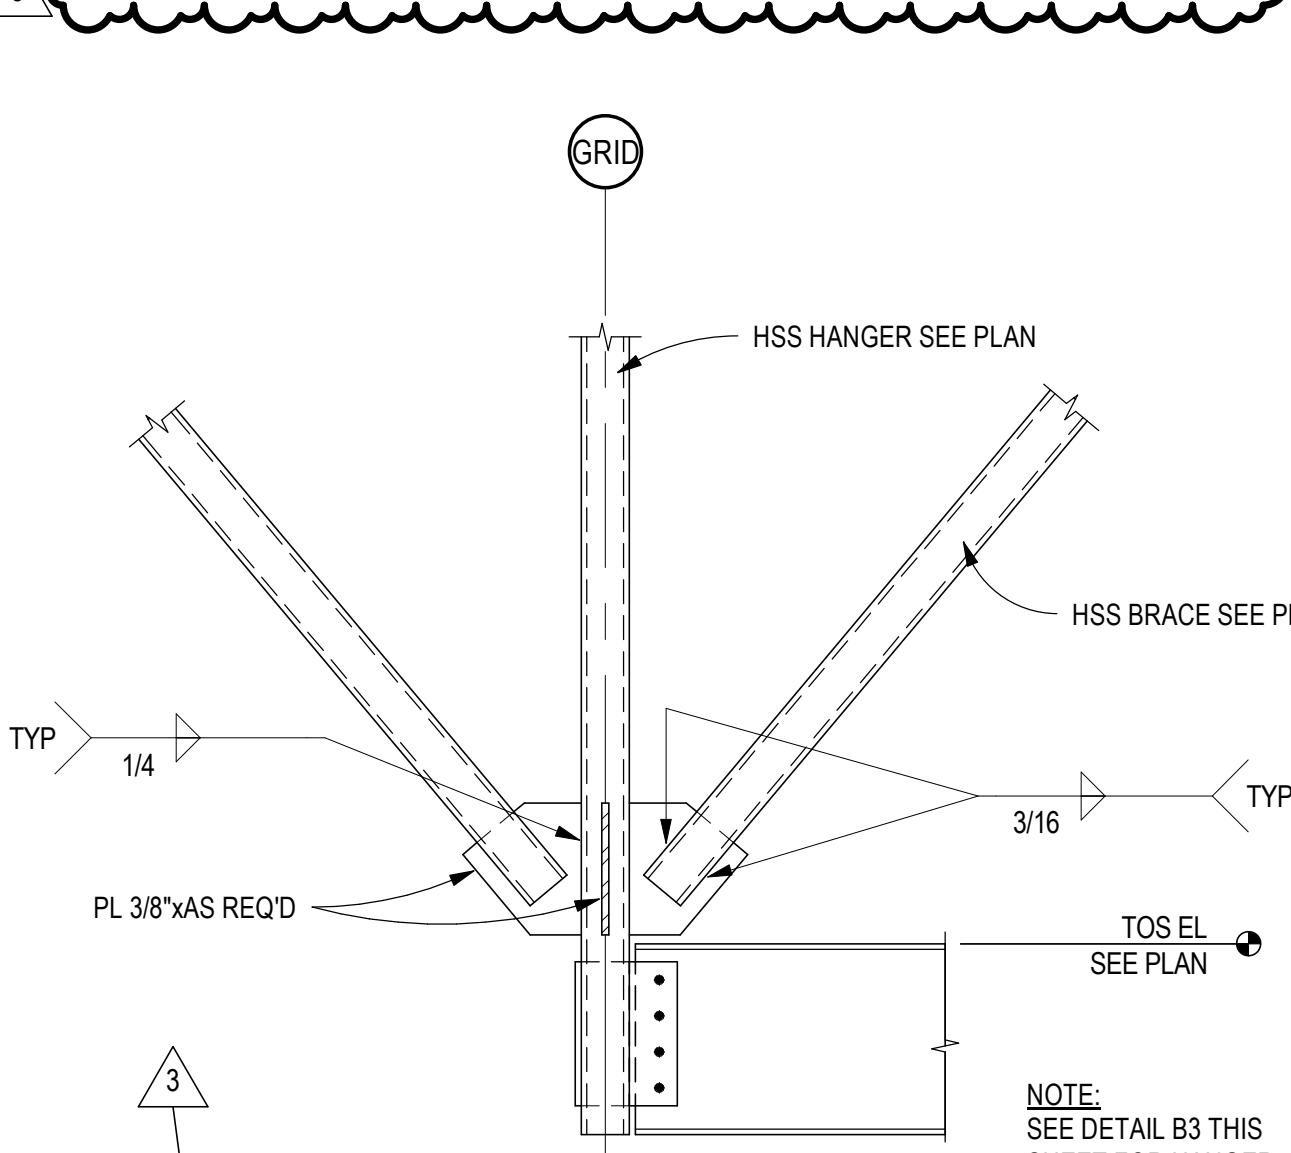

A2 BRACE DETAIL
 SCALE: 3/4" = 1'-0"

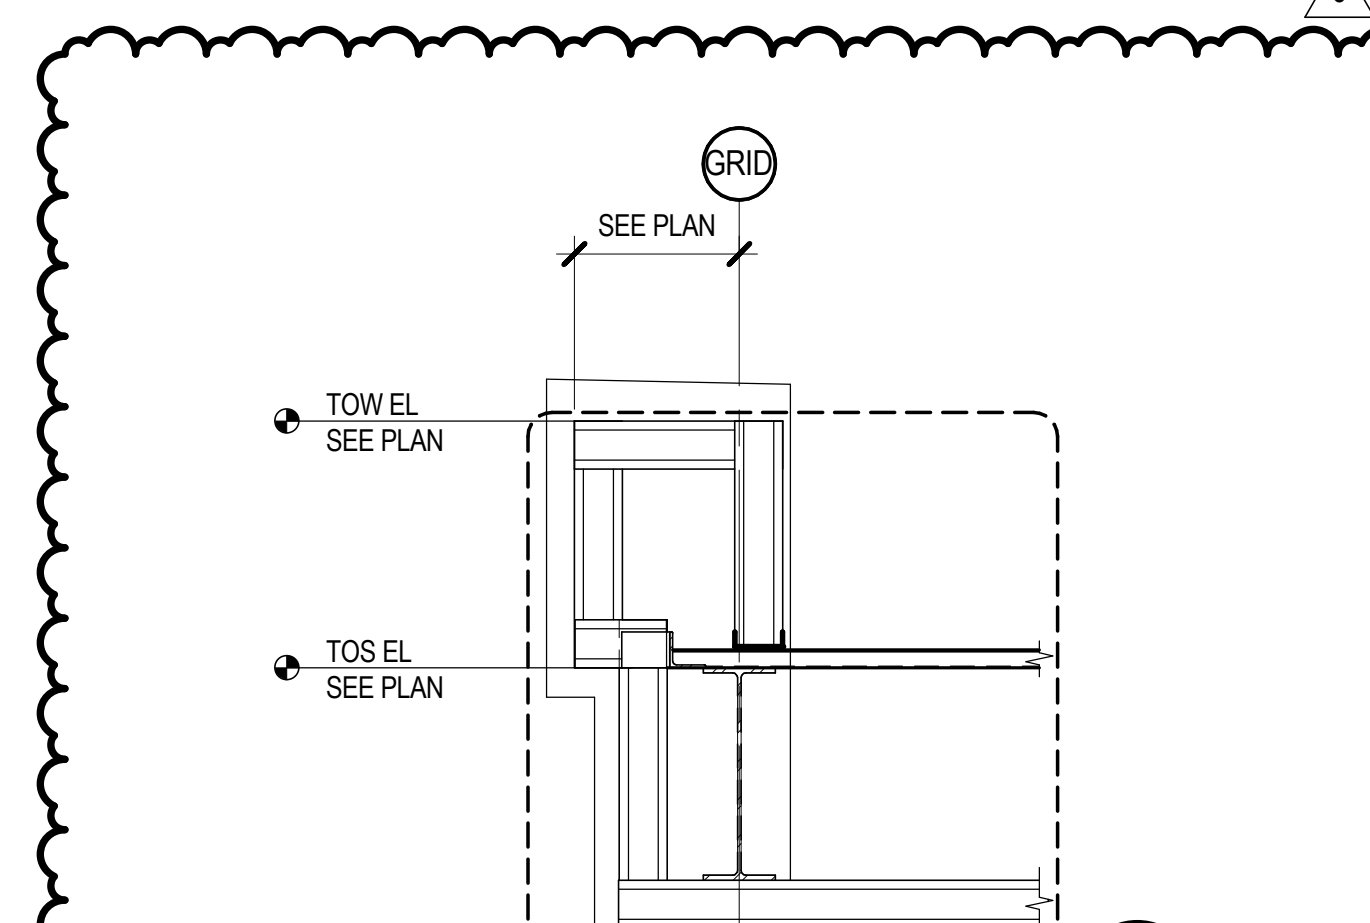

A1 ROOF FRAMING SECTION
 SCALE: 3/4" = 1'-0"

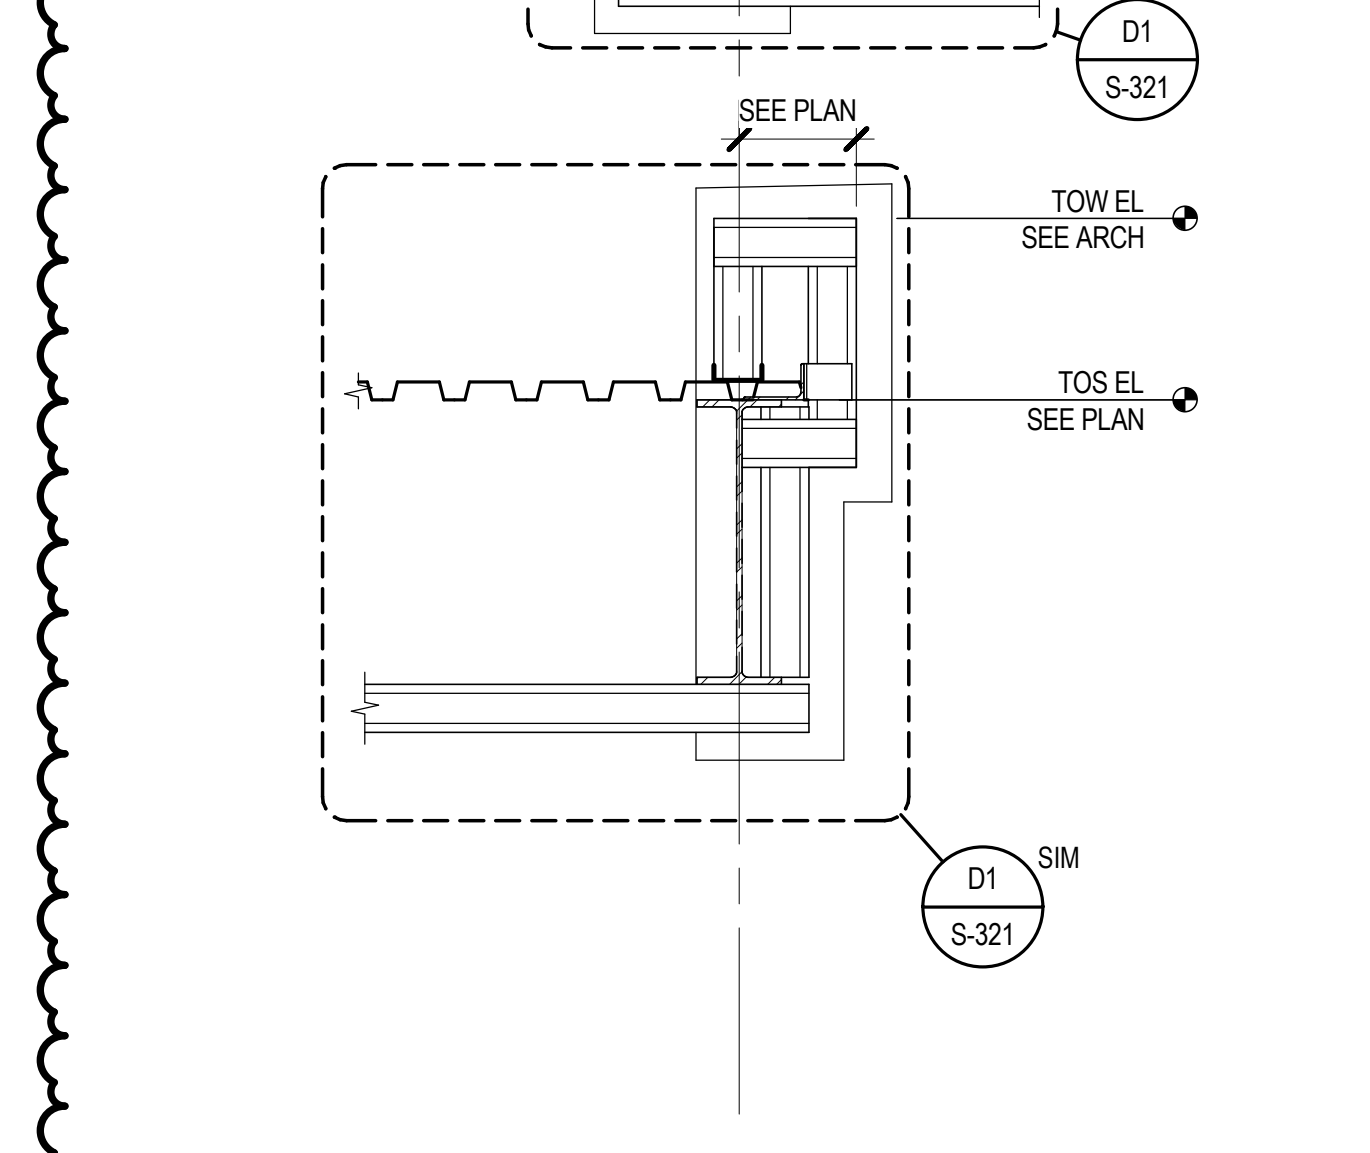

D1



CHEROKEE HARD ROCK CASINO 4

This document, and the ideas and designs incorporated herein, as an instrument of professional service, is the property of EDMONSON REED ASSOCIATES, and is not to be used, in whole or in part, for any other project, without the written authorization of EDMONSON REED ASSOCIATES.

INTERIOR ARCHITECTURE

JCI Architecture
 120 Hayslope Avenue
 Suite 400
 Hartford, CT 06106
 860-247-9226

STRUCTURAL ENGINEERING

Chavez-Grievos Consulting Engineers, Inc.
 4700 Lincoln Road NE
 Suite 102
 Albuquerque, NM 87109
 505-344-4080

MEP ENGINEERING

MSA Engineering Consultants
 370 E. Windmill Ln.
 Suite 100
 Las Vegas, NV 89123
 702-896-1100

CIVIL ENGINEERING / SURVEYING

Native Plans Surveying and Mapping /
 RK & Associates PLC
 5807 S. Garnett Rd.
 Suite K
 Tulsa, OK 74146
 918-234-7596

LOW VOLTAGE / THEME LIGHTING

M/E Engineering
 60 Lakewood Boulevard
 Suite 300
 Buffalo, NY 14202
 716-845-5092

FOOD SERVICES


Hestman Group, LLC
 7645 E. 63rd St.
 Suite 201
 Tulsa, OK 74133
 918-935-5036

CHEROKEE HARD ROCK CASINO 4



Chavez-Grievos
 consulting engineers, inc.
 4700 Lincoln Road NE, Suite 102, Albuquerque, NM 87109
 505-344-4080 / 505-343-9799 (fax)

CASINO 4

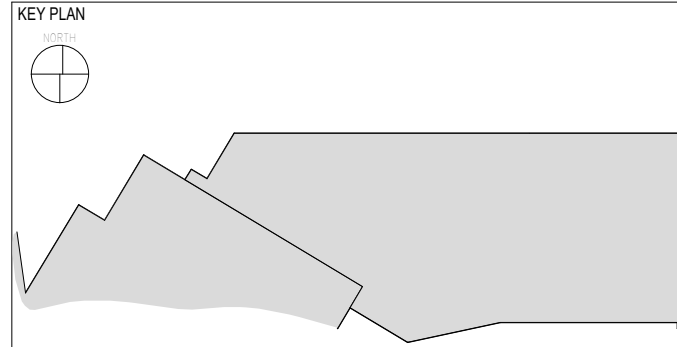



No.	Description	Date
2	ADDENDUM #2	05/04/2018
5	BULLETIN #2	06/14/2018

SCHEDULES

CONSTRUCTION SET


PROJECT NO: 201704
 DRAWN BY: J. ANDERSON
 CHECKED BY: C. ROMERO
 ISSUE DATE: 5/4/2018

S-602
 Scale: As indicated

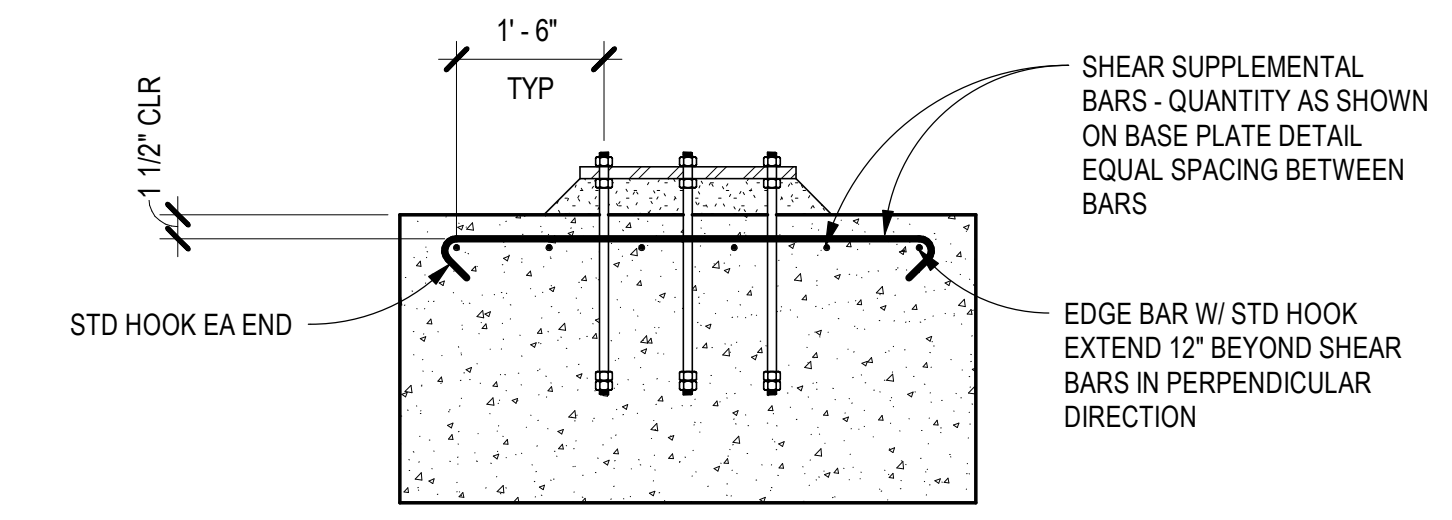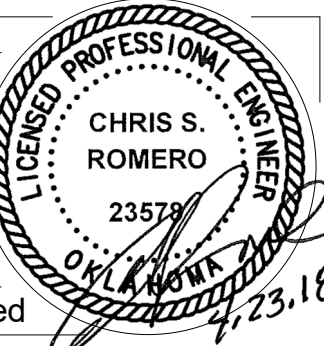

NOTE: ONLY SUPPLEMENTAL BARS ARE SHOWN FOR CLARITY

D5 SUPPLEMENTAL SHEAR BAR DETAIL
 SCALE: 3/4" = 1'-0"

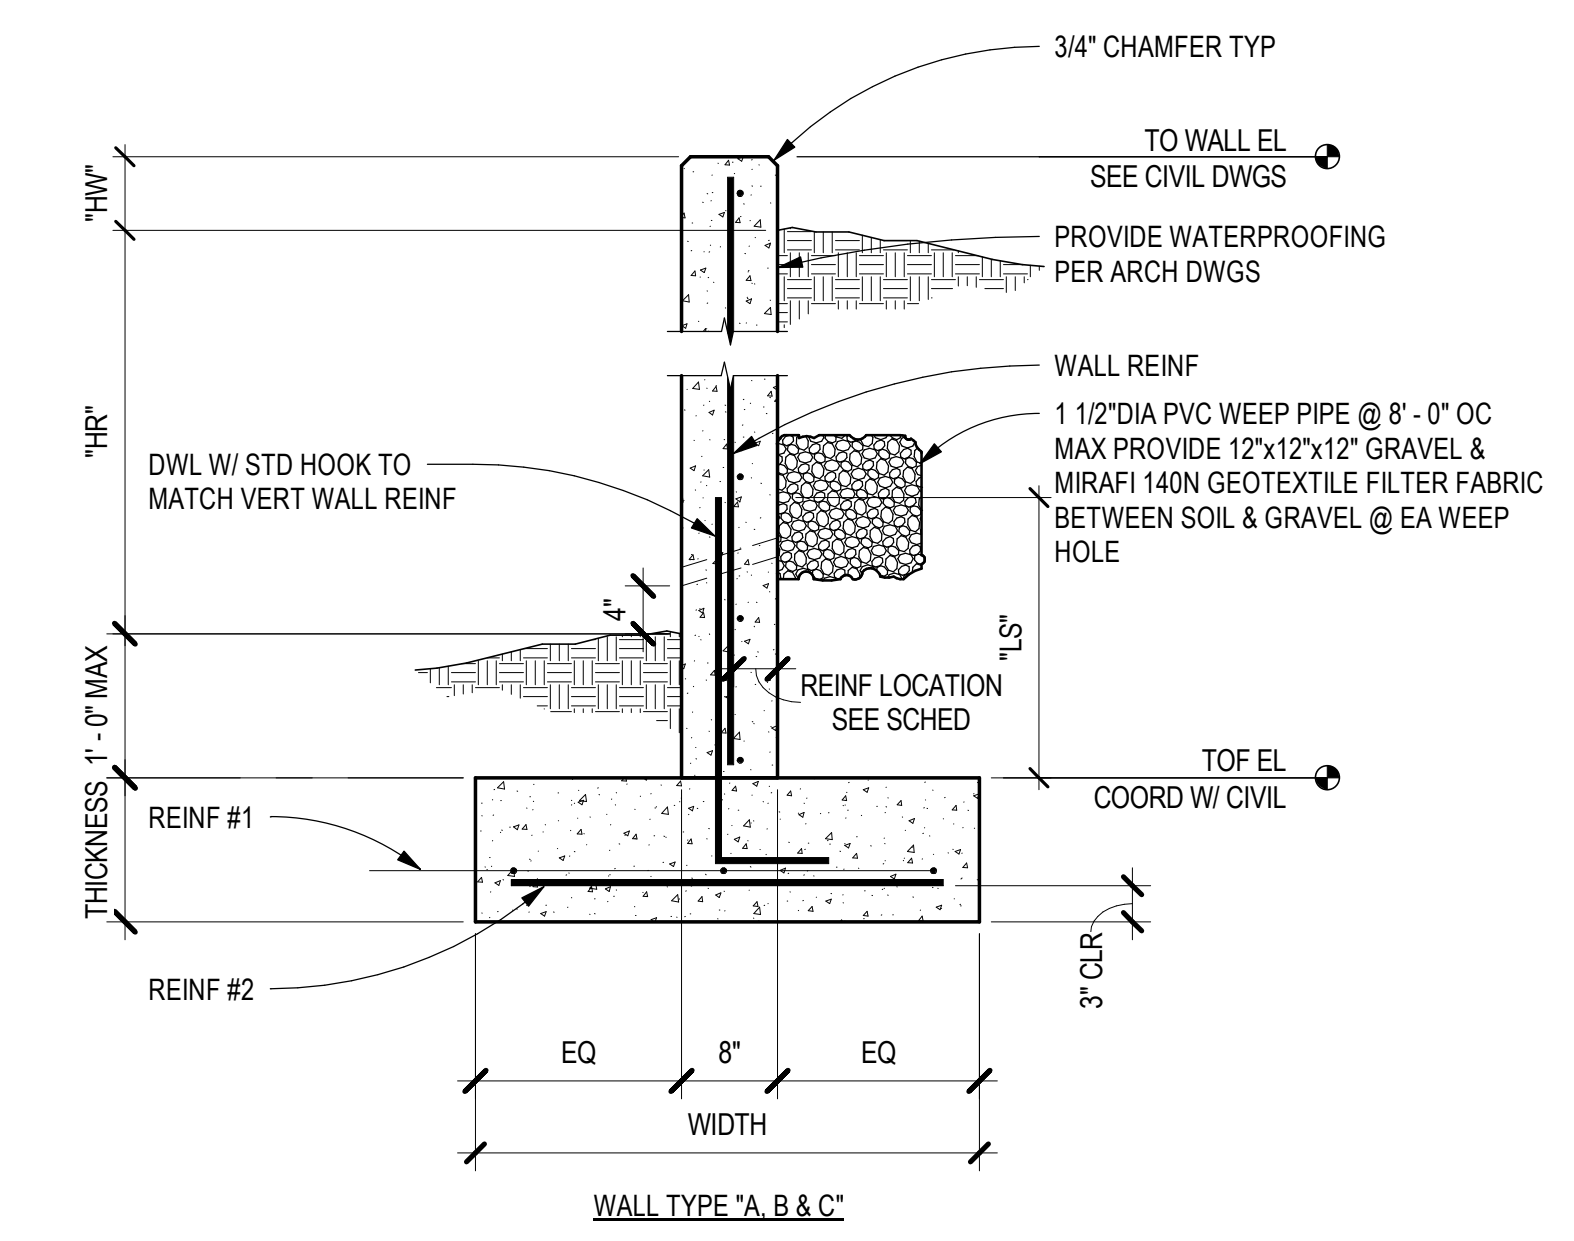


CONCRETE SITE RETAINING WALL SCHEDULE										
WALL TYPE	WALL HEIGHT ABOVE GRADE "HR"		FOOTING SIZE		FOOTING REINFORCING		WALL REINFORCING			SPLICE LENGTH "LS"
	FT-IN	FT-IN	FT-IN	FT-IN	NUMBER - SIZE	SIZE - SPACING	VERT SIZE - SPACING	HORIZ SIZE - SPACING	REIN LOCATION	
A	0'-0" - 0'-6"	0'-0" - 4'-0"	2'-6"	1'-0"	3 - #5 CONT	#4 @ 48" OC	#4 @ 18" OC	#4 @ 12" OC	4"	24"
B	0'-0" - 3'-6"	0'-0" - 5'-0"	3'-6"	1'-0"	3 - #5 CONT	#4 @ 48" OC	#4 @ 14" OC	#4 @ 12" OC	4"	24"
C	0'-0" - 0'-6"	4'-1" - 7'-0"	5'-0"	1'-0"	5 - #5 CONT T&B	#5 @ 24" OC T&B	#5 @ 10" OC	#4 @ 12" OC	4"	36"


NOTE:
 COORDINATE EXACT LOCATION AND EXTENT OF WALL WITH ARCHITECTURAL AND CIVIL DWGS.
 PROVIDE CONCRETE WALL VERTICAL CONTROL JOINTS AT (2) TIMES THE WALL HEIGHT AND AT ALL STEPS IN TOP OF WALL. SEE DETAIL C2S7.11 FOR CONTROL JOINT INFORMATION.

C3 TYPICAL CONCRETE SITE RETAINING WALL SCHEDULE AND DETAIL
 SCALE: NTS


BASE PLATE SCHEDULE				
MARK	TYPE	SIZE	ANCHOR BOLTS	TYPE
BP1	A	PL 3/4"x18"x1'-4"	4 - 3/4" DIA x 12"	1
BP2	B	PL 3/4"x18"x1'-6"	4 - 3/4" DIA x 12"	1
BP3	A	PL 3/4"x18"x1'-6"	4 - 3/4" DIA x 12"	1
BP4	A	PL 1"x18"x1'-6"	4 - 3/4" DIA x 12"	1
BP5	B	PL 1"x18"x1'-6"	4 - 3/4" DIA x 12"	1
BP6	A	PL 1 1/4"x18"x1'-6"	4 - 3/4" DIA x 12"	1
BP7	A	PL 3/4"x20"x1'-8"	4 - 3/4" DIA x 12"	1
BP8	A	PL 1"x22"x1'-10"	4 - 3/4" DIA x 12"	1
BP9	B	PL 1"x22"x1'-10"	4 - 3/4" DIA x 12"	1
BP10	G	PL 1"x24"x1'-10"	4 - 1 1/4" DIA x 12"	1
BP11	G	PL 1 1/4"x24"x1'-8"	4 - 1 1/4" DIA x 12"	1
BP12	D	PL 1"x18"x1'-6"	4 - 1" DIA x 12"	1
BP13	D	PL 1"x14"x1'-2"	4 - 1" DIA x 12"	1
BP14	C	PL 1 3/4"x24"x1'-10"	6 - 1 1/2" DIA x 12"	1
BP15	G	PL 1"x18"x1'-6"	4 - 1 1/4" DIA x 12"	1
BP16	G	PL 1 1/4"x20"x1'-8"	4 - 1 3/4" DIA x 12"	1
BP17	D	PL 1 1/4"x18"x1'-8"	4 - 1" DIA x 12"	1
BP18	E	PL 1"x18"x1'-8"	4 - 1" DIA x 12"	1
BP19	H	PL 1"x18"x1'-8"	4 - 1" DIA x 12"	1
BP20	F	PL 1 1/4"x18"x1'-8"	8 - 1" DIA x 12"	1
BP21	A	PL 3/4"x18"x1'-6"	4 - 3/4" DIA x 5"	2
BP23	J	PL 1 1/4"x20"x1'-8"	8 - 1" DIA x 12"	1

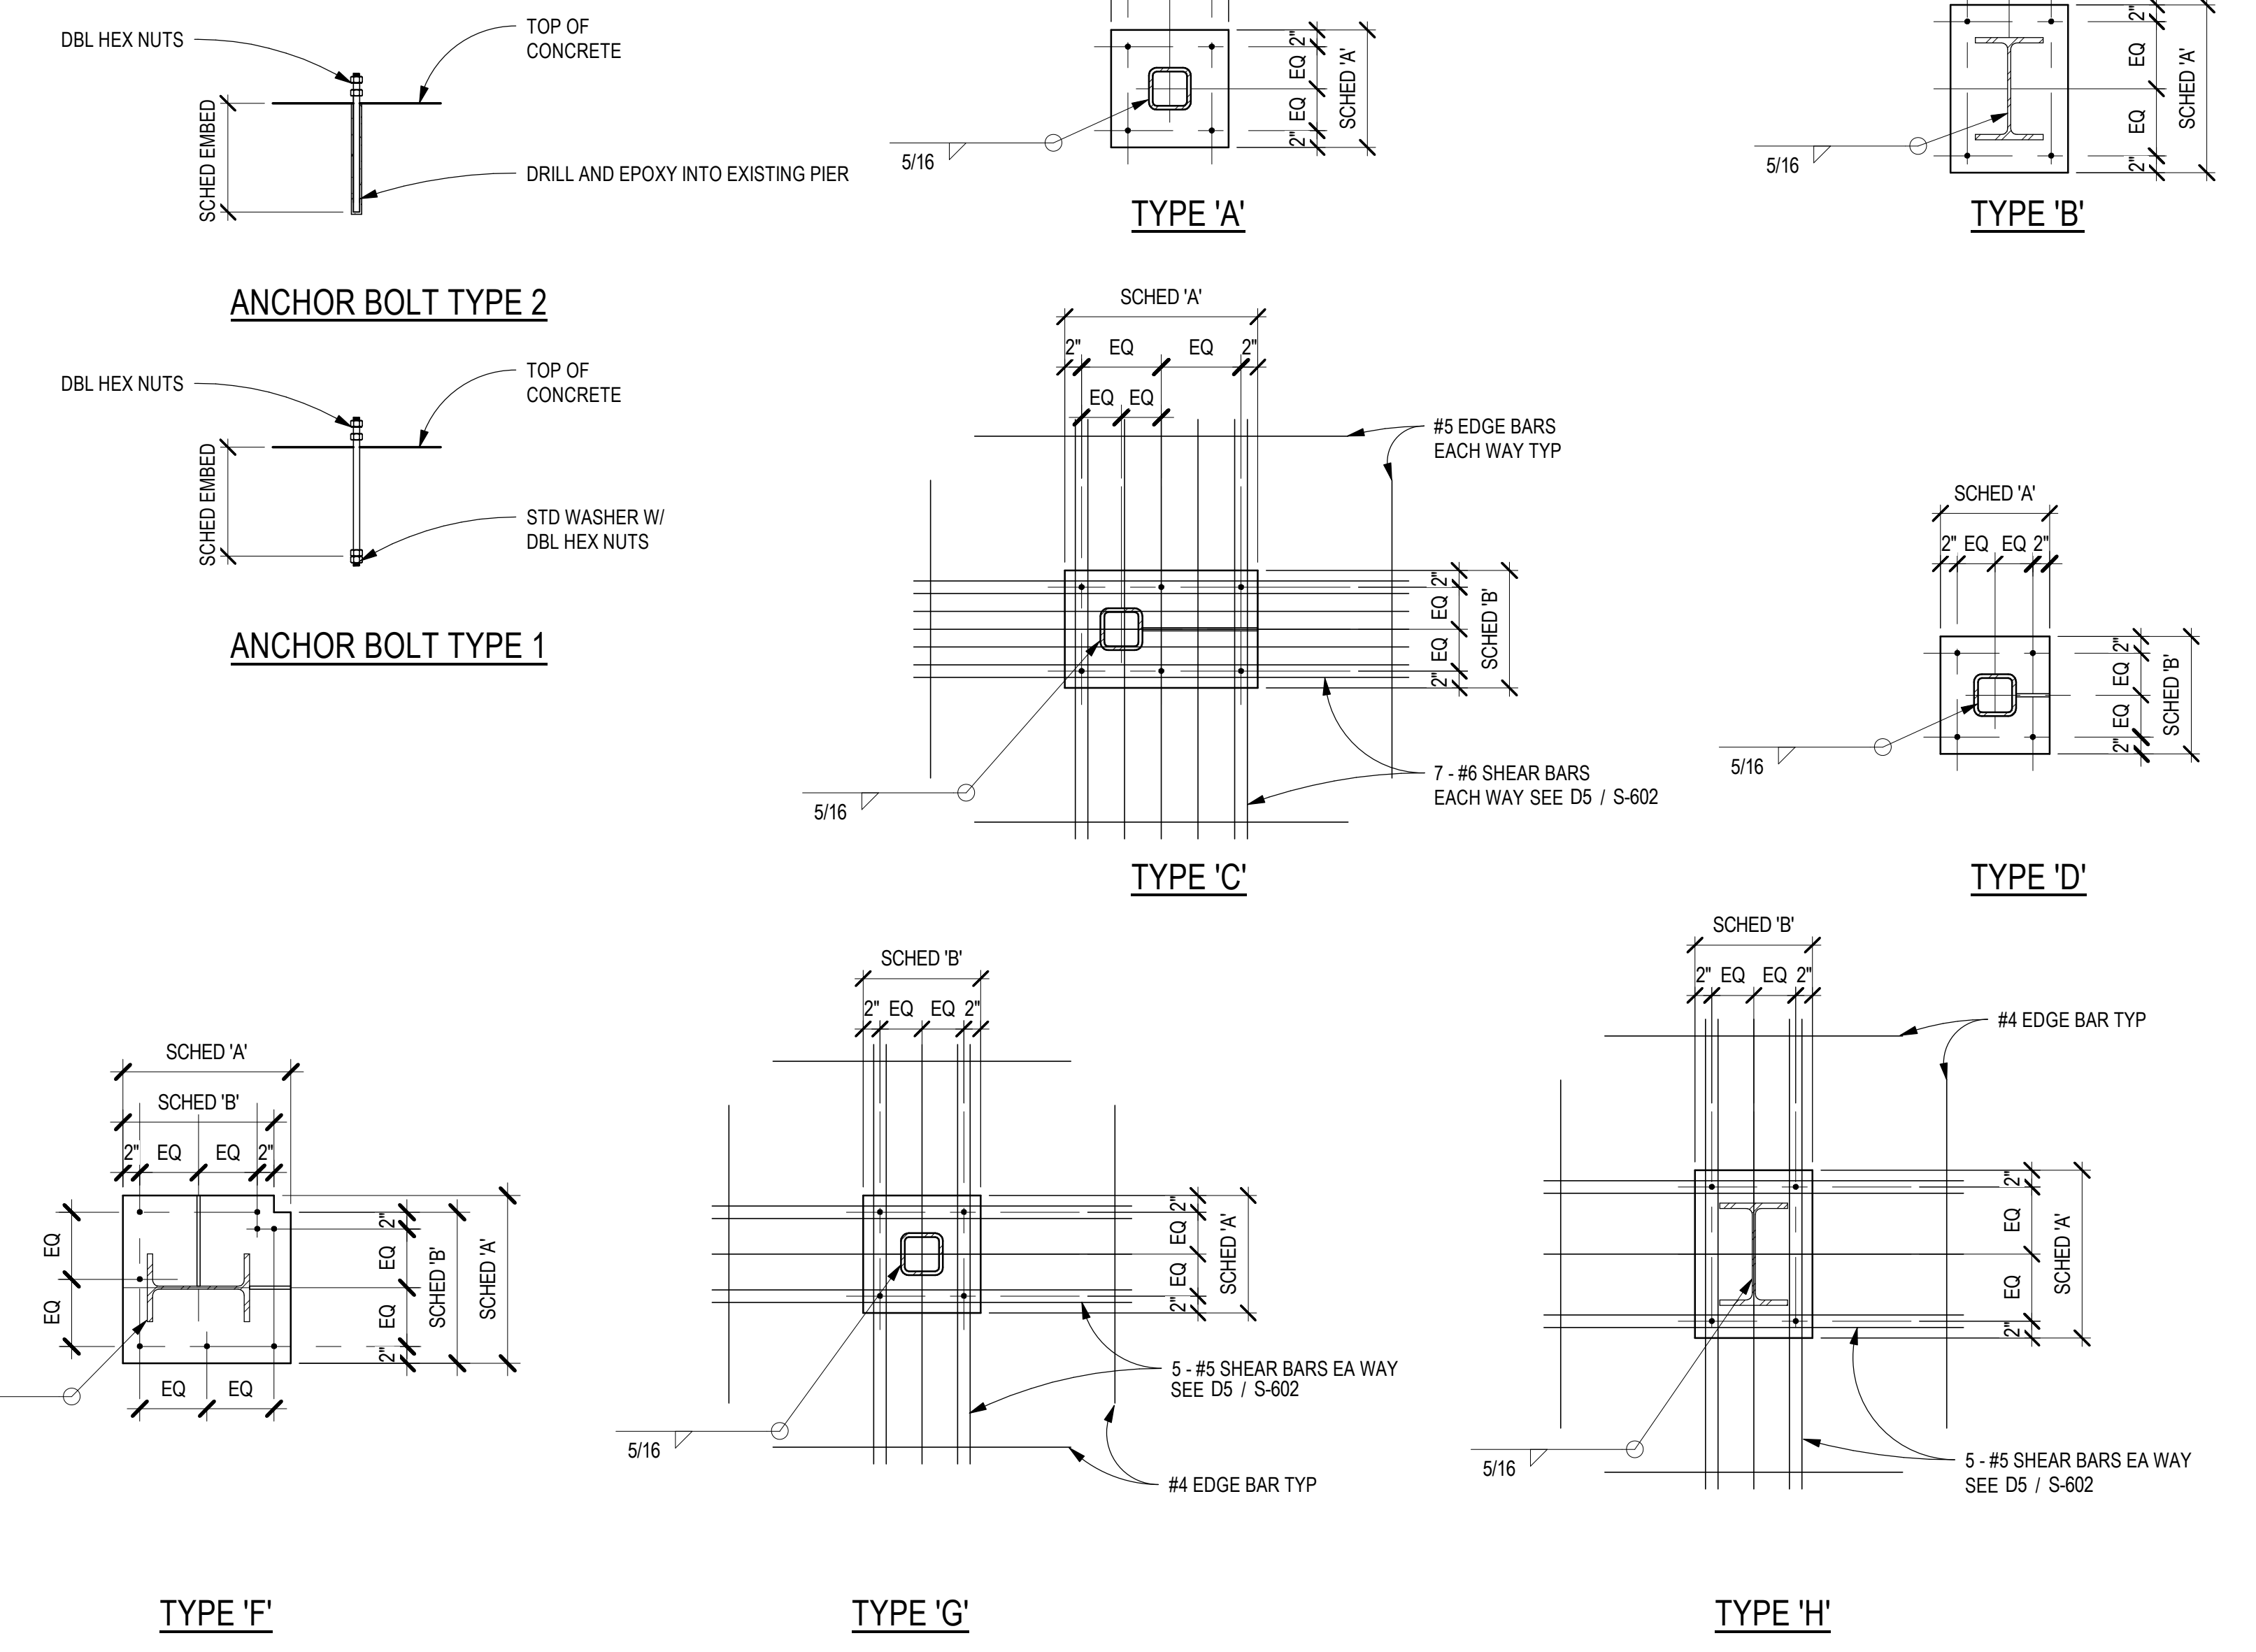


A4 BASE PLATE TYPES - SCHEDULE AND DETAILS
 SCALE: NTS

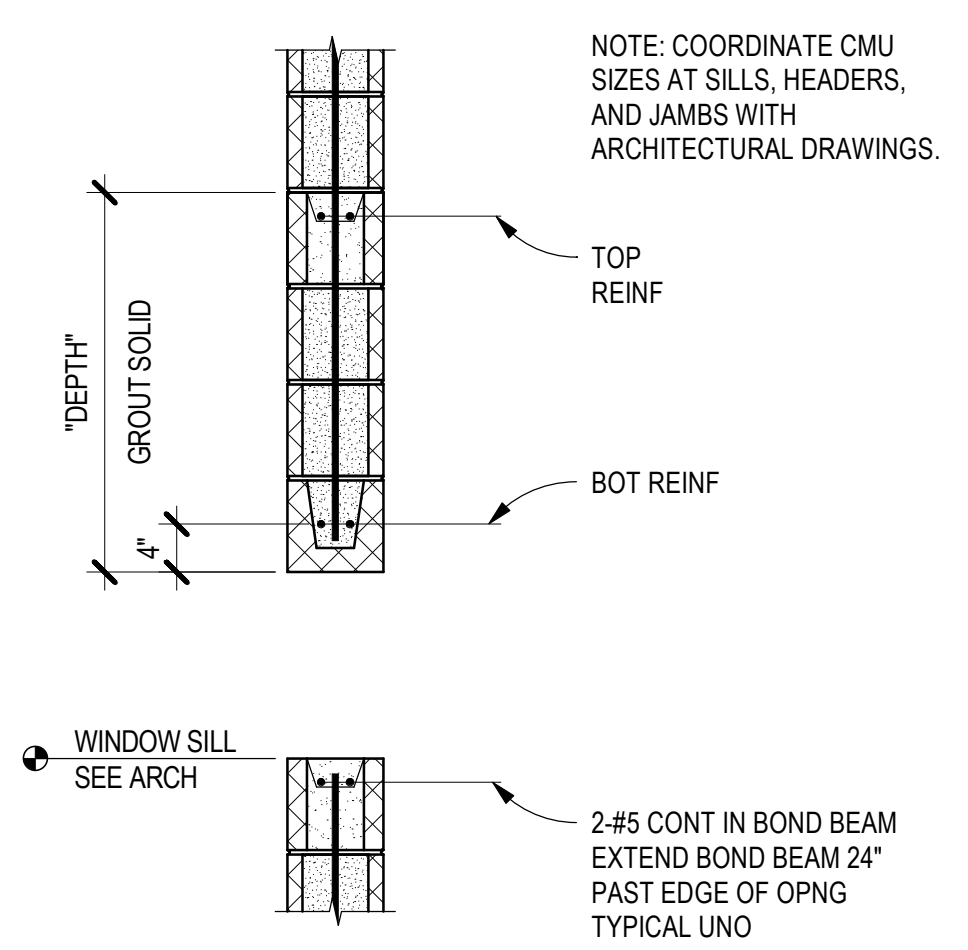

B3 TYPICAL CMU LINTEL SECTION
 SCALE: 3/4" = 1'-0"

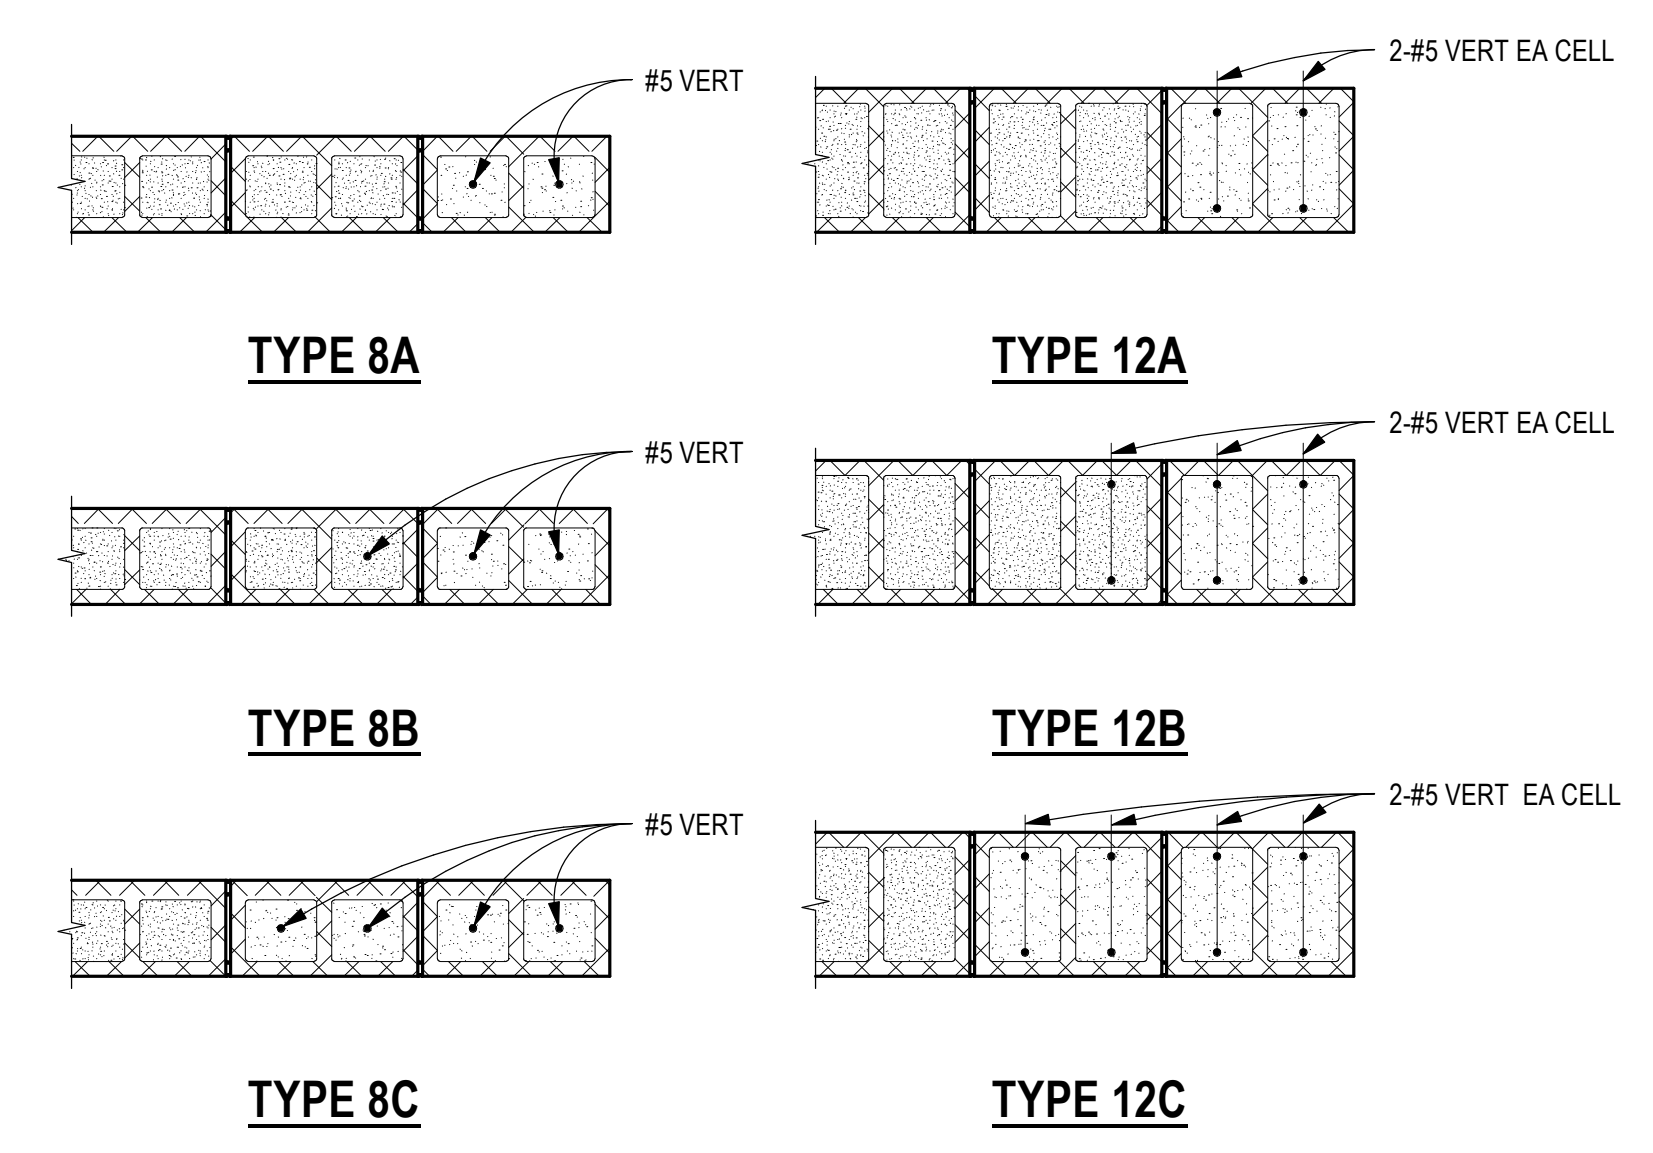

NOTE: SEE TYPICAL CMU PLAN DETAILS SHEET S-711 FOR TYPICAL HORIZONTAL REINFORCING REQUIREMENTS.

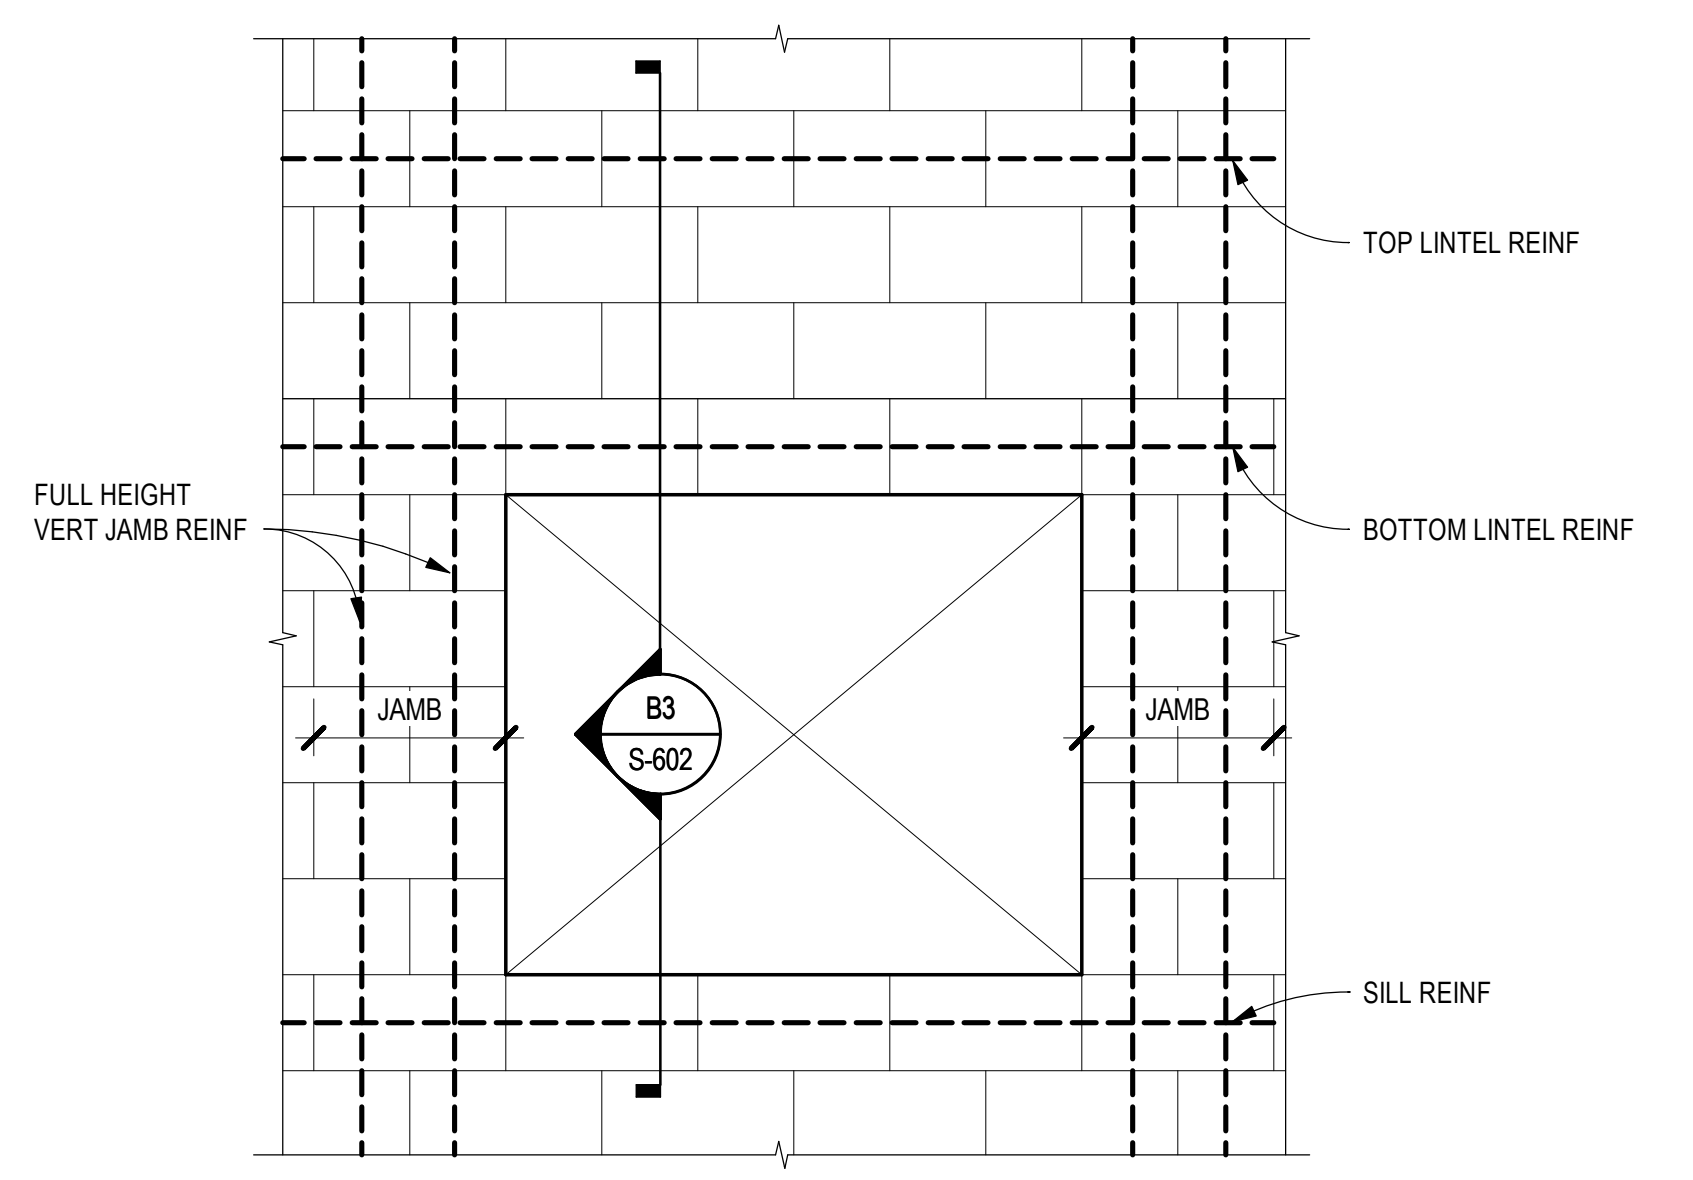

CMU LINTEL SCHEDULE						
OPENING WIDTH	WIDTH	DEPTH	LINTEL REINFORCING		SILL REINFORCING	LINTEL JAMB TYPE
			TOP	BOTTOM		
0'-0" - 3'-4"	8"	16"	2 - #5	2 - #5	8"	2 - #5 TYPE A
3'-5" - 8'-8"	8"	16"	2 - #5	2 - #5	8"	2 - #5 TYPE A
8'-9" - 12'-0"	8"	32"	2 - #5	2 - #5	8"	2 - #5 TYPE B
12'-1" - 18'-0"	8"	40"	2 - #5	2 - #5	8"	2 - #5 TYPE C

A1 CMU LINTEL SCHEDULE
 SCALE: NTS



This document, and the ideas and designs incorporated herein, as an instrument of professional service, is the property of EDMONSON REED ASSOCIATES, and is not to be used, in whole or in part, for any other project, without the written authorization of EDMONSON REED ASSOCIATES.

INTERIOR ARCHITECTURE

JCI Architecture
 120 Hayslope Avenue
 Suite 400
 Hartford, CT 06106
 860-247-9226

STRUCTURAL ENGINEERING

Chavez-Grievos Consulting Engineers, Inc.
 4700 Lincoln Road NE
 Suite 102
 Albuquerque, NM 87109
 505-344-4080

MEP ENGINEERING

MSA Engineering Consultants
 370 E. Windmill Ln.
 Suite 100
 Las Vegas, NV 89123
 702-898-1100

CIVIL ENGINEERING / SURVEYING

Native Plans Surveying and Mapping / RK & Associates PLC
 5807 S. Garnett Rd.
 Suite K
 Tulsa, OK 74146
 918-234-7596

LOW VOLTAGE / THEME LIGHTING

ME Engineers
 29 W. 38th St.
 5th Floor
 New York, NY 10018
 212-447-6770

FOOD SERVICES

Hestman Group, LLC
 7645 E. 63rd St.
 Suite 201
 Tulsa, OK 74133
 918-935-5036

CHEROKEE HARD ROCK CASINO 4

MECHANICAL SYMBOL LIST

NOTE: THIS IS A MASTER SCHEDULE. NOT ALL SYMBOLS CONTAINED HEREIN MAY APPEAR ON THE DRAWINGS.

---	ITEM TO BE REMOVED	---CHR---	CHILLED WATER RETURN PIPING
◆	POINT OF CONNECTION/DISCONNECTION	---CHS---	CHILLED WATER SUPPLY PIPING
◇	SHEET NOTE	---CR---	CONDENSER WATER RETURN PIPING
△	REVISION NUMBER	---CS---	CONDENSER WATER SUPPLY PIPING
□	EQUIPMENT MARK	---HWR---	HEATING WATER RETURN PIPING
TAG UNIT	DIFFUSER TAG	---HWS---	HEATING WATER SUPPLY PIPING
CFM	ACCESS PANEL	---RL---	REFRIGERANT LIQUID PIPING
□	SUPPLY AIR DUCT UP/DOWN	---RS---	REFRIGERANT SUCTION PIPING
□	RETURN AIR DUCT UP/DOWN	---CD---	CONDENSATE DRAIN PIPING
□	EXHAUST AIR DUCT UP/DOWN	---PC---	PUMPED CONDENSATE DRAIN PIPING
□	EXHAUST GRILLE	---CWS---	CIRCUIT SETTER
□	4-WAY BLOW SUPPLY DIFFUSER	---D---	DRAIN
□	3-WAY BLOW SUPPLY DIFFUSER	---DB---	DRY BULB TEMPERATURE
□	2-WAY BLOW SUPPLY DIFFUSER	---DDC---	DIRECT DIGITAL CONTROL
□	1-WAY BLOW SUPPLY DIFFUSER	---DIA---	DIAMETER
□	AIRFLOW DIRECTION	---DN---	DOWN
□	RECTANGULAR DUCTWORK (INCHES)	---DX---	DIRECT EXPANSION
□	RECTANGULAR DUCTWORK (INCHES)	---E---	EXISTING TO REMAIN
□	ROUND DUCTWORK (INCHES)	---EA---	EXHAUST AIR
□	ROUND FLEXIBLE DUCT	---EAT---	ENTERING AIR TEMPERATURE
□	SQUARE TO ROUND TRANSITION	---EC---	ELECTRICAL CONTRACTOR
□	SINGLE LINE RIGID DUCT	---EER---	ENERGY EFFICIENCY RATIO
□	SINGLE LINE RIGID DUCT (ACOUSTICALLY LINED)	---EFF---	EFFICIENCY
□	DOUBLE LINE RIGID DUCT	---ELEC---	ELECTRICAL
□	DOUBLE LINE RIGID DUCT (ACOUSTICALLY LINED)	---ESP---	EXTERNAL STATIC PRESSURE
□	EXISTING DUCTWORK	---EWT---	ENTERING WATER TEMPERATURE
□	FIRE DAMPER	---F---	FAHRENHEIT
□	SMOKE DAMPER	---FCO---	FLOOR CLEANOUT
□	MOTORIZED DAMPER (OPPOSED BLADE TYPE)	---FD---	FIRE DAMPER
□	MOTORIZED DAMPER (PARALLEL BLADE TYPE)	---FPM---	FEET PER MINUTE
□	BACKDRAFT DAMPER	---G---	GAS
□	MANUAL VOLUME DAMPER	---GA---	GAGE OR GAUGE
□	REMOTE VOLUME DAMPER	---GAL---	GALLONS
□	SMOKE DETECTOR	---	---
□	THERMOSTAT	---	---
□	HUMIDISTAT	---	---
□	SENSOR	---	---
□	CARBON DIOXIDE SENSOR	---	---
□	CARBON MONOXIDE SENSOR	---	---
□	DOOR UNDERCUT	---	---
□	FLOW SWITCH	---	---

MECHANICAL ABBREVIATIONS


NOTE: THIS IS A MASTER SCHEDULE. NOT ALL ABBREVIATIONS CONTAINED HEREIN MAY APPEAR ON THE DRAWINGS.

AABC	AMERICAN AIR BALANCE COUNCIL	GOO	GRADE CLEANOUT	PD	PRESSURE DROP
ACD	AUTOMATIC CONTROL DAMPER	GI	GREASE INTERCEPTOR	PRV	PRESSURE REDUCING VALVE
AFF	ABOVE FINISHED FLOOR	GPF	GALLONS PER FLUSH	PSI	POUNDS PER SQUARE INCH
AP	ACCESS PANEL	GPM	GALLONS PER MINUTE	PSIA	POUNDS PER SQUARE INCH ABSOLUTE
ASHRAE	AMERICAN SOCIETY OF HEATING, REFRIGERATION, AND AIR CONDITIONING ENGINEERS	GR	GLYCOL RETURN	PSID	POUNDS PER SQUARE INCH DIFFERENTIAL
ASPE	AMERICAN SOCIETY OF PLUMBING ENGINEERS	GS	GLYCOL SUPPLY	PSIG	POUNDS PER SQUARE INCH GAUGE
AV	ACID VENT	GW	GREASE WASTE	(R)	EXISTING TO BE RELOCATED
AW	ACID WASTE	HD	HEAD	RA	HORSEPOWER
BFD	BACKFLOW PREVENTION DEVICE	HP	HORSEPOWER	RH	RELATIVE HUMIDITY
BHP	BRAKE HORSEPOWER	HPG	HIGH PRESSURE GAS	RL/S	REFRIGERANT LIQUID/SUCTION
BTUH	BRITISH THERMAL UNIT PER HOUR	HR	HOUR	RPM	REVOLUTIONS PER MINUTE
CD	CONDENSATE DRAIN	HSPF	HEATING SEASONAL PERFORMANCE FACTOR	RPPA	REDUCED PRESSURE PRINCIPAL ASSEMBLY
CFM	CUBIC FEET PER MINUTE	HW	HOT WATER	RVD	REMOTE VOLUME DAMPER
CHAR	CHARACTERISTICS	HWR	HEATING HOT WATER RETURN	SA	SUPPLY AIR
CHR	CHILLED WATER RETURN	HWS	HEATING HOT WATER SUPPLY	SD	SMOKE DAMPER
CHS	CHILLED WATER SUPPLY	IBC	INTERNATIONAL BUILDING CODE	SEER	SEASONAL ENERGY EFFICIENCY RATIO
CO	CLEANOUT	IE	INVERT ELEVATION	SOI	SAND OIL INTERCEPTOR
CR	CONDENSER WATER RETURN	IMC	INTERNATIONAL MECHANICAL CODE	SP	STATIC PRESSURE (INCHES OF W.C.)
CS	CONDENSER WATER SUPPLY	IPC	INTERNATIONAL PLUMBING CODE	SPECS	SPECIFICATIONS
CW	COLD WATER	KW	KILOWATT	SO	SQUARE
D	DRAIN	LAT	LEAVING AIR TEMPERATURE	SOFT	SQUARE FEET
DB	DRY BULB TEMPERATURE	LBS	POUNDS	SS	STAINLESS STEEL
DDC	DIRECT DIGITAL CONTROL	LWT	LEAVING WATER TEMPERATURE	T	TEMPERATURE
DIA	DIAMETER	MAX	MAXIMUM	TAB	TEST AND BALANCE REPORT
DN	DOWN	MBH	ONE THOUSAND BTUH	TSP	TOTAL STATIC PRESSURE
DX	DIRECT EXPANSION	MCA	MINIMUM CIRCUIT AMPS	TW	TEMPERED WATER
(E)	EXISTING TO REMAIN	MIN	MINIMUM	TYP	TYPICAL
EA	EXHAUST AIR	MOCP	MAXIMUM OVERCURRENT PROTECTION	UBC	UNIFORM BUILDING CODE
EAT	ENTERING AIR TEMPERATURE	MPG	MEDIUM PRESSURE GAS	UMC	UNIFORM MECHANICAL CODE
EC	ELECTRICAL CONTRACTOR	MVD	MANUAL VOLUME DAMPER	UN	UNLESS OTHERWISE NOTED
EER	ENERGY EFFICIENCY RATIO	N/A	NOT APPLICABLE	UPC	UNIFORM PLUMBING CODE
EFF	EFFICIENCY	NC	NORMALLY CLOSED	V	VENT
ELEC	ELECTRICAL	NEBB	NATIONAL ENVIRONMENTAL BALANCING BUREAU	VPHHZ	VOLTAGE/PHASE/HERTZ
ESP	EXTERNAL STATIC PRESSURE	NEC	NATIONAL ELECTRIC CODE	VFD	VARIABLE FREQUENCY DRIVE
EWT	ENTERING WATER TEMPERATURE	NFPA	NATIONAL FIRE PROTECTION ASSOCIATION	VTR	VENT THROUGH ROOF
F	FAHRENHEIT	NIC	NOT IN CONTRACT	WCO	WALL CLEANOUT
FCO	FLOOR CLEANOUT	NO	NORMALLY OPEN	WG	WATER GAUGE
FD	FIRE DAMPER	NTS	NOT TO SCALE	WMS	WIRE MESH SCREEN
FPM	FEET PER MINUTE	OA	OUTSIDE AIR	(X)	EXISTING TO BE REMOVED
FSD	FIRE / SMOKE DAMPER	OAT	OUTSIDE AIR TEMPERATURE		
G	GAS	OB	OPPOSED BLADE DAMPER		
GA	GAGE OR GAUGE	OED	OPEN END DUCT		
GAL	GALLONS	OFCI	OWNER FURNISHED, CONTRACTOR INSTALLED		

MECHANICAL - DRAWING INDEX

SHEET NUMBER	SHEET NAME	04/16/2018 - BID SET - NOT FOR CONSTRUCTION	05/04/2018 - ADDENDUM #2	05/17/2018 - ADDENDUM #4	06/14/18 - Bulletin #2	MM.DD.YYYY
M-000	MECHANICAL ABBREVIATIONS AND SYMBOLS LIST	X	X	X	X	
M-001	MECHANICAL SPECIFICATIONS					
M-002	MECHANICAL SCHEDULES					
M-003	MECHANICAL SCHEDULES					
M-004	MECHANICAL DIAGRAMS	X	X	X		
M-005	COMPLIANCE CERTIFICATE					
M-006	MECHANICAL CONTROLS	X	X			
M-007	MECHANICAL CONTROLS	X	X			
M-008	MECHANICAL CONTROLS	X	X			
M-110	MECHANICAL FIRST FLOOR PLAN OVERALL	X	X			
M-111	MECHANICAL FIRST FLOOR AREA 1	X	X			
M-112	MECHANICAL FIRST FLOOR AREA 2	X	X	X		
M-120	MECHANICAL SECOND FLOOR PLAN OVERALL	X	X			
M-121	MECHANICAL SECOND FLOOR AREA 1	X	X			
M-122	MECHANICAL SECOND FLOOR AREA 2	X	X	X		
M-160	MECHANICAL ROOF PLAN OVERALL	X	X			
M-161	MECHANICAL ROOF AREA 1	X	X			
M-162	MECHANICAL ROOF AREA 2	X	X	X		
M-210	MECHANICAL PIPING FIRST FLOOR PLAN OVERALL	X	X			
M-211	MECHANICAL PIPING FIRST FLOOR AREA 1	X	X	X		
M-212	MECHANICAL PIPING FIRST FLOOR AREA 2	X	X	X		
M-220	MECHANICAL PIPING SECOND FLOOR PLAN OVERALL	X	X			
M-221	MECHANICAL PIPING SECOND FLOOR AREA 1	X	X	X		
M-222	MECHANICAL PIPING SECOND FLOOR AREA 2	X	X	X		
M-260	MECHANICAL PIPING ROOF PLAN OVERALL	X	X			
M-261	MECHANICAL PIPING ROOF AREA 1	X	X			
M-262	MECHANICAL PIPING ROOF AREA 2	X	X			
TOTAL:	27					

CASINO 4

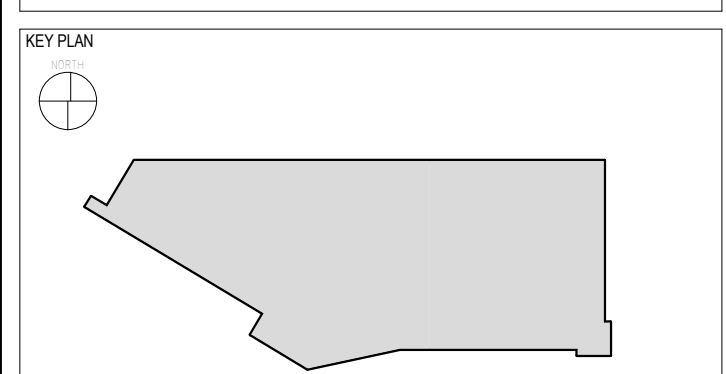

No.	Description	Date
2	ADDENDUM #2	05/04/2018
4	ADDENDUM #4	05/17/2018
5	BULLETIN #2	06/14/2018

MECHANICAL ABBREVIATIONS AND SYMBOLS LIST

CONSTRUCTION SET

PROJECT NO.	L17325
OWNER:	MSA
CHKD BY:	PE
ISSUE DATE:	5/4/2018

M-000
 Scale 12" = 1'-0"

6/14/2018 1:26:00 PM

GENERAL NOTES:

- ACCESS DOORS ARE REQUIRED FOR ALL DAMPERS INSTALLED ABOVE INACCESSIBLE CEILINGS. COORDINATE EXACT LOCATION OF ALL ACCESS DOORS WITH ARCHITECT PRIOR TO INSTALLATION.
- VERIFY EXACT LOCATION OF ALL THERMOSTATS WITH ARCHITECT PRIOR TO INSTALLATION. MOUNT ALL THERMOSTATS @48" A.F.F. IN ACCORDANCE WITH ADA STANDARDS. PROVIDE LOCKING COVERS FOR T-STATS.
- VERIFY AND COORDINATE FRAME AND BORDER TYPE REQUIREMENTS FOR AIR DEVICES WITH ARCHITECTURAL CEILING PLANS PRIOR TO ORDERING.
- DUCT SIZES SHOW ARE THE CLEAR INSIDE DIMENSIONS.
- THE MECHANICAL CONTRACTOR SHALL VERIFY THE LOCATION OF ALL ROOF MOUNTED EQUIPMENT AND ROOF PENETRATIONS WITH ARCHITECT AND STRUCTURAL ENGINEER PRIOR TO COMMENCING WORK.
- THE MECHANICAL CONTRACTOR SHALL COORDINATE LOCATION AND ROUTING OF HVAC EQUIPMENT AND DUCTWORK WITH OTHER TRADES PRIOR TO COMMENCING WORK.
- ALL EXHAUST OUTLETS SHALL BE LOCATED MIN. OF 10'-0" FROM ANY OUTSIDE AIR INTAKES.
- THE CUTTING, NOTCHING, AND BORING OF HOLES IN FLOOR JOIST AND WALL STUDS SHALL BE IN ACCORDANCE WITH THE LATEST APPROVED EDITION OF THE INTERNATIONAL BUILDING CODE.
- CONTRACTOR SHALL BE RESPONSIBLE FOR ALL CUTTING AND PATCHING AS REQUIRED TO ACCOMMODATE HIS WORK.
- REFER TO THE MECHANICAL DIAGRAMS THAT APPLY TO THE WORK ON THIS DRAWING. THESE DIAGRAMS PROVIDE GUIDANCE AS TO INSTALLATION INTENT AND DO NOT NECESSARILY SHOW ALL COMPONENTS REQUIRED.

SHEET NOTES:

- 3/4" HWS/HWR. CONNECT TO VAV BOX AS INDICATED.
- 1" CHS / CHR, 1" HWS / HWR UP TO LEVEL 2.
- 3/4" CHS / CHR DN IN WALL TO ICE MAKER (ITEM #P6051). REFER TO FOOD SERVICE PLANS FOR EXACT LOCATION.
- 3/4" CHS / CHR FROM LEVEL ABOVE DN IN WALL TO ICE MAKER (ITEM #P4849). REFER TO FOOD SERVICE PLANS FOR EXACT LOCATION.
- 1 1/4" CHS / CHR, 1" HWS / HWR UP TO LEVEL 2.

This document, and the ideas and designs incorporated herein, as an instrument of professional service, is the property of EDMONDSON REED ASSOCIATES, and is not to be used, in whole or in part, for any other project, without the written authorization of EDMONDSON REED ASSOCIATES.

INTERIOR ARCHITECTURE
JCI Architecture
120 Hayslope Avenue
Suite 400
Hartford, CT 06106
860-247-9228

STRUCTURAL ENGINEERING
Chavez-Grievos Consulting Engineers, Inc.
4700 Lincoln Road NE
Suite 102
Albuquerque, NM 87109
505-344-4080

MEP ENGINEERING
MSA Engineering Consultants
370 E. Windmill Ln.
Suite 100
Las Vegas, NV 89123
702-995-1100


CIVIL ENGINEERING / SURVEYING
Native Plans Surveying and Mapping / RK & Associates PLC
5807 S. Garnett Rd.
Suite K
Tulsa, OK 74146
918-234-7596

LOW VOLTAGE / THEME LIGHTING
ME Engineers
29 W. 38th St.
5th Floor
New York, NY 10018
212-447-6770

FOOD SERVICES
Hestman Group, LLC
7645 E. 63rd St.
Suite 201
Tulsa, OK 74133
918-935-5036

CHEROKEE HARD ROCK CASINO 4

CASINO 4

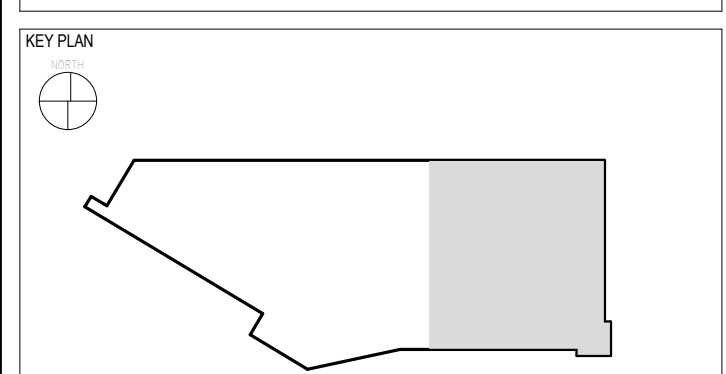

No.	Description	Date
2	ADDENDUM #2	05/04/2018
5	BULLETIN #2	06/14/2018


MECHANICAL PIPING FIRST FLOOR AREA 1

CONSTRUCTION SET


PROJECT NO: L17325
DRAWN BY: MSA
CHECKED BY: PE
ISSUE DATE: 5/4/2018

M-211
Scale: 1/8" = 1'-0"

ENTIRE SHEET CHANGES

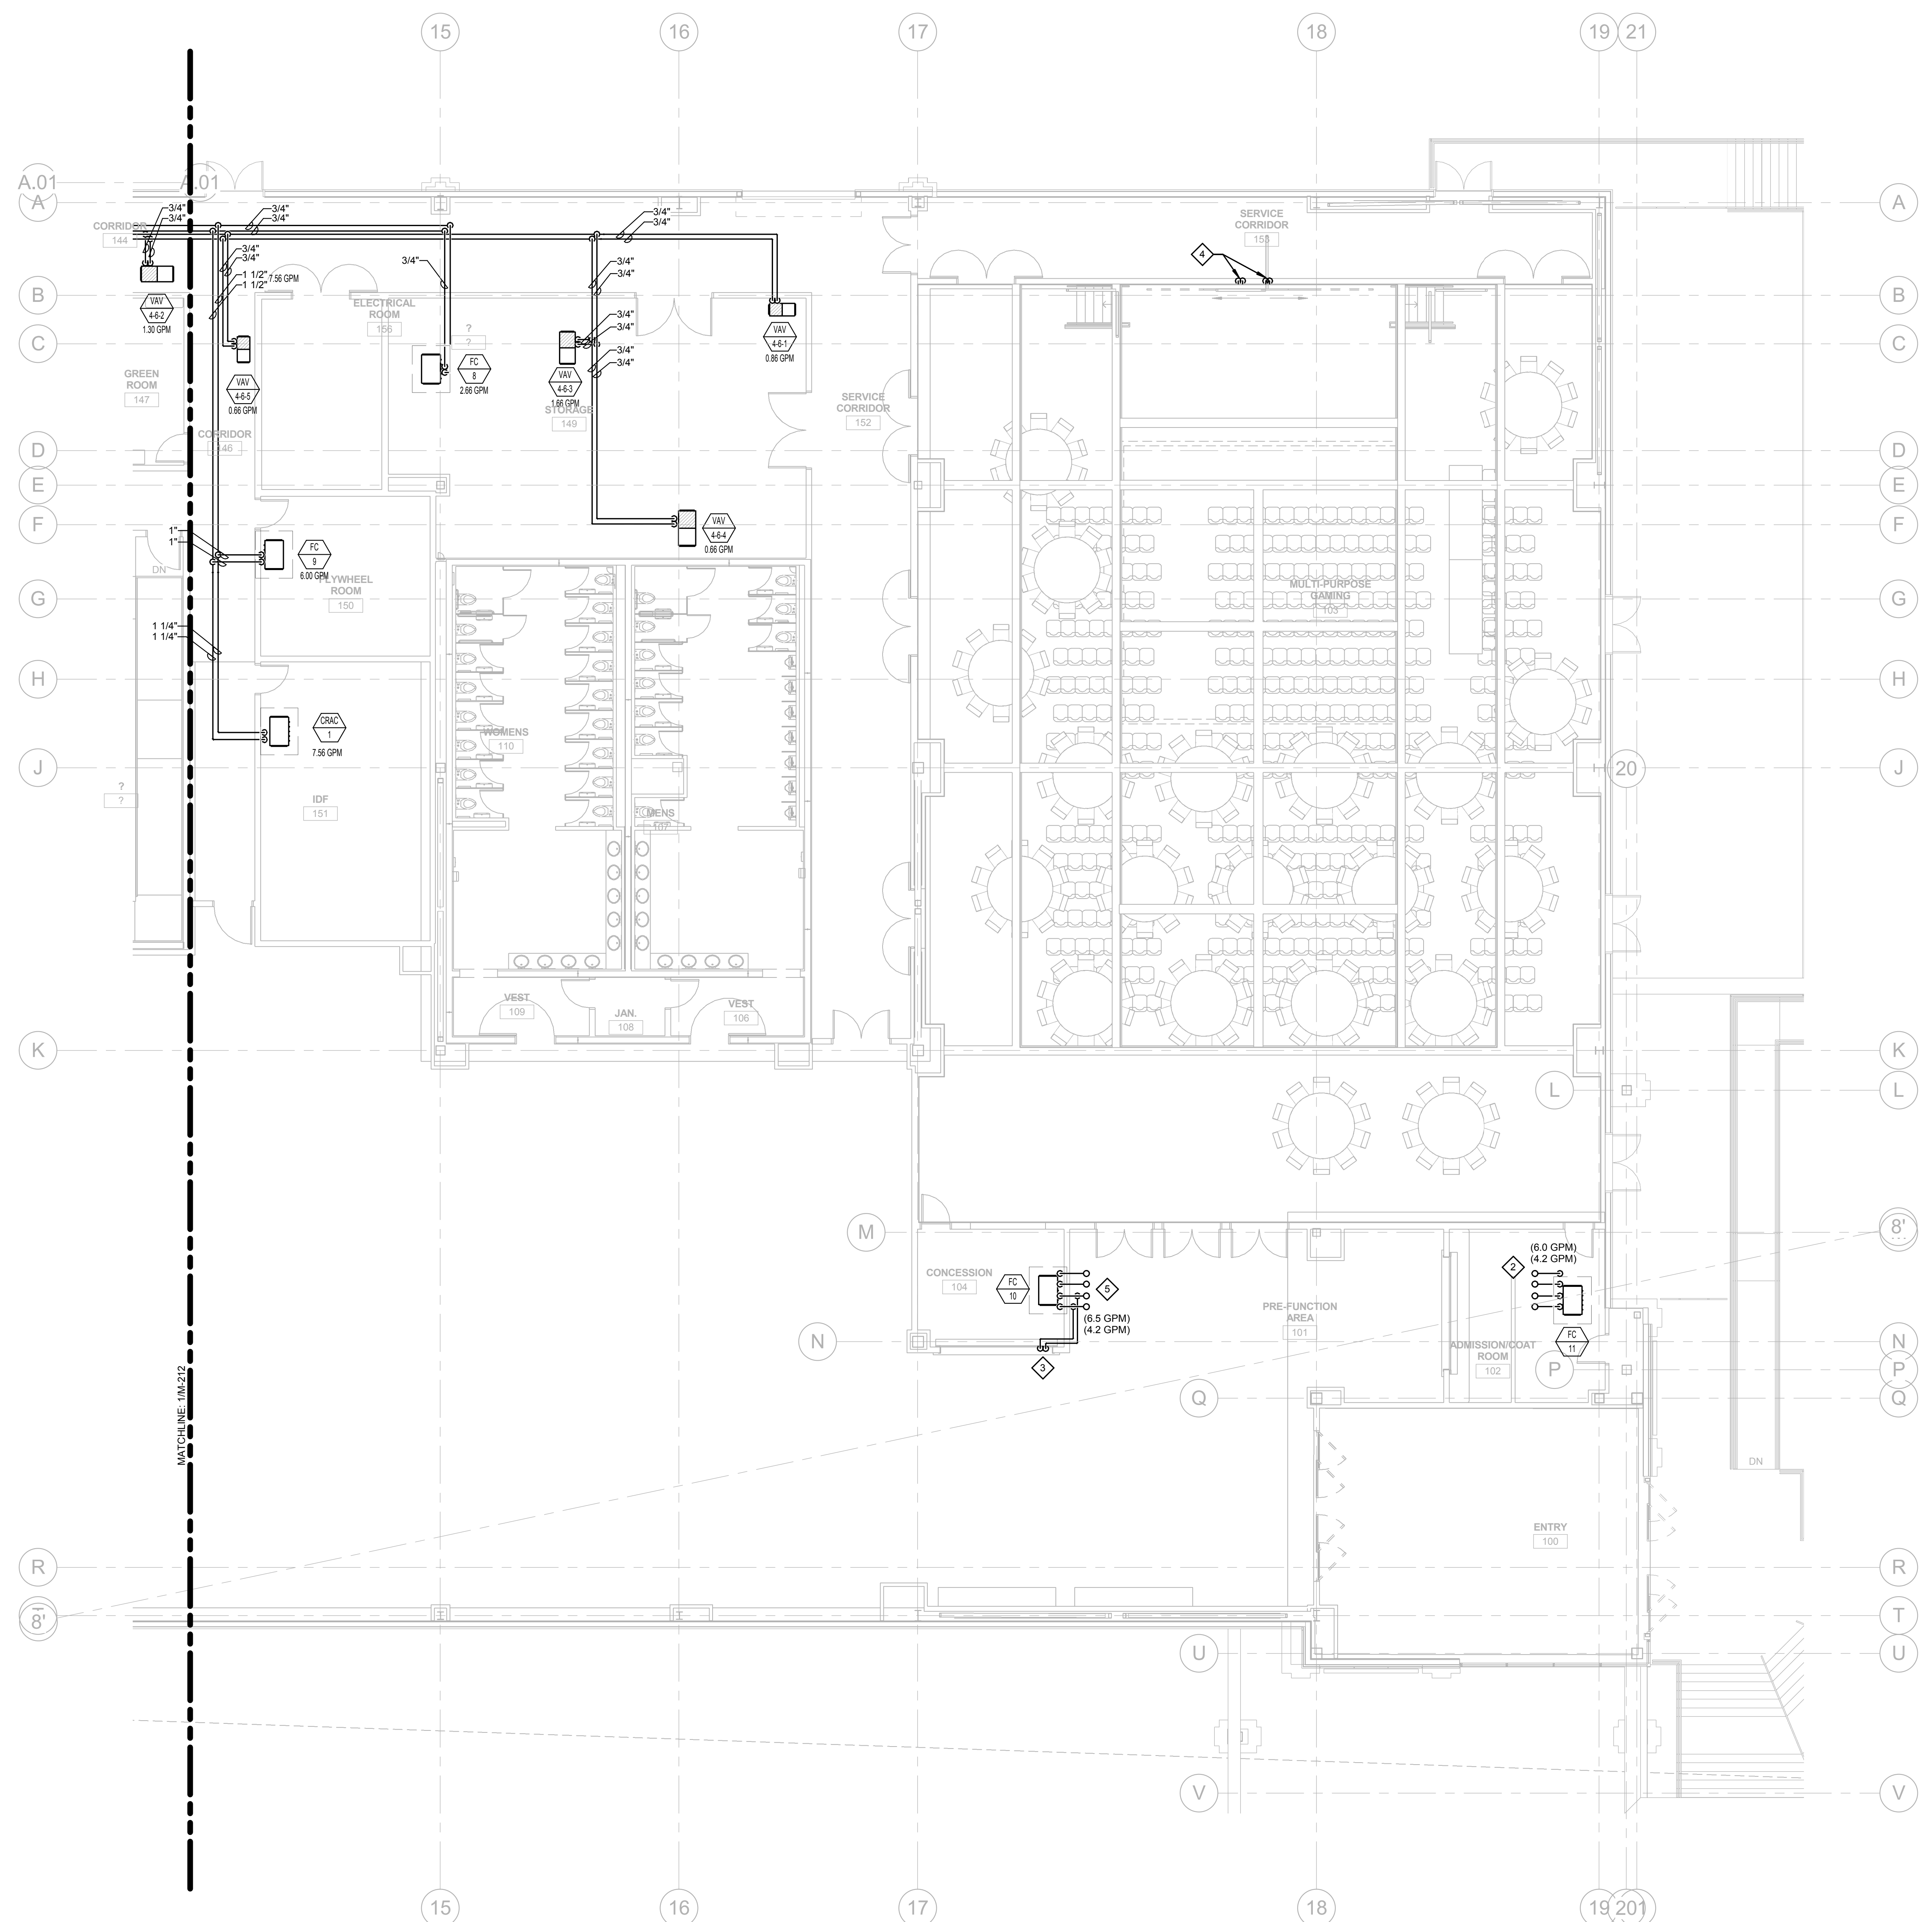


1 LEVEL 1 - MECHANICAL PIPING PLAN AREA 1
M-211 1/8" = 1'-0"

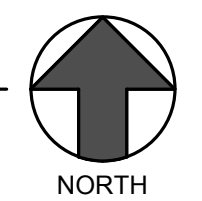

6/14/2018 11:30:16 AM



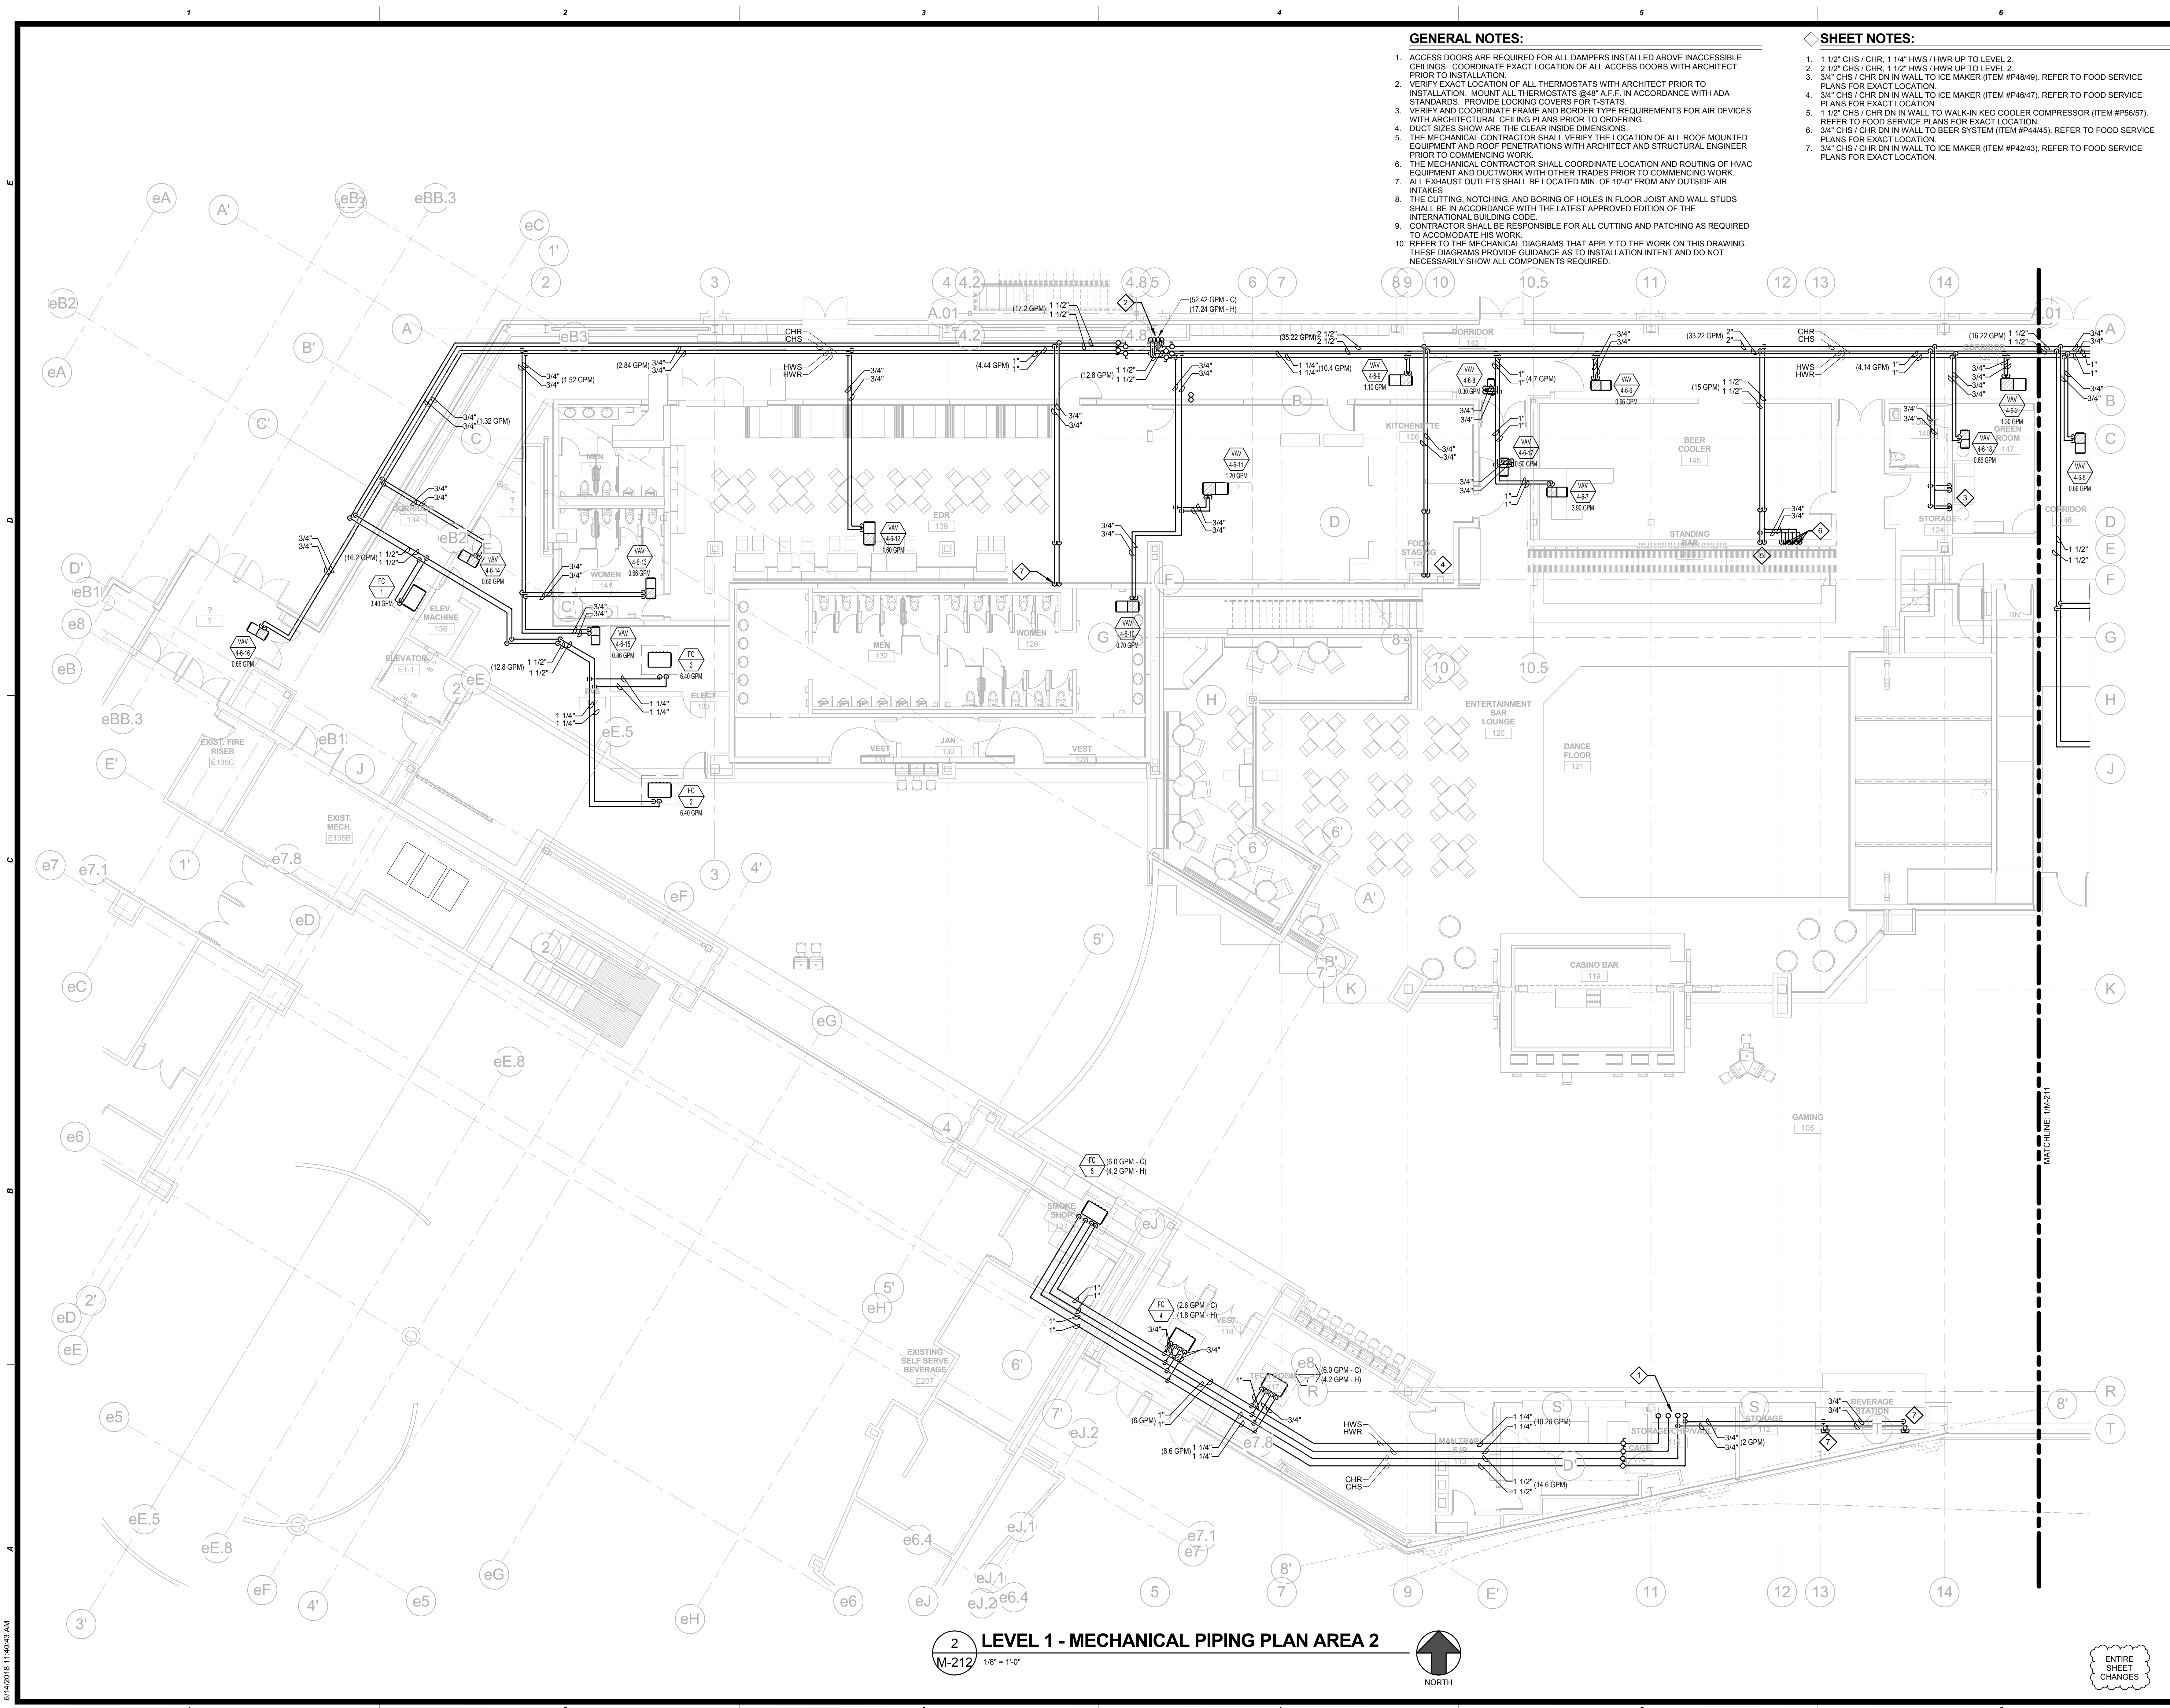

GENERAL NOTES:

1. ACCESS DOORS ARE REQUIRED FOR ALL DAMPERS INSTALLED ABOVE INACCESSIBLE CEILINGS. COORDINATE EXACT LOCATION OF ALL ACCESS DOORS WITH ARCHITECT PRIOR TO INSTALLATION.
2. VERIFY EXACT LOCATION OF ALL THERMOSTATS WITH ARCHITECT PRIOR TO INSTALLATION. MOUNT ALL THERMOSTATS @48" A.F.F. IN ACCORDANCE WITH ADA STANDARDS. PROVIDE LOCKING COVERS FOR T-STATS.
3. VERIFY AND COORDINATE FRAME AND BORDER TYPE REQUIREMENTS FOR AIR DEVICES WITH ARCHITECTURAL CEILING PLANS PRIOR TO ORDERING.
4. DUCT SIZES SHOW ARE THE CLEAR INSIDE DIMENSIONS.
5. THE MECHANICAL CONTRACTOR SHALL VERIFY THE LOCATION OF ALL ROOF MOUNTED EQUIPMENT AND ROOF PENETRATIONS WITH ARCHITECT AND STRUCTURAL ENGINEER PRIOR TO COMMENCING WORK.
6. THE MECHANICAL CONTRACTOR SHALL COORDINATE LOCATION AND ROUTING OF HVAC EQUIPMENT AND DUCTWORK WITH OTHER TRADES PRIOR TO COMMENCING WORK.
7. ALL EXHAUST OUTLETS SHALL BE LOCATED MIN. OF 10'-0" FROM ANY OUTSIDE AIR INTAKES.
8. THE CUTTING, NOTCHING, AND BORING OF HOLES IN FLOOR JOIST AND WALL STUDS SHALL BE IN ACCORDANCE WITH THE LATEST APPROVED EDITION OF THE INTERNATIONAL BUILDING CODE.
9. CONTRACTOR SHALL BE RESPONSIBLE FOR ALL CUTTING AND PATCHING AS REQUIRED TO ACCOMMODATE HIS WORK.
10. REFER TO THE MECHANICAL DIAGRAMS THAT APPLY TO THE WORK ON THIS DRAWING. THESE DIAGRAMS PROVIDE GUIDANCE AS TO INSTALLATION INTENT AND DO NOT NECESSARILY SHOW ALL COMPONENTS REQUIRED.

SHEET NOTES:

1. 1 1/2" CHS / CHR, 1 1/4" HWS / HWR UP TO LEVEL 2.
2. 2" CHS / CHR, 1 1/2" HWS / HWR UP TO LEVEL 2.
3. 3/4" CHS / CHR DN IN WALL TO ICE MAKER (ITEM #484/49). REFER TO FOOD SERVICE PLANS FOR EXACT LOCATION.
4. 3/4" CHS / CHR DN IN WALL TO ICE MAKER (ITEM #464/47). REFER TO FOOD SERVICE PLANS FOR EXACT LOCATION.
5. 1 1/2" CHS / CHR DN IN WALL TO WALK-IN KEG COOLER COMPRESSOR (ITEM #56/57). REFER TO FOOD SERVICE PLANS FOR EXACT LOCATION.
6. 3/4" CHS / CHR DN IN WALL TO BEER SYSTEM (ITEM #44/45). REFER TO FOOD SERVICE PLANS FOR EXACT LOCATION.
7. 3/4" CHS / CHR DN IN WALL TO ICE MAKER (ITEM #42/43). REFER TO FOOD SERVICE PLANS FOR EXACT LOCATION.

ERA
EDMONDSON REED ASSOCIATES
1401 S. Denver Ave., Suite B
Tulsa, OK 74119
Tel: (918) 584-6007
Fax: (918) 278-1342

This document, and the ideas and designs incorporated herein, as an instrument of professional service, is the property of EDMONDSON REED ASSOCIATES, and is not to be used, in whole or in part, for any other project, without the written authorization of EDMONDSON REED ASSOCIATES.

INTERIOR ARCHITECTURE
CJ Architecture
120 Haysheop Avenue
Suite 400
Hartford, CT 06106
860-247-9226

STRUCTURAL ENGINEERING
Chavez-Grievens Consulting Engineers, Inc.
4700 Lincoln Road NE
Suite 102
Albuquerque, NM 87109
505-344-4080

MEP ENGINEERING
MSA Engineering Consultants
370 E. Windmill Ln.
Suite 100
Las Vegas, NV 89123
702-995-1100


CIVIL ENGINEERING / SURVEYING
Native Plans Surveying and Mapping / RK & Associates PLC
5807 S. Garnett Rd.
Suite K
Tulsa, OK 74146
918-234-7596

LOW VOLTAGE / THEME LIGHTING
ME Engineers
29 W. 38th St.
5th Floor
New York, NY 10018
212-447-6770

FOOD SERVICES
Hestman Group, LLC
7645 E. 63rd St.
Suite 201
Tulsa, OK 74133
918-935-5036

CHEROKEE HARD ROCK CASINO 4

CASINO 4

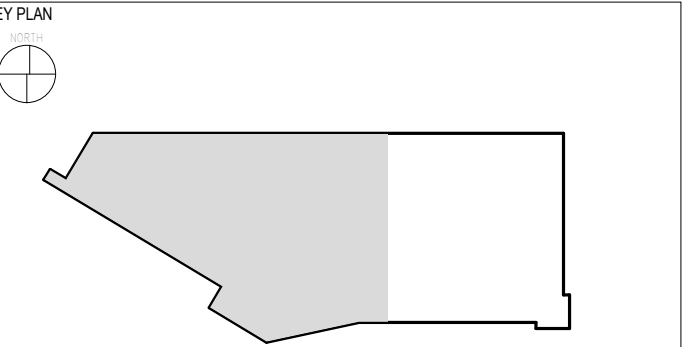

No.	Description	Date
2	ADDENDUM #2	05/04/2018
5	BULLETIN #2	06/14/2018


MECHANICAL PIPING FIRST FLOOR AREA 2

CONSTRUCTION SET

PROJECT NO: L17325
DRAWN BY: MSA
CHECKED BY: PE
ISSUE DATE: 5/4/2018


M-212
Scale: 1/8" = 1'-0"

2 LEVEL 1 - MECHANICAL PIPING PLAN AREA 2
M-212 1/8" = 1'-0"

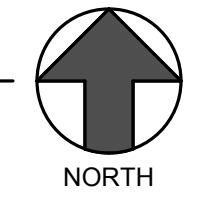

6/14/2018 11:40:45 AM

ENTIRE SHEET CHANGES

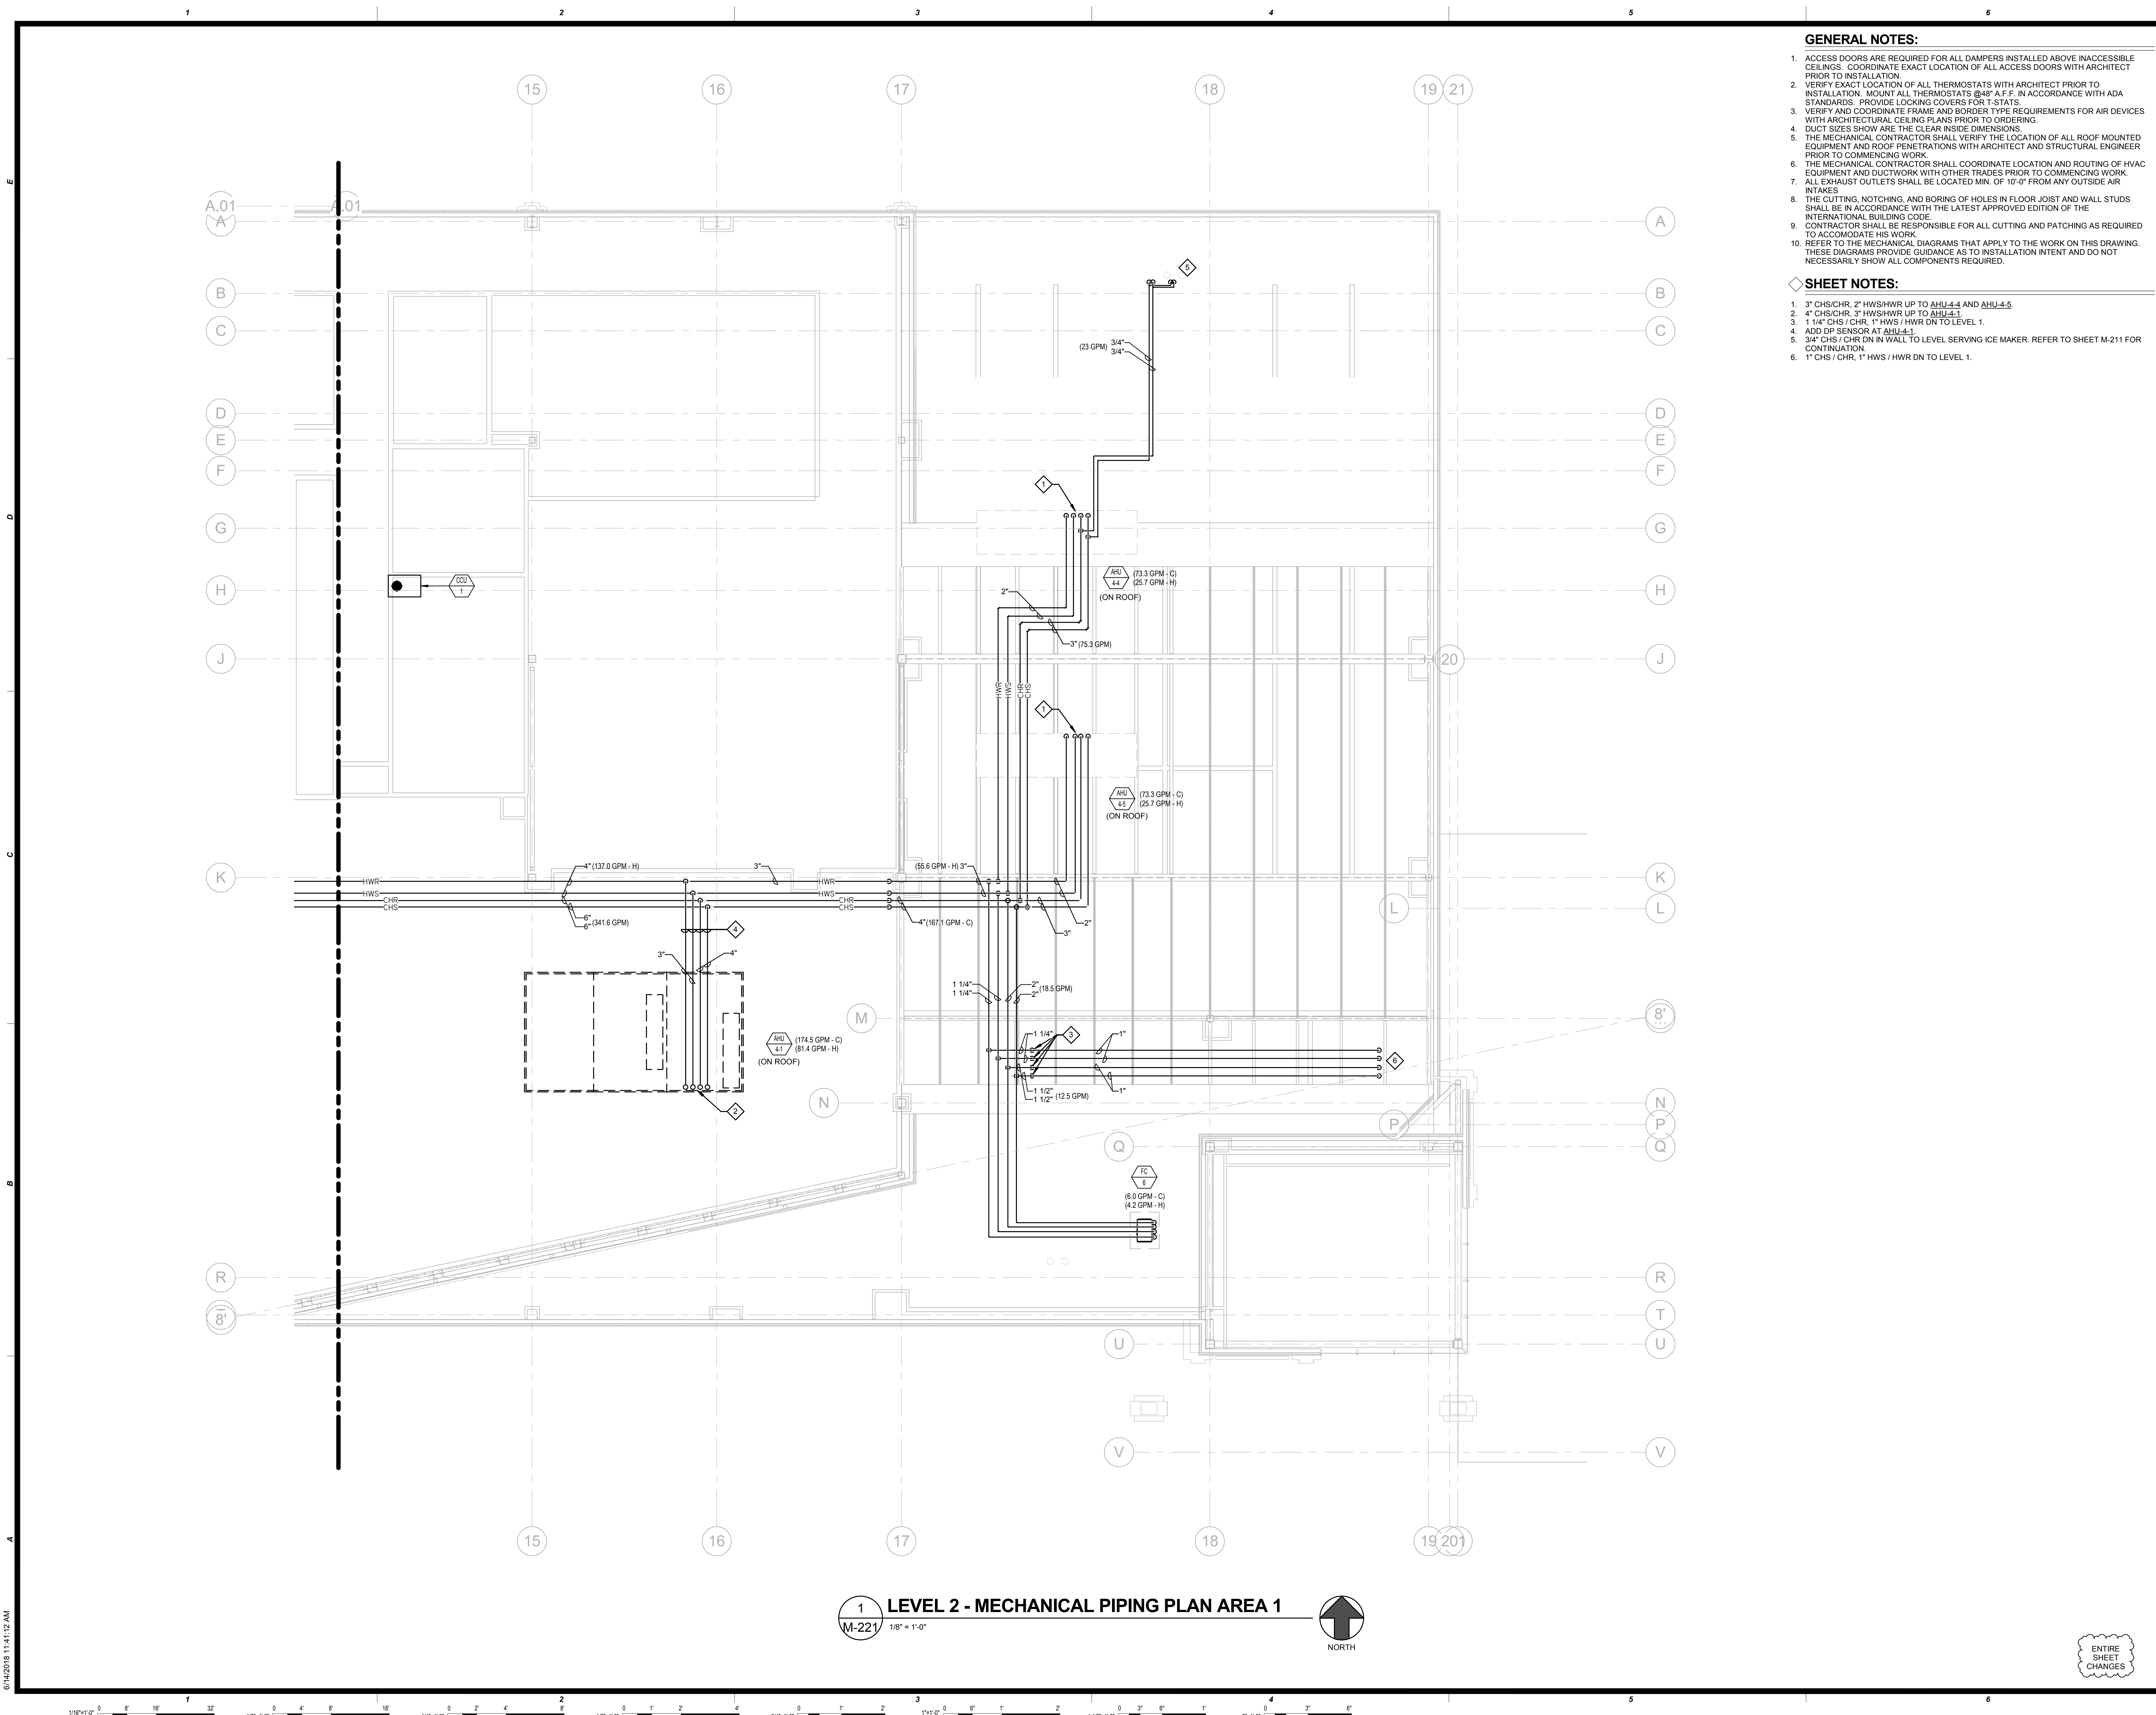

GENERAL NOTES:

- ACCESS DOORS ARE REQUIRED FOR ALL DAMPERS INSTALLED ABOVE INACCESSIBLE CEILING. COORDINATE EXACT LOCATION OF ALL ACCESS DOORS WITH ARCHITECT PRIOR TO INSTALLATION.
- VERIFY EXACT LOCATION OF ALL THERMOSTATS WITH ARCHITECT PRIOR TO INSTALLATION. MOUNT ALL THERMOSTATS @48" A.F.F. IN ACCORDANCE WITH ADA STANDARDS. PROVIDE LOCKING COVERS FOR T-STATS.
- VERIFY AND COORDINATE FRAME AND BORDER TYPE REQUIREMENTS FOR AIR DEVICES WITH ARCHITECTURAL CEILING PLANS PRIOR TO ORDERING.
- DUCT SIZES SHOW ARE THE CLEAR INSIDE DIMENSIONS.
- THE MECHANICAL CONTRACTOR SHALL VERIFY THE LOCATION OF ALL ROOF MOUNTED EQUIPMENT AND ROOF PENETRATIONS WITH ARCHITECT AND STRUCTURAL ENGINEER PRIOR TO COMMENCING WORK.
- THE MECHANICAL CONTRACTOR SHALL COORDINATE LOCATION AND ROUTING OF HVAC EQUIPMENT AND DUCTWORK WITH OTHER TRADES PRIOR TO COMMENCING WORK.
- ALL EXHAUST OUTLETS SHALL BE LOCATED MIN. OF 10'-0" FROM ANY OUTSIDE AIR INTAKES.
- THE CUTTING, NOTCHING, AND BORING OF HOLES IN FLOOR JOIST AND WALL STUDS SHALL BE IN ACCORDANCE WITH THE LATEST APPROVED EDITION OF THE INTERNATIONAL BUILDING CODE.
- CONTRACTOR SHALL BE RESPONSIBLE FOR ALL CUTTING AND PATCHING AS REQUIRED TO ACCOMMODATE HIS WORK.
- REFER TO THE MECHANICAL DIAGRAMS THAT APPLY TO THE WORK ON THIS DRAWING. THESE DIAGRAMS PROVIDE GUIDANCE AS TO INSTALLATION INTENT AND DO NOT NECESSARILY SHOW ALL COMPONENTS REQUIRED.

SHEET NOTES:

- 3" CHS/CHR, 2" HWS/HWR UP TO AHU-4-4 AND AHU-4-5.
- 4" CHS/CHR, 3" HWS/HWR UP TO AHU-4-1.
- 1 1/4" CHS/CHR, 1" HWS/HWR DN TO LEVEL 1.
- ADD DP SENSOR AT AHU-4-1.
- 3/4" CHS/CHR DN IN WALL TO LEVEL SERVING ICE MAKER. REFER TO SHEET M-211 FOR CONTINUATION.
- 1" CHS/CHR, 1" HWS/HWR DN TO LEVEL 1.



This document, and the ideas and designs incorporated herein, as an instrument of professional service, is the property of EDWARDS REED ASSOCIATES, and is not to be used, in whole or in part, for any other project, without the written authorization of EDWARDS REED ASSOCIATES.

INTERIOR ARCHITECTURE

JCI Architecture
120 Hayshepe Avenue
Suite 400
Hartford, CT 06106
860-247-9228

STRUCTURAL ENGINEERING

Chavez-Grievos Consulting Engineers, Inc.
4700 Lincoln Road NE
Suite 102
Albuquerque, NM 87109
505-344-4080

MEP ENGINEERING

MSA Engineering Consultants
370 E. Windmill Ln.
Suite 100
Las Vegas, NV 89123
702-896-1100

CIVIL ENGINEERING / SURVEYING

Native Plans Surveying and Mapping / RK & Associates PLC
5807 S. Garnett Rd.
Suite K
Tulsa, OK 74146
918-234-7596

LOW VOLTAGE / THEME LIGHTING


ME Engineers
29 W. 38th St.
5th Floor
New York, NY 10018
212-447-6770

FOOD SERVICES

Hestman Group, LLC
7645 E. 63rd St.
Suite 201
Tulsa, OK 74133
918-935-5036

CHEROKEE HARD ROCK CASINO 4

CASINO 4

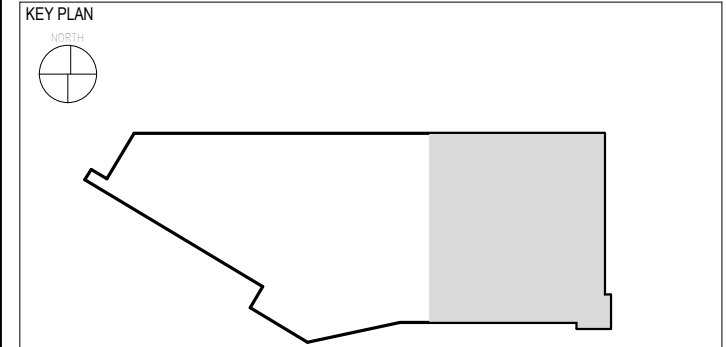

No.	Description	Date
2	ADDENDUM #2	05/04/2018
5	BULLETIN #2	06/14/2018

MECHANICAL PIPING SECOND FLOOR AREA 1

CONSTRUCTION SET


PROJECT NO: L17325
DRAWN BY: MSA
CHECKED BY: PE
ISSUE DATE: 5/4/2018


M-221
Scale 1/8" = 1'-0"

ENTIRE SHEET CHANGES

1 LEVEL 2 - MECHANICAL PIPING PLAN AREA 1
M-221 1/8" = 1'-0"
NORTH

6/14/2018 11:41:12 AM

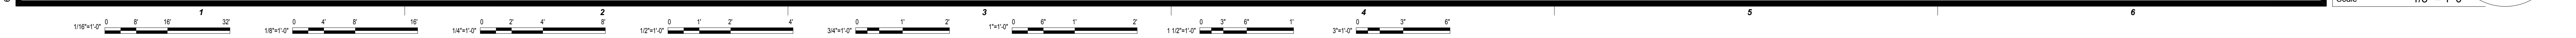

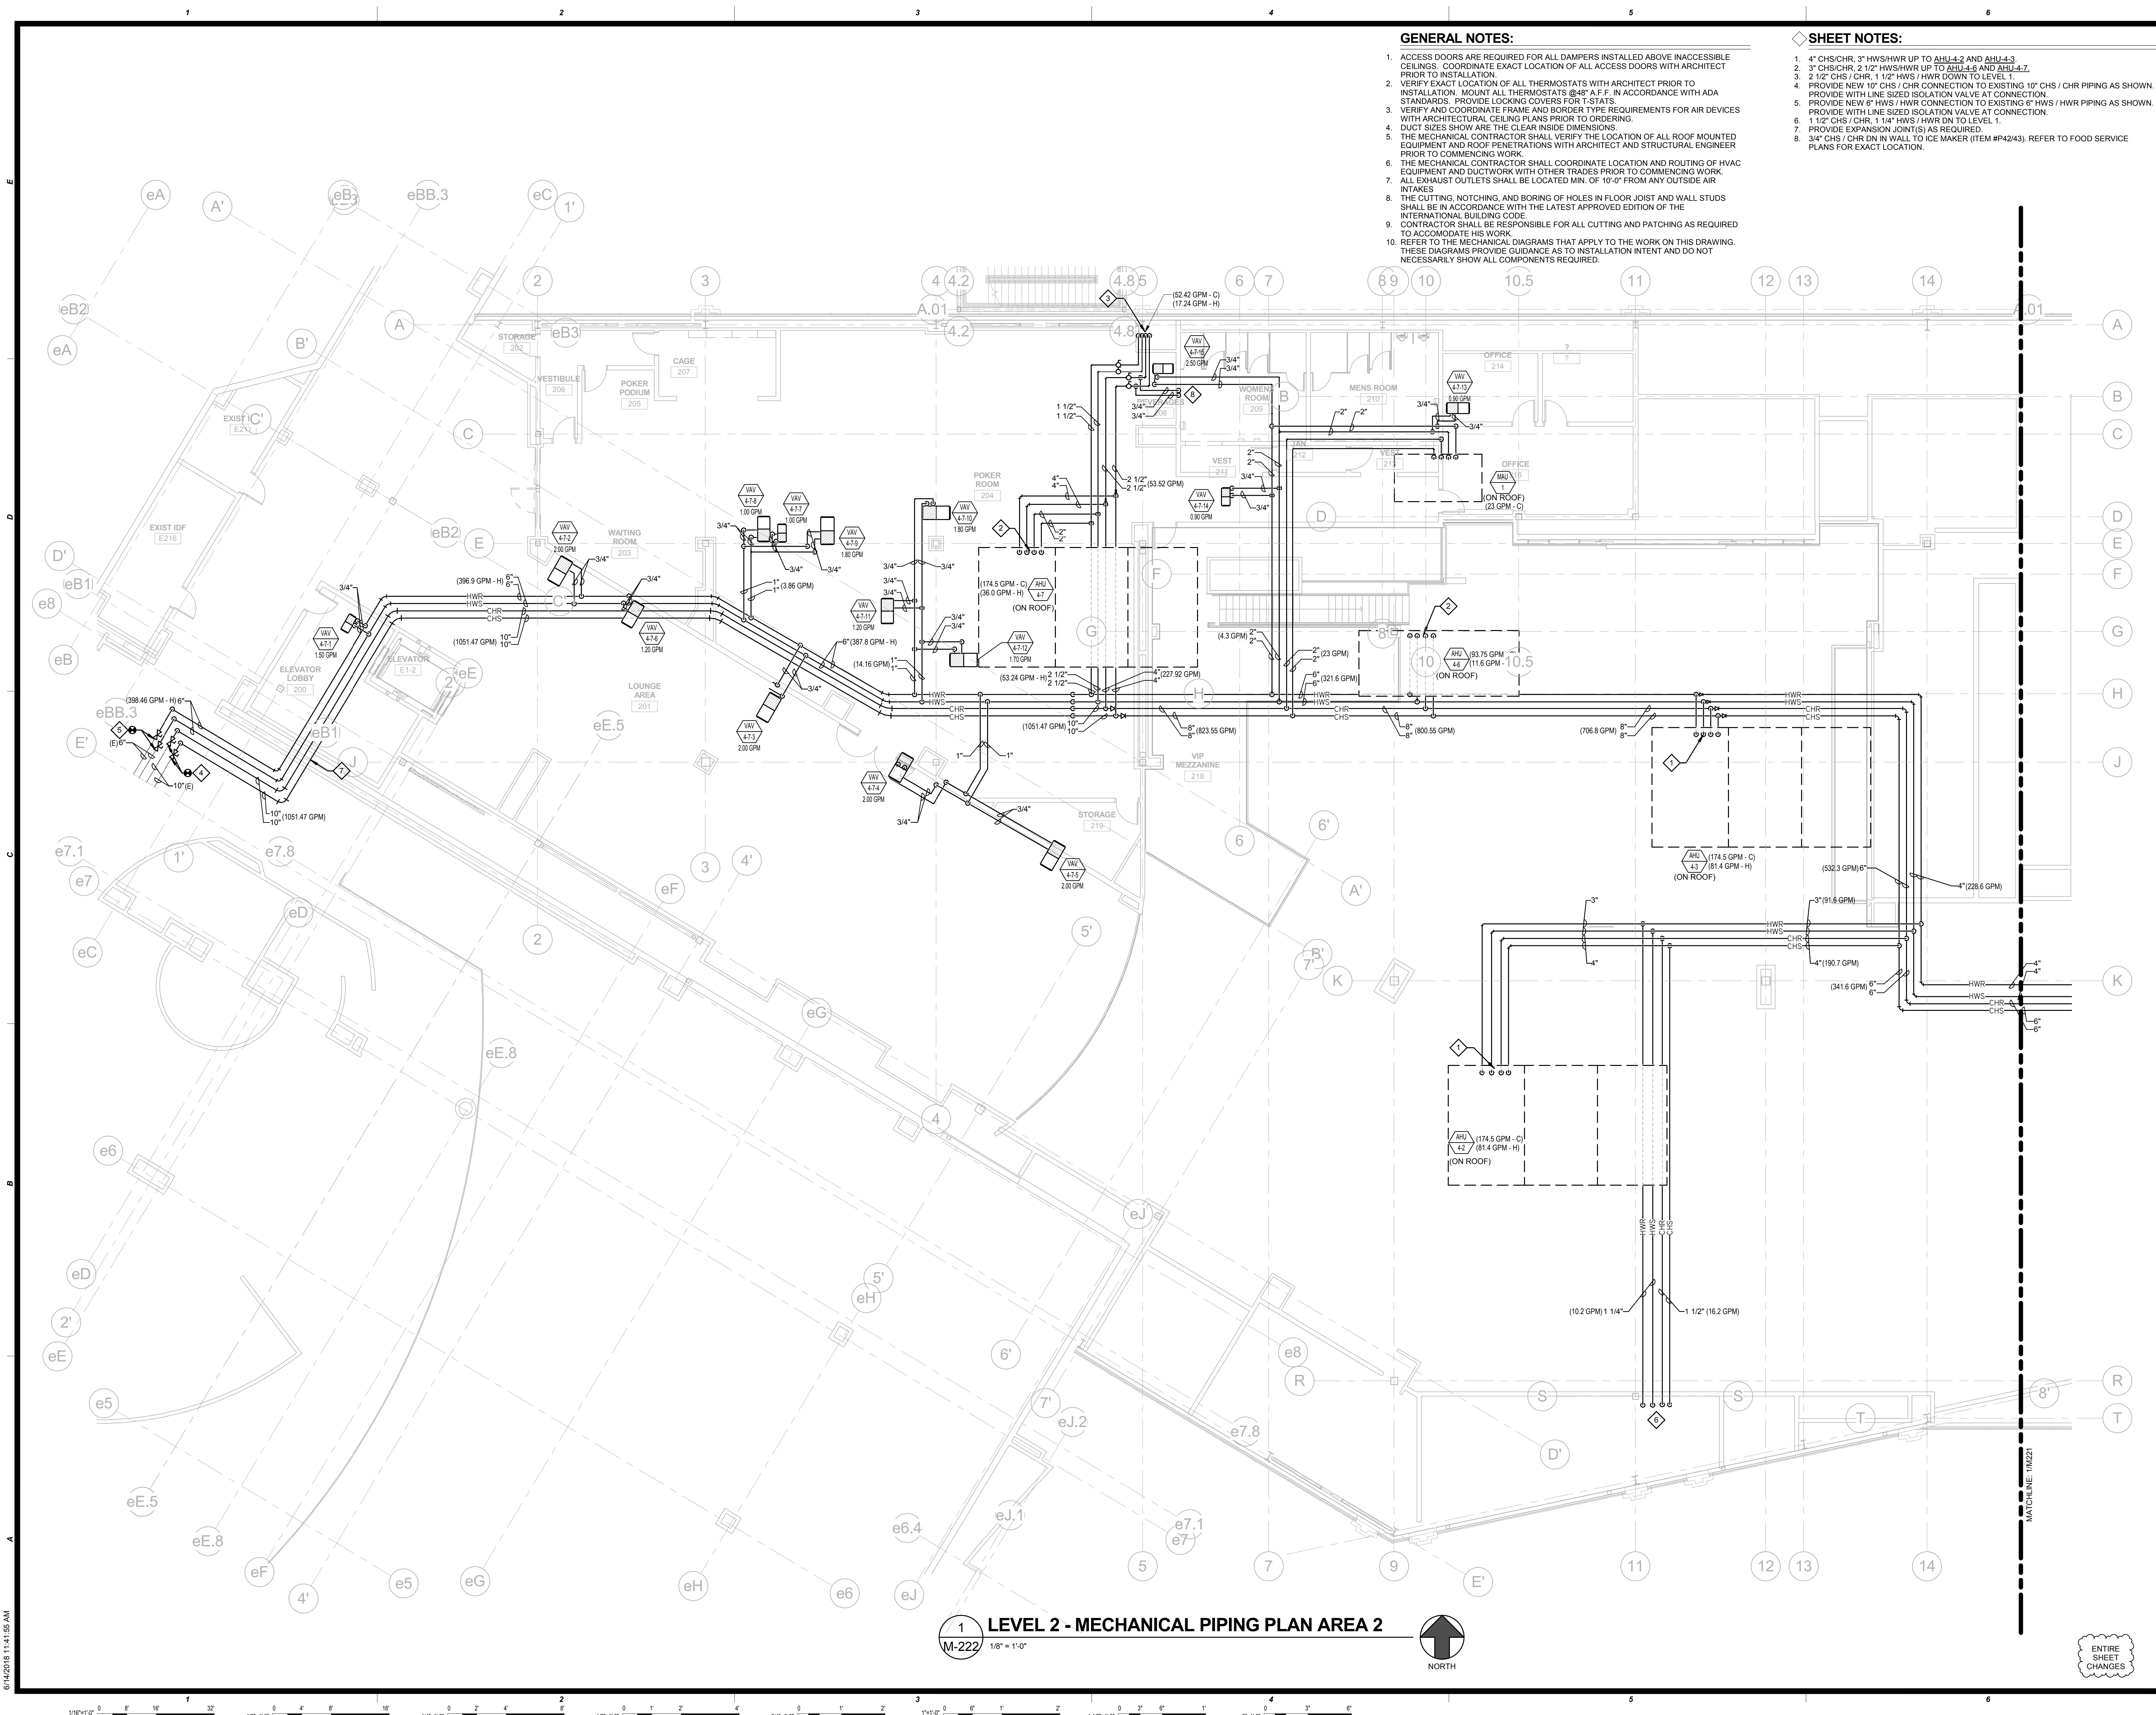

GENERAL NOTES:

- ACCESS DOORS ARE REQUIRED FOR ALL DAMPERS INSTALLED ABOVE INACCESSIBLE CEILINGS. COORDINATE EXACT LOCATION OF ALL ACCESS DOORS WITH ARCHITECT PRIOR TO INSTALLATION.
- VERIFY EXACT LOCATION OF ALL THERMOSTATS WITH ARCHITECT PRIOR TO INSTALLATION. MOUNT ALL THERMOSTATS @48" A.F.F. IN ACCORDANCE WITH ADA STANDARDS. PROVIDE LOCKING COVERS FOR T-STATS.
- VERIFY AND COORDINATE FRAME AND BORDER TYPE REQUIREMENTS FOR AIR DEVICES WITH ARCHITECTURAL CEILING PLANS PRIOR TO ORDERING.
- DUCT SIZES SHOW ARE THE CLEAR INSIDE DIMENSIONS.
- THE MECHANICAL CONTRACTOR SHALL VERIFY THE LOCATION OF ALL ROOF MOUNTED EQUIPMENT AND ROOF PENETRATIONS WITH ARCHITECT AND STRUCTURAL ENGINEER PRIOR TO COMMENCING WORK.
- THE MECHANICAL CONTRACTOR SHALL COORDINATE LOCATION AND ROUTING OF HVAC EQUIPMENT AND DUCTWORK WITH OTHER TRADES PRIOR TO COMMENCING WORK.
- ALL EXHAUST OUTLETS SHALL BE LOCATED MIN. OF 10'-0" FROM ANY OUTSIDE AIR INTAKES.
- THE CUTTING, NOTCHING, AND BORING OF HOLES IN FLOOR JOIST AND WALL STUDS SHALL BE IN ACCORDANCE WITH THE LATEST APPROVED EDITION OF THE INTERNATIONAL BUILDING CODE.
- CONTRACTOR SHALL BE RESPONSIBLE FOR ALL CUTTING AND PATCHING AS REQUIRED TO ACCOMMODATE HIS WORK.
- REFER TO THE MECHANICAL DIAGRAMS THAT APPLY TO THE WORK ON THIS DRAWING. THESE DIAGRAMS PROVIDE GUIDANCE AS TO INSTALLATION INTENT AND DO NOT NECESSARILY SHOW ALL COMPONENTS REQUIRED.

SHEET NOTES:

- 4" CHS/CHR, 3" HWS/HWR UP TO AHU-4.2 AND AHU-4.3.
- 3" CHS/CHR, 2 1/2" HWS/HWR UP TO AHU-4.6 AND AHU-4.7.
- 2 1/2" CHS / CHR, 1 1/2" HWS / HWR DOWN TO LEVEL 1.
- PROVIDE NEW 10" CHS / CHR CONNECTION TO EXISTING 10" CHS / CHR PIPING AS SHOWN. PROVIDE WITH LINE SIZED ISOLATION VALVE AT CONNECTION.
- PROVIDE NEW 6" HWS / HWR CONNECTION TO EXISTING 6" HWS / HWR PIPING AS SHOWN. PROVIDE WITH LINE SIZED ISOLATION VALVE AT CONNECTION.
- 1 1/2" CHS / CHR, 1 1/4" HWS / HWR DN TO LEVEL 1.
- PROVIDE EXPANSION JOINT(S) AS REQUIRED.
- 3/4" CHS / CHR DN IN WALL TO ICE MAKER (ITEM #P4243). REFER TO FOOD SERVICE PLANS FOR EXACT LOCATION.




This document, and the ideas and designs incorporated herein, as an instrument of professional service, is the property of EDMONDSON REED ASSOCIATES, and is not to be used, in whole or in part, for any other project, without the written authorization of EDMONDSON REED ASSOCIATES.

- INTERIOR ARCHITECTURE**
 JCI Architecture
 120 Hayslope Avenue
 Suite 400
 Hartford, CT 06106
 860-247-9226
- STRUCTURAL ENGINEERING**
 Chavez-Grievos Consulting Engineers, Inc.
 4700 Lincoln Road NE
 Suite 102
 Albuquerque, NM 87109
 505-344-4080
- MEP ENGINEERING**
 MSA Engineering Consultants
 370 E. Windmill Ln.
 Suite 100
 Las Vegas, NV 89123
 702-996-1100
- CIVIL ENGINEERING / SURVEYING**
 Native Plans Surveying and Mapping / RK & Associates PLC
 5807 S. Garnett Rd.
 Suite K
 Tulsa, OK 74146
 918-234-7596
- LOW VOLTAGE / THEME LIGHTING**
 ME Engineers
 29 W. 38th St.
 5th Floor
 New York, NY 10018
 212-447-6770
- FOOD SERVICES**
 Heisman Group, LLC
 7645 E. 63rd St.
 Suite 201
 Tulsa, OK 74133
 918-935-5036

CHEROKEE HARD ROCK CASINO 4

CASINO 4

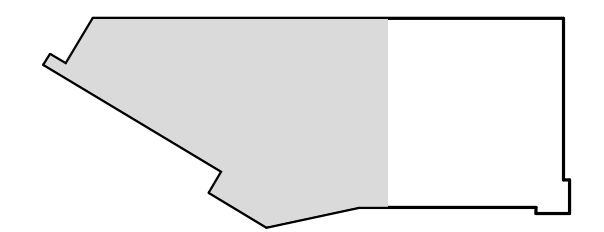

No.	Description	Date
2	ADDENDUM #2	05/04/2018
5	BULLETIN #2	06/14/2018

MECHANICAL PIPING SECOND FLOOR AREA 2

CONSTRUCTION SET

PROJECT NO.	L17325
DRAWN BY:	MSA
CHECKED BY:	PE
ISSUE DATE:	5/4/2018

M-222
 Scale 1/8" = 1'-0"



ENTIRE SHEET CHANGES

6/14/2018 11:41:35 AM

PLUMBING SYMBOL LIST

NOTE: THIS IS A MASTER SCHEDULE. NOT ALL SYMBOLS CONTAINED HEREIN MAY APPEAR ON THE DRAWINGS.

---X---	ITEM TO BE REMOVED	---RD---	ROOF DRAIN PIPING
◆	POINT OF CONNECTION/DISCONNECTION	---AV---	ACID VENT PIPING
◇	SHEET NOTE	---AW---	ABOVE GROUND ACID WASTE PIPING
△	REVISION NUMBER	---AW---	UNDERGROUND ACID WASTE PIPING
⬢	EQUIPMENT MARK	---V---	VENT PIPING
⬢	ACCESS PANEL	---AW---	ABOVE GROUND WASTE PIPING
+	CLEAN OUT	---W---	UNDERGROUND WASTE PIPING
⊥	WALL CLEAN OUT	---GW---	ABOVE GROUND GREASE WASTE PIPING
⊥	FLOOR CLEAN OUT	---GW---	UNDERGROUND GREASE WASTE PIPING
⊥	GRADE CLEAN OUT	---GW---	ABOVE GROUND GW PIPING W/HEAT TRACE
⊥	FLOOR DRAIN	---GW---	UNDERGROUND GW PIPING W/HEAT TRACE
⊥	FLOOR SINK	⊥	CIRCUIT SETTER
⊥	FLOOR SINK W/ GRATE	⊥	2-WAY ELECTRONIC CONTROL VALVE
⊥	ROOF DRAIN	⊥	3-WAY ELECTRONIC CONTROL VALVE
⊥	OVERFLOW ROOF DRAIN	⊥	2-WAY PNEUMATIC CONTROL VALVE
⊥	VENT THRU ROOF	⊥	3-WAY PNEUMATIC CONTROL VALVE
⊥	FLOW SWITCH	⊥	SOLENOID VALVE
⊥	GAS REGULATOR	⊥	BUTTERFLY VALVE
⊥	GAS METER	⊥	PLUG VALVE
⊥	WATER METER	⊥	GAS COCK
⊥	WATER HAMMER ARRESTOR	⊥	BALL VALVE
⊥	SHUT-OFF VALVE IN IRRIGATION BOX	⊥	CHECK VALVE
⊥	BACKFLOW PREVENTION STATION	⊥	GATE VALVE
⊥	HOSE BIBB	⊥	HOSE END DRAIN VALVE
⊥	COMPRESSED AIR LINES	⊥	PRESSURE REDUCING VALVE
⊥	CONDENSATE DRAIN PIPING	⊥	RELIEF VALVE
⊥	PUMPED CONDENSATE DRAIN PIPING	⊥	TEMPERATURE PRESSURE RELIEF VALVE
⊥	DRAIN PIPING	⊥	THERMOMETER
⊥	COLD WATER PIPING	⊥	PRESSURE GAUGE WITH GAUGE COCK
⊥	INDUSTRIAL COLD WATER PIPING	⊥	MANUAL AIR VENT
⊥	INDUSTRIAL SOFTENED COLD WATER PIPING	⊥	PRESSURE TEMPERATURE PORT
⊥	SOFTENED COLD WATER PIPING	⊥	Y-STRAINER WITH BLOWDOWN
⊥	FIRE PROTECTION PIPING	⊥	PIPE GUIDE
⊥	HIGH PRESSURE GAS PIPING	⊥	UNION
⊥	LOW PRESSURE GAS PIPING	⊥	PIPE ANCHOR
⊥	MEDIUM PRESSURE GAS PIPING	⊥	FLEXIBLE CONNECTOR
⊥	GAS VENT PIPING	⊥	PIPE CAP/STUB-OUT
⊥	HOT WATER PIPING	⊥	DIRECTION OF FLOW
⊥	140° HOT WATER PIPING	⊥	PIPE DOWN
⊥	HOT WATER RETURN PIPING	⊥	PIPE UP
⊥	TEMPERED WATER PIPING	⊥	PIPE TEE UP
⊥	OVERFLOW ROOF DRAIN PIPING	⊥	PIPE TEE DOWN

PLUMBING ABBREVIATIONS

NOTE: THIS IS A MASTER SCHEDULE. NOT ALL ABBREVIATIONS CONTAINED HEREIN MAY APPEAR ON THE DRAWINGS.

AABC	AMERICAN AIR BALANCE COUNCIL	GCO	GRADE CLEANOUT	PD	PRESSURE DROP
ACC	AUTOMATIC CONTROL DAMPER	GI	GREASE INTERCEPTOR	PRV	PRESSURE REDUCING VALVE
AFF	ABOVE FINISHED FLOOR	GPF	GALLONS PER FLUSH	PSI	POUNDS PER SQUARE INCH
AP	ACCESS PANEL	GPM	GALLONS PER MINUTE	PSIA	POUNDS PER SQUARE INCH ABSOLUTE
ASHRAE	AMERICAN SOCIETY OF HEATING, REFRIGERATION AND AIR CONDITIONING ENGINEERS	GR	GLYCOL RETURN	PSID	DIFFERENTIAL POUNDS PER SQUARE INCH
ASPE	AMERICAN SOCIETY OF PLUMBING ENGINEERS	GS	GLYCOL SUPPLY	PSIG	DIFFERENTIAL POUNDS PER SQUARE INCH GAUGE
BFD	BACKFLOW PREVENTION DEVICE	GW	GREASE WASTE	(R)	EXISTING TO BE RELOCATED
BHP	BRAKE HORSEPOWER	HD	HEAD	RA	RETURN AIR
BTUH	BRITISH THERMAL UNIT PER HOUR	HP	HORSEPOWER	RH	RELATIVE HUMIDITY
CD	CONDENSATE DRAIN	HRS	HOUR	RUS	REFRIGERANT LIQUID/SUCTION
CFM	CUBIC FEET PER MINUTE	HSPF	HEATING SEASONAL PERFORMANCE FACTOR	RPM	REVOLUTIONS PER MINUTE
CHAR	CHARACTERISTICS	HW	HOT WATER	RPPA	REDUCED PRESSURE PRINCIPAL ASSEMBLY
CHR	CHILLED WATER RETURN	HWR	HEATING HOT WATER RETURN	RVD	REMOTE VOLUME DAMPER
CHS	CHILLED WATER SUPPLY	HWS	HEATING HOT WATER SUPPLY	SA	SUPPLY AIR
CO	CLEANOUT	IE	INVERT ELEVATION	SD	SMOKE DAMPER
CR	CONDENSER WATER RETURN	IBC	INTERNATIONAL BUILDING CODE	SEER	SEASONAL ENERGY EFFICIENCY RATIO
CS	CONDENSER WATER SUPPLY	IMC	INTERNATIONAL MECHANICAL CODE	SOI	SAND OIL INTERCEPTOR
CW	COLD WATER	IPC	INTERNATIONAL PLUMBING CODE	"SP"	STATIC PRESSURE (INCHES OF W.C.)
D	DRAIN	KW	KILOWATT	SPECS	SPECIFICATIONS
DB	DRY BULB TEMPERATURE	LAT	LEAVING AIR TEMPERATURE	SO	SQUARE
DDC	DIRECT DIGITAL CONTROL	LBS	POUNDS	SOFT	SQUARE FEET
DIA	DIAMETER	LWT	LEAVING WATER TEMPERATURE	SS	STAINLESS STEEL
DN	DOWN	MAX	MAXIMUM	T	TEMPERATURE
DX	DIRECT EXPANSION	MBH	ONE THOUSAND BTUH	TAB	TEST AND BALANCE REPORT
(E)	EXISTING TO REMAIN	MCA	MINIMUM CIRCUIT AMPS	TSP	TOTAL STATIC PRESSURE
EA	EXHAUST AIR	MIN	MINIMUM	TW	TEMPERED WATER
EAT	ENTERING AIR TEMPERATURE	MOCPP	MAXIMUM OVERCURRENT PROTECTION	TYP	TYPICAL
EC	ELECTRICAL CONTRACTOR	MPG	MEDIUM PRESSURE GAS	UBC	UNIFORM BUILDING CODE
EER	ENERGY EFFICIENCY RATIO	MVD	MANUAL VOLUME DAMPER	UMC	UNIFORM MECHANICAL CODE
EFF	EFFICIENCY	N/A	NOT APPLICABLE	UNC	UNLESS OTHERWISE NOTED
ELEC	ELECTRICAL	NC	NORMALLY CLOSED	UPC	UNIFORM PLUMBING CODE
ESP	EXTERNAL STATIC PRESSURE	NEBB	NATIONAL ENVIRONMENTAL BALANCING BUREAU	V	VENT
EWT	ENTERING WATER TEMPERATURE	NEC	NATIONAL FIRE PROTECTION ASSOCIATION	V/PHHZ	VOLTAGE/PHASE/HERTZ
F	FAHRENHEIT	NFPA	NATIONAL FIRE PROTECTION ASSOCIATION	VFD	VARIABLE FREQUENCY DRIVE
FCD	FLOOR CLEANOUT	NIC	NOT IN CONTRACT	VTR	VENT THROUGH ROOF
FD	FIRE DAMPER	NO	NORMALLY OPEN	WB	WET BULB TEMPERATURE
FPM	FEET PER MINUTE	NTS	NOT TO SCALE	WCO	WALL CLEANOUT
FSD	FIRE SMOKE DAMPER	OA	OUTSIDE AIR	WG	WATER GAUGE
G	GAS	OAT	OUTSIDE AIR TEMPERATURE	WMS	WIRE MESH SCREEN
GA	GAGE OR GAUGE	OBD	OPPOSED BLADE DAMPER	(X)	EXISTING TO BE REMOVED
GAL	GALLONS	ODD	OPEN END DUCT		
		OFCI	OWNER FURNISHED, CONTRACTOR INSTALLED		

PLUMBING - DRAWING INDEX

SHEET NUMBER	SHEET NAME	NOT FOR CONSTRUCTION			
		4/16/2018 - BID SET	5/4/2018 - ADDENDUM #2	06/14/18 - BULLETIN #2	MM.DD.YYYY
P-000	PLUMBING ABBREVIATIONS AND SYMBOLS LIST	X	X	X	
P-001	PLUMBING SPECIFICATIONS	X	X	X	
P-002	PLUMBING SCHEDULES	X	X	X	
P-003	PLUMBING DIAGRAMS	X	X	X	
P-004	PLUMBING GAS ISOMETRIC DIAGRAM	X	X	X	
P-100	PLUMBING SITE PLAN	X	X	X	
P-110	PLUMBING FIRST FLOOR PLAN OVERALL - WASTE AND VENT	X	X	X	
P-111	PLUMBING FIRST FLOOR AREA 1 - WASTE AND VENT	X	X	X	
P-112	PLUMBING FIRST FLOOR AREA 2 - WASTE AND VENT	X	X	X	
P-120	PLUMBING SECOND FLOOR PLAN OVERALL - WASTE AND VENT	X	X	X	
P-121	PLUMBING SECOND FLOOR AREA 1 - WASTE AND VENT	X	X	X	
P-122	PLUMBING SECOND FLOOR AREA 2 - WASTE AND VENT	X	X	X	
P-160	PLUMBING OVERALL ROOF PLAN	X	X	X	
P-161	PLUMBING ROOF AREA 1	X	X	X	
P-162	PLUMBING ROOF AREA 2	X	X	X	
P-210	PLUMBING FIRST FLOOR PLAN OVERALL - DOMESTIC WATER	X	X	X	
P-211	PLUMBING FIRST FLOOR AREA 1 - DOMESTIC WATER	X	X	X	
P-212	PLUMBING FIRST FLOOR AREA 2 - DOMESTIC WATER	X	X	X	
P-220	PLUMBING SECOND FLOOR PLAN OVERALL - DOMESTIC WATER	X	X	X	
P-221	PLUMBING SECOND FLOOR AREA 1 - DOMESTIC WATER	X	X	X	
P-222	PLUMBING SECOND FLOOR AREA 2 - DOMESTIC WATER	X	X	X	
P-410	PLUMBING WASTE AND VENT ENLARGED PLANS	X	X	X	
P-411	PLUMBING WATER AND GAS ENLARGED PLANS	X	X	X	
PFS-101	PLUMBING ENLARGED WASTE & VENT PLAN - FOOD SERVICE	X	X	X	
PFS-102	PLUMBING ENLARGED WASTE & VENT PLAN - FOOD SERVICE	X	X	X	
PFS-103	PLUMBING ENLARGED WASTE & VENT PLAN - FOOD SERVICE	X	X	X	
PFS-104	PLUMBING ENLARGED WTR & GAS PLAN - FOOD SERVICE	X	X	X	
PFS-105	PLUMBING ENLARGED WTR & GAS PLAN - FOOD SERVICE	X	X	X	
PFS-106	PLUMBING ENLARGED WTR & GAS PLAN - FOOD SERVICE	X	X	X	
Grand total: 29					



This document, and the ideas and designs incorporated herein, as an instrument of professional service, is the property of EDMONDSON REED ASSOCIATES, and is not to be used, in whole or in part, for any other project, without the written authorization of EDMONDSON REED ASSOCIATES.

INTERIOR ARCHITECTURE
CJ Architecture
120 Hayslope Avenue
Suite 400
Hartford, CT 06106
860-247-9226

STRUCTURAL ENGINEERING
Chavez-Grievens Consulting Engineers, Inc.
4700 Lincoln Road NE
Suite 102
Albuquerque, NM 87109
505-344-4080

MEP ENGINEERING
MSA Engineering Consultants
370 E. Windmill Ln.
Suite 100
Las Vegas, NV 89123
702-996-1100

CIVIL ENGINEERING / SURVEYING
Native Plans Surveying and Mapping / RK & Associates PLC
5807 S. Garnett Rd.
Suite K
Tulsa, OK 74146
918-234-7596

LOW VOLTAGE / THEME LIGHTING
ME Engineers
29 W. 38th St.
5th Floor
New York, NY 10018
212-447-6770

FOOD SERVICES
Hestman Group, LLC
7645 E. 63rd St.
Suite 201
Tulsa, OK 74133
918-935-5036

CHEROKEE HARD ROCK CASINO 4

CASINO 4



No.	Description	Date
2	ADDENDUM #2	05/04/2018
5	BULLETIN #2	06/14/2018

PLUMBING ABBREVIATIONS AND SYMBOLS LIST

CONSTRUCTION SET

PROJECT NO: L17325
DRAWN BY: MSA
CHECKED BY: PE
ISSUE DATE: 5/4/2018

P-000
Scale 12" = 1'-0"

6/14/2018 1:18:57 PM



This document, and the ideas and designs incorporated herein, as an instrument of professional service, is the property of EDMONSON REED ASSOCIATES, and is not to be used, in whole or in part, for any other project, without the written authorization of EDMONSON REED ASSOCIATES.

INTERIOR ARCHITECTURE

JCI Architecture
120 Hayslope Avenue
Suite 400
Hartford, CT 06106
860-247-9226

STRUCTURAL ENGINEERING

Chavez-Grievos Consulting Engineers, Inc.
4700 Lincoln Road NE
Suite 102
Albuquerque, NM 87109
505-344-4080

MEP ENGINEERING

MSA Engineering Consultants
370 E. Windmill Ln.
Suite 100
Las Vegas, NV 89123
702-995-1100

CIVIL ENGINEERING / SURVEYING

Native Plans Surveying and Mapping / RK & Associates PLC
5807 S. Garnett Rd.
Suite K
Tulsa, OK 74146
918-234-7596

LOW VOLTAGE / THEME LIGHTING

ME Engineers
29 W. 38th St.
5th Floor
New York, NY 10018
212-447-6770

FOOD SERVICES

Hestman Group, LLC
7645 E. 63rd St.
Suite 201
Tulsa, OK 74133
918-935-5036


CHEROKEE HARD ROCK CASINO 4

GENERAL NOTES:

1. ALL WATER PIPING SHALL BE INSTALLED ON THE INTERIOR SIDE OF THE BUILDING.
2. THE CUTTING, NOTCHING AND BORING OF HOLES IN FLOOR JOIST AND WALL STUDS SHALL BE IN ACCORDANCE WITH THE LATEST APPROVED EDITION OF THE INTERNATIONAL BUILDING CODE.
3. CONTRACTOR SHALL BE RESPONSIBLE FOR THE COORDINATION OF ALL PLUMBING ROUGH-IN LOCATIONS. REFER TO ARCHITECTURAL DRAWINGS FOR FIXTURES AND EQUIPMENT LOCATIONS.
4. CONTRACTOR SHALL BE RESPONSIBLE FOR ALL CUTTING AND PATCHING AS REQUIRED TO ACCOMMODATE HIS WORK.
5. SANITARY DRAINAGE PIPING SHALL BE SLOPED UNDER 3" AT 1/4" PER FOOT, 3" AND LARGER AT 1/8" PER FOOT.
6. PLUMBING CONTRACTOR SHALL COORDINATE ROUTING OF PIPING WITH ALL OTHER TRADES PRIOR TO COMMENCING WORK.
7. ALL PLUMBING FIXTURES SHALL BE WATER CONSERVATION TYPE AS MANDATED BY LOCAL BUILDING DEPARTMENT.
8. ALL WATER CLOSETS DESIGNATED AS ACCESSIBLE SHALL BE INSTALLED SUCH THAT THE ACTUATOR IS OPERABLE FROM THE WIDE SIDE OF THE WATER CLOSET.
9. PRIOR TO INSTALLATION OF SEWER AND WATER PIPING BELOW GRADE COORDINATE EXACT LOCATIONS AND DEPTHS OF BURIAL WITH CIVIL AND FOUNDATION DRAWINGS AND CORRESPONDING ENGINEERS.
10. REFER TO THE PLUMBING DIAGRAMS THAT APPLY TO THE WORK ON THIS DRAWING. THESE DIAGRAMS PROVIDE GUIDANCE AS TO INSTALLATION INTENT AND DO NOT NECESSARILY SHOW ALL COMPONENTS REQUIRED.

SHEET NOTES:

1. REFER TO PLUMBING SITE PLAN & CIVIL UTILITY PLANS FOR CONTINUATION.
2. REFER TO SHEET P-112 FOR CONTINUATION.
3. 4" RD & ORD UP TO RD-1 & ORD-1 ON PORTE COCHERE.
4. PROVIDE DSN-1 FOR PRIMARY RD AT 10' ABOVE GRADE AND DSN-1 FOR SECONDARY ORD AT 1'-6" ABOVE GRADE STACKED IN VERTICAL.

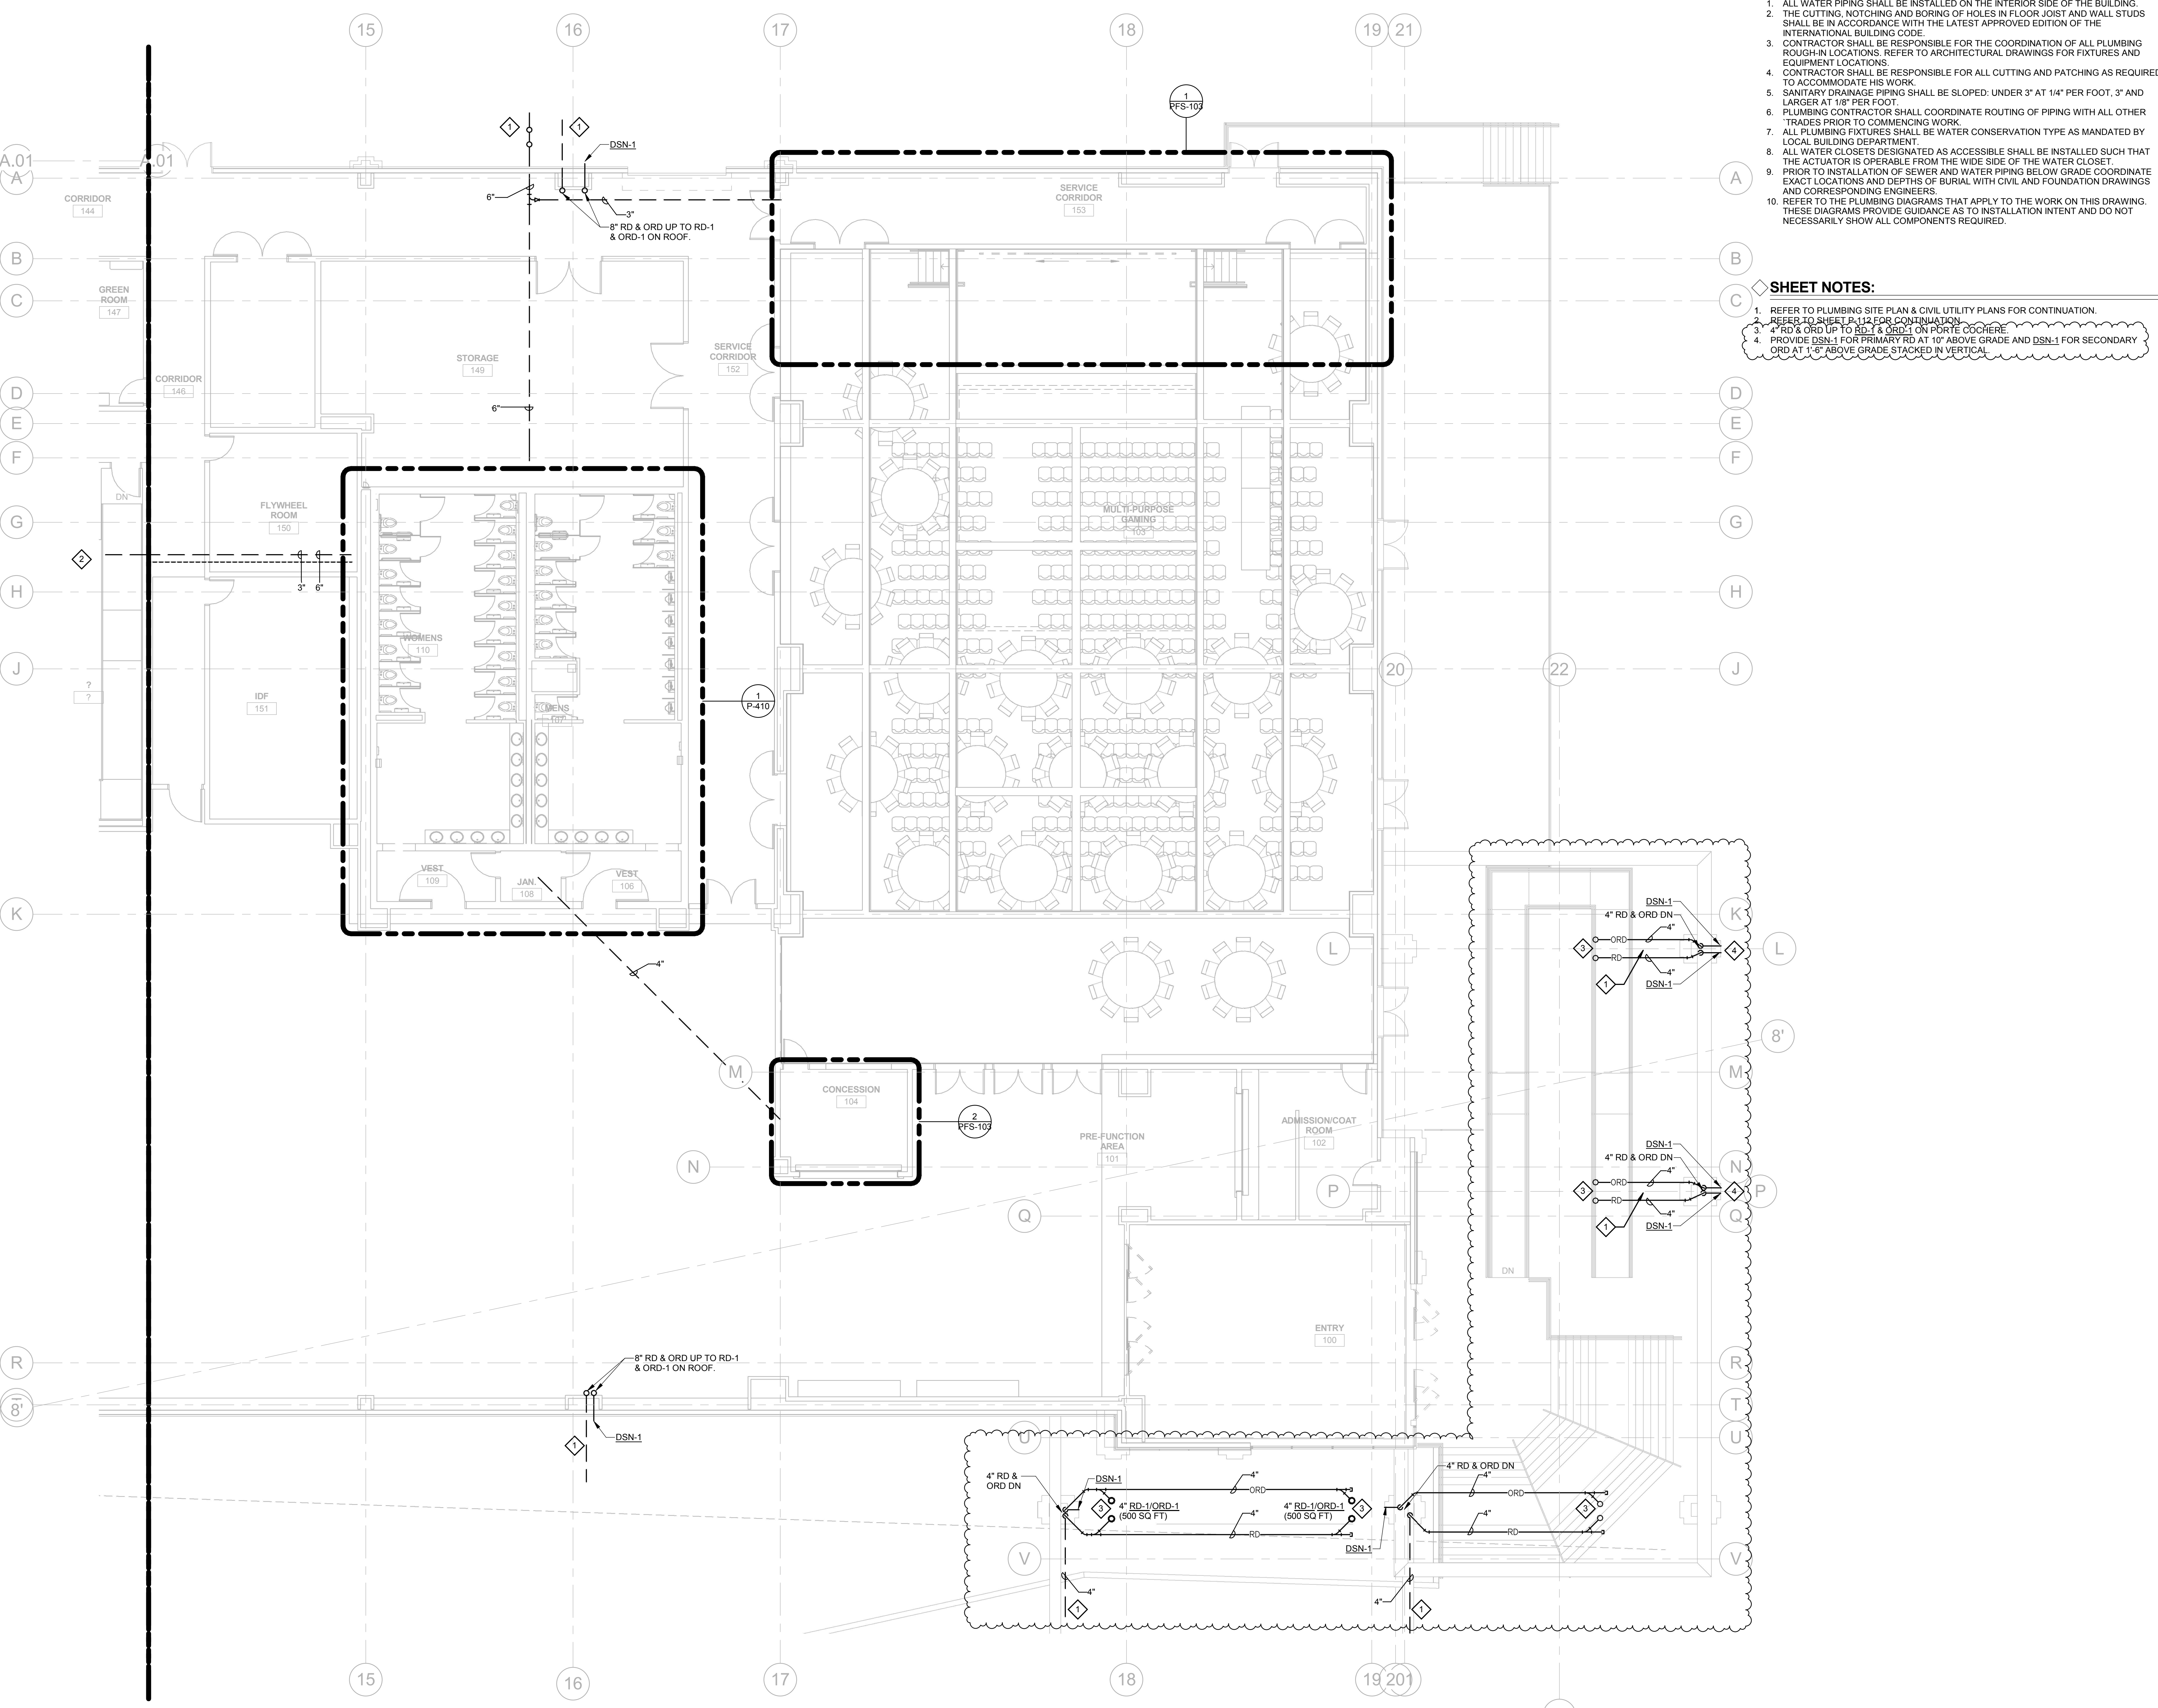


1 Level 1 - Plumbing DW&V Plan Area 1
P-111 1/8" = 1'-0"



6/14/2018 1:44:49 PM



CASINO 4

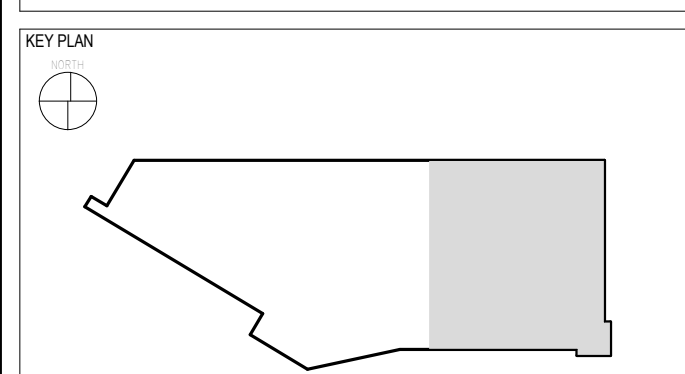

No.	Description	Date
2	ADDENDUM #2	05/04/2018
5	BULLETIN #2	06/14/2018

CONSTRUCTION SET

PROJECT NO.	L17325
OWNER:	MSA
CHKD BY:	PE
ISSUE DATE:	5/4/2018

P-111

Scale 1/8" = 1'-0"

This document, and the ideas and designs incorporated herein, as an instrument of professional service, is the property of EDMONDSON REED ASSOCIATES, and is not to be used, in whole or in part, for any other project, without the written authorization of EDMONDSON REED ASSOCIATES.

INTERIOR ARCHITECTURE
 ICI Architecture
 1200 Haysboro Avenue
 Suite 400
 Hartford, CT 06106
 860-247-9226

STRUCTURAL ENGINEERING
 Chavez-Grievos Consulting Engineers, Inc.
 4700 Lincoln Road NE
 Suite 102
 Albuquerque, NM 87109
 505-344-4080

MEP ENGINEERING
 MSA Engineering Consultants
 370 E. Windmill Ln.
 Suite 100
 Las Vegas, NV 89123
 702-996-1100


CIVIL ENGINEERING / SURVEYING
 Native Plans Surveying and Mapping / RK & Associates PLC
 5807 S. Garnett Rd.
 Suite K
 Tulsa, OK 74146
 918-234-7596

LOW VOLTAGE / THEME LIGHTING
 ME Engineers
 29 W. 38th St.
 5th Floor
 New York, NY 10018
 212-447-6770

FOOD SERVICES
 Heisman Group, LLC
 7645 E. 63rd St.
 Suite 201
 Tulsa, OK 74133
 918-935-5036

CHEROKEE HARD ROCK CASINO 4

CASINO 4

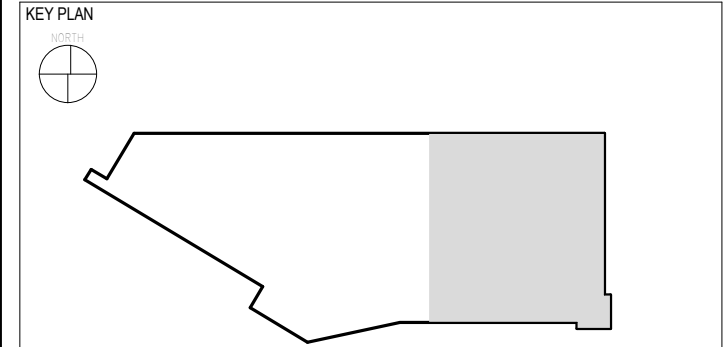

No.	Description	Date
2	ADDENDUM #2	05/04/2018
5	BULLETIN #2	06/14/2018

PLUMBING SECOND FLOOR AREA 1 - WASTE AND VENT

CONSTRUCTION SET

PROJECT NO: L17325
 DRAWN BY: MSA
 CHECKED BY: PE
 ISSUE DATE: 5/4/2018


P-121
 Scale: 1/8" = 1'-0"

GENERAL NOTES:


- ALL WATER PIPING SHALL BE INSTALLED ON THE INTERIOR SIDE OF THE BUILDING. THE CUTTING, NOTCHING AND BORING OF HOLES IN FLOOR JOIST AND WALL STUDS SHALL BE IN ACCORDANCE WITH THE LATEST APPROVED EDITION OF THE INTERNATIONAL BUILDING CODE.
- CONTRACTOR SHALL BE RESPONSIBLE FOR THE COORDINATION OF ALL PLUMBING ROUGH-IN LOCATIONS. REFER TO ARCHITECTURAL DRAWINGS FOR FIXTURES AND EQUIPMENT LOCATIONS.
- CONTRACTOR SHALL BE RESPONSIBLE FOR ALL CUTTING AND PATCHING AS REQUIRED TO ACCOMMODATE HIS WORK.
- SANITARY DRAINAGE PIPING SHALL BE SLOPED UNDER 3" AT 14" PER FOOT, 3" AND LARGER AT 1/8" PER FOOT.
- PLUMBING CONTRACTOR SHALL COORDINATE ROUTING OF PIPING WITH ALL OTHER TRADES PRIOR TO COMMENCING WORK.
- ALL PLUMBING FIXTURES SHALL BE WATER CONSERVATION TYPE AS MANDATED BY LOCAL BUILDING DEPARTMENT.
- ALL WATER CLOSETS DESIGNATED AS ACCESSIBLE SHALL BE INSTALLED SUCH THAT THE ACTUATOR IS OPERABLE FROM THE WIDE SIDE OF THE WATER CLOSET.
- PRIOR TO INSTALLATION OF SEWER AND WATER PIPING BELOW GRADE, COORDINATE EXACT LOCATIONS AND DEPTHS OF BURIAL WITH CIVIL AND FOUNDATION DRAWINGS AND CORRESPONDING ENGINEERS.
- REFER TO THE PLUMBING DIAGRAMS THAT APPLY TO THE WORK ON THIS DRAWING. THESE DIAGRAMS PROVIDE GUIDANCE AS TO INSTALLATION INTENT AND DO NOT NECESSARILY SHOW ALL COMPONENTS REQUIRED.

SHEET NOTES:

- 8" RD & ORD DN. REFER TO PLUMBING FIRST FLOOR PLANS AND SITE PLAN FOR CONTINUATION.
- 3" VENT FROM BELOW. TERMINATE 3" VTR ON ROOF.
- REFER TO SHEET P-122 FOR CONTINUATION.

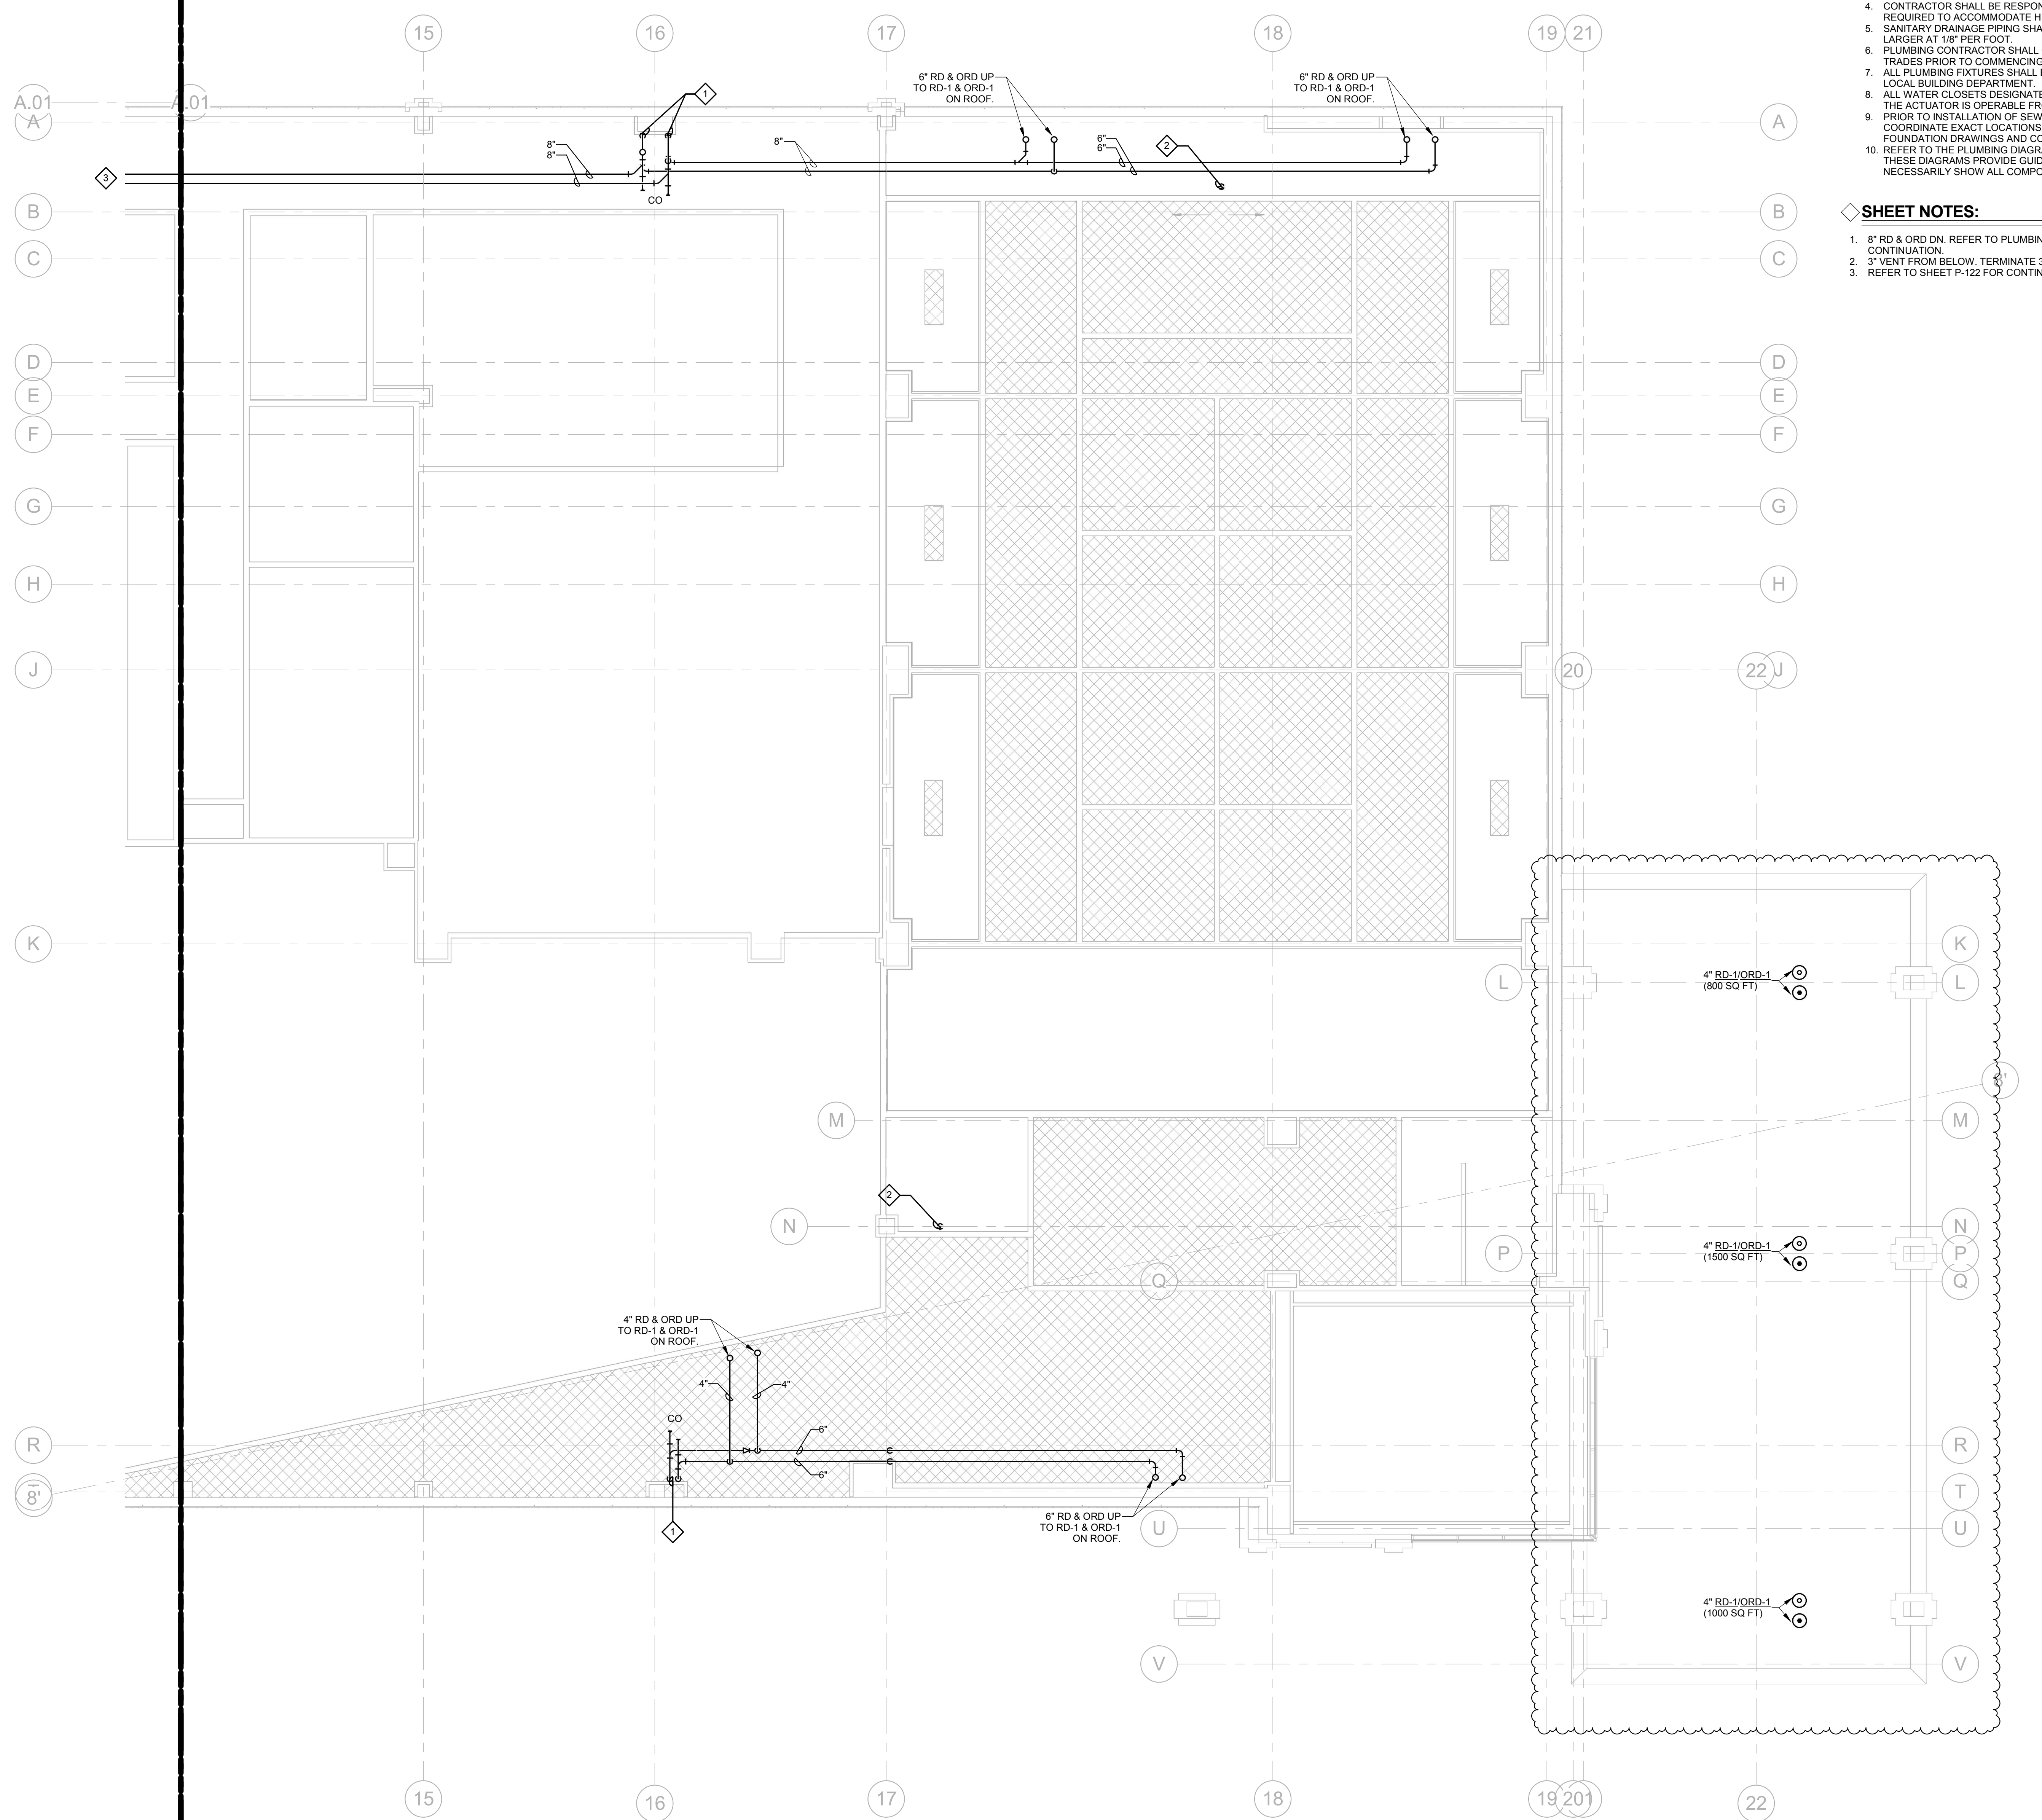

1 Level 2 - Plumbing DW&V Plan Area 1
 P-121 1/8" = 1'-0"

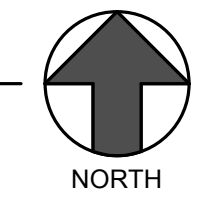

6/14/2018 1:36:22 PM



This document, and the ideas and designs incorporated herein, as an instrument of professional service, is the property of EDMONDSON REED ASSOCIATES, and is not to be used, in whole or in part, for any other project, without the written authorization of EDMONDSON REED ASSOCIATES.

INTERIOR ARCHITECTURE

OCI Architecture
120 Hayslope Avenue
Suite 400
Hartford, CT 06106
860-247-9226

STRUCTURAL ENGINEERING

Chavez-Grievos Consulting Engineers, Inc.
4700 Lincoln Road NE
Suite 102
Albuquerque, NM 87109
505-344-4080

MEP ENGINEERING

MSA Engineering Consultants
370 E. Windmill Ln.
Suite 100
Las Vegas, NV 89123
702-996-1100

CIVIL ENGINEERING / SURVEYING

Native Plans Surveying and Mapping / RK & Associates PLC
5807 S. Garnett Rd.
Suite K
Tulsa, OK 74146
918-234-7596

LOW VOLTAGE / THEME LIGHTING


ME Engineers
29 W. 38th St.
5th Floor
New York, NY 10018
212-447-6770

FOOD SERVICES

Hestman Group, LLC
7645 E. 63rd St.
Suite 201
Tulsa, OK 74133
918-935-5036

CHEROKEE HARD ROCK CASINO 4

CASINO 4

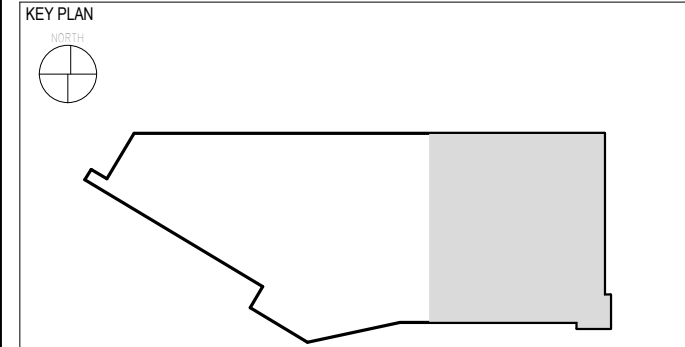

No.	Description	Date
2	ADDENDUM #2	05/04/2018
5	BULLETIN #2	06/14/2018

PLUMBING ROOF AREA 1

CONSTRUCTION SET

PROJECT NO: L17325
DRAWN BY: MSA
CHKD BY: PE
ISSUE DATE: 5/4/2018


P-161
Scale: 1/8" = 1'-0"

GENERAL NOTES:


- ALL WATER PIPING SHALL BE INSTALLED ON THE INTERIOR SIDE OF THE BUILDING.
- THE CUTTING, NOTCHING AND BORING OF HOLES IN FLOOR JOIST AND WALL STUDS SHALL BE IN ACCORDANCE WITH THE LATEST APPROVED EDITION OF THE INTERNATIONAL BUILDING CODE.
- CONTRACTOR SHALL BE RESPONSIBLE FOR THE COORDINATION OF ALL PLUMBING ROUGH-IN LOCATIONS. REFER TO ARCHITECTURAL DRAWINGS FOR FIXTURES AND EQUIPMENT LOCATIONS.
- CONTRACTOR SHALL BE RESPONSIBLE FOR ALL CUTTING AND PATCHING AS REQUIRED TO ACCOMMODATE HIS WORK.
- SANITARY DRAINAGE PIPING SHALL BE SLOPED UNDER 3" AT 1/4" PER FOOT, 3" AND LARGER AT 1/8" PER FOOT.
- PLUMBING CONTRACTOR SHALL COORDINATE ROUTING OF PIPING WITH ALL OTHER TRADES PRIOR TO COMMENCING WORK.
- ALL PLUMBING FIXTURES SHALL BE WATER CONSERVATION TYPE AS MANDATED BY LOCAL BUILDING DEPARTMENT.
- ALL WATER CLOSETS DESIGNATED AS ACCESSIBLE SHALL BE INSTALLED SUCH THAT THE ACTUATOR IS OPERABLE FROM THE WIDE SIDE OF THE WATER CLOSET.
- PRIOR TO INSTALLATION OF SEWER AND WATER PIPING BELOW GRADE COORDINATE EXACT LOCATIONS AND DEPTHS OF BURIAL WITH CIVIL AND FOUNDATION DRAWINGS AND CORRESPONDING ENGINEERS.
- REFER TO THE PLUMBING DIAGRAMS THAT APPLY TO THE WORK ON THIS DRAWING. THESE DIAGRAMS PROVIDE GUIDANCE AS TO INSTALLATION INTENT AND DO NOT NECESSARILY SHOW ALL COMPONENTS REQUIRED.

SHEET NOTES:

- 4" OPENING FOR PRIMARY DRAIN. 4" OPENING 2" HIGHER FROM SECONDARY DRAIN.
- MECHANICAL EQUIPMENT, SHOWN FOR REFERENCE.
- COPPER CONDENSATE DRAIN PIPING SHALL BE PROVIDED WITH PIPE SUPPORT STAND ON ROOF. MAPA MODEL MS-1-X-A10, OR APPROVED EQUIVALENT. PIPE SUPPORT SPACING SHALL BE 7 FT MAXIMUM FOR 1 1/4" PIPE SIZE, 8 FT MAXIMUM FOR 1 1/2" AND 2", AND 10 FT MAXIMUM FOR 3" PIPE SIZE.
- SPILL CONDENSATE DRAIN TO ROOF DRAIN WITH 90 DEGREE ELBOWS.
- 1" CW DN.

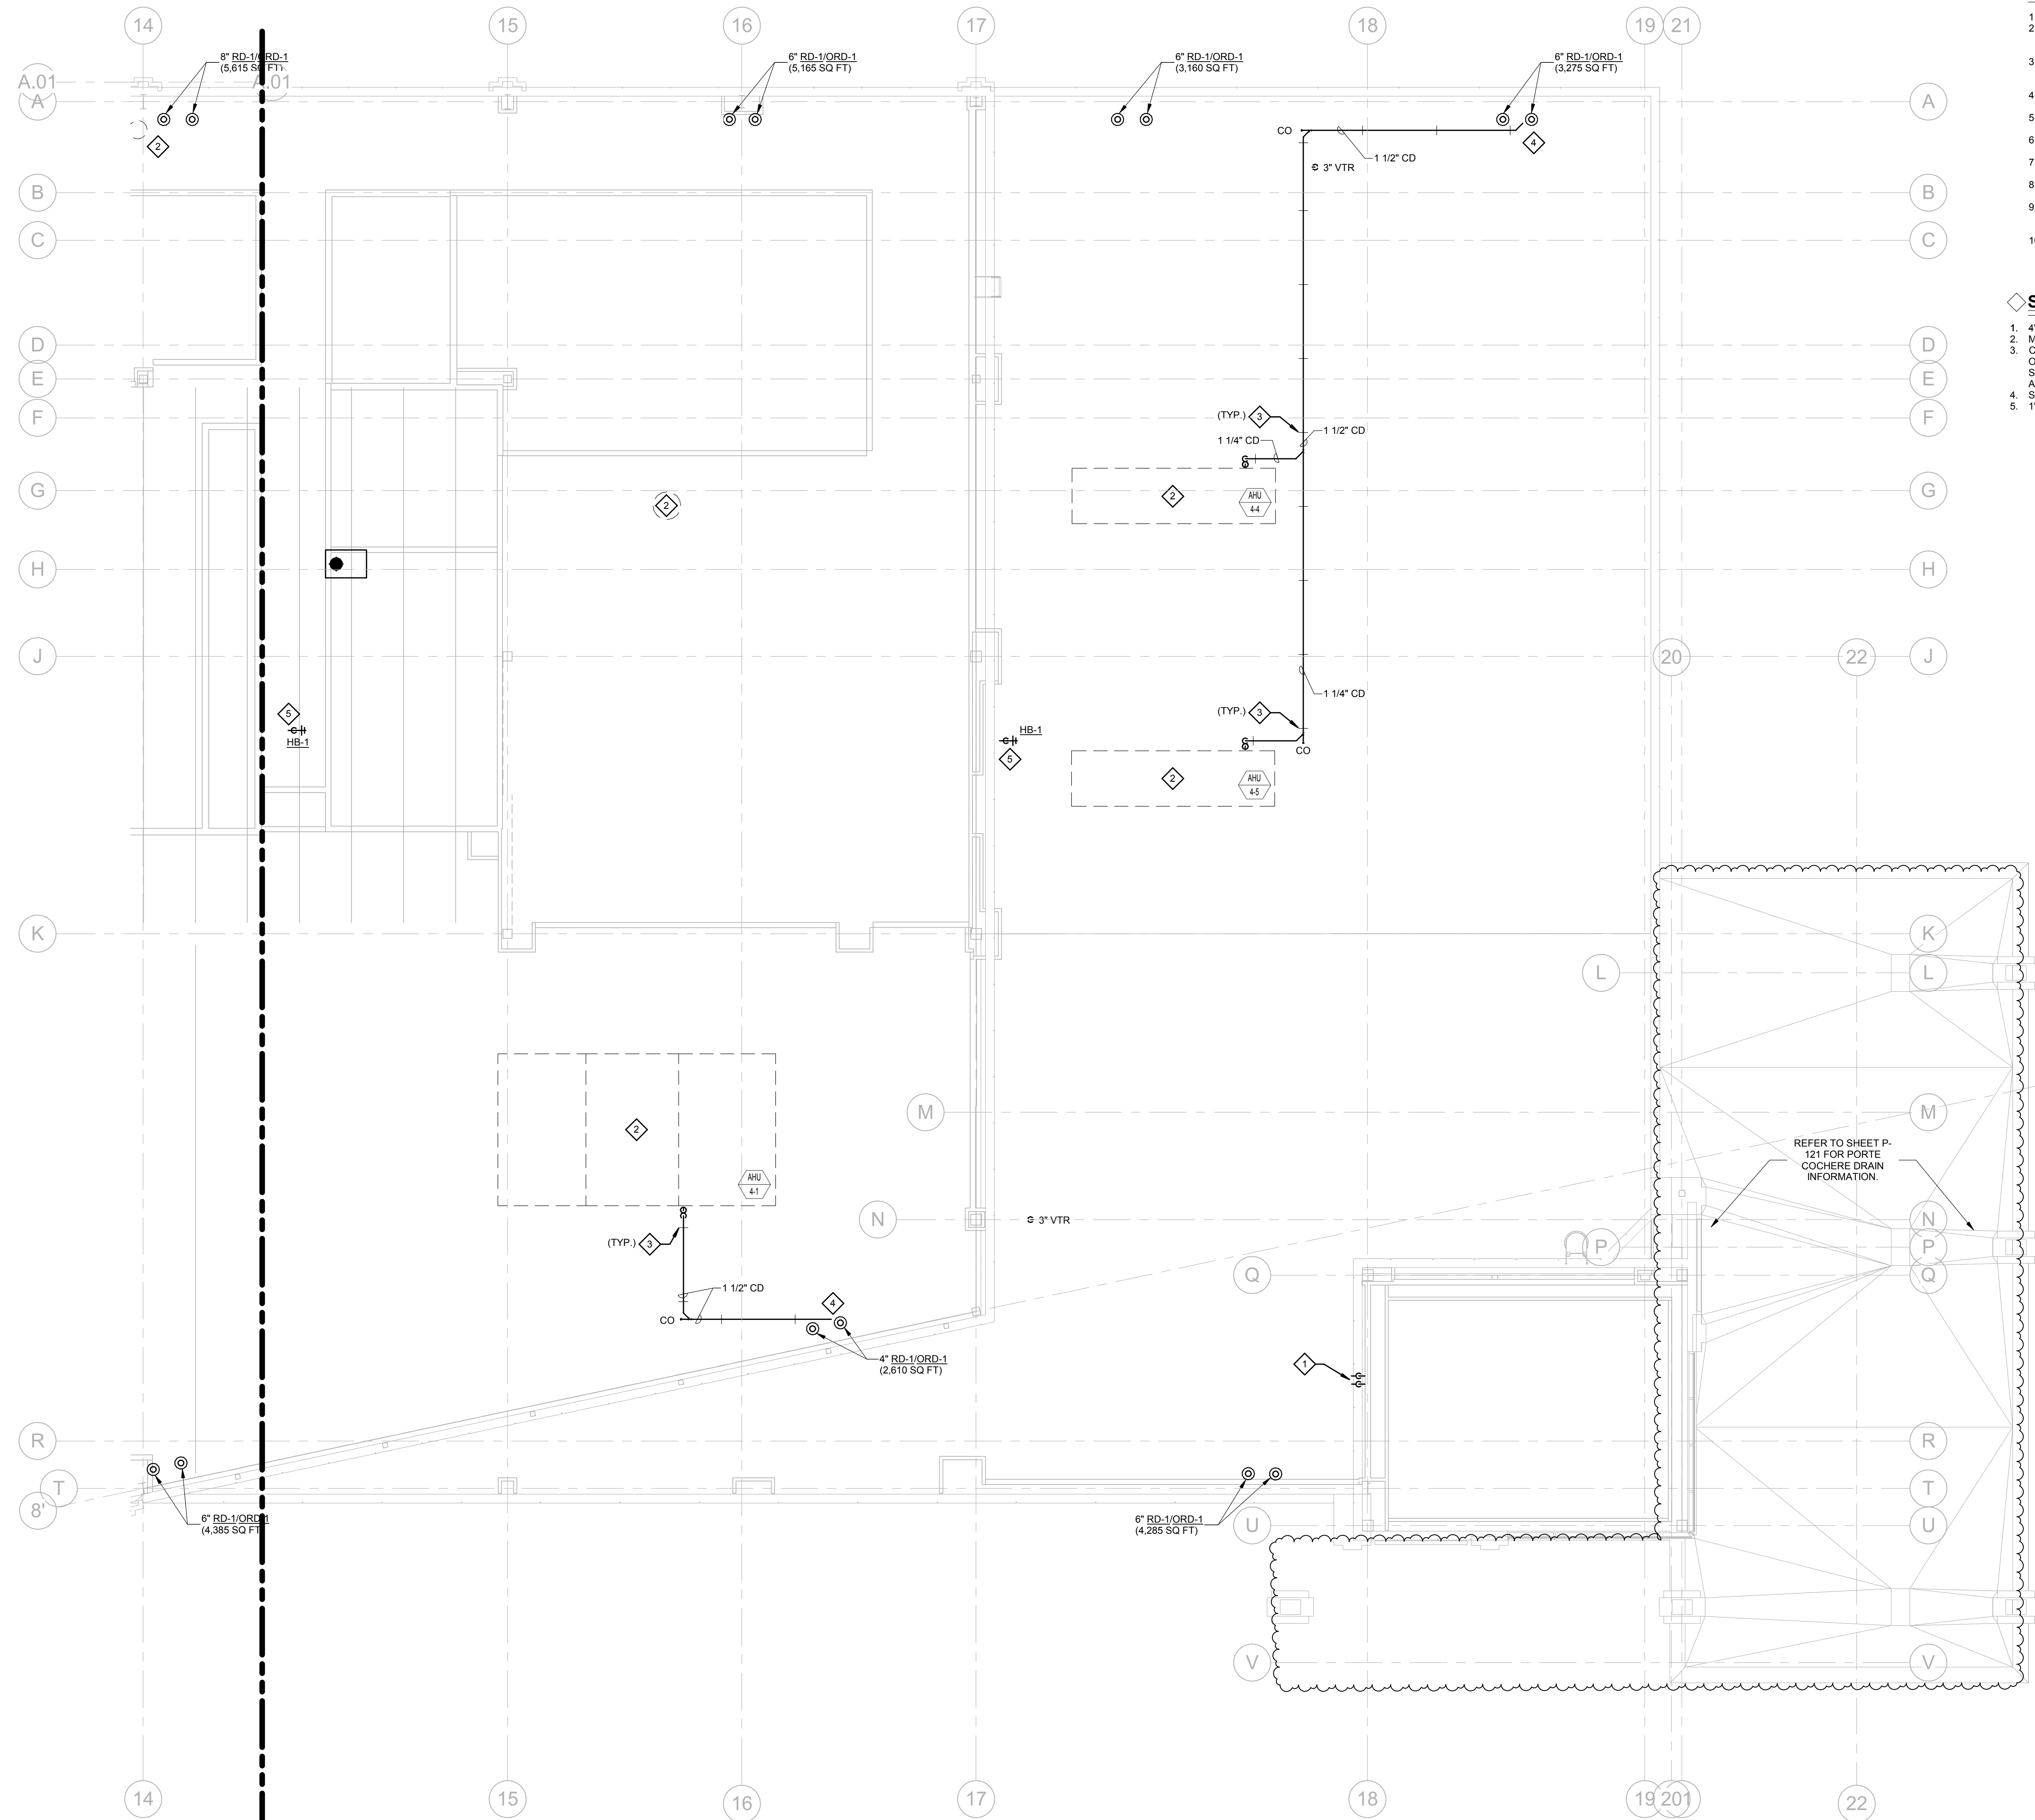

1 Roof - Plumbing Roof Plan area 1
P-161 1/8" = 1'-0"

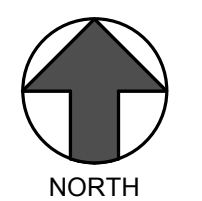

01/14/2018 11:42:36 AM

