# CHEROKEE NATION HOUSING AUTHORITY

# PLANS FOR

# DOGWOOD ADDITION NO. 2

LOTS 1-6

STREET, WATER, SANITARY SEWER AND DRAINAGE IMPROVEMENTS

### STILWELL, OKLAHOMA REVISED APRIL 2023

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AERIAL LOCATION MAP

GWY Sum & Association

AND SURVEYORS & ENGINEERS

SOUTT & ASSOCIATES, DK: Lond Surveyors & Engineers A. \$6041 (PLS. PS) Rep. 8/90/71 907-3 Callabus Street Enginges, OK 74405



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18772 Harmon Road
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Email:
carl.d.gales@gmail.con

PROJECT:

Dogwood II Addition

IENT:

Housing Authority of the Cherokee Natio

Address:

North 5th Street Stilwell, OK.

SHEET:

Cover Sheet

APPROVED BY: CDG DATE PREPARED: Oct. 2015

DRAWN BY:

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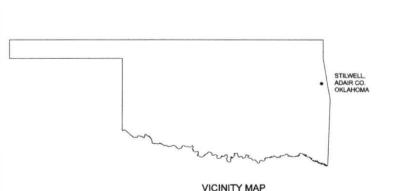
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A-1

22"x34" PRINT ONLY



SCALE N.T.S

Location of.


Adair County, OK

LATITUDE: 35"49'28.82"N LONGITUDE: 94°37'54.21"W

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EFORE YOU DIG... CALL OKIE -800-522-6543 OR TO PERFORMANG ANY GRADING OR EXCAVATING WORK.
CONTRACTOR SHALL NOTIFY ALL UPLITY OWNERS AND
LL DINE (DALAHOMA ONE-CALL)" NOT LESS THAN +8
JRS. IN ADVANCE AND SHALL VERIEY OR ESTABLISH THE
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Address:

North 5th Street, Stilwell, OK.

SHEET:

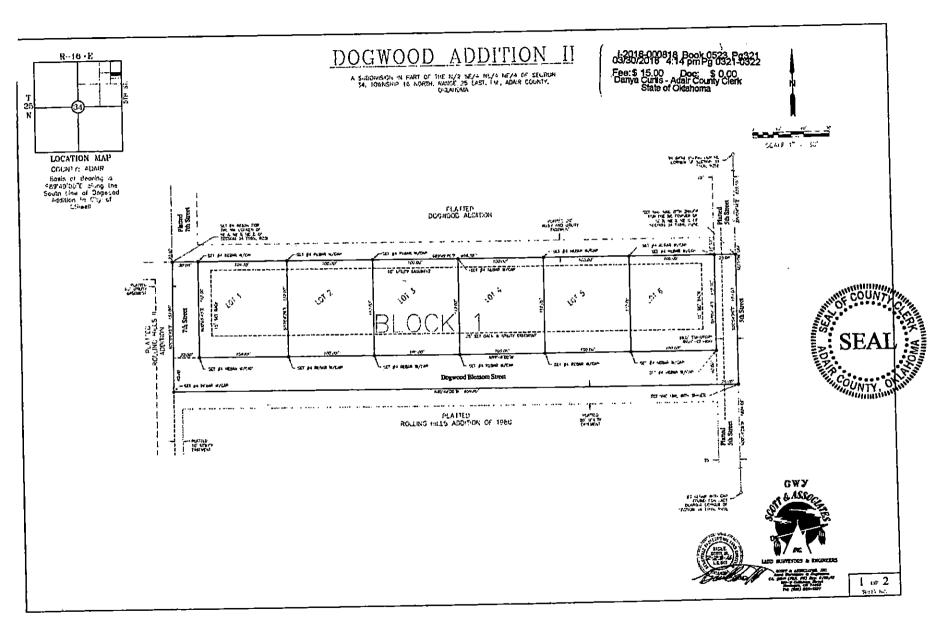Filled Plat File Number 2016-000818, Book 0523, Page 321

APPROVED BY:
CDG
DATE FREFARED:
Oct. 2019
DESIGNED BY:

DRAWN BY:

REVISION FOR DAY OF STELLARLE.





A-2 SHEET NO.

### DOGWOOD ADDITION II

A SUBDIVIERAL A PART OF THE N/2 SI/A NE/A NE/A OF SECTION 34, TOWNSHIP 16 NORTH, MANGE 25 DAST, LM. AGAIN COUNTY, OFLANDING

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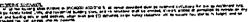
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ENGINEER KAS Gales Company Consulting Engineer: 18772 Harmon Road Fayetteville, AR 72704 Wk. 479.361,9977 Cell 479,422,0763 Email: carl.d.gales@gmail.con

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Dogwood II Addition

CLIENT:

Housing Authority of the Cherokee Nation

Address:

North 5th Street, Stilwell, OK,

SHEET;

Filled Plat Covenants and Restrictions 2016-000818, Book 0523, Page 322

APPROVED BY DATE PREPARED Oct. 2015 ESMINED BY


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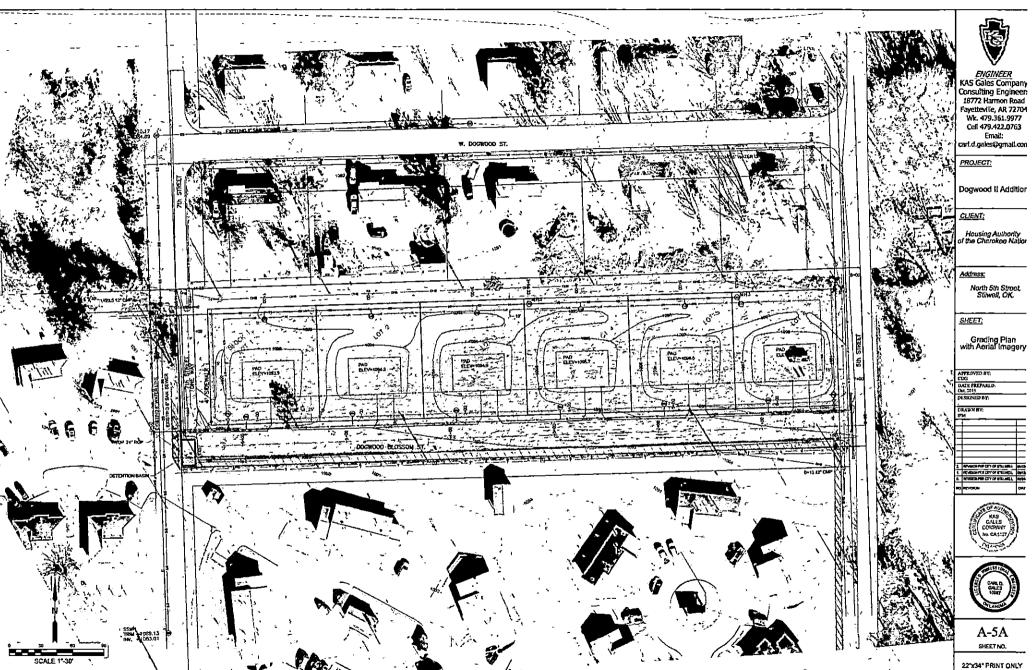
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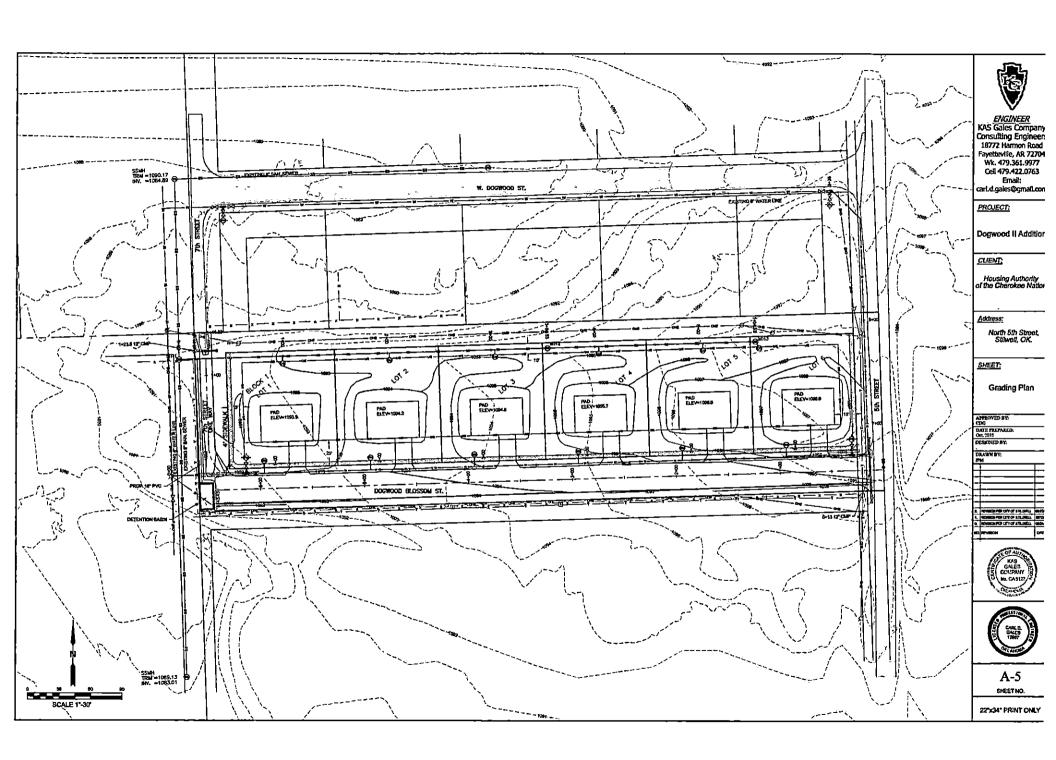





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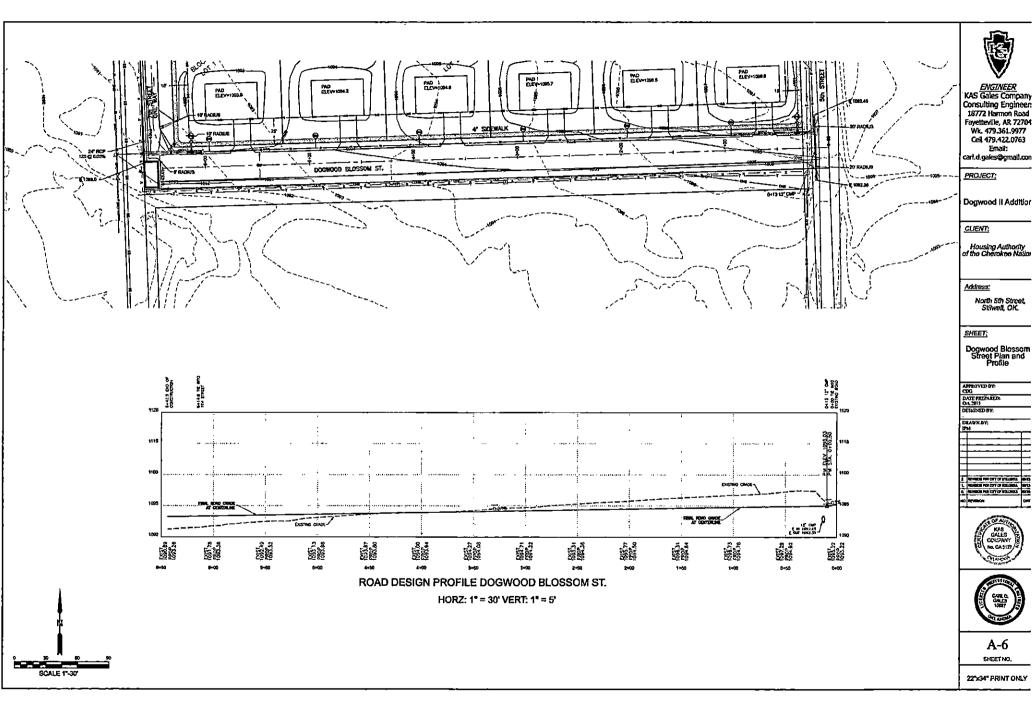






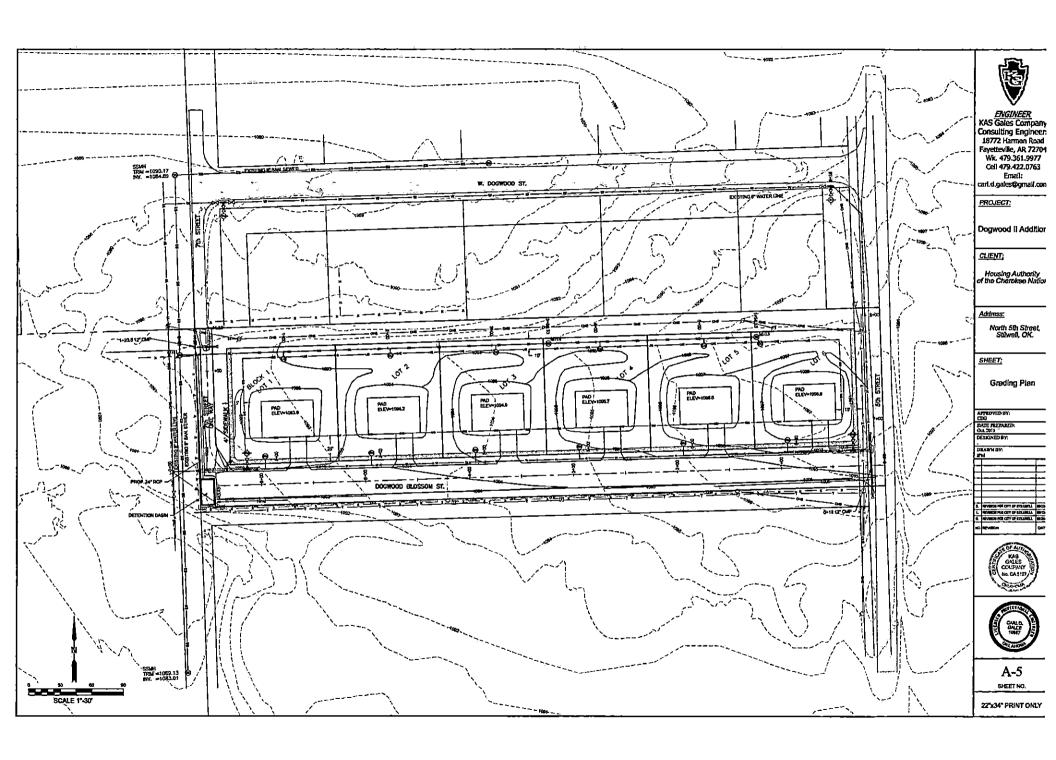

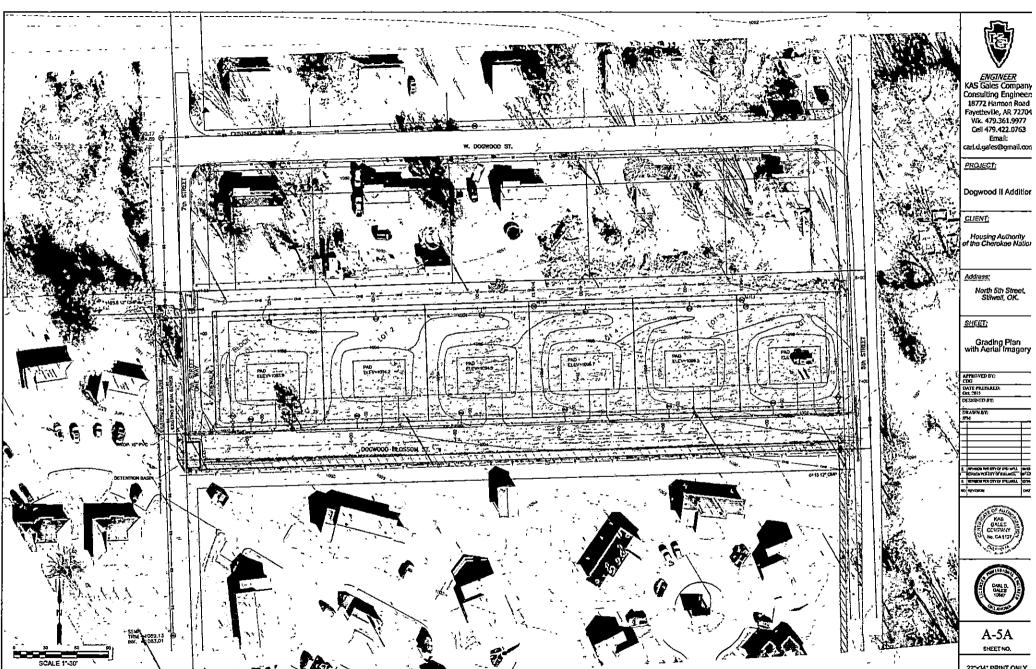





ENGINEER
KAS Gales Company Consulting Engineer: 18772 Harmon Road Fayetteville, AR 72704 Wk. 479.361.9977 Cell 479.422.0763 Email:

Dogwood II Addition

Housing Authority of the Cherokee Nation


North 5th Street, Stilwell, OK.


Dogwood Blossom Street Plan and Profile





A-6

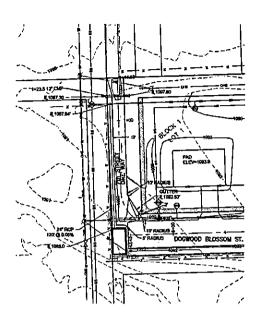

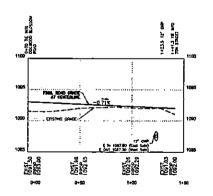

**ROAD DESIGN PROFILE 7TH STREET** HORZ: 1" = 30' VERT: 1" = 5"

BILL OF MATERIALS						
ITEM NO.	DESCRIPTION	GUANTITY	UNIT			
1	UNCLASSIFIED STREET EXCAVATION	850	CY			
2	SELECT BORROW FURNISH AND INSTALL	50	ଫ			
3	SB-2 BASE ROCK FURNISH AND INSTALL	190	CY			
4	6" CONCRETE PAYING	1900	sr			
5	CONCRETE CURB AND GUTTER	1600	UF.			
5	SRT FENCE, EROSION CONTROL FURNISH AND INSTALL	1628	ı.			
7	18" CORRUGATED METAL PIPS OR 18" HOPE PIPE W/ ENDWALLS	40	U			
8	CLEARING AND GRUBBING REMOVING OF EXISTING STRUCTURES	1	ß			
9	MOBILIZATION	1	LS.			
10	CONSTRUCTION STAKING	1	ιs			
11	MATERIAL AND Construction Testing	-	LS			



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PROJECT:

Dogwood II Addition

CLIENT:

Housing Authority of the Cherokee Nation

Address:

North 5th Street, Stilwell, OK.

SHEET;

7th Street (One-way Plan and Profile

APPROVED BY: CDG DATE PREPARED Oct. 2015

DESIGNED BY: DEADN BY:

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8. REVISION FOR CATY OF STRUMENT. 88.06


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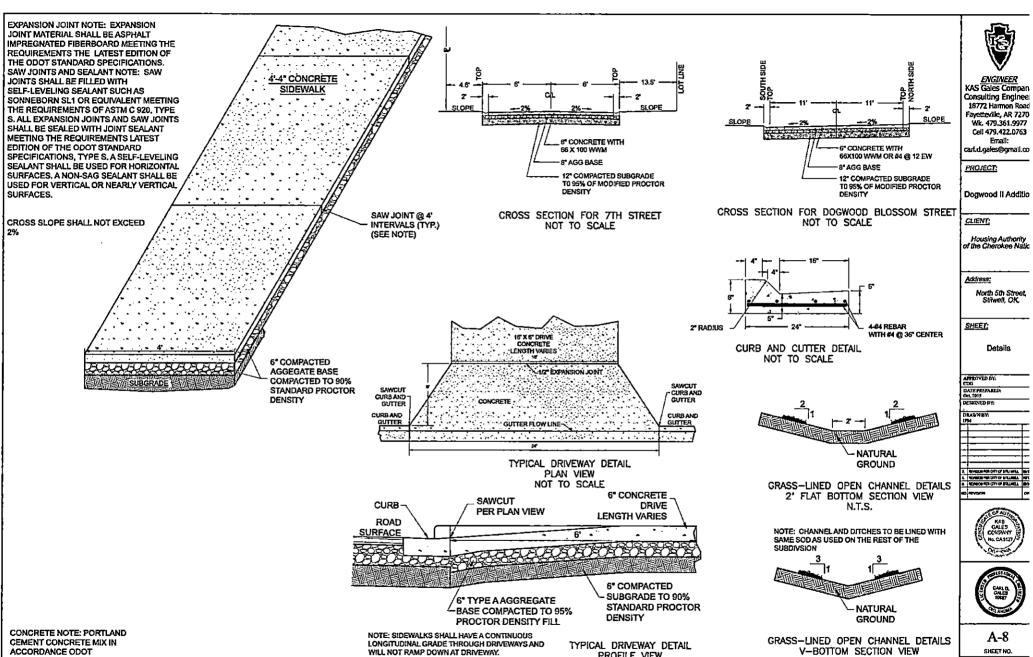
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A-7 SHEET NO.





DRIVEWAY GRADE ACROSS SIDEWALK SHALL NOT

EXCEED 2%.

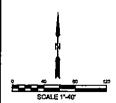STANDARD SPECIFICATIONS.

PROFILE VIEW

NOT TO SCALE

V-BOTTOM SECTION VIEW N.T.S.

SHEET NO.

#### SITE NOTES:

- 1. THE WORK AND MATERIAL SHALL COMPLY WITH ALL CITY/COUNTY/STATE FEDERAL REGULATIONS CODES AND OSHA STANDARDS.
- 2. CONTRACTOR SHALL COORDINATE PLANS AND REFER TO STRUCTURAL & BUILDING PLANS AS NEEDED.
- 3. ALL WORK SHALL BE DONE IN STRICT ACCORDANCE WITH THE PROJECT SPECIFICATIONS.
- ALL.CURB/SIDEWALK/VAN HANDICAP CONSTRUCTION SHALL CONFORM TO FEDERAL ADA STANDARDS OR LOCAL CODES, WHICHEVER IS NORE RESTRICTIVE.
- 5. CONTRACTOR SHALL ENSURE ALL NECESSARY PERMITS ARE OBTAINED PRIOR TO CONSTRUCTION START.
- 6. CONTRACTOR SHALL MATCH THE PROPOSED DRIVEWAYS TO THE EXISTING ASPHALT ROADWAY PAVEMENT.

#### GENERAL NOTES:

- ALL GRADING, PAVING AND STORM SEMER CONSTRUCTION SHALL BE IN ACCORDANCE WITH THE ORLAHOMA DEPARTMENT OF TRANSPORTATION 2005 STANDARD SPECIFICATIONS & STANDARDS. ALL CONSTRUCTION TESTION SHALL BE IN ACCORDANCE WITH DIALARDAN DEPARTMENT OF TRANSPORTATION (OLD.O.T.) 1999 SPECIAL, PROVISION 643—6046—699 AND FEILATED 1999 SPECIAL PROVISIONS AND MATERIALS TESTING 6—GUIDE. GRADING & COMPACTION & ANY SELECT INVERTIAL FOR THE BUILDING SHALL BE PER THE GEO—TECHNICAL REPORT.
- 2. CONSTRUCTION, MATERIAL & PHYSICAL TESTING AS REQUIRED WILL BE THE RESPONSIBILITY OF THE CONTRACTOR.
- 3. CONTRACTOR SHALL GAZ THE NOTIFICATION CENTER OF THE ORLHOMA "ONE-CALL SYSTEM INC. NOTICE OF ANY EXCAVATION NO SOURCE THAN TEN DAYS OR LATER THAN 72 HOURS (EXCLUDING SATURDAYS, SUNDAYS OR LEGAL HOLIDAYS), PRIOR TO COMMENDELENT OF WORK. PHONE 1-600-622-6543.
- 4. THE EOSTENCE AND LOCATION OF ANY UNDERGROUND LITLITY PIPES OR STRUCTURES SHOWN ON THESE DRAWINGS ARE OSTAINED BY A SEARCH OF THE AVAILABLE RECORDS. TO THE BEST OF OUR KNOWLEDGE, THERE ARE NO EDISTRIC LITLITES EXCEPT AS SHOWN ON THESES BRAWINGS AND WE ASSULE AN RESPONSEDIENT AS TO THE ACCUPACY OF THEIR DEPICTION. LOCATION ON THESE DRAWINGS. THE CONTRACTOR IS REQUIRED TO TAKE DUE PRECAUTIONARY MEASURES TO PROTECT THE UTILITY LINES SHOWN, AND ALL OTHER LINES NOT OF RECORD OR NOT SHOWN ON THESE DRAWINGS BY VERIFICATION OF THEIR LOCATION IN THE FIELD PROOR TO THE INITIATION OF THE ACTUAL PORTION OF THEIR WORK.
- 5. ALL CONSTRUCTION STAKING SHALL BE PERFORMED BY LICENSED SURVEYOR. ELECTRONIC DATA WILL BE MADE AVAILABLE TO THE SURVEYOR FOR HIS USE.
- 6. THE CONTRACTOR SHALL COMPLY WITH ALL APPLICABLE FEDERAL, STATE AND LOCAL LAWS GOVERNING SAFETY, HEALTH, AND SAMITATION. THE CONTRACTOR SHALL PROVIDE ALL SAFEGUARDS, SAFETY DEVICES AND PROTECTIVE COMPRHENT, AND TAKE ANY OTHER NEEDED ATTIONS ON HIS OWN RESPONSEDITY OR AS THE PROMPTER MANY DETERMINE RESONANT OF PROTECT PROPERTY IN CONNECTION WITH THE PERFORMANCE OF THE WORK COVERED BY THE CONTRACT. THE CONTRACTOR SHALL COMPLY WITH THE LATEST OSIAN RECOVATIONS.
- 7. CONTRACTOR IS RESPONSIBLE FOR OBTAINING ANY AND ALL PERMITS REQUIRED,
- S. ALL DIMENSIONS SHALL BE COORDINATED WITH ENGINEER. AN ELECTRONIC FORMAT WILL BE AVAILABLE TO SURVEYOR.
- 9. THE CONTRACTOR SHALL CONTACT THE ENGINEER FOR CLARFICATION IF A DISCREPANCY OR INCONSISTENCY IS IDENTIFIED ON THE PLANS AND/OR SPECIFICATIONS IMMEDIATELY.
- 10. DRAWINGS AT ALL TIMES. THE CONTRACTOR SHALL MARK (IN RED) ALL APPROVED CHANGES INCURRED FOLLOWING APPROVAL OF THE DISTRAL DRAWINGS. THISE CHANGES MAY BE INTIMED FROM FILLD CONDITIONS OR CHANGES MADE BY THE DESIGN DEPOCRET. EXCEPT FOR LINIOR FIELD ADJUSTMENTS, ALL CHANGES SHALL BE REVIEWED AND ADRICED TO BY THE DESIGN DEPOCRET PROOF FINAL APPROVAL OF THE PROJECT. THE CONTRACTOR SHALL SUBBIT THE WORKING DRAWINGS TO THE DESIGN DEPOCRET AFTER FINAL INSPECTION OF THE PROJECT TO STAVE AS A BASIS FOR DEVELOPMENT OF THE FINAL ASSESSING RECOORD DRAWINGS.

#### GRADING NOTES:

- ALL GRADING AND EROSION CONTROL SHALL BE CONSTRUCTED IN ACCORDANCE WITH THE EROSION CONTROL PLANS AND O.D.O.T. SPECIFICATIONS AND STANDARDS.
- 2. THE CONTRACTOR SHALL VERIFY UTILITY LOCATIONS BEFORE EXCAVATING.
- 3. ALL EXISTING USAGLE TOPSOIL(AS APPROVED BY THE CONTRACTORS TESTING LAB) SHALL BE STRIPPED AND STOCKPILED IN AN AREA APPROVED BY THE OWNER AND RESPIRED AS DIRECTED BY OWNER AFTER GRADING IS COMPLETED.
- . Stripping, proof rolling, subgrade scarpfoation and compaction, and fell construction for the site, paying areas and europag shall be performed according to the oddt's 2009 specifications.
- Contractor shall promoe water as required to obtain specified compaction requirements and shall contact the city of stuyell for any meter permits.
- 8. Subgrade stabilization shall be per plans or as directed by the contractor's testing firm,
- . ENCOREER WILL NOT INTERPRET SOILS REPORTS OR ACCEPT RESPONSIBILITY FOR ALTERNATIVE METHODS PROPOSED BY THE CONTRACTOR.
- GEO-TECHNICAL CONSTRUCTION & MATERIAL TESTING WILL BE PROVIDED BY THE CONTRACTOR, ANY FALLING TEST SHALL BE RE-TESTED AT THE CONTRACTOR'S EXPENSE UNTIL PASSING TESTS ARE OBTAINED.
- 9. Undercutting of soft spots and placement of Earthwork is governed by the Geo-technical report for the site.
- Corrective measures directed by the engineer may include complete removal, and replacement at no cost to the owner in cases of poor workmanship or unsatisfactory in-place conditions.
- 11. SITE CRADING SHALL NOT PROCEED UNTIL APPROPRIATE EROSION AND SEDIMENT CONTROL MEASURES HAVE BEEN INSTALLED.
- 12. ALL UNSURFACED AREAS DISTURBED BY GRADING OR FILLING OPERATIONS SHALL RECEIVE 4°OF TOPSOIL TO FINAL GRADE. THE TOPSOIL SHALL BE WATER FLOODED, DRIED AND PROOF-ROLLED PRIOR TO PLACEMENT OF SOUD SURE SOO.
- 13. THE CONTRACTOR SHALL ASSURE POSITIVE DRAINAGE AWAY FROM PROPOSED HOMES.



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PROJECT:

Dogwood II Addition

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Housing Authority of the Cherokee Nation

Address:

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SHEET;

Notes


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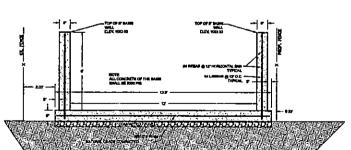




A-9



BILL OF MATERIALS							
ITEM NO.	DESCRIPTION	QUANTITY	UNIT				
1	UNCLASSIFIED EXCAVATION	35	3				
2	FURNISH AND INSTALL CONCRETE BASIN	22	CY				
3	FURNISH AND INSTALL CRAVEL	12	cr				
4	FURNISH AND INSTALL FENCE (SIZE TO BE GETERMINED BY EXISTING FENCE)	37	ιF				
5	24" RCP PIPE	120	lF				
6	CLEARING AND GRUBBING REMOVING OF EXISTING STRUCTURES	!	ĽS				
7	MOBILIZATION	1	LS				
8	CONSTRUCTION STAKING	i	LS				
9	HATERIAL AND CONSTRUCTION TESTING	1	LS				

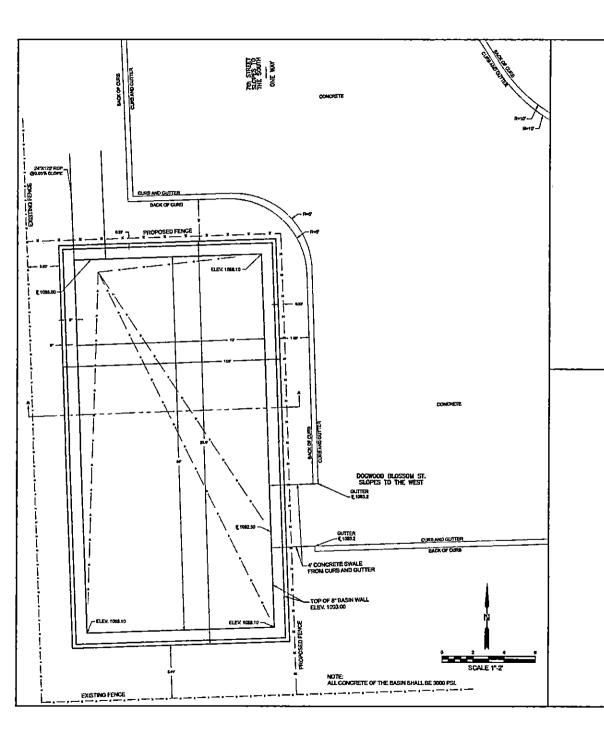

DETENTION BASIN SECTION VIEW SCALE 1"=2'



ENGINEER KAS Gales Company Consulting Engineer 18772 Harmon Road Fayetteville, AR 72704 Wk. 479.361.9977 Cell 479.422.0763 Email: carl.d.gales@gmail.con

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SHEET:

Drainage Base Plar and Section View


APPROVED BY: CDG DATE PREPARED: Apr. 2023 DESIGNED BY:


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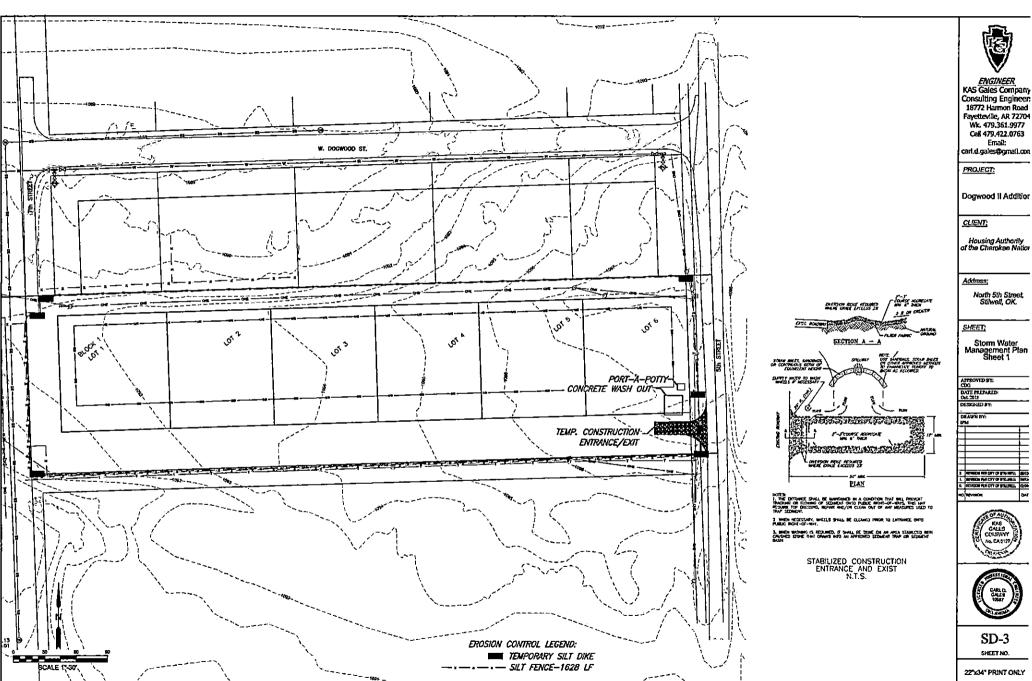
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B. SEMBON PER COTY OF STRUMELL SECS.
SECOND SECS.



SD-1 SHEET NO.



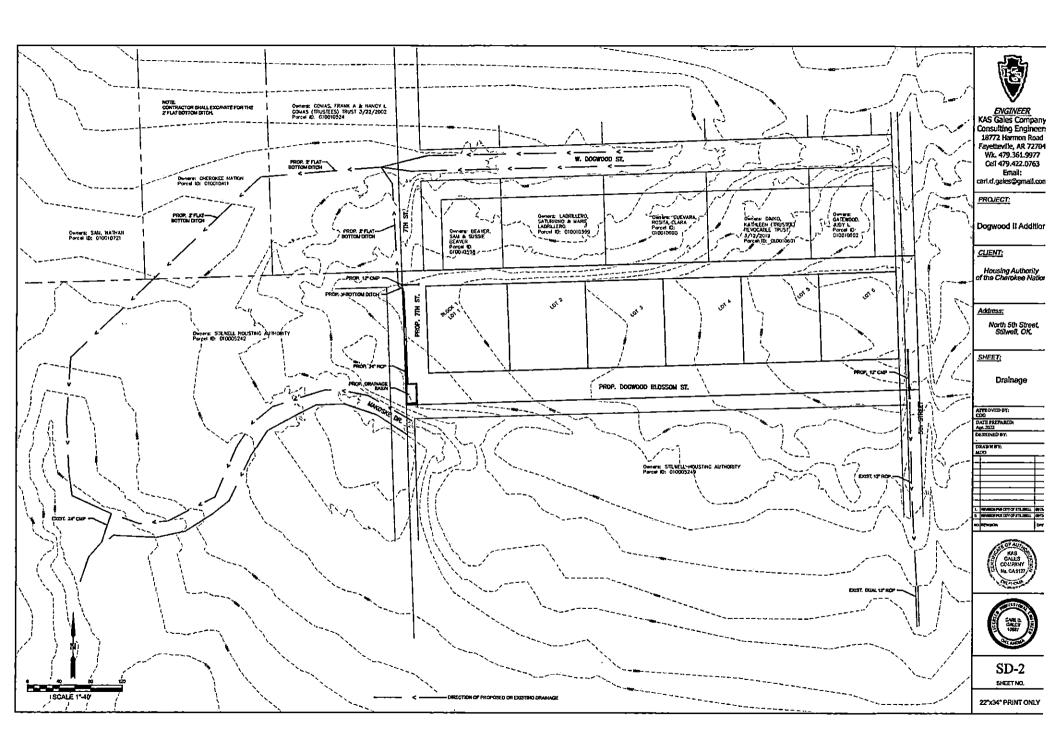

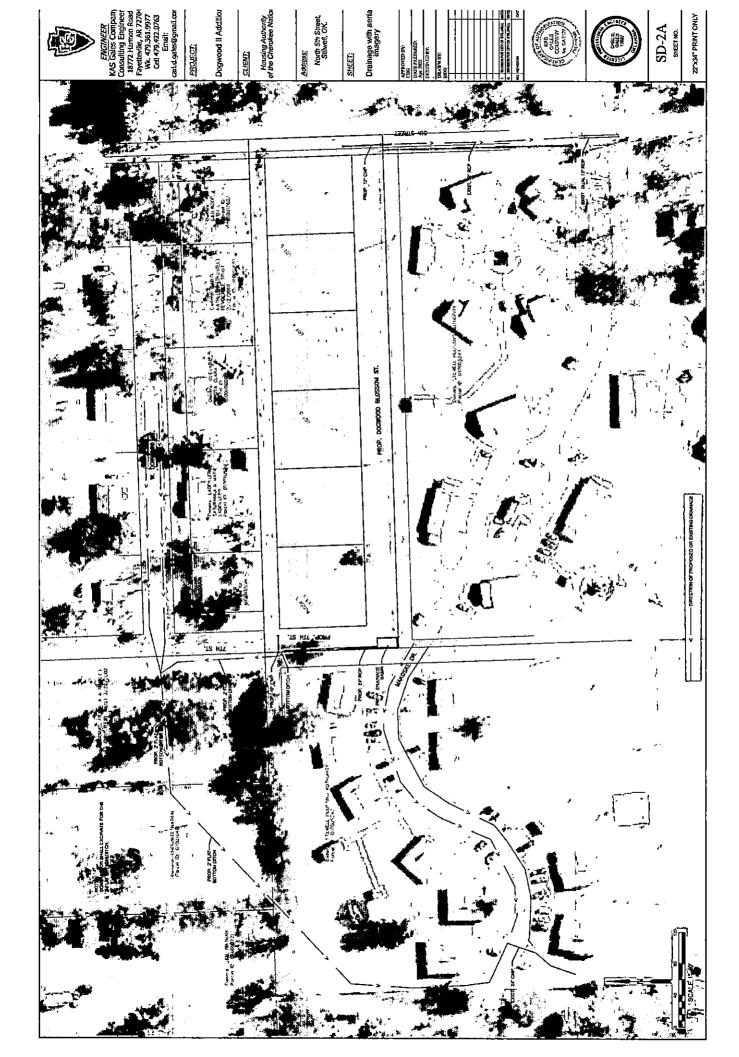



ENGINEER
KAS Gales Company
Consulting Engineer:
18772 Harmon Road
Fayetteville, AR 72704 Wk. 479.361.9977 Cell 479.422.0763 Email:

Dogwood II Addition

Housing Authority of the Cherokee Nation

North 5th Street, Stilwell, OK.

Storm Water Management Plan Sheet 1



SD-3

### STORM WATER MANAGEMENT PLAN

SITE DESCRIPTION	EROSION AND SEDIMENT CONTROLS			
PROJECT LIMITS:  A 2 3 ACRE SITE IN THE SELA NEVA NEVA OF SECTION 31, TOWNSHIP 16 NORTH, RANGE 25 FAST LOCATED IN STRUBELL, ADMIT COUNTY.  LATITUDE AND LONGSTUDE:  LATITUDE: JS/19'28.82'N LONGSTUDE: 94/37'54.21'W  PROJECT DESCRIPTION: THE PROJECT IS 6 TRACTS ON A NEW SUIT-DANSON, DOCUMEN ADDITION NO.2" A SURDINGSON IN STRUBELL, ORLANDIA MITH CONSTRUCTION OF STREETS, SANITARY SEWER AND WAITED BE.  SUGGESTED SEQUENCE OF EROSION CONTROL ACTIVITIES:  1. INSTALL TRAFFIC CONTROL	SOIL STABILIZATION PRACTICES:  TEMPORARY SEEDING PERMANENT SODDING, SPREGING OR SEEDING VEGETATIVE MULCHING SOIL RETENTION BLANKET PRESERVATION OF EXISTING VECETATION NOTE: TEMPORARY EROSION CONTROL METHODS MUST BE USED ON ALL DISTURBED AREAS WHERE CONST. ACTIVITIES HAVE CEASED FOR OVER 21 DAYS. METHODS USED WILL BE AS SHOWN ON PLANS OR AS DIRECTED BY THE ENGINEER.  STRUCTURAL PRACTICES: TEMPORARY SRUSH SEDIMENT BARRIERS TEMPORARY SILT FENCE	THE CONTRACTOR SHALL ALSO BE RESPONSIBLE FOR THE FOLLOWING:  MAINTENANCE AND INSPECTION: ALL EROSION AND SEDIMENT CONTROLS WILL BE MAINTAINED IN GOOD WORKING ORDER FROM THE BEGINNING OF CONSTRUCTION UNTIL AN ACCEPTABLE VEGETATIVE COVER IS ESTABLISHED. INSPECTION BY THE CONTRACTOR AND ANY NECESSARY REPAIRS SHALL BE PERFORMED ONCE EVERY 7 CALENDAR DAYS AND WITHIN 24 HOURS AFTER ANY STORM EVENT GREATER THAN Q.S. INCHES (AS RECORDED BY A NON-PREEDING RAIN GAUGE TO BE LOCATED ON STIE). POTENTIALLY ERODIBLE AREAS, DRAINAGEWAYS, MATERIAL STORAGE, STRUCTURAL DEVICES, CONSTRUCTION ENTRANCES AND EXITS ALONG WITH EROSION AND SEDIMENT CONTROL LOCATIONS ARE EXAMPLES OF SITES THAT NEED TO BE INSPECTED.  WASTE MATERIALS: PROPER MANAGEWENT AND DISPOSAL OF CONSTRUCTION WASTE MATERIAL IS REQUIRED BY THE CONTRACTOR. MATERIALS INCLUDE STOCKPILES, SURPLUS, DEBRIS AND ALL OTHER BY-PRODUCTS FROM THE CONSTRUCTION PROCESS. PRACTICES INCLUDE DISPOSAL, PROPER MATERIALS HANDLING, SPILL PREVENTION AND CLEANUP MEASURES. CONTROLS AND PRACTICES SHALL MEET THE REQUIREMENTS OF ALL FEDERAL, STATE AND LOCAL AGENCIES.  HAZARDOUS MATERIALS: PROPER MANAGEWENT AND DISPOSAL OF HAZARDOUS WASTE MATERIALS IS REQUIRED. THE CONTRACTOR IS RESPONSIBLE FOR		
2. CLEAR, GRUB AND STOCKPRE TOPSOR  3. BEGIN FENCING, INSTALLATION OF STRUCTURES AND GRACING  4. INSTALL SECURITY CONTROLS AS AREAS BECOME DISTURBED  5. COMPLETE STREET GRACING  6. INSTALL VICETATIVE MULCHING  7. CONSTRUCT BASE AND PRIVING  8. COMPLETE FINE GRADING AND PRIVING  8. COMPLETE FINE GRADING AND RISTALL PERMANENT ENDSIGH CONTROL  NOTE: THIS SHOULD INCLUDE MAJOR ACTIVATIES REQUIRED TO  CONSTRUCT THE PROJECT & EROSION CONTROL ITEMS.  TOTAL AREA TO BE DISTURBED; 100.254 Sq. Feet, 2,302 Acres	* TEMPORARY SILT DIVES  ** TEMPORARY SILT DIVES  ** TEMPORARY SILT DIVES  ** TEMPORARY SILT DIVES  DIVERSION, INTERCEPTOR OR PERIMETER DIVES  SANDBAG BERNS  ROCK FILTER DAMS (CHECK DAM)  TEMPORARY SLOPE DIVAN  PAVED DITCH W/ DITCH LINER PROTECTION  TEMPORARY DIVERSION CHANNELS  RIP RAP  TEMPORARY STREAM CROSSINGS  TEMPORARY SEDIMENT BASINS  ** TEMPORARY SEDIMENT FILTERS  ** TEMPORARY SEDIMENT FILTERS  ** TEMPORARY SEDIMENT FILTERS  ** TEMPORARY SEDIMENT FILTERS  ** TEMPORARY SEDIMENT FREMOVAL  INLET SEDIMENT FILTER  ** STABILIZED CONSTRUCTION ENTRANCE	FOLLOWING MANUFACTURER'S RECOMMENDATIONS, STATE AND FEDERAL REQUIATIONS TO ENSURE CORRECT HANDLING, DISPOSA SPILL PREVENTION AND CLEANUP MEASURES. EXAMPLES INCLIDE BUT ARE NOT LIMITED TO: PAINTS, ACIDS, CLEANING SOLVENTS, CHEMICAL ADDITIVES, CONCRETE CURING COMPOUNDS AND CONTAMINATED SOILS.  GENERAL NOTES:  THE ENCLOSED STORMWATER MANAGEMENT PLAN (SWAP) COMPLIES WITH OPDES REGULATIONS UNDER THE CITY OF STILMELL OKROAL STORMWATER PERMIT FOR CONSTRUCTION ACTIVITIES ON LAND OWNED BY THE CHEROKEE NATION.		
WEIGHTED RUNOFF COEFFICIENT:  DEFORE CONSTRUCTION:  0.45  AFTER CONSTRUCTION:  0.45  NOTE: THIS SHOULD BE DETERMINED BY THE HYDRAULIC DESIGNER FOR THE PROJECT, THIS VALUE SHOULD BE THE AVERAGE "C" FACTOR USED ON THE PROJECT. IT SHOULD BE BASED ON THE ANTICIPATED FUTURE LAND USE.	OFFSITE VEHICLE TRACKING:  — HAUL ROADS DAMPENED FOR DUST CONTROL  _ LOADED HAUL TRUCKS TO BE COVERED WITH TARPAULIN  _ EXCESS DIRT IN LOT REMOVED DAILY			
NAME OF RECEIVING WATERS: CAMEY CREEK  NOTE: THIS SHEET SHOULD BE USED IN COMMUNICATION WITH A DRAWAGE MAP THAT ILLUSTRATES THE BRAININGE CHARACTERISTICS AND RECEIVING WAIERS FOR THIS PROJECT. THIS SHEET SHOULD ALSO BE USED WITH THE EROSION CONTROL SUMMARIES, PAY ITEMS, & NOTES.	NOTES: CONTENTIOR SHALL REMOVE ALL ITEMPORARY SEGMENTATION CONTROL DEVICES FROM PROJECT LIMITS ATTER CONSTRUCTION IS COMPLETED. CONTRACTOR IS RESPONSIBLE TO MAINTAIN ALL EROSION CONTROL DEVICES.			



ENGINEER
KAS Gales Company
Consulting Engineer:
18772 Harmon Road
Fayetteville, AR 72704
Wit. 479.361.9977
Cell 479.422.0763
Email:
carl.d.gales@gmail.con

PROJECT:

Dogwood II Additior

CLIENT;

Housing Authority of the Cherokee Nation

Address:

North 5th Street, Stilwell, OK,

SHEET:

Storm Water Management Plan Sheet 2

APPEOVED BY: CDG DATE PREPARED: Oct. 2015 DESIGNED BY:

DRAWN BY:

STREET FOR CITY OF FILLING.

OF ALTER


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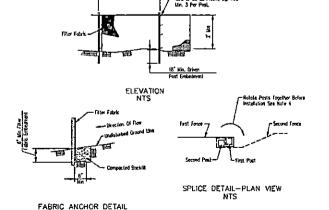
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SD-4 sheet no.

### CLEARING AND GRUBBING CONSTRUCTION SEQUENCE I. PLACE PERIMETER CONTROLS ILE, SILT FENCES . DIVERSION DITCHES, SEDIMENT BASINS. FIC.) 2. PERFORM CLEARING AND GRUDGING OFERATION. **EXCAVATION** EXISTING CROWN > EXISTING GROUND -PHASE 1 EXCAVATION PHASE 2 EXCAVATION FINAL PHASE EXCAVATION ALL CUT SLOPES SMALL BE DRESSED, PREPARED, SEEDED, AND MULCHED AS THE WORK PROCRESSES, SLOPES SMALL BE EXCAVATED AND STABILIZED IN EDUAL INCREMENTS NOT TO EXCEED 25 FEET, MEASURED VERTICALLY. CONSTRUCTION SEQUENCE 1. EXCAYATE AND STABILIZE INTERCEPTOR AND/OR DIVERSION DITCHES, 2. PERFORM PHASE I EXCAVATION. PLACE PERMANENT OR TEMPORARY SEEDING. 3. PERFORM PHASE 2 EXCAVATION, PLACE PERMANENT OR TEMPORARY SEEDING. 4. PERFORM FINAL PHASE OF EXCAVATION, PLACE PERMANENT OR TEMPORARY SEEDING, STABLIZE DITCES, CONSTRUCT DITCH CHECKS, DIVERSION DITCHES, SEDIMENT BASHES, OR OTHER EMPOSION CONTROL DEVICES AS REQUIRED.






NTS

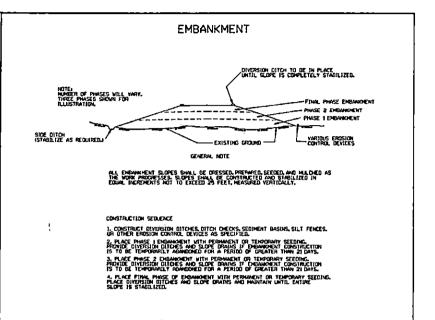NOTE:

I Improvey sill times shall be included prior to any grading work in the cross to be problected. Fance shall be modished throughout the construction protein and removed in or construction and be first gradied and site subdifficultion.

Filter fative double of the 2, Coass I with equivalent opening size of all south 30 for monarcements of motivate specification 592 Cookertile fabric for 2, Coass I with equivalent opening size of all south 30 for monarcement of 50 for several coase more size of 50 for several coase of 50 fo

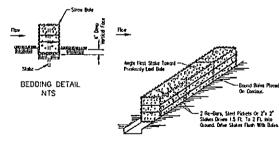

ANCHORING DETAIL NTS

- NOTES:

  1. Boles shall be placed at the lot of slape or as the contour and is a row with ends lightly abutting the adjacent bales.
- Each bale shall be embedded in the soil a minimum of 13", and placed no that bindings are hartcontal.
- 1 Butes that he securely creticated in place by either two states or ne-bors driven brough the bole. The first state is each bole shall be direct laward the previously laid bale at an angle to torce the bales together. Stakes shall be driven thush with the bale.
- Inspection shall be irrequired and repair replacement shall be made promptly as needed.
- 5 Boles shall be removed when they have served their usefulness to as not to block or impede storm flow or drainage,



KAS Gales Company Consulting Engineer: 18772 Harmon Road Fayetteville, AR 72704 Wk. 479.361.9977 Cell 479.422.0763 Email: carl.d.gales@gmail.con

PROJECT:

Dogwood II Addition

CLIENT;

Housing Authority of the Cherokee Nation

Address:

North 5th Street, Stilwell, OK.

SHEET;

Typical Erosion Control Devices

APPROVED BY: DATE PREPARED: Oct. 2015 DESIGNED AV


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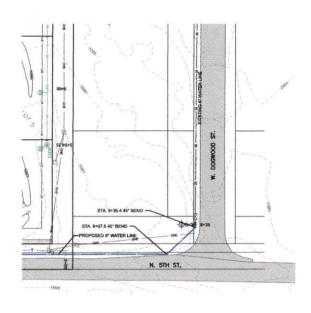



SD-5 SHEET NO,

22"x34" PRINT ONLY

SILT FENCE AND TEMP. SILT DIKE INSTALLATION



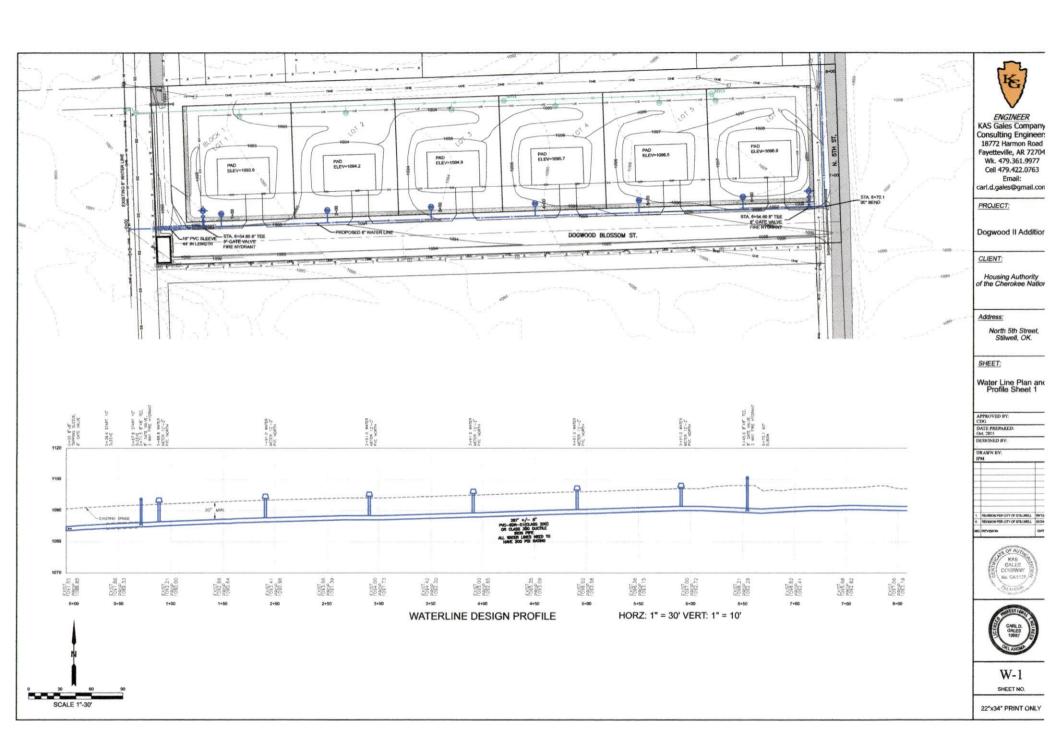

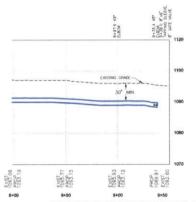

WATERLINE DESIGN PROFILE HORZ: 1" = 30' VERT: 1" = 10'





ENGINEER KAS Gales Company Consulting Engineer: 18772 Harmon Road Fayetteville, AR 72704 Wk. 479.361.9977 Cell 479.422.0763 Email: carl.d.gales@gmail.con

PROJECT:

Dogwood II Addition

CLIENT:

Housing Authority of the Cherokee Nation

Address:

North 5th Street, Stilwell, OK.

SHEET:

Water Line Plan and Profile Sheet 2

APPROVED BY: CDG DATE PREPARED: Oct. 2015 DESIGNED BY:


DRAWN BY:

2.	REVISION PER CITY OF STRUMELL	0
1.	REVENON PER CITY OF STRUMELL	Or.
0.	REVISION PER CITY OF STRUMELL,	60
NO.	REVISION	1






W-2 SHEET NO.

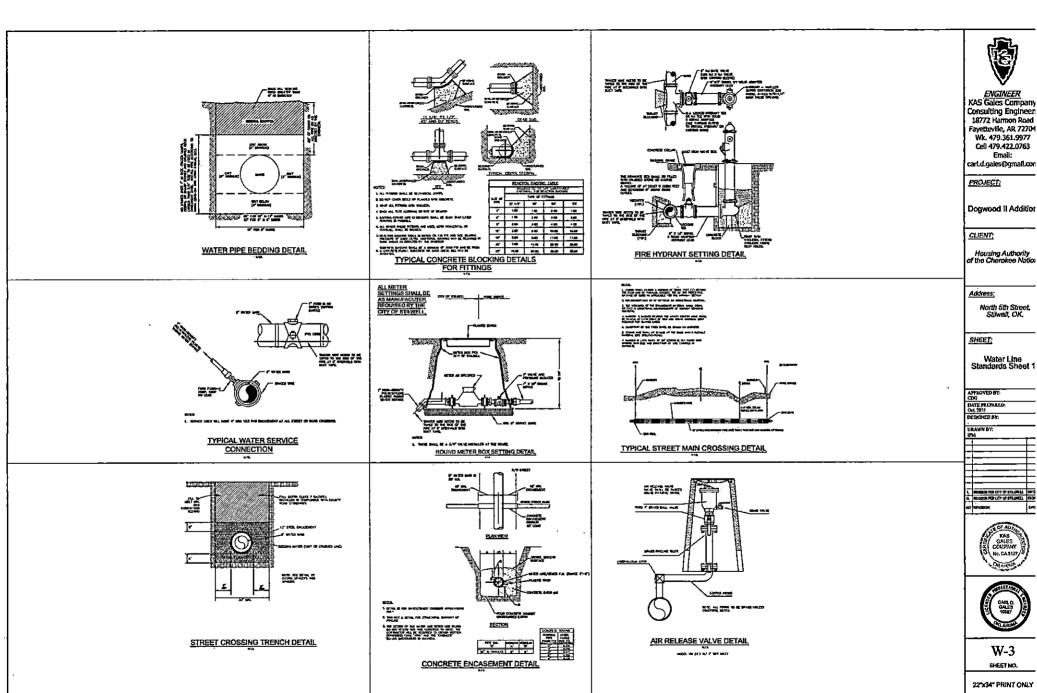

18772 Harmon Road Fayetteville, AR 72704





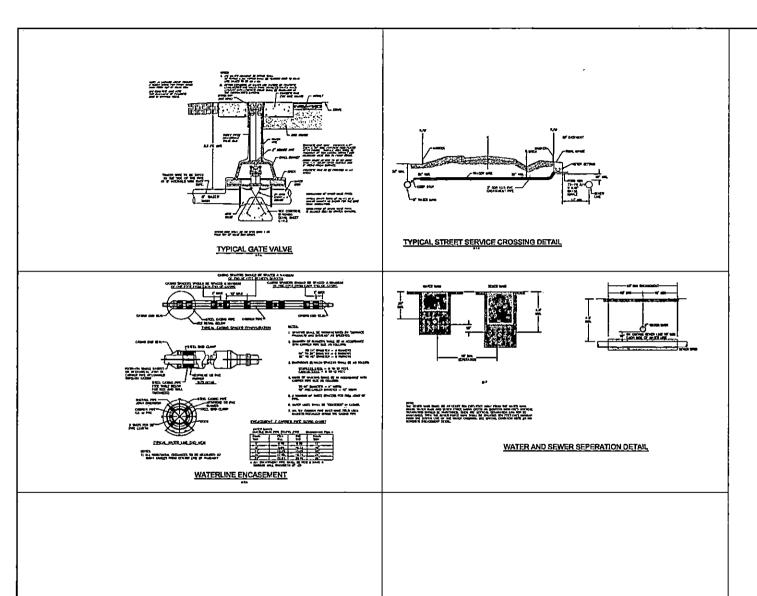

	BILL OF MATE	RIALS	
CTEM NO.	DESCRIPTION	QUANTITY	UNIT
t	EXCAVATION AND BACKFILL TRENCH	325	er
2	8" ANWAA C900 CLASS 200 PIPE FURNISH AND INSTALL	935	IJ
3	10" PVC CLASS 200 PIPE FURNISH AND INSTALL	44	រេ
4	3/8" PEBBLES	115	CY
5	3/4" PVC SERVICE UNES	30	ır
6	8" TEE Furriish and install	3	EA
7	8"x6" TEE TAPPING SLEEVE FURNISH AND INSTALL	1	EA
8	8" GATE VALVE FURTHSH AND INSTALL	3	EA
9	SERVICE METER, METER CANS W/ APPURTUENANCES FURNISH AND INSTALL	e	CA
10	VALVE BOXES Furnish and install	3	EA
ĮΤ	ihree way fire hydrani furnish and install	1	EA
12	REMOVE AND RELOCATE EXISTING FIRE HYDRANT	1	EA
13	FITTINGS	1	LS
14	MORTALINGOM	1	នេ
15	CONSTRUCTION STAKING	-	ıs
16	MATERIAL AND CONSTRUCTION TESTING	1	LS



ENGINEER
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PROJECT:

Dogwood II Addition

CLIENT;

Housing Authority of the Cherokee Nation

Address:

North 5th Street, Stilwell, OK.

SHEET;

Water Line Standards Sheet 2

APPROVED BY:
CDG:
DATE PREPARED:
Oct.2015
DESERVED BY:
DEARN BY:
SPM

MANAGORI PER CITY OF STRAINERS. MICES
MANAGEM PER CITY OF STRAINERS.
MANAGEM PER CITY OF STRAINERS.
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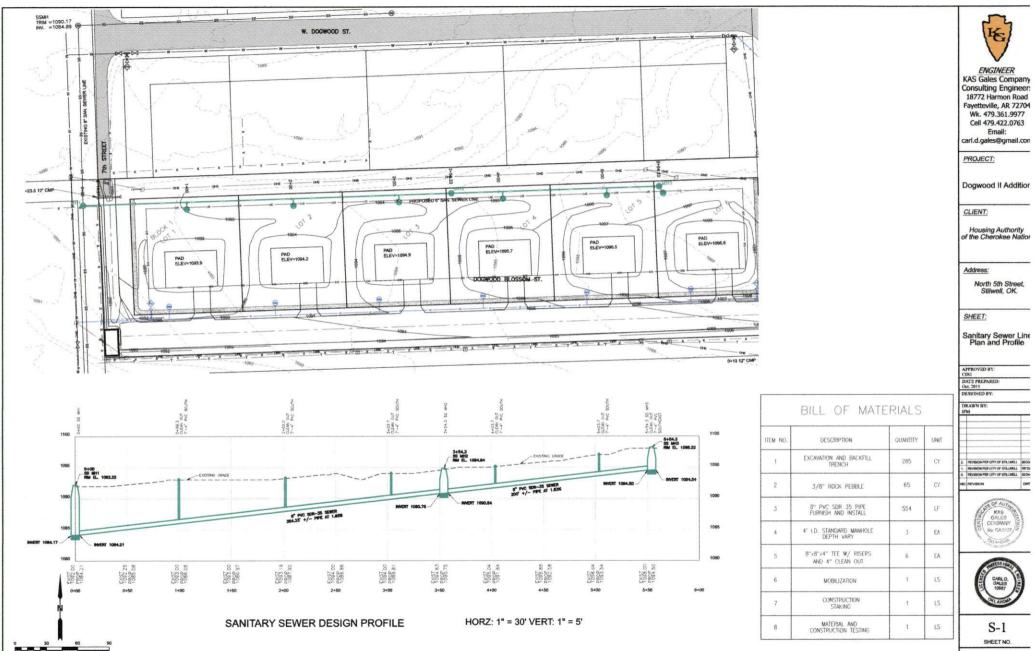
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MAS GALES COLUZANY BL CASETY



W-4 SHEET NO.





SCALE 1"-30"

18772 Harmon Road Fayetteville, AR 72704






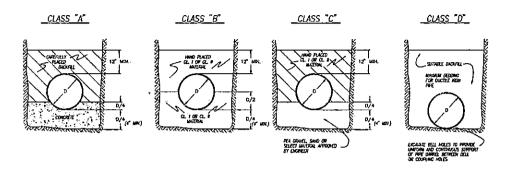


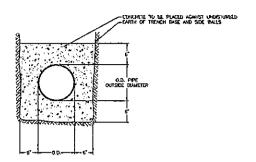



CLASSES OF BEDDING FOR PIPE IN TRENCHES — FOR ALL GRAVITY AND PRESSURE LINES N.T.S.


TYPICAL CONCRETE ENCASEMENT

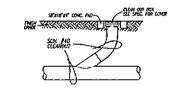

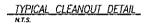

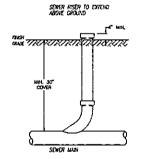

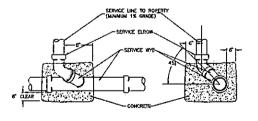

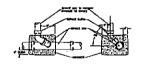

TYPICAL ENCASEMENT FOR VERTICAL SERVICE CONNECTIONS

TYPICAL SEWER RISER DETAIL

TYPICAL ENCASEMENT FOR VERTICAL SERVICE CONNECTIONS



ENGINEER
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PROJECT:

Dogwood II Additior

CLIENT:

Housing Authority of the Cherokee Nation

Address:

North 5th Street, Stilwell, OK.

SHEET

Sanitary Sewe Standards

APPROVED BY: CDG DATE PREPARED: Oct. 2015

DRAWN BY:

2. REPUBLISHENCE OF STELLINEEL 69/25
5. REPUBLISHENCE OF STELLINEEL CONS.
6. REPUBLISHENCE OF STELLINEEL CONS.





S÷2 sheet no.

# DRAINAGE REPORT FOR

DOGWOOD ADDITION NO. 2
City of STILWELL
ADAIR COUNTY, OKLAHOMA
Part of SE ¼ NE ¼ NE ¼ OF
SECTION 34, T16N, R25E

PREPARED BY:

KAS GALES COMPANY
Consulting Engineers
18772 Harmon Road
Fayetteville, Arkansas 72704



June 10, 2023 Revised June 29, 2023

#### I. REPORT CERTIFICATION

I, Carl D. Gales, Registered Professional Engineer, No. 10587 in the State of Oklahoma, hereby certifies that the drainage designs and specifications contained in this Report have been prepared by me, or under my responsible supervision in accordance the regulations of the City of Stilwell, Oklahoma,, the Professional Engineers Registration Act of the State of Oklahoma, and reflect the application of generally accepted standards of Engineering practice. I further certify that the improvements outlined in this Report will not have any adverse effects to life or downstream properties. I understand that review of these plans is limited to general compliance with City Codes and Regulations and does not warrant the Engineer's design or imply any liability to the City of Stillwell for the designs contained herein.

Carl D. Gales, P.E.



# Dogwood Addition No. 2 Drainage Study

#### INTRODUCTION

This study is for the platted subdivision of Dogwood Addition No. 2 located in Stilwell, Oklahoma.

#### SITE DESCRIPTION

The site was original a poorly graded grassed area with a house and metal shop barn type building located on the eastern portion of the property. The property is a total of 2.25 areas that generally slopes from the north to south and then east to west. The original storm water runoff was deposited via surface sheet flow to the existing south property (Rolling Hills Addition of 1980) and to the west side drainage ditch of 5<sup>th</sup> Street.

#### **Project Description**

The proposed project will not encroach on any existing floodplain area and no regulatory floodplain exists on the property. This property will have an increased storm water runoff volume with the development of the proposed six (6) new houses, concrete driveways and Dogwood Blossom Street. In order, to not change the peak storm water runoff volume, it is proposed to construct a detention pond in the southwest corner of the property and channel all storm water thru this pond and to discharge the water via an outlet pipe to the northwest. Plans have been designed and runoff calculations and charts are included in this report.

A Cn value of 74 was used for the existing drainage site runoff calculations
The Cn values for the completed proposed subdivision area used an average of 85.

#### **HYDROLOGY**

The solfware programs used for this project are Hydraflow 2004, Hydraflow Storm Sewers 2008 Using the Rational Metod


TABLE 1						
Existing Conditions	Area	CN	1	Time of Co	ncentration	
	1	2.25	0.74	5		
Proposed Condition	<u></u>	_	1.		•	
		2.25	0.85	5:		


[		Table 2			
Hydaflow [	Data Ratio	nal Design 1	Frequency a	ind CFS	
	Existing Ru	noff			
2 yr   5 yr   10 yr   25 yr   50 yr   100 y					
9.48	10.94	12.05	13.74	15.05	16.37
	Proposed P	lunoff			
10.89	12.56	13.84	15.77	17.29	18.81
	Increased F	Runoff			
1.41	1.62	1.79	2.03	2.24	2.44


31

#### Summary

The existing and proposed runoff calculations were completed and the detention pond was designed to limit post peak rate of surface discharge to be the same or lower that the existing discharge for the 24 hour duration storms for the two, five, ten, and twenty five, fifthy, and 100 year events.

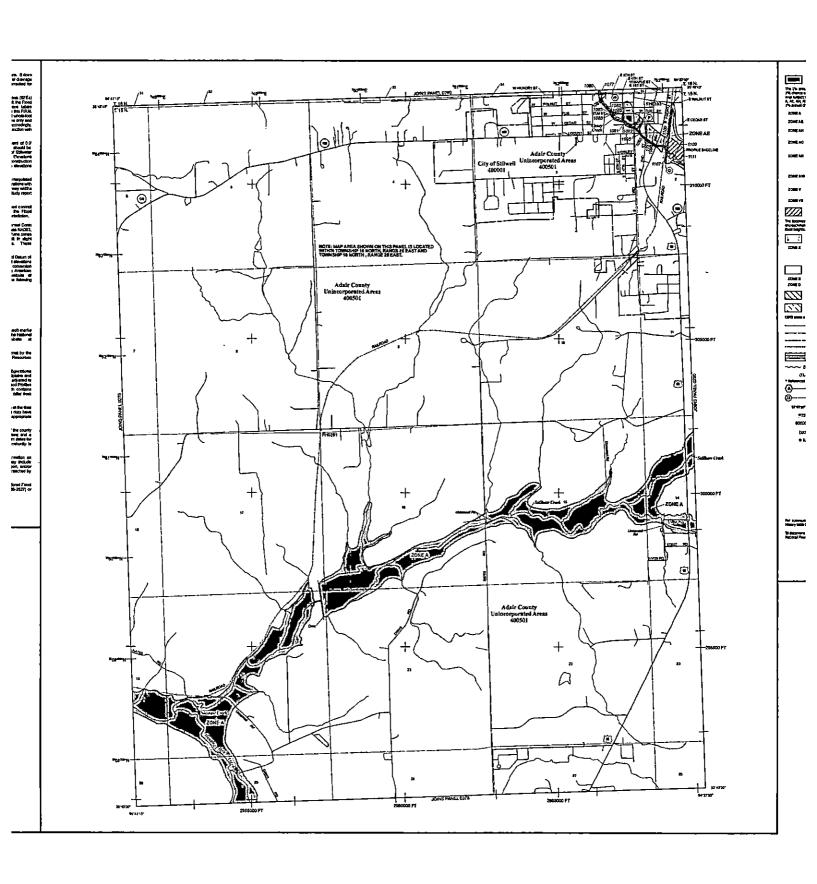

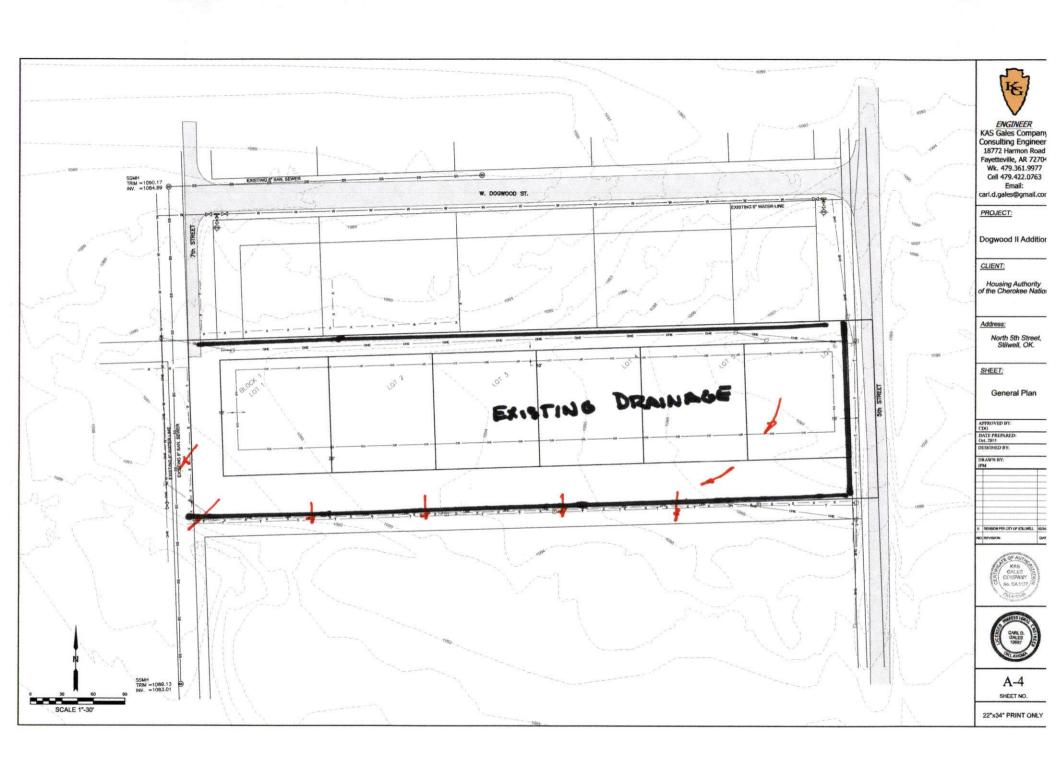

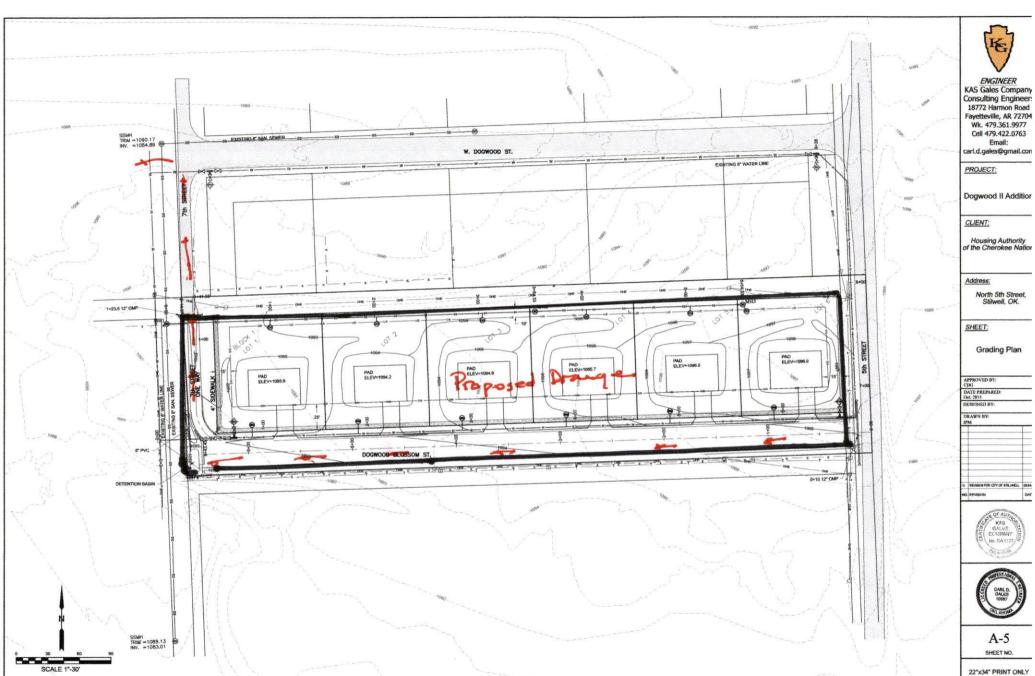

18772 Harmon Road Fayetteville, AR 72704 Wk. 479.361.9977 Cell 479.422.0763



Hydraflow Hydrographs by Intelisolve

Saturday, Jun 10 2023, 2:2 PM


### Hyd. No. 1

Dogwood Stilwell

Hydrograph type = Rational
Storm frequency = 2 yrs
Drainage area = 2.250 ac
Intensity = 5.693 in/hr
IDF Curve = SampleFHA.idf

Peak discharge = 9.48 cfs
Time interval = 1 min
Runoff coeff. = 0.74
Tc by User = 5.00 min
Asc/Rec limb fact = 1/1

Hydrograph Volume = 2,844 cuft

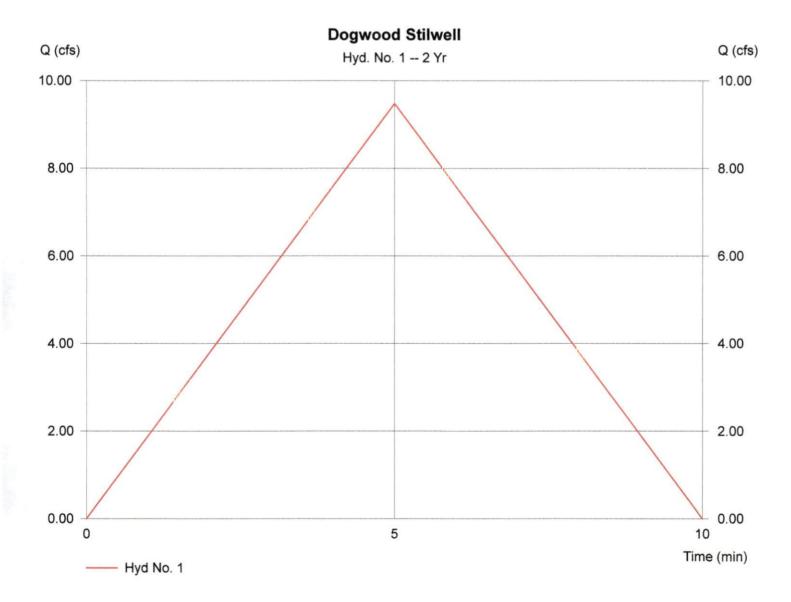

Hydraflow Hydrographs by Intelisolve

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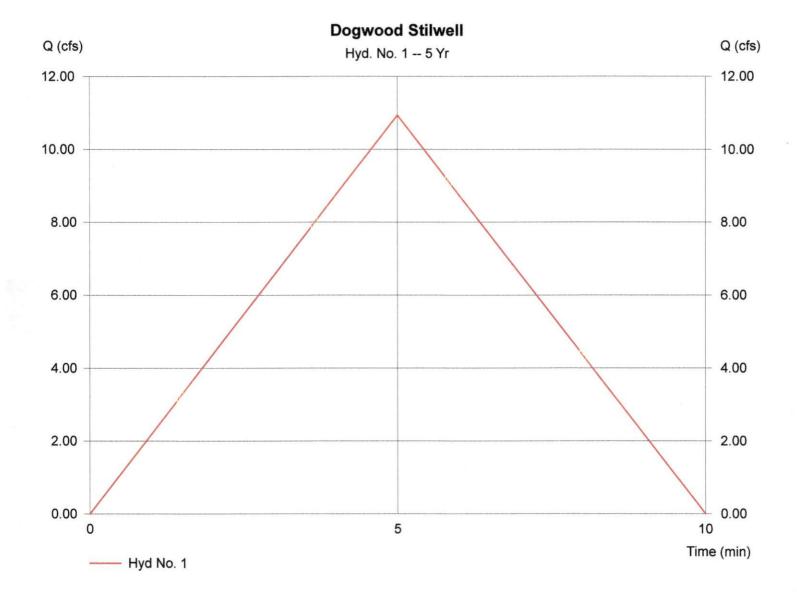
### Hyd. No. 1

Dogwood Stilwell

Hydrograph type = Rational
Storm frequency = 5 yrs
Drainage area = 2.250 ac
Intensity = 6.570 in/hr
IDF Curve = SampleFHA.idf

Peak discharge = 10.94 cfs
Time interval = 1 min
Runoff coeff. = 0.74
Tc by User = 5.00 min
Asc/Rec limb fact = 1/1

Hydrograph Volume = 3,282 cuft



Hydraflow Hydrographs by Intelisolve

Saturday, Jun 10 2023, 2:2 PM


### Hyd. No. 1

Dogwood Stilwell

Hydrograph type = Rational
Storm frequency = 10 yrs
Drainage area = 2.250 ac
Intensity = 7.238 in/hr
IDF Curve = SampleFHA.idf

Peak discharge = 12.05 cfs
Time interval = 1 min
Runoff coeff. = 0.74
Tc by User = 5.00 min
Asc/Rec limb fact = 1/1

Hydrograph Volume = 3,615 cuft

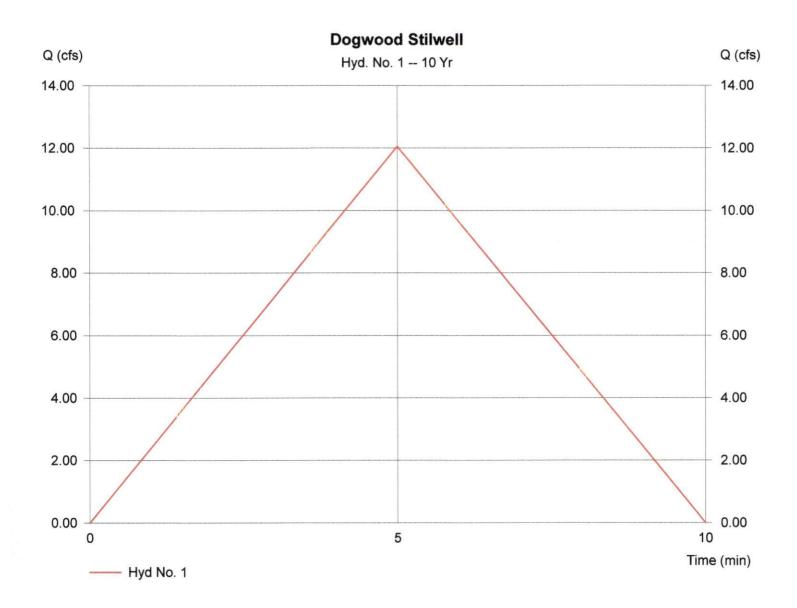

Hydraflow Hydrographs by Intelisolve


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### Hyd. No. 1

Dogwood Stilwell

Hydrograph type = Rational Storm frequency = 25 yrs Drainage area = 2.250 ac Intensity = 8.247 in/hr IDF Curve = SampleFHA.idf Peak discharge = 13.73 cfs
Time interval = 1 min
Runoff coeff. = 0.74
Tc by User = 5.00 min
Asc/Rec limb fact = 1/1

Hydrograph Volume = 4,120 cuft

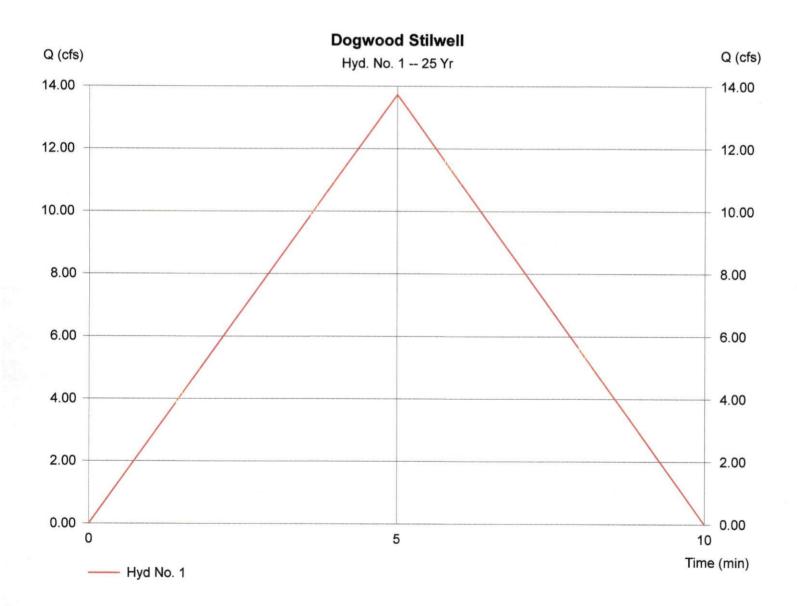

Hydraflow Hydrographs by Intelisolve

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#### Hyd. No. 1


Dogwood Stilwell

Hydrograph type = Rational Storm frequency = 50 yrs Drainage area = 2.250 ac Intensity = 9.041 in/hr

IDF Curve = SampleFHA.idf

Peak discharge = 15.05 cfs
Time interval = 1 min
Runoff coeff. = 0.74
Tc by User = 5.00 min
Asc/Rec limb fact = 1/1

Hydrograph Volume = 4,516 cuft

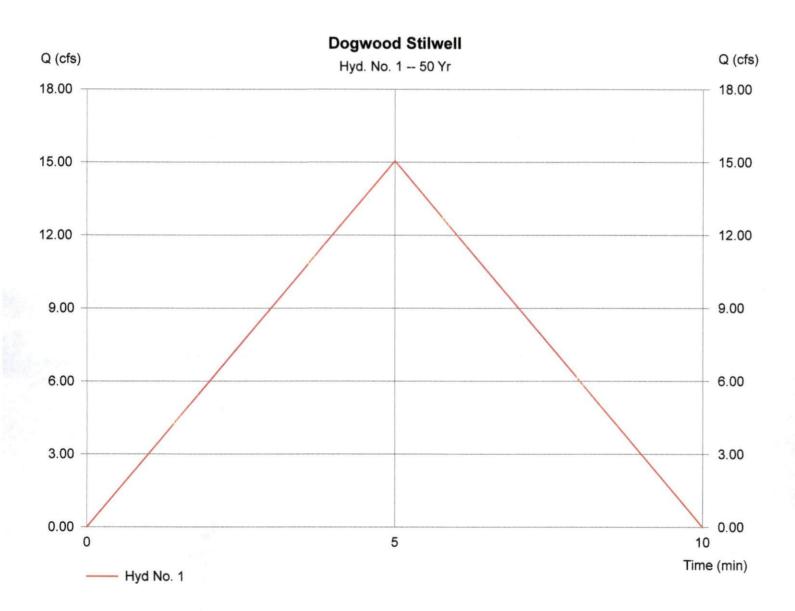

Hydraflow Hydrographs by Intelisolve

Saturday, Jun 10 2023, 2:3 PM


### Hyd. No. 1

Dogwood Stilwell

Hydrograph type = Rational
Storm frequency = 100 yrs
Drainage area = 2.250 ac
Intensity = 9.833 in/hr
IDF Curve = SampleFHA.idf

Peak discharge = 16.37 cfs
Time interval = 1 min
Runoff coeff. = 0.74
Tc by User = 5.00 min
Asc/Rec limb fact = 1/1

Hydrograph Volume = 4,911 cuft

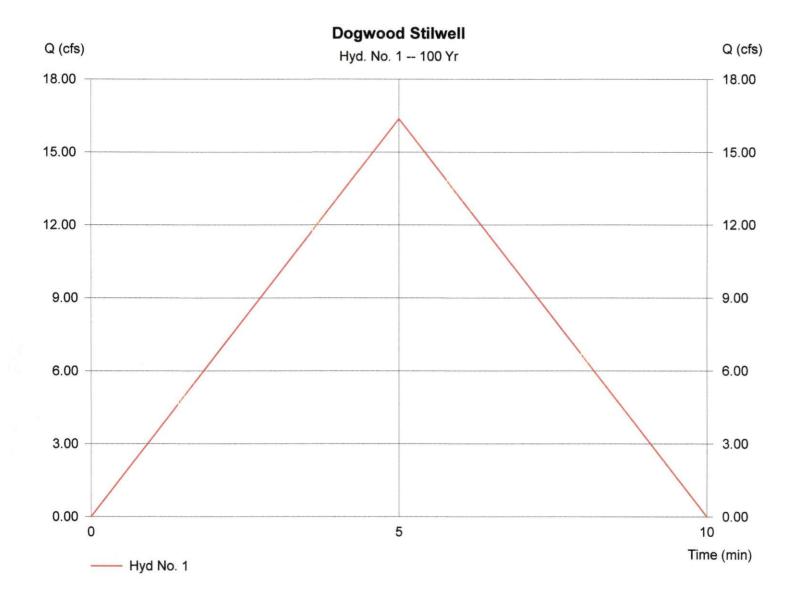

Hydraflow Hydrographs by Intelisolve


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### Hyd. No. 1

Dogwood No.2 w/ houses

Hydrograph type = Rational Storm frequency = 2 yrs Drainage area = 2.250 ac Intensity = 5.693 in/hr IDF Curve = SampleFHA.idf Peak discharge = 10.89 cfs
Time interval = 1 min
Runoff coeff. = 0.85
Tc by User = 5.00 min
Asc/Rec limb fact = 1/1

Hydrograph Volume = 3,266 cuft

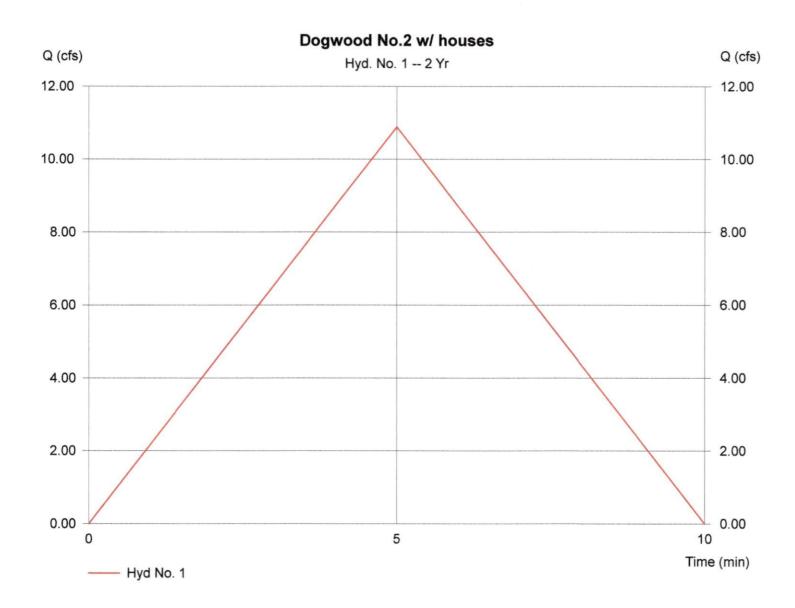

Hydraflow Hydrographs by Intelisolve


Thursday, Jun 29 2023, 8:21 AM

#### Hyd. No. 1

Dogwood No.2 w/ houses

 Peak discharge = 12.56 cfs
Time interval = 1 min
Runoff coeff. = 0.85
Tc by User = 5.00 min
Asc/Rec limb fact = 1/1

Hydrograph Volume = 3,769 cuft

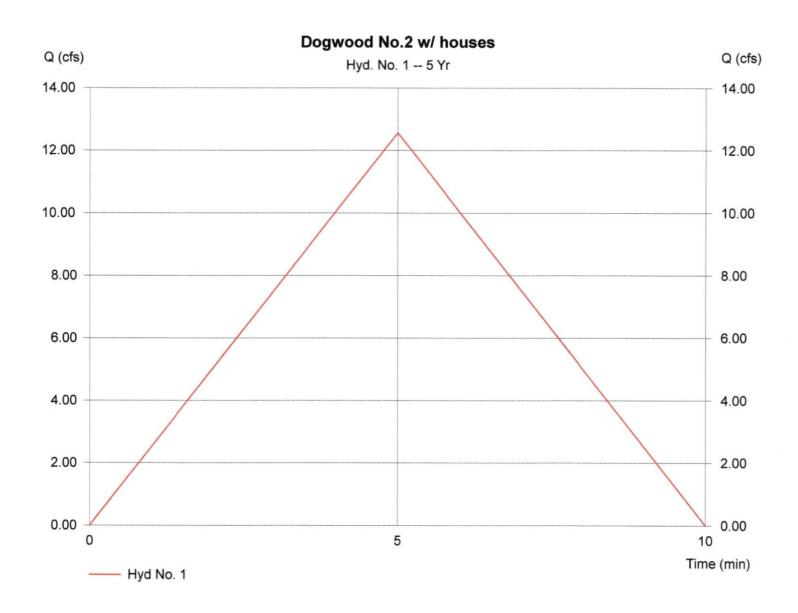

Hydraflow Hydrographs by Intelisolve

Thursday, Jun 29 2023, 8:21 AM


### Hyd. No. 1

Dogwood No.2 w/ houses

Hydrograph type = Rational
Storm frequency = 10 yrs
Drainage area = 2.250 ac
Intensity = 7.238 in/hr
IDF Curve = SampleFHA.idf

Peak discharge = 13.84 cfs
Time interval = 1 min
Runoff coeff. = 0.85
Tc by User = 5.00 min
Asc/Rec limb fact = 1/1

Hydrograph Volume = 4,153 cuft

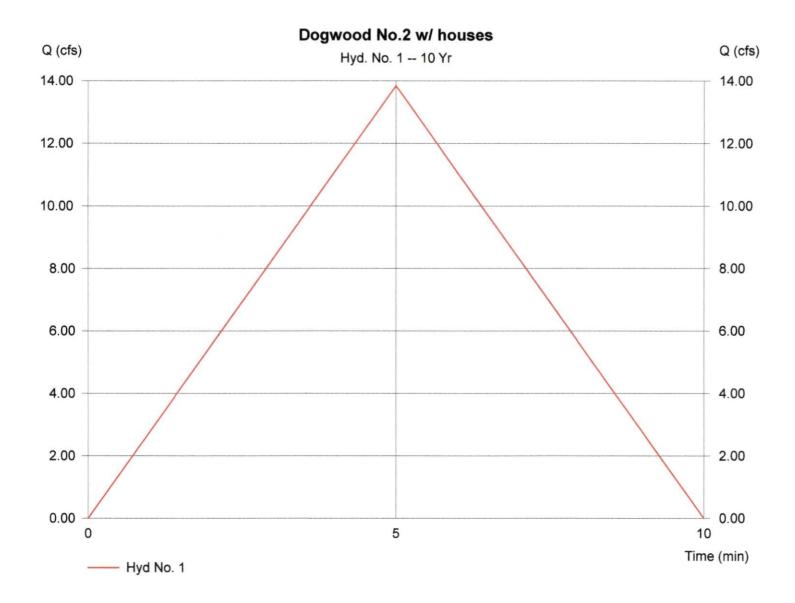

Hydraflow Hydrographs by Intelisolve


Thursday, Jun 29 2023, 8:21 AM

#### Hyd. No. 1

Dogwood No.2 w/ houses

Hydrograph type = Rational Storm frequency = 25 yrs Drainage area = 2.250 ac Intensity = 8.247 in/hr IDF Curve = SampleFHA.idf Peak discharge = 15.77 cfs
Time interval = 1 min
Runoff coeff. = 0.85
Tc by User = 5.00 min
Asc/Rec limb fact = 1/1

Hydrograph Volume = 4,732 cuft

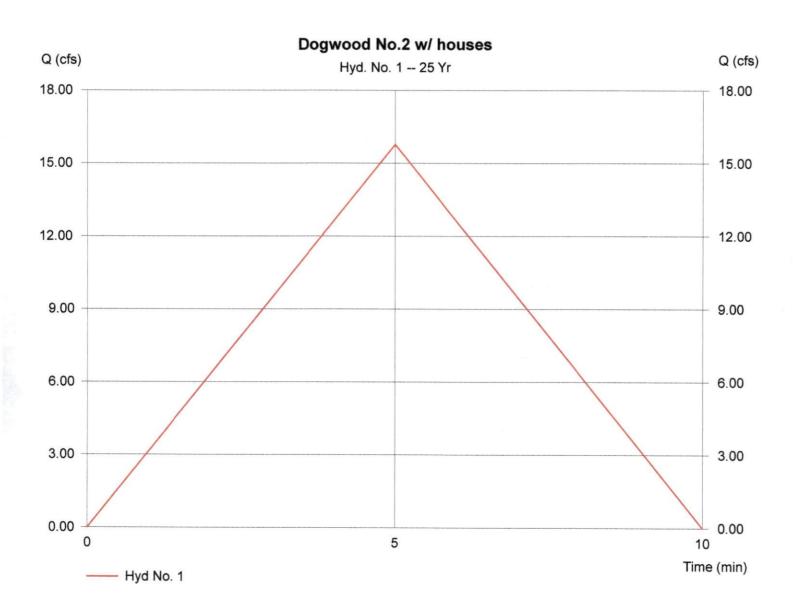

Hydraflow Hydrographs by Intelisolve


Thursday, Jun 29 2023, 8:21 AM

### Hyd. No. 1

Dogwood No.2 w/ houses

Hydrograph type = Rational Storm frequency = 50 yrs Drainage area = 2.250 ac Intensity = 9.041 in/hr IDF Curve = SampleFHA.idf Peak discharge = 17.29 cfs
Time interval = 1 min
Runoff coeff. = 0.85
Tc by User = 5.00 min
Asc/Rec limb fact = 1/1

Hydrograph Volume = 5,187 cuft

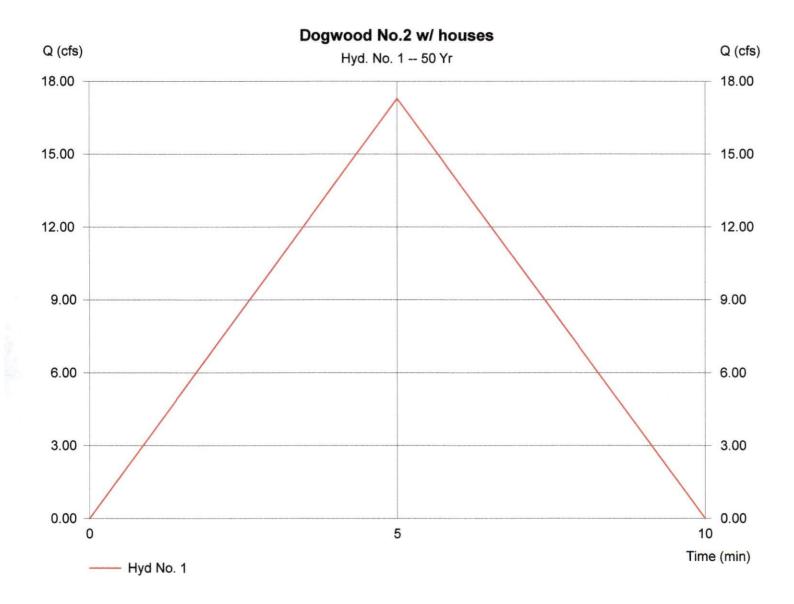

Hydraflow Hydrographs by Intelisolve


Thursday, Jun 29 2023, 8:22 AM

### Hyd. No. 1

Dogwood No.2 w/ houses

Hydrograph type = Rational Storm frequency = 100 yrs Drainage area = 2.250 ac Intensity = 9.833 in/hr IDF Curve = SampleFHA.idf Peak discharge = 18.81 cfs
Time interval = 1 min
Runoff coeff. = 0.85
Tc by User = 5.00 min
Asc/Rec limb fact = 1/1

Hydrograph Volume = 5,642 cuft

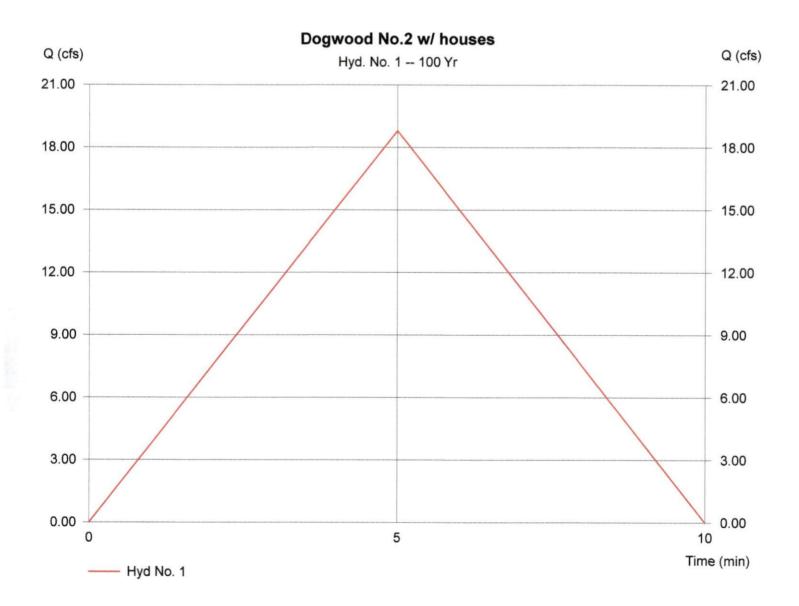

### **Pond Report**

Hydraflow Hydrographs by Intelisolve

Thursday, Jun 29 2023, 8:34 AM

#### Pond No. 1 - Dogwood no. 2 with houses

**Pond Data** 

Bottom LxW =  $25.0 \times 12.0 \text{ ft}$ 

Side slope = 1.0:1

Bottom elev. = 1088.10 ft Depth = 4.40 ft

#### Stage / Storage Table

Stage (ft)	Elevation (ft)	Contour area (sqft)	Incr. Storage (cuft)	Total storage (cuft)
0.00	1088.10	300	0	0
0.22	1088.32	316	68	68
0.44	1088.54	333	71	139
0.66	1088.76	351	75	215
0.88	1088.98	368	79	294
1.10	1089.20	386	83	377
1.32	1089.42	405	87	464
1.54	1089.64	423	91	555
1.76	1089.86	443	95	650
1.98	1090.08	462	100	749
2.20	1090.30	482	104	853
2.42	1090.52	503	108	962
2.64	1090.74	523	113	1,074
2.86	1090.96	544	117	1,192
3.08	1091.18	566	122	1,314
3.30	1091.40	588	127	1,441
3.52	1091.62	610	132	1,573
3.74	1091.84	633	137	1,709
3.96	1092.06	656	142	1,851
4.18	1092.28	679	147	1,998
4.40	1092.50	703	152	2,150

#### **Culvert / Orifice Structures**

#### **Weir Structures**

	[A]	[B]	[C]	[D]		[A]	[B]	[C]	[D]
Rise (in)	= 24.00	0.00	0.00	0.00	Crest Len (ft)	= 0.00	0.00	0.00	0.00
Span (in)	= 24.00	0.00	0.00	0.00	Crest El. (ft)	= 0.00	0.00	0.00	0.00
No. Barrels	= 1	0	0	0	Weir Coeff.	= 0.00	0.00	0.00	0.00
Invert El. (ft)	= 1088.10	0.00	0.00	0.00	Weir Type	=	10 No. 10		
Length (ft)	= 100.00	0.00	0.00	0.00	Multi-Stage	= No	No	No	No
Slope (%)	= 0.00	0.00	0.00	0.00	•				
N-Value	= .013	.000	.000	.000					
Orif. Coeff.	= 0.60	0.00	0.00	0.00					
Multi-Stage	= n/a	No	No	No	Exfiltration = 0	.000 in/hr (We	t area) Ta	ilwater Ele	v. = 0.00 ft

Note: Culvert/Orifice outflows have been analyzed under inlet and outlet control.

