

4" TYP. TO FRAME UNLESS NOTED OTHERWISE

NEW WALL / PARTITION EXISTING WALL / PARTITION

TYPICAL DOOR PLACEMENT,

UNLESS NOTED OTHERWISE. APPLIES TO SINGLE AND DOUBLE DOORS

- ALIGN FINISHED EDGES, UNLESS NOTED OTHERWISE

OTHERWISE. DO NOT SCALE DRAWINGS. CONTACT ARCHITECT FOR CLARIFICATION. ALL EXTERIOR DIMENSIONS ARE FROM FACE OF EXTERIOR FINISH, UNLESS NOTED OTHERWISE.

ALL INTERIOR DIMENSIONS ARE TO THE FACE OF STUD, UNLESS NOTED

- UNLESS DIMENSIONED OTHERWISE, ALIGN PARTITIONS ON GRIDLINES WITH CENTERLINE OF STUD.
- . INTERIOR PARTITIONS ARE TYPE XXXX UNLESS NOTED OTHERWISE. REFER TO SHEET A601 FOR PARTITION TYPES. 5. WHEN WALL PARTITIONS OF DIFFERENT FIRE OR SOUND RATINGS INTERSECT, THE
- HIGHEST RATED PARTITION SHALL TAKE PRECEDENT. . WHERE EQUIPMENT IS SHOWN IN DASHED AND / OR HALFTONE, IT SHALL BE OWNER FURNISHED, OWNER INSTALLED, UNLESS NOTED OTHERWISE. EQUIPMENT, WHERE SHOWN, IS FOR COORDINATION AND BACKING PURPOSES ONLY. CONFIRM MAKES AND MODELS WITH OWNER. VERIFY EQUIPMENT ROUGH-IN DIMENSIONS WITH MANUFACTURER. COORDINATE UTILITIES FOR EQUIPMENT WITH OWNER'S EQUIPMENT AND MEP DOCUMENTS. CONTRACTOR TO VERIFY AND COORDINATE ALL EQUIPMENT WITH OWNER, INCLUDING BUT NOT LIMITED TO

WEIGHT, LOCATION, BACKING REQUIREMENTS, POWER AND CLEARANCES.

- REFER TO SHEET A610 FOR DOOR SCHEDULE AND DETAILS.
- 8. REFER TO SHEET IDIOI FOR FINISH INFORMATION, SCHEDULES, AND DETAILS.
- B. REFER TO A200 SERIES SHEETS FOR EXTERIOR ELEVATIONS.
- 10. REFER TO A400 SERIES SHEETS FOR ENLARGED PLANS.

PARTITION TYPES GRAPHICS CONVENTION

TYPICAL PARTITION WITH NO SPECIAL MATERIALS OR RATINGS TYPICAL PARTITION

FIRE RATED PARTITIONS USE STRIPES TO CONVEY HOURS 1-HR FIRE RATING

// // // // 2-HR FIRE RATING /// /// /// 3-HR FIRE RATING SMOKE RESISTANCE IS NOTED WITH THIN DIAGONAL HATCH

/////// SMOKE PARTITION PARTITIONS WITH COMBINED FIRE RATING \$ SMOKE RESISTANCE

RATINGS MAY BE COMBINED WITH SPECIAL WALL MATERIALS; EX: 1-HR FIRE RATED MASONRY 2-HR FIRE/SMOKE RATED MASONRY

1-HR CONCRETE

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CATOOSA. OKLAHOMA blueriver ARCHITECTS A Native American Owned Firm


BLUE RIVER PROJECT NUMBER: 20230011 ISSUE DATE: 03/14/2024 ISSUE: CM PACKAGE

OTHER ISSUE DATES: NO. DESCRIPTION

SHEET NAME:
FIRST FLOOR PLAN - AREA A

A FLOOR PLAN - AREA A

1/8" = 1'-0"

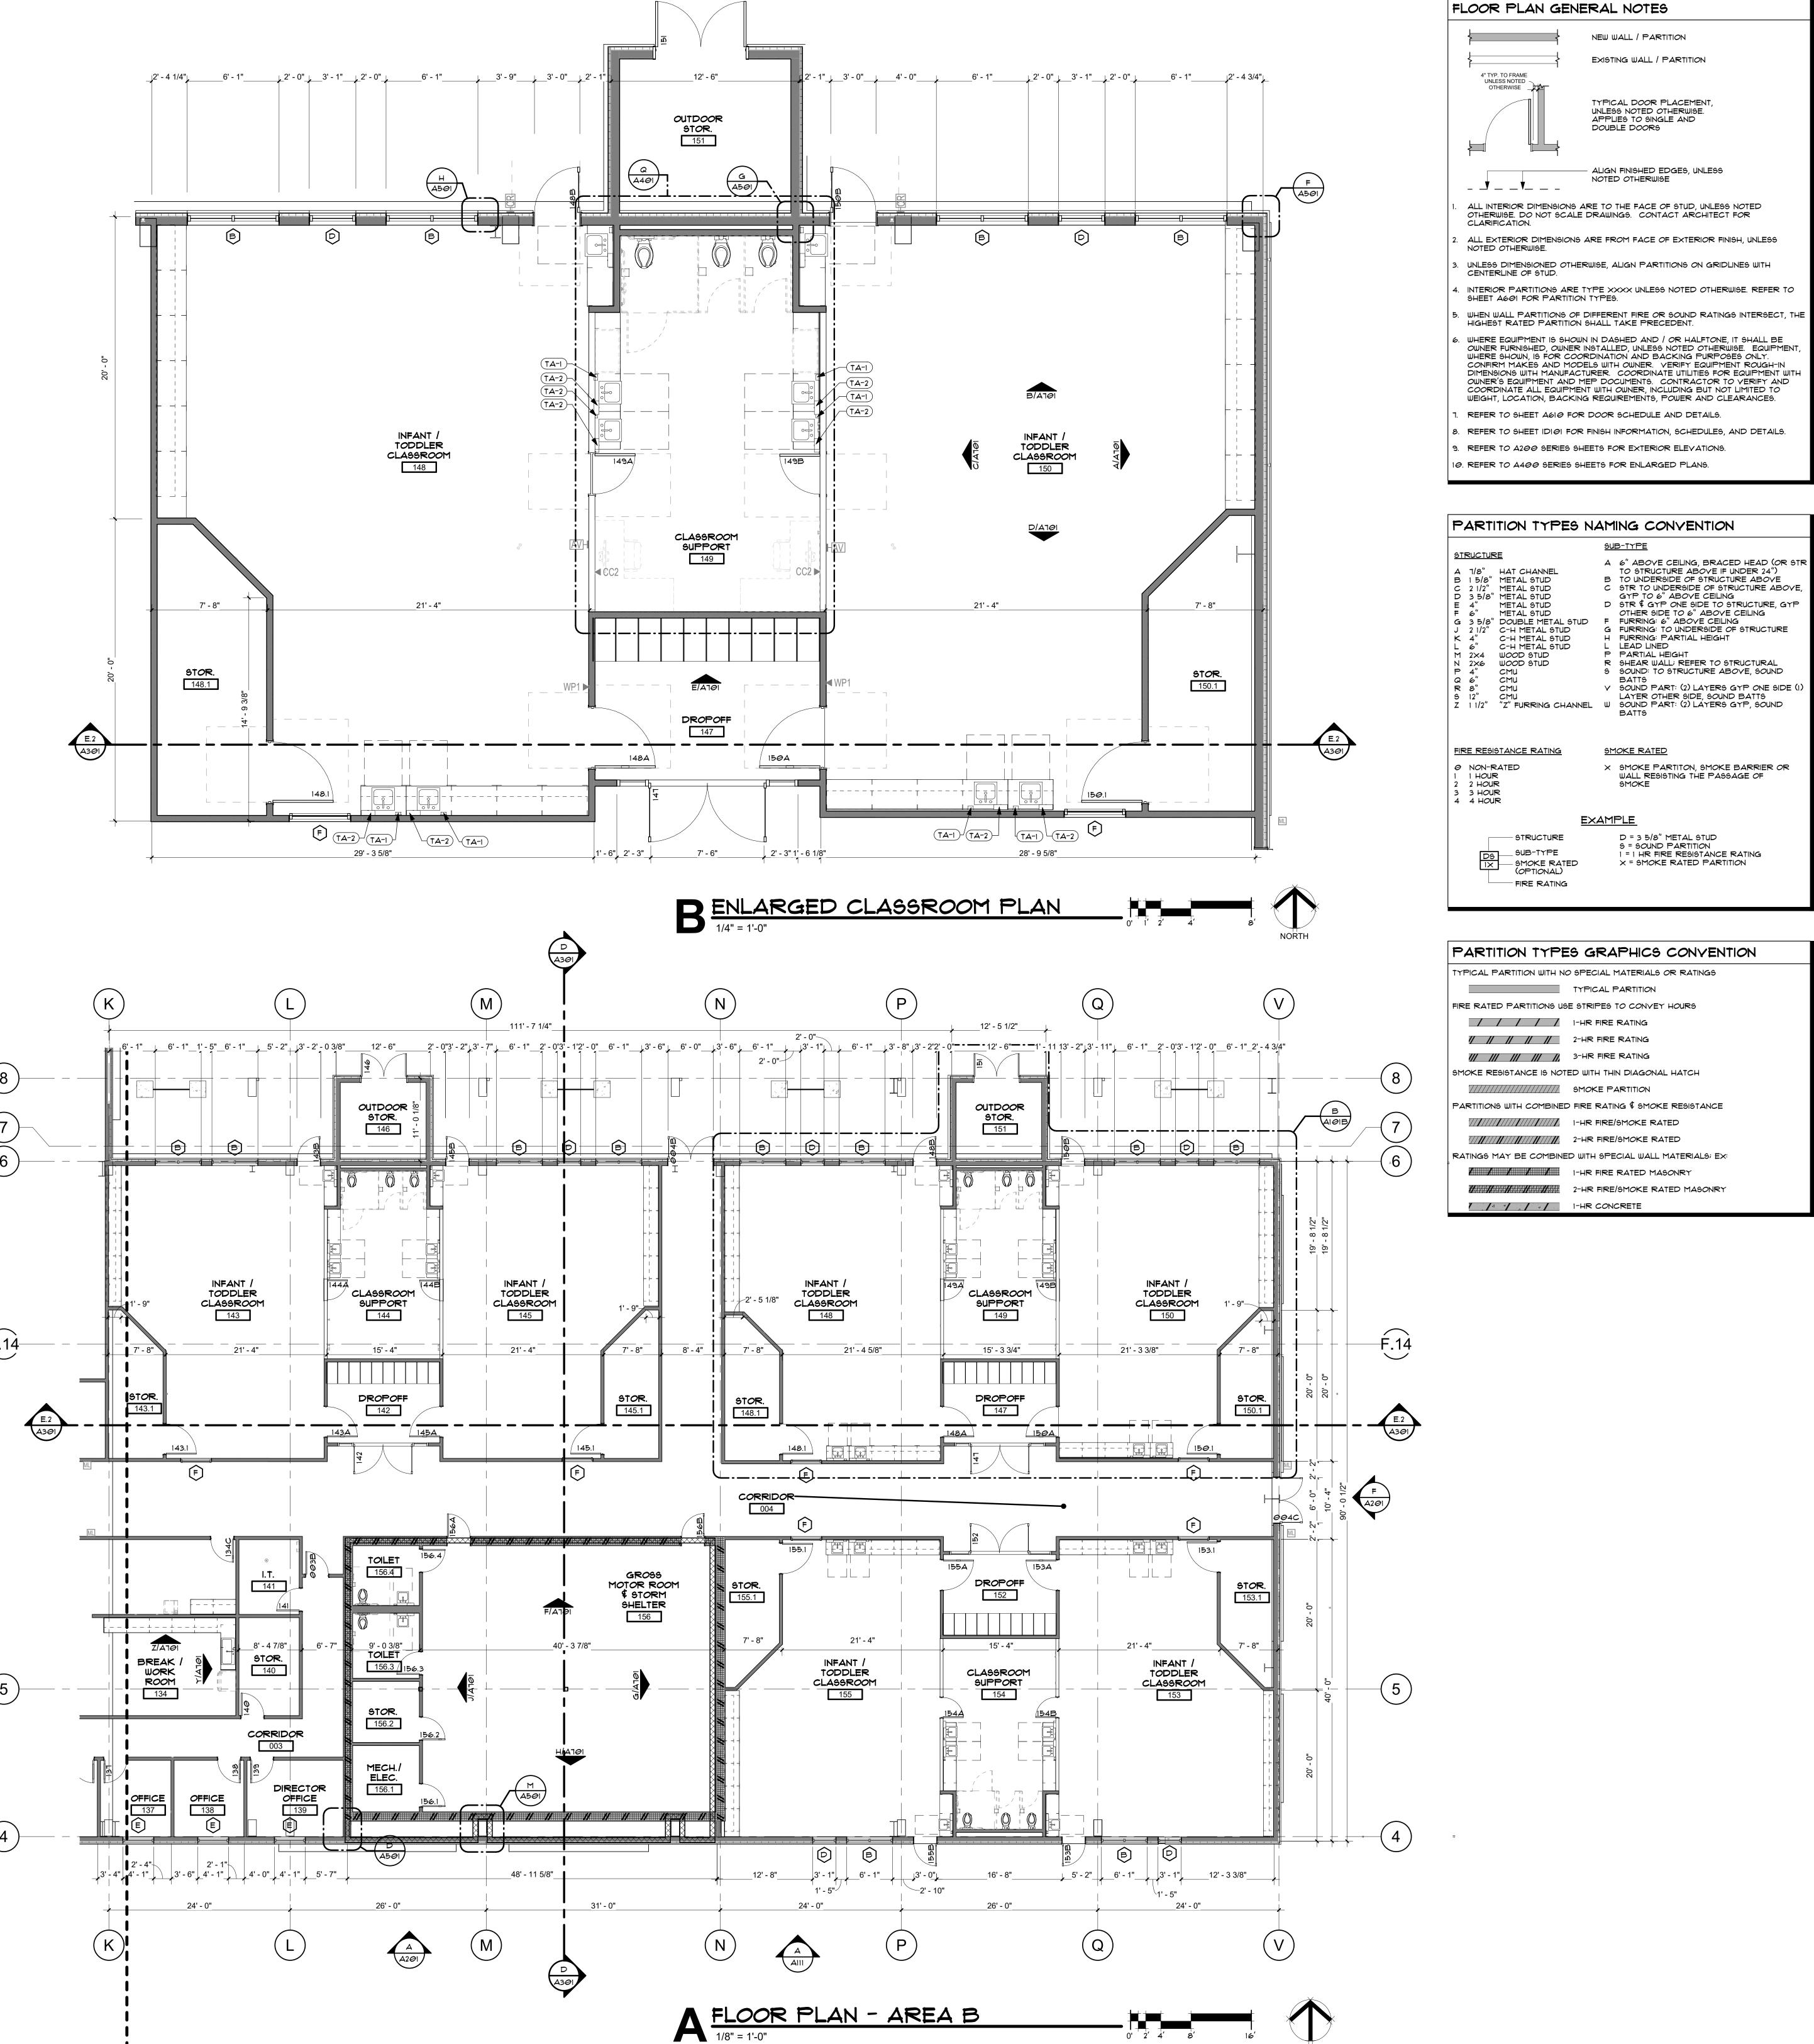



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PARTITION TYPES NAMING CONVENTION STRUCTURE A 6" ABOVE CEILING, BRACED HEAD (OR STR TO STRUCTURE ABOVE IF UNDER 24") A 1/8" HAT CHANNEL B 15/8" METAL STUD C 21/2" METAL STUD B TO UNDERSIDE OF STRUCTURE ABOVE STR TO UNDERSIDE OF STRUCTURE ABOVE, GYP TO 6" ABOVE CEILING D 35/8" METAL STUD E 4" METAL STUD F 6" METAL STUD D STR \$ GYP ONE SIDE TO STRUCTURE, GYP OTHER SIDE TO 6" ABOVE CEILING

F FURRING: 6" ABOVE CEILING

G FURRING: TO UNDERSIDE OF STRUCTURE G 35/8" DOUBLE METAL STUD C-H METAL STUD J 2 1/2" C-H METAL STUD K 4" C-H METAL STUD FURRING: PARTIAL HEIGHT LEAD LINED C-H METAL STUD M 2X4 WOOD STUD
N 2X6 WOOD STUD
P 4" CMU PARTIAL HEIGHT R SHEAR WALL; REFER TO STRUCTURAL 9 SOUND: TO STRUCTURE ABOVE, SOUND BATTS R 8" CMU Y SOUND PART: (2) LAYERS GIF ONE SIDE N S 12" CMU LAYER OTHER SIDE, SOUND BATTS Z 1 1/2" "Z" FURRING CHANNEL W SOUND PART: (2) LAYERS GYP, SOUND BATTS Y SOUND PART: (2) LAYERS GYP ONE SIDE (1) FIRE RESISTANCE RATING SMOKE RATED X SMOKE PARTITON, SMOKE BARRIER OR WALL RESISTING THE PASSAGE OF SMOKE 0 NON-RATED 2 HOUR 3 3 HOUR 4 4 HOUR EXAMPLE D = 3 5/8" METAL STUD S = SOUND PARTITION STRUCTURE SUB-TYPE

IX SMOKE RATED

(OPTIONAL) I = I HR FIRE RESISTANCE RATING X = SMOKE RATED PARTITION

NEW WALL / PARTITION

EXISTING WALL / PARTITION

TYPICAL DOOR PLACEMENT, UNLESS NOTED OTHERWISE.

- ALIGN FINISHED EDGES, UNLESS

APPLIES TO SINGLE AND

DOUBLE DOORS

NOTED OTHERWISE

PARTITION TYPES GRAPHICS CONVENTION

TYPICAL PARTITION WITH NO SPECIAL MATERIALS OR RATINGS TYPICAL PARTITION FIRE RATED PARTITIONS USE STRIPES TO CONVEY HOURS 1-HR FIRE RATING

// // // 2-HR FIRE RATING /// /// /// 3-HR FIRE RATING SMOKE RESISTANCE IS NOTED WITH THIN DIAGONAL HATCH ////// SMOKE PARTITION PARTITIONS WITH COMBINED FIRE RATING \$ SMOKE RESISTANCE

2-HR FIRE/SMOKE RATED RATINGS MAY BE COMBINED WITH SPECIAL WALL MATERIALS; EX: 1-HR FIRE RATED MASONRY

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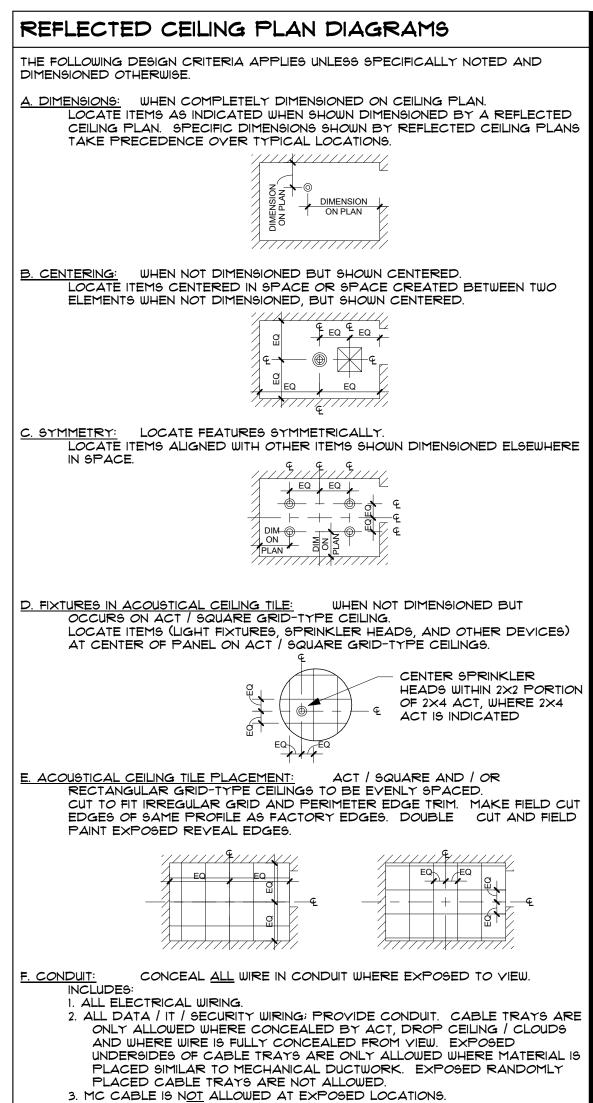
BLUE RIVER PROJECT NUMBER: 20230011 ISSUE DATE: **TBD**

ISSUE:

CM PACKAGE

OTHER ISSUE DATES: NO. DESCRIPTION

FIRST FLOOR PLAN - AREA B



REFLECTED CEILING PLAN NOTES

ALL CEILINGS SHALL BE X' - X" AFF, UNLESS NOTED OTHERWISE.

ALL CEILING FINISHES TO BE ACT-1, UNLESS NOTED OTHERWISE. ALL CEILING GRIDS TO BE CENTERED IN ROOM, UNLESS NOTED OTHERWISE.

REFER TO MECHANICAL AND ELECTRICAL DRAWINGS FOR MOUNTING LOCATIONS OF ITEMS WHERE NO CEILING IS REQUIRED OR INDICATED. . IN THE CASE OF MINOR DISCREPANCIES BETWEEN MECHANICAL, ELECTRICAL, PLUMBING AND ARCHITECTURAL DOCUMENTS IN THE LOCATION OF CEILING

MOUNTED COMPONENTS, THE ARCHITECTURAL REFLECTED CEILING PLAN SHALL GOVERN. IN THE CASE OF MAJOR DISCREPANCIES, THE ARCHITECT SHALL BE NOTIFIED AS SOON AS THE DISCREPANCY IS DISCOVERED PRIOR TO PROCEEDING WITH THE WORK.

 LIGHT9, EXIT 9IGN9, 9MOKE DETECTOR9, 9PEAKER9, DIFFU9ER9, 9TROBE9, AND MISCELLANEOUS DEVICES SHALL BE CENTERED IN THE CEILING TILE IN WHICH THEY OCCUR, UNLESS NOTED OTHERWISE.

6. CENTER, ALIGN AND / OR LOCATE LIGHT FIXTURES, MECHANICAL GRILLES, LIFE SAFETY DEVICES, OCCUPANCY SENSORS, SECURITY AND DATA FIXTURES AND OTHER MISCELLANEOUS COMPONENTS IN A UNIFORM AND ORDERLY FASHION, UNLESS ALTERNATE ARRANGEMENT IS SPECIFICALLY DIMENSIONED AND NOTED. INSTALL TRUE AND SQUARE.

IT IS THE CONTRACTOR'S RESPONSIBILITY TO COORDINATE THE FIT OF ALL WORK AND TO PROVIDE A UNIFORM AND ORDERLY PLACEMENT AND APPEARANCE, WHETHER EXPOSED TO VIEW OR CONCEALED BY FINISHES.

B. ALL SPRINKLER HEADS SHALL BE ALIGNED IN THE SAME CEILING LOCATION PARALLEL TO THE WALL WITHIN EACH SPECIFIC CEILING CONSTRUCTION. . CENTER EXIT SIGNS ABOVE DOORS, UNLESS ALTERNATE ARRANGEMENT IS

SPECIFICALLY DIMENSIONED AND NOTED. 10. CENTER, ALIGN AND LOCATE ACCESS PANELS IN ACCORDANCE WITH DESIGN CRITERIA FOR OTHER DEVICES. SUBMIT SHOP DRAWINGS THAT INDICATE EXACT SIZE, TYPE AND LOCATION OF CEILING AND WALL ACCESS PANELS FOR REVIEW AND ACCEPTANCE BEFORE INSTALLATION. ALL ACCESS PANELS SHALL BE PAINTED, UNLESS NOTED OTHERWISE AND EXTERIOR GRADE WHERE

PROVIDE GYPSUM BOARD BULKHEADS WHERE CEILINGS OF DIFFERENT HEIGHTS OR ORIENTATION ABUT. DO NOT BUILD BULKHEADS OF ACOUSTICAL

. ALIGN ALL SOFFITS AND / OR BULKHEADS WITH ADJACENT WALLS, UNLESS NOTED OTHERWISE.

S. PROVIDE SUFFICIENT SUPPORT AND GRID SYSTEMS TO SUPPORT ALL CEILING MOUNTED DEVICES. ALL FIXTURES SHALL BE SUPPORTED AT EACH CORNER.

14. ALL OUTLETS, RECEPTACLES, DEVICES AND COVER PLATES SHALL BE INSTALLED PLUMB AND LEVEL. CROOKED INSTALLATION IS NOT ALLOWED. 15. MISALIGNED MEP FIXTURES OF ANY TYPE OR AT ANY LOCATION EXPOSED TO

VIEW ARE NOT ALLOWED. MISALIGNED FIXTURES SHALL BE ADJUSTED OR REMOVED AND REPLACED IF REQUIRED FOR PROPER ALIGNMENT AT NO ADDITIONAL COST. 16. ALL RECESSED LIGHTING TO BE SEALED AIR-TIGHT, ICC-RATED AND SEALED TO GYPSUM BOARD OR FINISH MATERIAL AS REQUIRED BY THE IECC

(INTERNATIONAL ENERGY CONSERVATION CODE). ALL MECHANICAL, ELECTRICAL AND PLUMBING FIXTURES SHALL BE IECC COMPLIANT. I. CONTRACTOR TO COORDINATE ALL OUTLETS, SWITCHES AND POWER FEED WITH CASEWORK, PARTITIONS, FINISHES, FIXTURES AND EQUIPMENT.

18. SPRINKLER HEAD TYPES AND FINISHES: A. EXPOSED STRUCTURE: EXPOSED / CHROME. B. FINISHED CEILING OR WALLS: FULLY RECESSED AND CONCEALED WITH WHITE COVER PLATE, FLAT AND FLUSH WITH CEILING OR WALL. PRE-FINISHED METAL CEILING OR WALL FEATURES: FULLY RECESSED AND CONCEALED WITH COVER PLATE, FLAT AND FLUSH TO MATCH ADJACENT

FINISH, CUSTOM COLOR MAY BE REQUIRED IF MANUFACTURER'S RANGE DOES NOT PROVIDE MATCH, IN THE OPINION OF THE ARCHITECT. D. PROVIDE SPRINKLER GUARDS WHERE REQUIRED BY CODE. 19. PROVIDE SPRINKLER HEADS AND COVERS IN ACCORDANCE WITH SPECIFIED LEYEL OF EXPOSURE (TO VIEW), DESIGN CRITERIA AND AS INDICATED. PROVIDE BRAIDED METAL FLEXIBLE SPRINKLER DROPS AT ALL FINISHED CEILINGS OR WHERE REQUIRED FOR SPECIFIED PLACEMENT. CENTER AND ALIGN PIPES WITH ARCHITECTURAL FEATURES. PROVIDE ADDITIONAL HEADS

BEYOND THAT REQUIRED FOR MINIMUM COVERAGE AS REQUIRED TO COMPLY WITH ARCHITECTURAL LAYOUT, AND UNIFORM ALIGNMENT WITH OTHER FIXTURES.

SUBMIT LAYOUT FOR REVIEW PRIOR TO AHJ REVIEW OR INSTALLATION. 20. PROVIDE PRE-FINISHED GRAY ELECTRICAL DEVICES AND STAINLESS STEEL COVER PLATES AT ALL WALLS IN PROJECT. AT ALL OTHER LOCATIONS, SUCH AS CASEWORK, RECEPTACLES AND COVER PLATES SHALL MATCH ADJACENT FINISHES, AS DETERMINED AND SELECTED BY THE ARCHITECT FROM MANUFACTURER'S FULL RANGE. FIELD PAINT WHERE REQUIRED.

. MAINTAIN CONTINUOUS FIRE RATED ENCLOSURES AS REQUIRED AT RATED WALLS AND CEILINGS. PROVIDE FIRE RATED FIXTURE COVERS, J-BOXES OR CONSTRUCT GYPSUM BOARD ENCLOSURES WHERE REQUIRED FOR FIXTURE OR MEP RUNS TO MAINTAIN CONTINUOUS FIRE RATING.

2. REFER TO MECHANICAL DRAWINGS FOR ADDITIONAL INFORMATION FOR DIFFUSERS AND GRILLE TYPES. REFER TO ELECTRICAL DRAWINGS FOR FIXTURE SCHEDULES AND ADDITIONAL INFORMATION. DESIGN INTENT FOR APPEARANCE, TYPE, ARRANGEMENT AND LOCATION IS INDICATED ON ARCHITECTURAL DRAWINGS. REPORT DISCREPANCIES TO ARCHITECT FOR CLARIFICATION PRIOR TO ORDERING MATERIALS OR THE START OF ROUGH-IN

23. LIFE SAFETY DEVICE COLORS: GRAY (UNLESS RED IS SPECIFICALLY REQUIRED A. WHITE, AT WHITE CEILINGS OR WHERE EXPOSED STRUCTURES.


B. OTHER CEILINGS: NOT ALLOWED, USE WALL MOUNTED. C. INTERIOR / EXTERIOR WALLS: GRAY.

24. EXPOSED METAL DUCTWORK: ALL METAL DUCTWORK EXPOSED TO VIEW SHALL HAVE UNIFORM AND NEAT SEALANT AND SEAMS, CLEAN EXCESS SEALANT. PROVIDE 12 FOOT BY 12 FOOT MOCK-UP TO ILLUSTRATE ALL SEAMS AND SEALANT TYPES IN PROJECT.

25. EXPOSED STRUCTURE: WHEN NOT DIMENSIONED, BUT OCCURS ON OR ADJACENT TO EXPOSED STRUCTURE. LOCATE ITEMS (LIGHT FIXTURES, SPRINKLER PIPING / HEADS, MECHANICAL DUCTS, PIPES, PLUMBING, DEVICES, AND ALL ASSOCIATED MOUNTING BRACKETS AND FASTENERS) CENTERED WITHIN SPACE BETWEEN OR ON STRUCTURAL ELEMENTS. MATCH ORIENTATION OF STRUCTURE, UNLESS A SPECIFIC ALTERNATE ARRAIGNMENT IS DIMENSIONED AND NOTED. CHANGE ORIENTATION OF ITEMS, IN ACCORDANCE WITH DESIGN CRITERIA FOR PLACEMENT, TO MATCH CHANGES IN ORIENTATION OF STRUCTURE. WHERE MULTIPLE SYSTEMS NEED TO SHARE THE SAME SPACE, CENTER ONE SYSTEM AND ALIGN ADJACENT SYSTEMS IN A UNIFORM AND


26. COORDINATION: ALL DEVICES REQUIRED FOR PROJECT MAY NOT BE SHOWN ON ARCHITECTURAL DRAWINGS. REFER TO MECHANICAL, ELECTRICAL, PLUMBING AND TECHNOLOGY DRAWINGS FOR ADDITIONAL DEVICES. ALL DEVICES IN PROJECT SHALL FOLLOW DESIGN CRITERIA FOR PLACEMENT, AS INDICATED, WHETHER OR NOT SHOWN ON ARCHITECTURAL DRAWINGS. REPORT DISCREPANCIES TO ARCHITECT FOR CLARIFICATION PRIOR TO INSTALLATION.

17. COORDINATION DRAWINGS - PROVIDE THE FOLLOWING: PREPARE COORDINATION DRAWINGS TO A SCALE OF 1/4 INCH = 1'-0" OR LARGER. DETAILING MAJOR ELEMENTS, COMPONENTS, AND SYSTEMS OF FIRE PROTECTION EQUIPMENT AND MATERIALS IN RELATIONSHIP WITH OTHER SYSTEMS, INSTALLATIONS, AND BUILDING COMPONENTS. INDICATE LOCATIONS WHERE SPACE IS LIMITED FOR INSTALLATION AND ACCESS AND WHERE SEQUENCING AND COORDINATION OF INSTALLATION ARE IMPORTANT TO THE EFFICIENT FLOW OF THE WORK, INCLUDING, BUT NOT NECESSARILY LIMITED TO A. INDICATE THE PROPOSED LOCATIONS OF PIPING, EQUIPMENT, HANGERS, HEAD TYPES AND LOCATIONS, AND MATERIALS. B. CLEARANCES FOR INSTALLING AND MAINTAINING INSULATION.

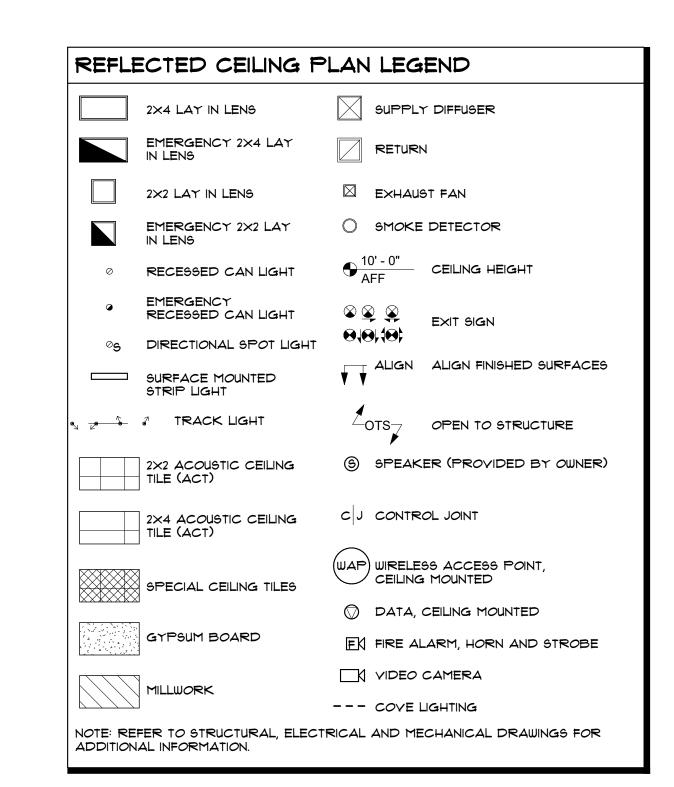




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ROKE blueriver ARCHITECTS A Native American Owned Firm BLUE RIVER PROJECT NUMBER: 20230011 ISSUE DATE: **TBD** ISSUE: **CM PACKAGE** OTHER ISSUE DATES: NO. DESCRIPTION

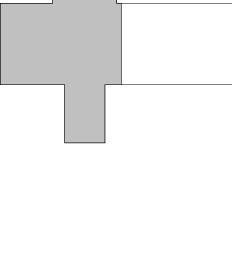SHEET NAME: REFLECTED **CEILING PLAN -**AREA A



REFLECTED CEILING PLAN NOTES

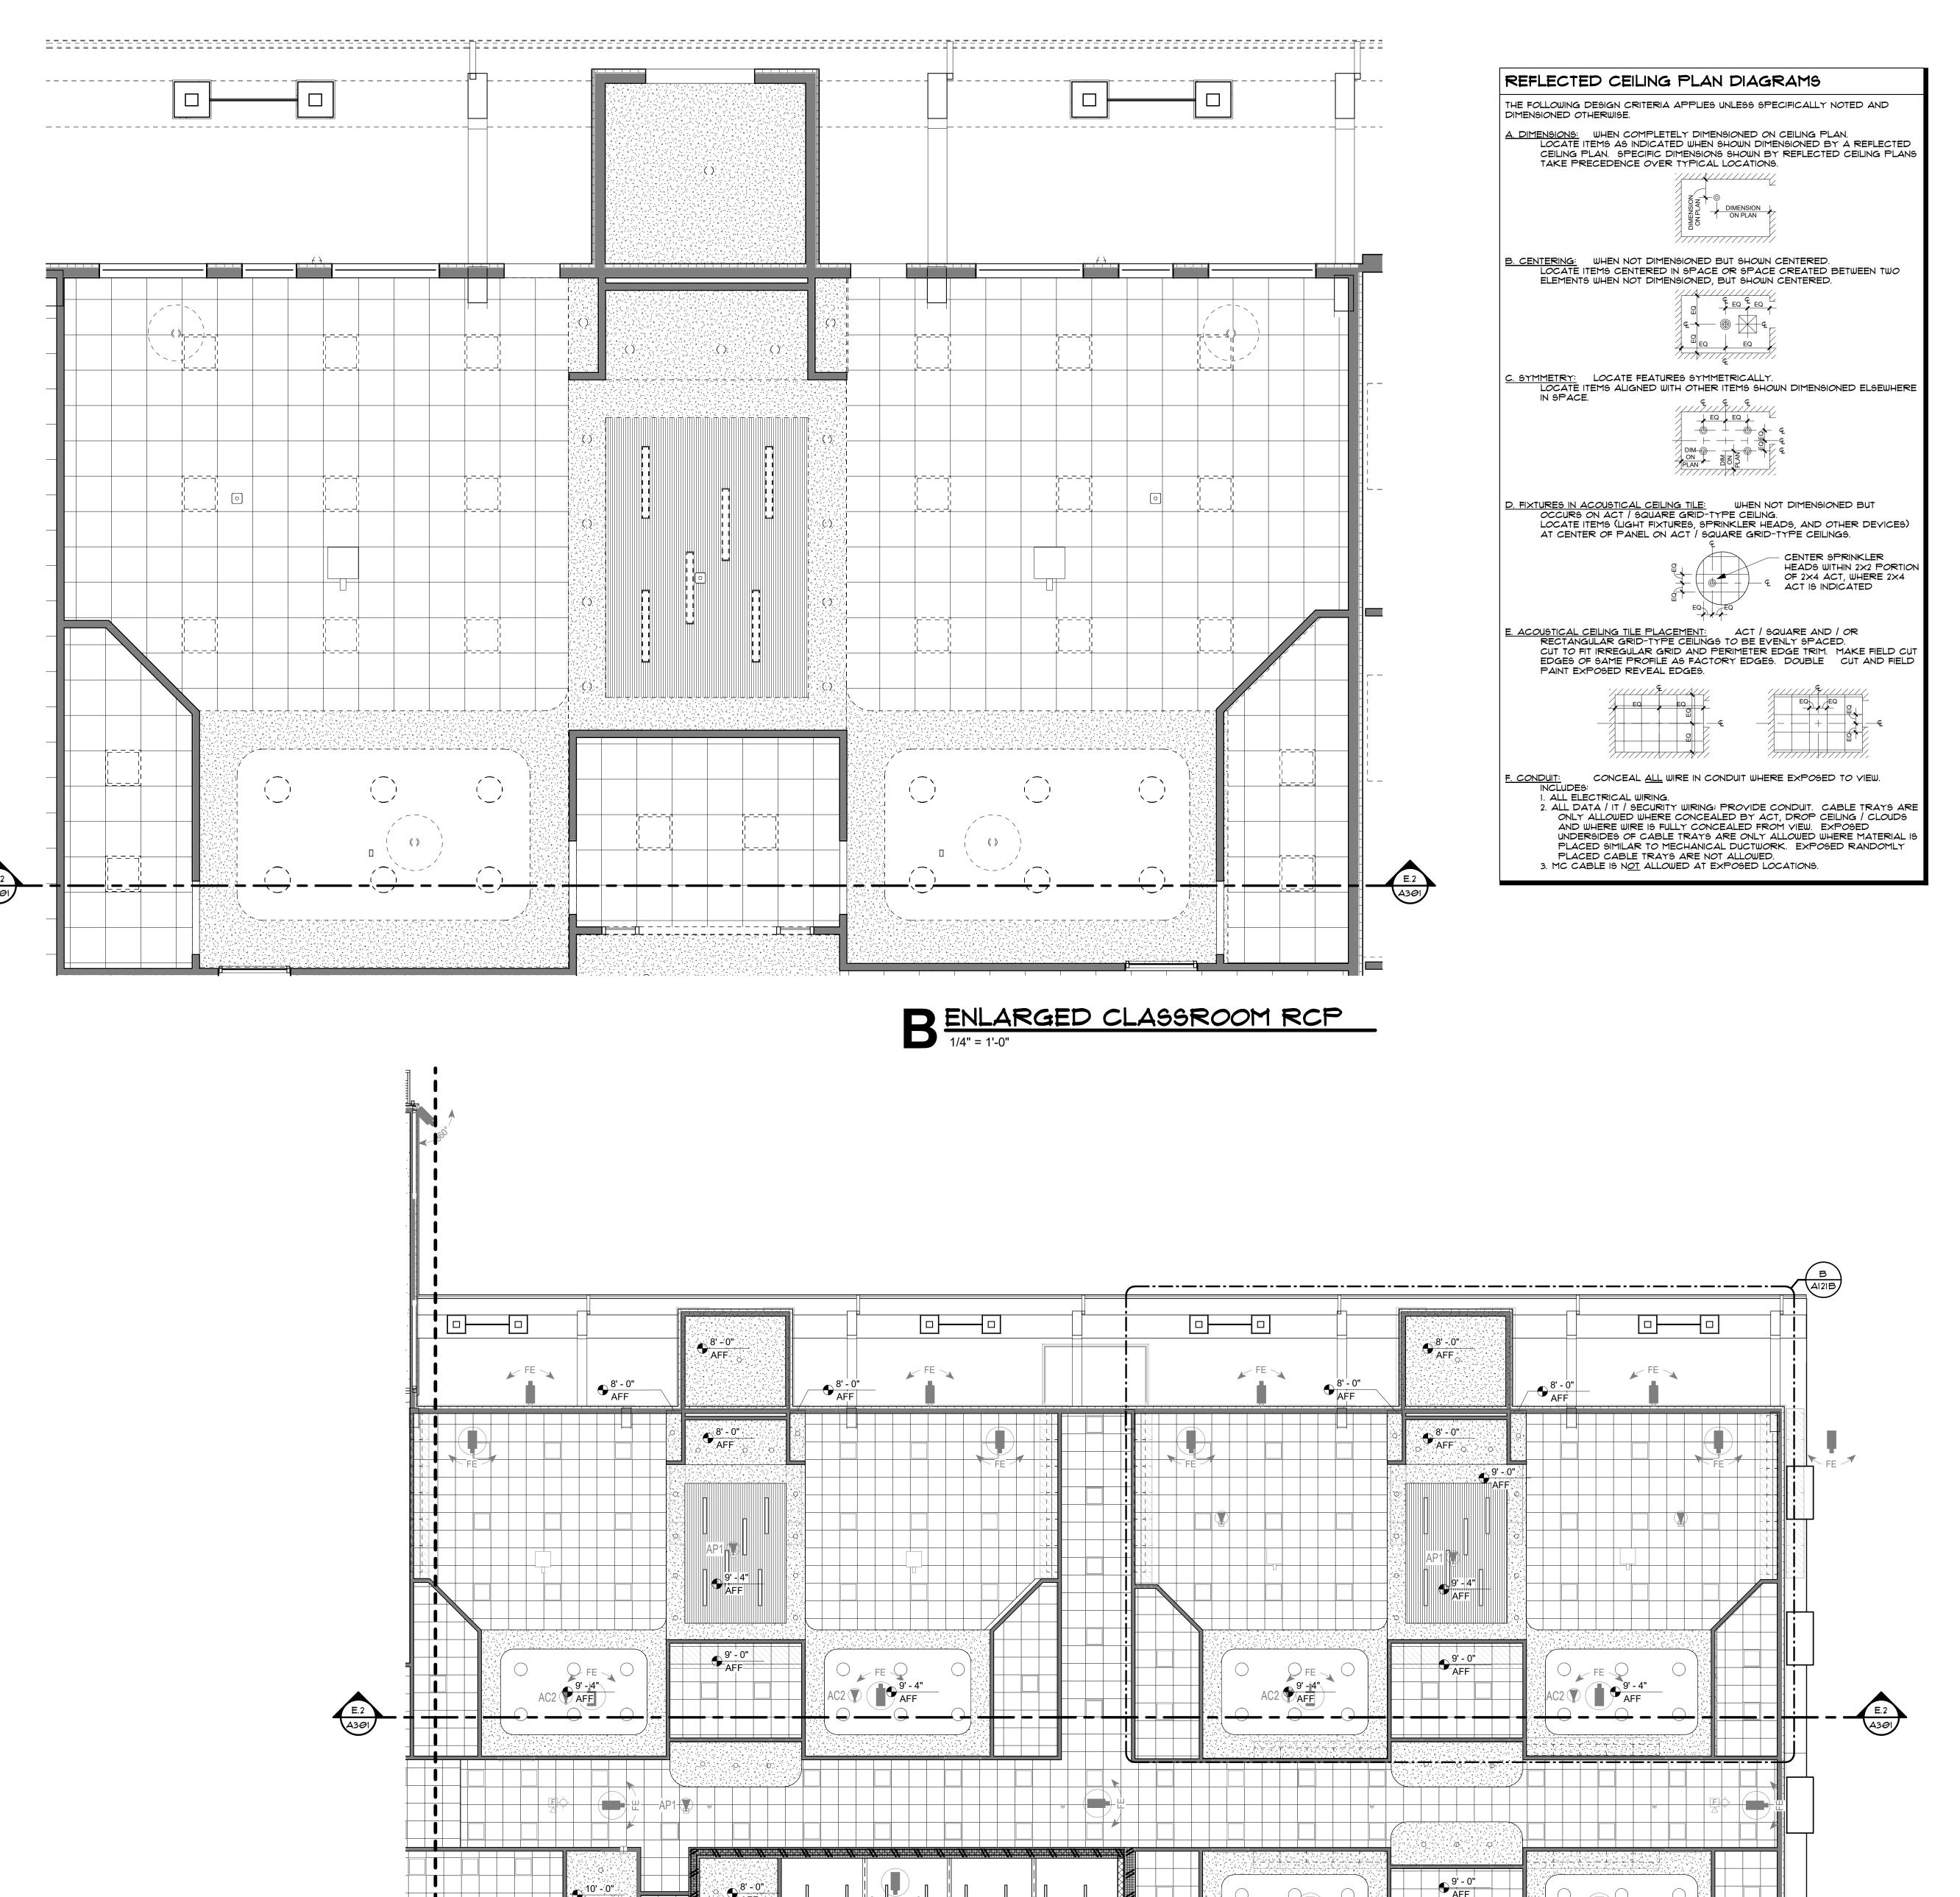PROCEEDING WITH THE WORK.

- ALL CEILINGS SHALL BE X' X" AFF, UNLESS NOTED OTHERWISE.
- ALL CEILING FINISHES TO BE ACT-1, UNLESS NOTED OTHERWISE. ALL CEILING GRIDS TO BE CENTERED IN ROOM, UNLESS NOTED OTHERWISE.
- REFER TO MECHANICAL AND ELECTRICAL DRAWINGS FOR MOUNTING LOCATIONS OF ITEMS WHERE NO CEILING IS REQUIRED OR INDICATED.
- IN THE CASE OF MINOR DISCREPANCIES BETWEEN MECHANICAL, ELECTRICAL, PLUMBING AND ARCHITECTURAL DOCUMENTS IN THE LOCATION OF CEILING MOUNTED COMPONENTS, THE ARCHITECTURAL REFLECTED CEILING PLAN SHALL GOVERN. IN THE CASE OF MAJOR DISCREPANCIES, THE ARCHITECT SHALL BE NOTIFIED AS SOON AS THE DISCREPANCY IS DISCOVERED PRIOR TO
- LIGHTS, EXIT SIGNS, SMOKE DETECTORS, SPEAKERS, DIFFUSERS, STROBES, AND MISCELLANEOUS DEVICES SHALL BE CENTERED IN THE CEILING TILE IN WHICH THEY OCCUR, UNLESS NOTED OTHERWISE.
- CENTER, ALIGN AND / OR LOCATE LIGHT FIXTURES, MECHANICAL GRILLES, LIFE SAFETY DEVICES, OCCUPANCY SENSORS, SECURITY AND DATA FIXTURES AND OTHER MISCELLANEOUS COMPONENTS IN A UNIFORM AND ORDERLY FASHION, UNLESS ALTERNATE ARRANGEMENT IS SPECIFICALLY DIMENSIONED AND NOTED.
- INSTALL TRUE AND SQUARE. IT IS THE CONTRACTOR'S RESPONSIBILITY TO COORDINATE THE FIT OF ALL WORK AND TO PROVIDE A UNIFORM AND ORDERLY PLACEMENT AND APPEARANCE, WHETHER EXPOSED TO VIEW OR CONCEALED BY FINISHES.
- ALL SPRINKLER HEADS SHALL BE ALIGNED IN THE SAME CEILING LOCATION PARALLEL TO THE WALL WITHIN EACH SPECIFIC CEILING CONSTRUCTION. CENTER EXIT SIGNS ABOVE DOORS, UNLESS ALTERNATE ARRANGEMENT IS SPECIFICALLY DIMENSIONED AND NOTED. 10. CENTER, ALIGN AND LOCATE ACCESS PANELS IN ACCORDANCE WITH DESIGN
- PROVIDE GYPSUM BOARD BULKHEADS WHERE CEILINGS OF DIFFERENT HEIGHTS OR ORIENTATION ABUT. DO NOT BUILD BULKHEADS OF ACOUSTICAL CEILING MATERIAL.
- ALIGN ALL SOFFITS AND / OR BULKHEADS WITH ADJACENT WALLS, UNLESS

CRITERIA FOR OTHER DEVICES. SUBMIT SHOP DRAWINGS THAT INDICATE

EXACT SIZE, TYPE AND LOCATION OF CEILING AND WALL ACCESS PANELS FOR REVIEW AND ACCEPTANCE BEFORE INSTALLATION. ALL ACCESS PANELS SHALL BE PAINTED, UNLESS NOTED OTHERWISE AND EXTERIOR GRADE WHERE

- NOTED OTHERWISE. PROVIDE SUFFICIENT SUPPORT AND GRID SYSTEMS TO SUPPORT ALL CEILING MOUNTED DEVICES. ALL FIXTURES SHALL BE SUPPORTED AT EACH CORNER.
- ALL OUTLETS, RECEPTACLES, DEVICES AND COVER PLATES SHALL BE INSTALLED PLUMB AND LEVEL. CROOKED INSTALLATION IS NOT ALLOWED. MISALIGNED MEP FIXTURES OF ANY TYPE OR AT ANY LOCATION EXPOSED TO VIEW ARE NOT ALLOWED. MISALIGNED FIXTURES SHALL BE ADJUSTED OR
- REMOVED AND REPLACED IF REQUIRED FOR PROPER ALIGNMENT AT NO ADDITIONAL COST. . ALL RECESSED LIGHTING TO BE SEALED AIR-TIGHT, ICC-RATED AND SEALED TO GYPSUM BOARD OR FINISH MATERIAL AS REQUIRED BY THE IECC (INTERNATIONAL ENERGY CONSERVATION CODE). ALL MECHANICAL,
- ELECTRICAL AND PLUMBING FIXTURES SHALL BE IECC COMPLIANT. CONTRACTOR TO COORDINATE ALL OUTLETS, SWITCHES AND POWER FEED WITH CASEWORK, PARTITIONS, FINISHES, FIXTURES AND EQUIPMENT. B. SPRINKLER HEAD TYPES AND FINISHES:
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 PRE-FINISHED METAL CEILING OR WALL FEATURES: FULLY RECESSED AND
 CONCEALED WITH COVER PLATE, FLAT AND FLUSH TO MATCH ADJACENT FINISH, CUSTOM COLOR MAY BE REQUIRED IF MANUFACTURER'S RANGE

DOES NOT PROVIDE MATCH, IN THE OPINION OF THE ARCHITECT.

- D. PROVIDE SPRINKLER GUARDS WHERE REQUIRED BY CODE. 9. PROVIDE 9PRINKLER HEADS AND COVERS IN ACCORDANCE WITH SPECIFIED LEVEL OF EXPOSURE (TO VIEW), DESIGN CRITERIA AND AS INDICATED. PROVIDE BRAIDED METAL FLEXIBLE SPRINKLER DROPS AT ALL FINISHED CEILINGS OR WHERE REQUIRED FOR SPECIFIED PLACEMENT. CENTER AND ALIGN PIPES WITH ARCHITECTURAL FEATURES. PROVIDE ADDITIONAL HEADS BEYOND THAT REQUIRED FOR MINIMUM COVERAGE AS REQUIRED TO COMPLY WITH ARCHITECTURAL LAYOUT, AND UNIFORM ALIGNMENT WITH OTHER FIXTURES. SUBMIT LAYOUT FOR REVIEW PRIOR TO AHJ REVIEW OR INSTALLATION.
- 20. PROVIDE PRE-FINISHED GRAY ELECTRICAL DEVICES AND STAINLESS STEEL COVER PLATES AT ALL WALLS IN PROJECT. AT ALL OTHER LOCATIONS, SUCH AS CASEWORK, RECEPTACLES AND COVER PLATES SHALL MATCH ADJACENT FINISHES, AS DETERMINED AND SELECTED BY THE ARCHITECT FROM MANUFACTURER'S FULL RANGE. FIELD PAINT WHERE REQUIRED.
- MAINTAIN CONTINUOUS FIRE RATED ENCLOSURES AS REQUIRED AT RATED WALLS AND CEILINGS. PROVIDE FIRE RATED FIXTURE COVERS, J-BOXES OR CONSTRUCT GYPSUM BOARD ENCLOSURES WHERE REQUIRED FOR FIXTURE OR MEP RUNS TO MAINTAIN CONTINUOUS FIRE RATING. REFER TO MECHANICAL DRAWINGS FOR ADDITIONAL INFORMATION FOR

DIFFUSERS AND GRILLE TYPES. REFER TO ELECTRICAL DRAWINGS FOR

- FIXTURE SCHEDULES AND ADDITIONAL INFORMATION. DESIGN INTENT FOR APPEARANCE, TYPE, ARRANGEMENT AND LOCATION IS INDICATED ON ARCHITECTURAL DRAWINGS. REPORT DISCREPANCIES TO ARCHITECT FOR CLARIFICATION PRIOR TO ORDERING MATERIALS OR THE START OF ROUGH-IN 23. LIFE SAFETY DEVICE COLORS: GRAY (UNLESS RED IS SPECIFICALLY REQUIRED A. WHITE, AT WHITE CEILINGS OR WHERE EXPOSED STRUCTURES. B. OTHER CEILINGS: NOT ALLOWED, USE WALL MOUNTED.
- 4. EXPOSED METAL DUCTWORK: ALL METAL DUCTWORK EXPOSED TO VIEW SHALL HAYE UNIFORM AND NEAT SEALANT AND SEAMS, CLEAN EXCESS SEALANT. PROVIDE 12 FOOT BY 12 FOOT MOCK-UP TO ILLUSTRATE ALL SEAMS AND SEALANT TYPES IN PROJECT.

C. INTERIOR / EXTERIOR WALLS: GRAY.

- 25. EXPOSED STRUCTURE: WHEN NOT DIMENSIONED, BUT OCCURS ON OR ADJACENT TO EXPOSED STRUCTURE. LOCATE ITEMS (LIGHT FIXTURES, SPRINKLER PIPING / HEADS, MECHANICAL DUCTS, PIPES, PLUMBING, DEVICES, AND ALL ASSOCIATED MOUNTING BRACKETS AND FASTENERS) CENTERED WITHIN SPACE BETWEEN OR ON STRUCTURAL ELEMENTS. MATCH ORIENTATION OF STRUCTURE, UNLESS A SPECIFIC ALTERNATE ARRAIGNMENT IS DIMENSIONED AND NOTED. CHANGE ORIENTATION OF ITEMS, IN ACCORDANCE WITH DESIGN CRITERIA FOR PLACEMENT, TO MATCH CHANGES IN ORIENTATION OF STRUCTURE. WHERE MULTIPLE SYSTEMS NEED TO SHARE THE SAME SPACE, CENTER ONE SYSTEM AND ALIGN ADJACENT SYSTEMS IN A UNIFORM AND ORDERLY FASHION.
- 26. COORDINATION: ALL DEVICES REQUIRED FOR PROJECT MAY NOT BE SHOWN ON ARCHITECTURAL DRAWINGS. REFER TO MECHANICAL, ELECTRICAL, PLUMBING AND TECHNOLOGY DRAWINGS FOR ADDITIONAL DEVICES. A DEVICES IN PROJECT SHALL FOLLOW DESIGN CRITERIA FOR PLACEMENT, AS INDICATED, WHETHER OR NOT SHOWN ON ARCHITECTURAL DRAWINGS. REPORT DISCREPANCIES TO ARCHITECT FOR CLARIFICATION PRIOR TO INSTALLATION.
- COORDINATION DRAWINGS PROVIDE THE FOLLOWING: PREPARE COORDINATION DRAWINGS TO A SCALE OF 1/4 INCH = 1'-0" OR LARGER, DETAILING MAJOR ELEMENTS, COMPONENTS, AND SYSTEMS OF FIRE PROTECTION EQUIPMENT AND MATERIALS IN RELATIONSHIP WITH OTHER SYSTEMS, INSTALLATIONS, AND BUILDING COMPONENTS. INDICATE LOCATIONS WHERE SPACE IS LIMITED FOR INSTALLATION AND ACCESS AND WHERE SEQUENCING AND COORDINATION OF INSTALLATION ARE IMPORTANT TO THE EFFICIENT FLOW OF THE WORK, INCLUDING, BUT NOT NECESSARILY LIMITED TO
- A. INDICATE THE PROPOSED LOCATIONS OF PIPING, EQUIPMENT, HANGERS, HEAD TYPES AND LOCATIONS, AND MATERIALS. B. CLEARANCES FOR INSTALLING AND MAINTAINING INSULATION.

REFLECTED CEILING PLAN LEGEND SUPPLY DIFFUSER 2×4 LAY IN LENS EXHAUST FAN SMOKE DETECTOR - CEILING HEIGHT RECESSED CAN LIGHT ØS DIRECTIONAL SPOT LIGHT ALIGN ALIGN FINISHED SURFACES SURFACE MOUNTED STRIP LIGHT TRACK LIGHT COTS OPEN TO STRUCTURE SPEAKER (PROVIDED BY OWNER) C J CONTROL JOINT 2×4 ACOUSTIC CEILING TILE (ACT) WAP) WIRELESS ACCESS POINT, CEILING MOUNTED SPECIAL CEILING TILES DATA, CEILING MOUNTED FK FIRE ALARM, HORN AND STROBE

VIDEO CAMERA

--- COYE LIGHTING

NOTE: REFER TO STRUCTURAL, ELECTRICAL AND MECHANICAL DRAWINGS FOR



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80 A Native American Owned Firm BLUE RIVER PROJECT NUMBER: 20230011 ISSUE DATE: **TBD** ISSUE: CM PACKAGE OTHER ISSUE DATES: NO. DESCRIPTION

SHEET NAME: REFLECTED **CEILING PLAN -**AREA B

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-ALL DECK AND ITS STRUCTURE WITHIN THE TORNADO SHELTER SHALL BE PAINTED PT-II 2-HOUR RATED INTUMESCENT FRIEPROOF COATING SYSTEM, UL ASSEMBLY D601. SYSTEM TO BE CONTINUOUS ABOVE ALL OTHER CEILING SYSTEMS AND INTERIOR PARTITIONS. PROVIDE FIRE SEALANT AT ALL JOINTS BETWEEN WALL AND DECK

EXTERIOR MATERIAL LEGEND

ROOFING SYSTEM

(SSR-1) STANDING SEAM METAL ROOF SYSTEM

MR-I) SINGLE-PLY ROOFING MEMBRANE SYSTEM

MANUFACTURED STONE MASONRY VENEER - ST ST-I MANUFACTURED STONE MASONRY VENEER

ST-2 CAST STONE CAP

DRAINABLE EXTERIOR INSULATED FINISH SYSTEM - EIFS EIFS-I) DRAINABLE EXTERIOR INSULATION FINISH SYSTEM, FINAL COLOR TO BE SELECTED BY OWNERS/ARCITECT

FROM MANUFACTURER'S STANDARD RANGE EIFS-2 DRAINABLE EXTERIOR INSULATION FINISH SYSTEM, FINAL COLOR TO BE SELECTED BY OWNERS/ARCITECT FROM MANUFACTURER'S STANDARD RANGE

DRAINABLE EXTERIOR INSULATION FINISH SYSTEM, FINAL COLOR TO BE SELECTED BY OWNERS/ARCITECT FROM MANUFACTURER'S STANDARD RANGE

PRE-FINISHED GUTTER AND DOWNSPOUT - GD GD-I PRE-FINSIHED GUTTER AND DOWNSPOUT, REFER TO CIVIL FOR TIE IN LOCATIONS

EXTERIOR STRUCTURE PAINT - PT

6P-1 EXTERIOR PAINT, BASIS OF DESIGN: THEMEC SERIES APPROPRIATE FOR APPLICATION, COLOR: XXX

EXTERIOR CLADDING - EC EC-1 EXTERIOR CLADDING, BASIS OF DESIGN: XXX COLOR: XXX

OTHER ITEMS

GLAZING SYSTEM, REFER TO A621 FOR MORE INFORMATION

(1 LIGHTING, REFER TO ELECTRICAL LOUVER, REFER TO MECHANICAL

√3 WALL VENT, REFER TO PLUMBING

PREFINISHED METAL DOWNSPOUT, SIZED PER SMACNA GUIDELINES, REFER TO CIVIL FOR TIE IN LOCATIONS

R J REVEAL JOINT C SECURITY CAMERA

EXTERIOR ELEVATION GENERAL NOTES

REFER TO SHEET A621 FOR WINDOW TYPES.

REFER TO SHEET A6XX FOR DOOR SCHEDULE. REFER TO A300 SERIES SHEETS FOR EXTERIOR WALL SECTIONS.

4. ALL EXTERIOR DIMENSIONS ARE FROM FACE OF EXTERIOR FINISH, UNLESS NOTED OTHERWISE.

5. MASONRY DIMENSIONS ARE NOMINAL, UNLESS NOTED OTHERWISE. REFER TO CIVIL DRAWINGS FOR FINISH GRADE ELEVATIONS.

 DETAILS ON EXTERIOR ELEVATIONS ARE GENERAL IN NATURE AND FOR ILLUSTRATIVE PURPOSES ONLY. REFER TO WALL DETAILS AND SECTIONS FOR DETAILED INFORMATION CONCERNING EXTERIOR CONSTRUCTION. REFER TO ELECTRICAL FOR ADDITIONAL INFORMATION AT EXTERIOR LIGHTING.

. PROVIDE CONTROL JOINTS PER MANUFACTURER'S SPECIFICATIONS. 10. PROVIDE WATERTIGHT SEAL AT ALL SIGNAGE ATTACHMENT AND POWER FEED

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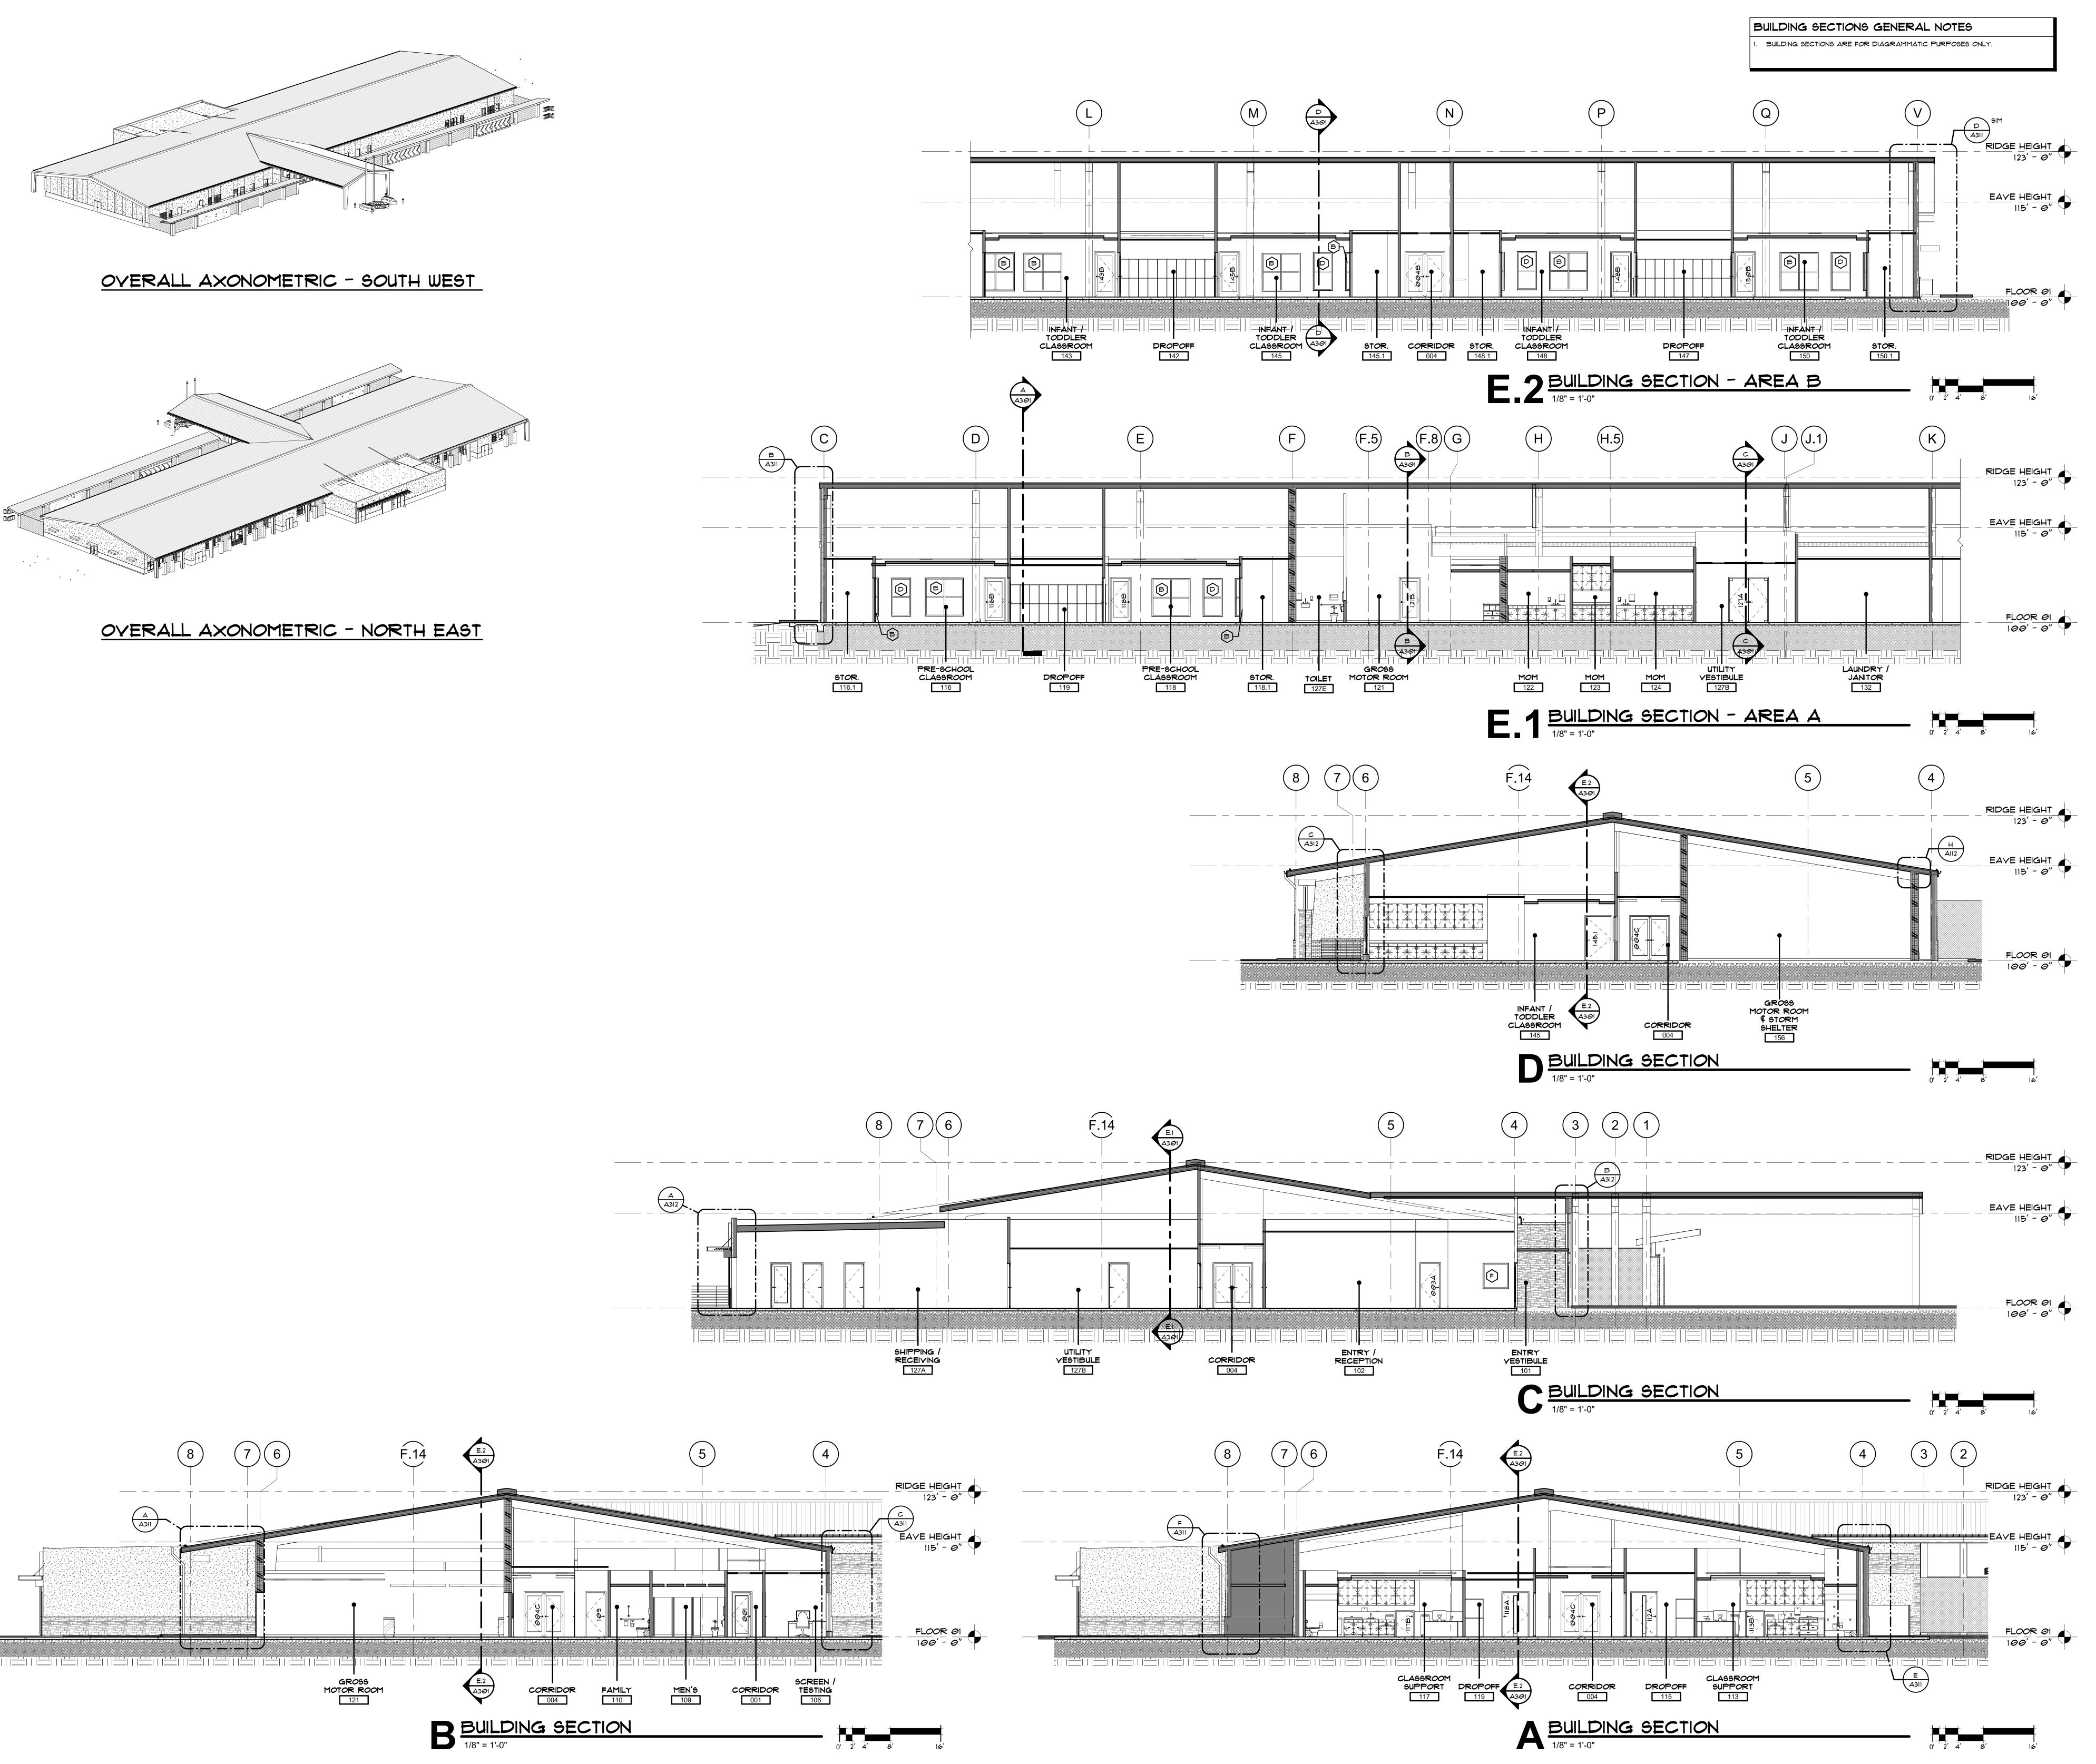
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DOLY

STANDARD

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CM PACKAGE

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NO. DESCRIPTION

SHEET NAME:
BUILDING
SECTIONS

SHEET NUMBER:

A301
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