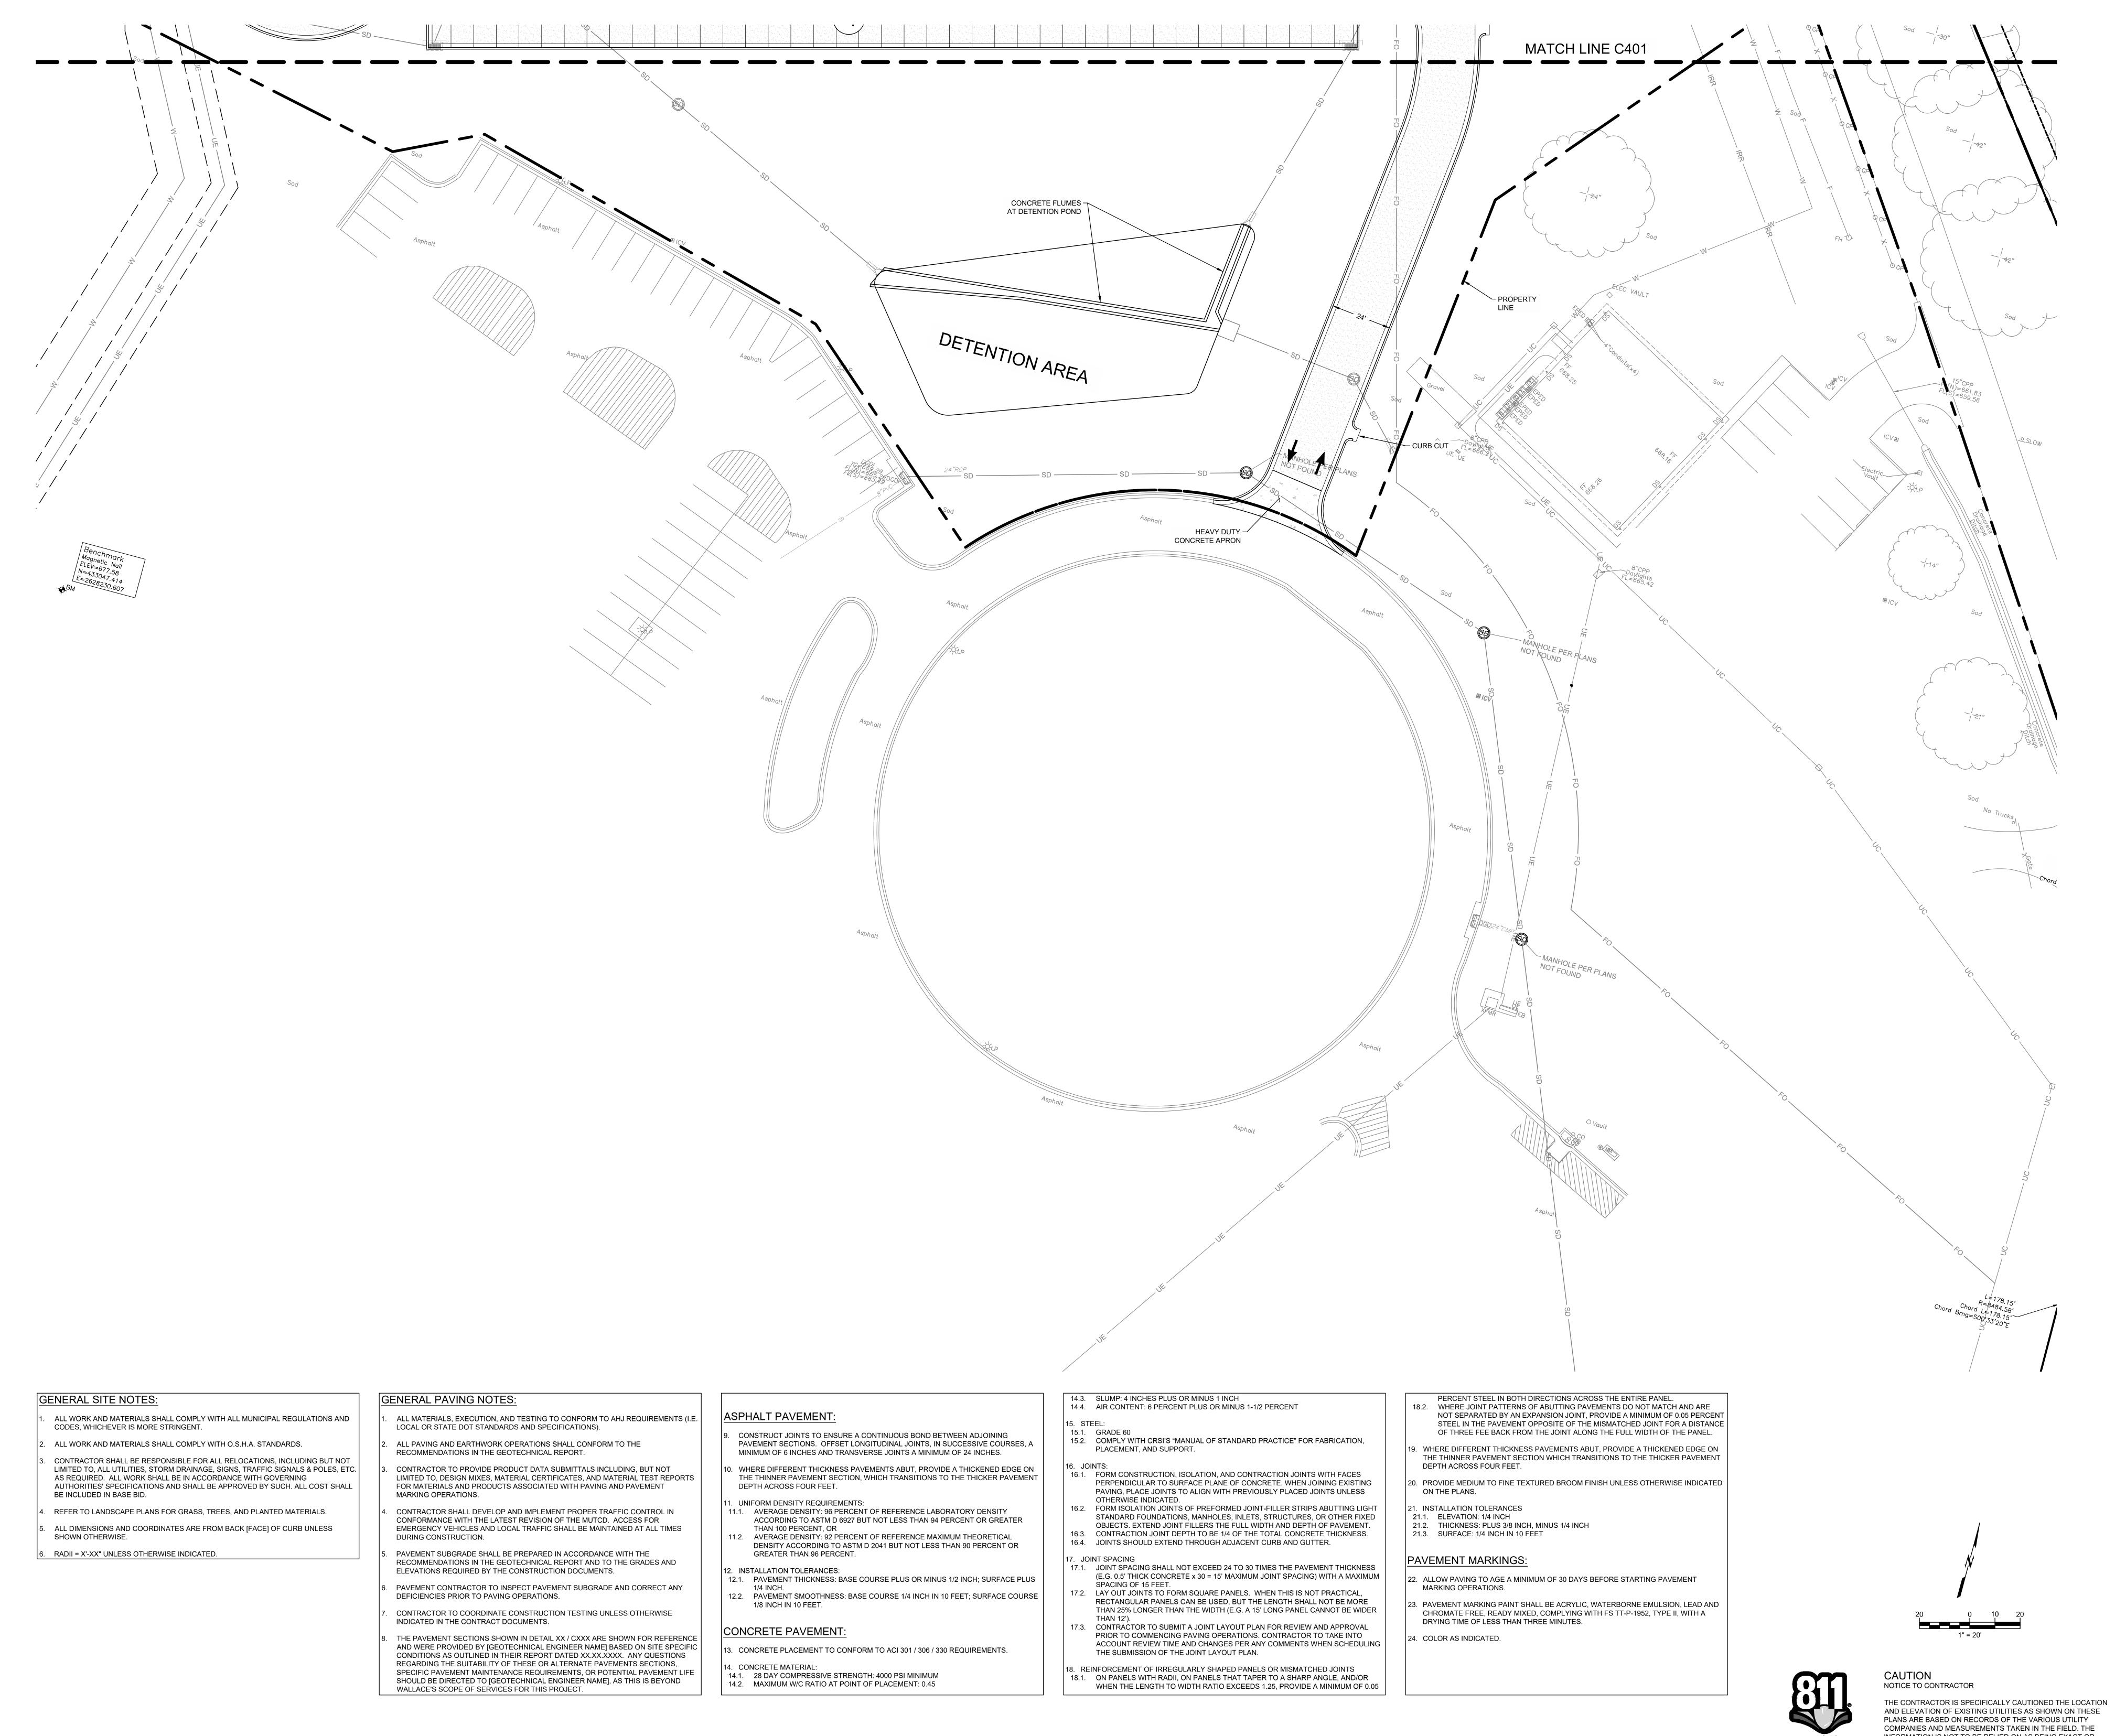
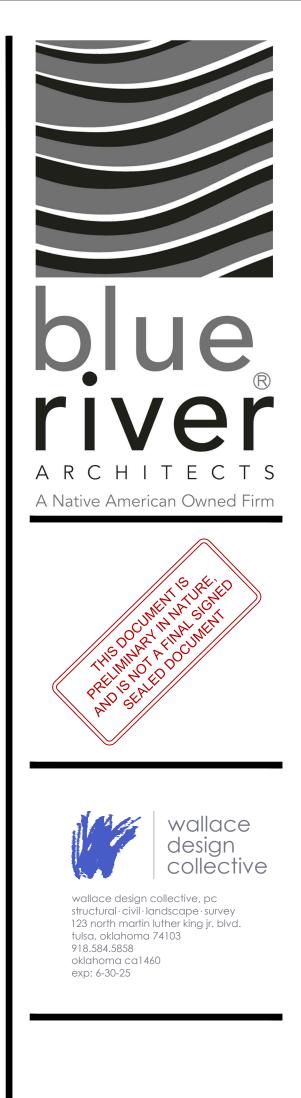


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18. REI	NFORCEMENT

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TO REQUEST EXACT FIELD LOCATIONS OF THE UTILITIES.





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BLUE RIVER PROJECT NUMBER: 20230011 ISSUE DATE: 03/14/2024 ISSUE: CM PACKAGE

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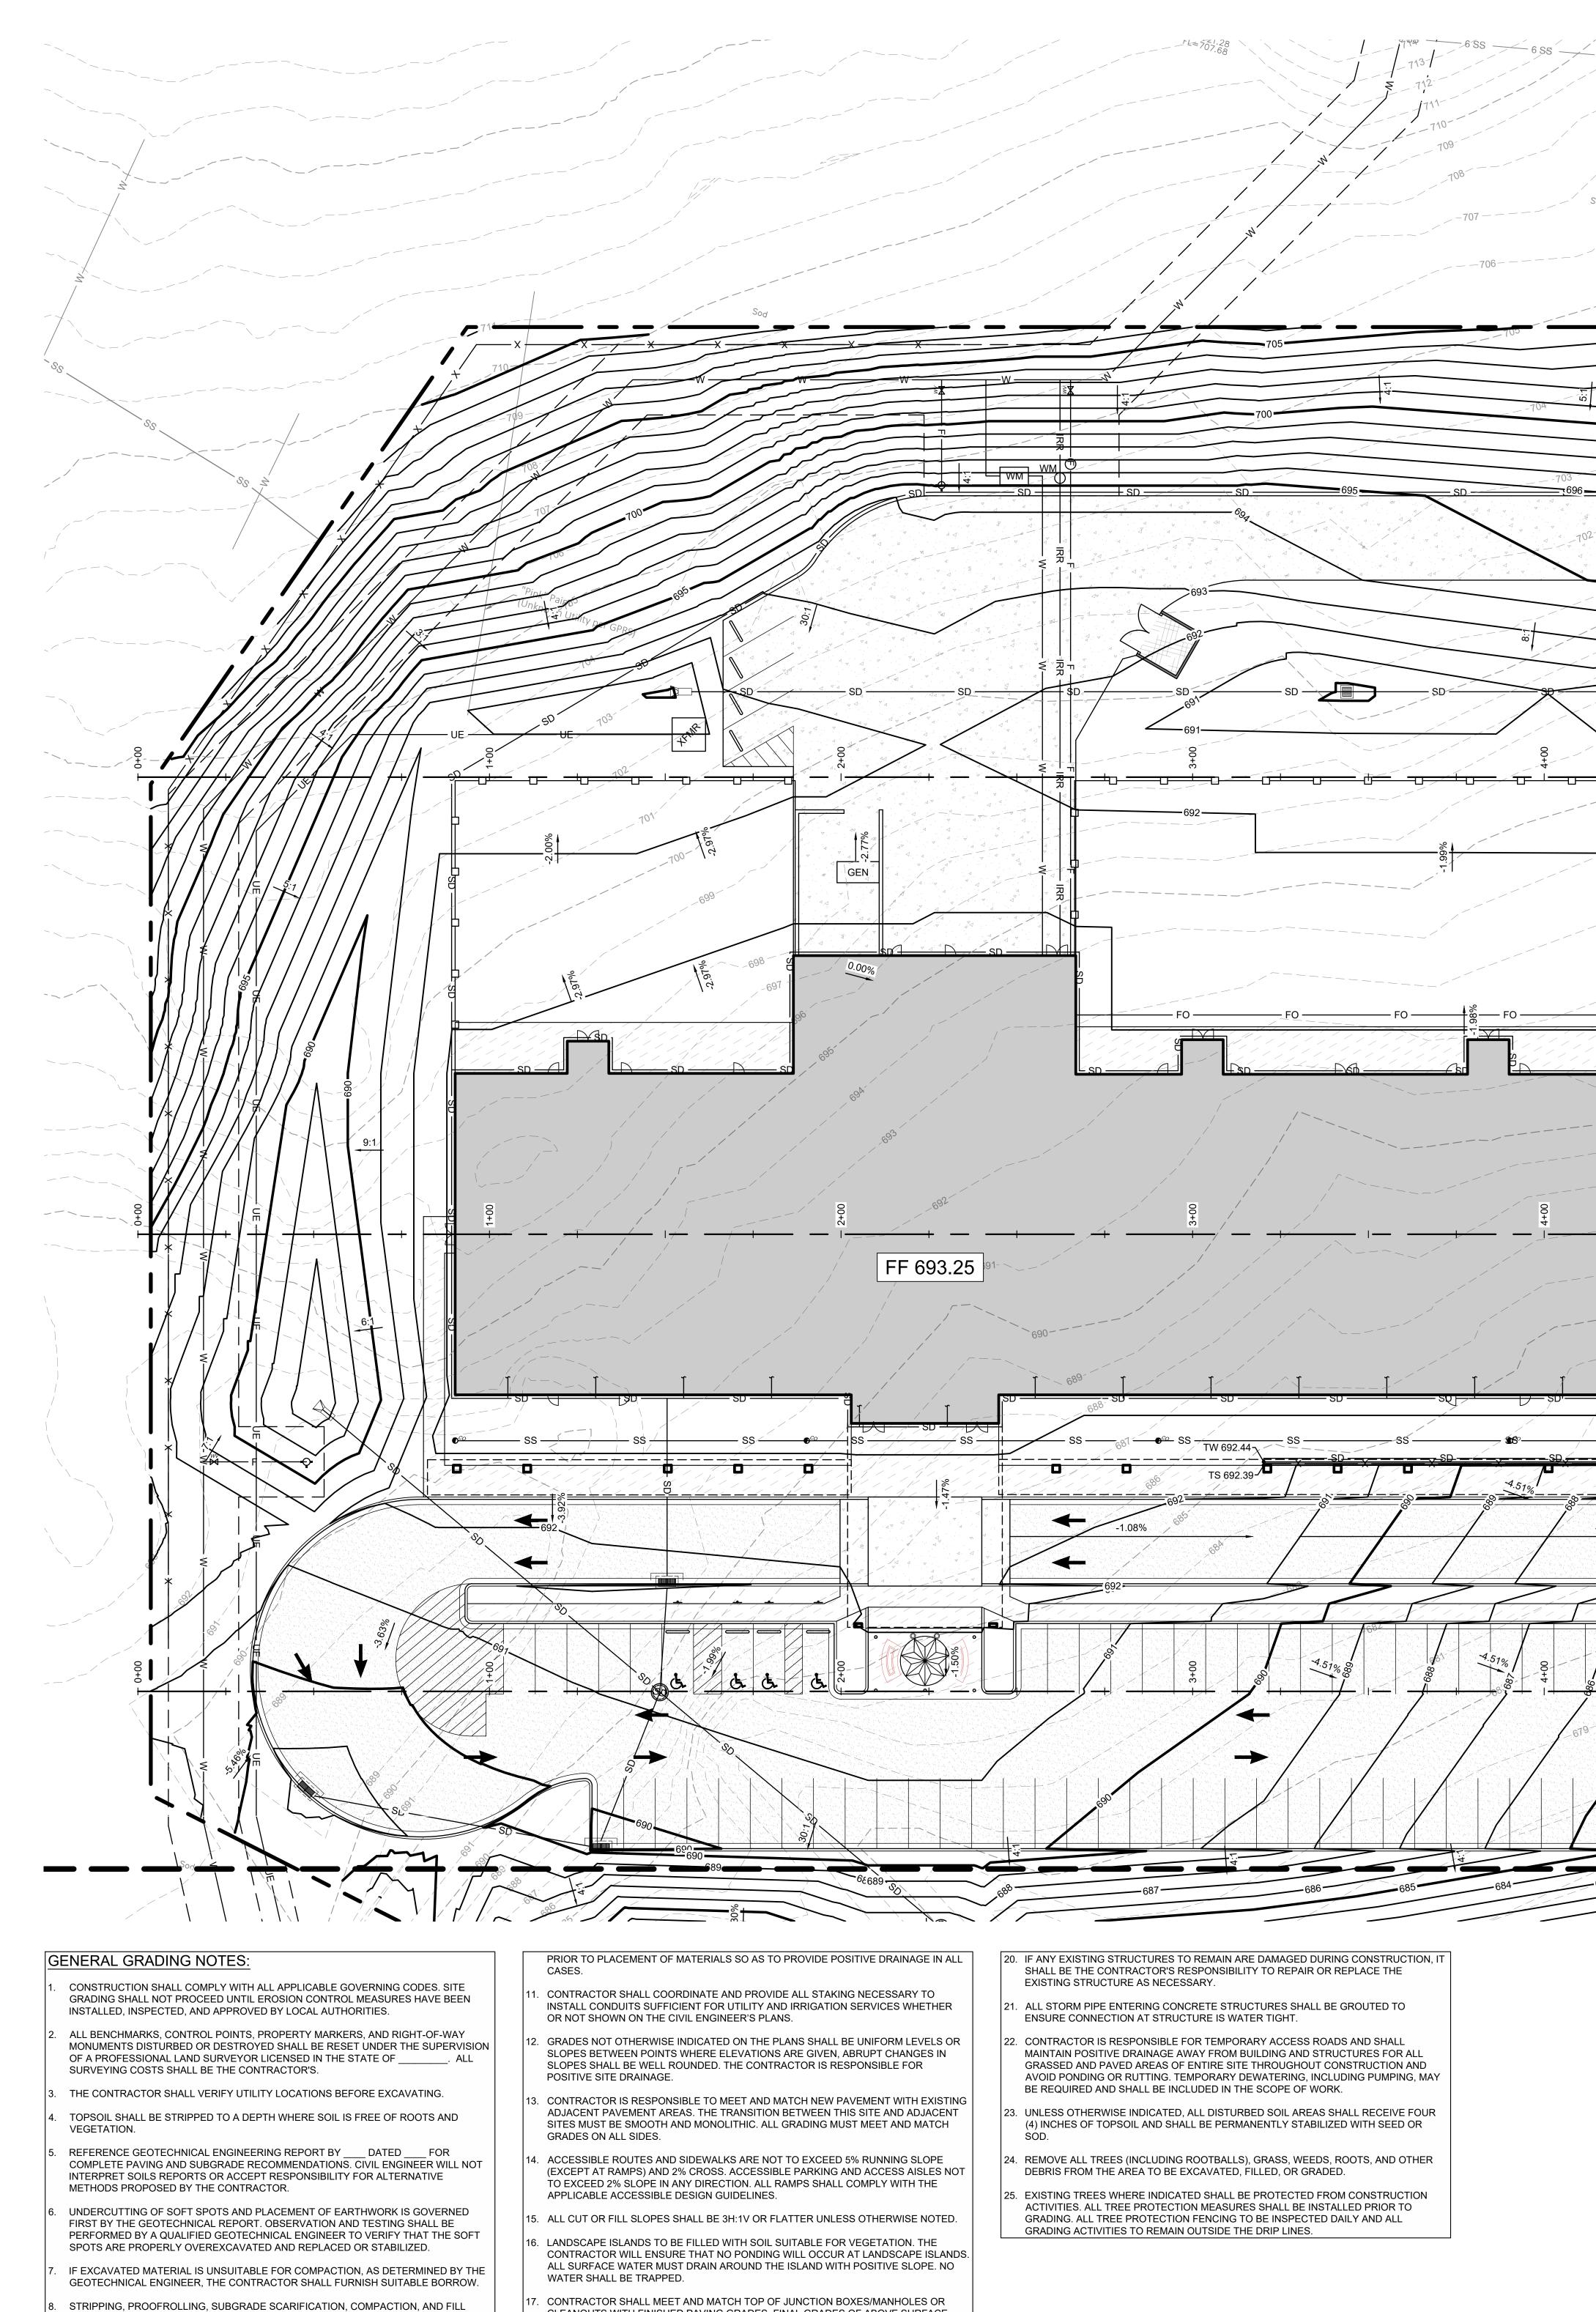
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INFORMATION IS NOT TO BE RELIED ON AS BEING EXACT OR COMPLETE. THE CONTRACTOR MUST CALL THE LOCAL UTILITY Call before you dig. LOCATION CENTER AT LEAST 72 HOURS BEFORE ANY EXCAVATION TO REQUEST EXACT FIELD LOCATIONS OF THE UTILITIES.



CONSTRUCTION IN THE BUILDING AND PAVING AREAS SHALL BE PERFORMED ACCORDING TO THE GEOTECHNICAL REPORT. EMBANKMENT BENEATH BUILDING PADS OR FOR PAVING SUBGRADE SHALL BE PLACED IN LIFTS NOT EXCEEDING EIGHT (8) INCHES AND COMPACTED TO A MINIMUM OF 98% AND 95% STANDARD PROCTOR DENSITY, RESPECTIVELY, AT OPTIMUM MOISTURE CONTENT UNLESS OTHERWISE SPECIFIED THEREIN. CONTRACTOR SHALL PROVIDE WATER AS REQUIRED TO OBTAIN SPECIFIED COMPACTION.

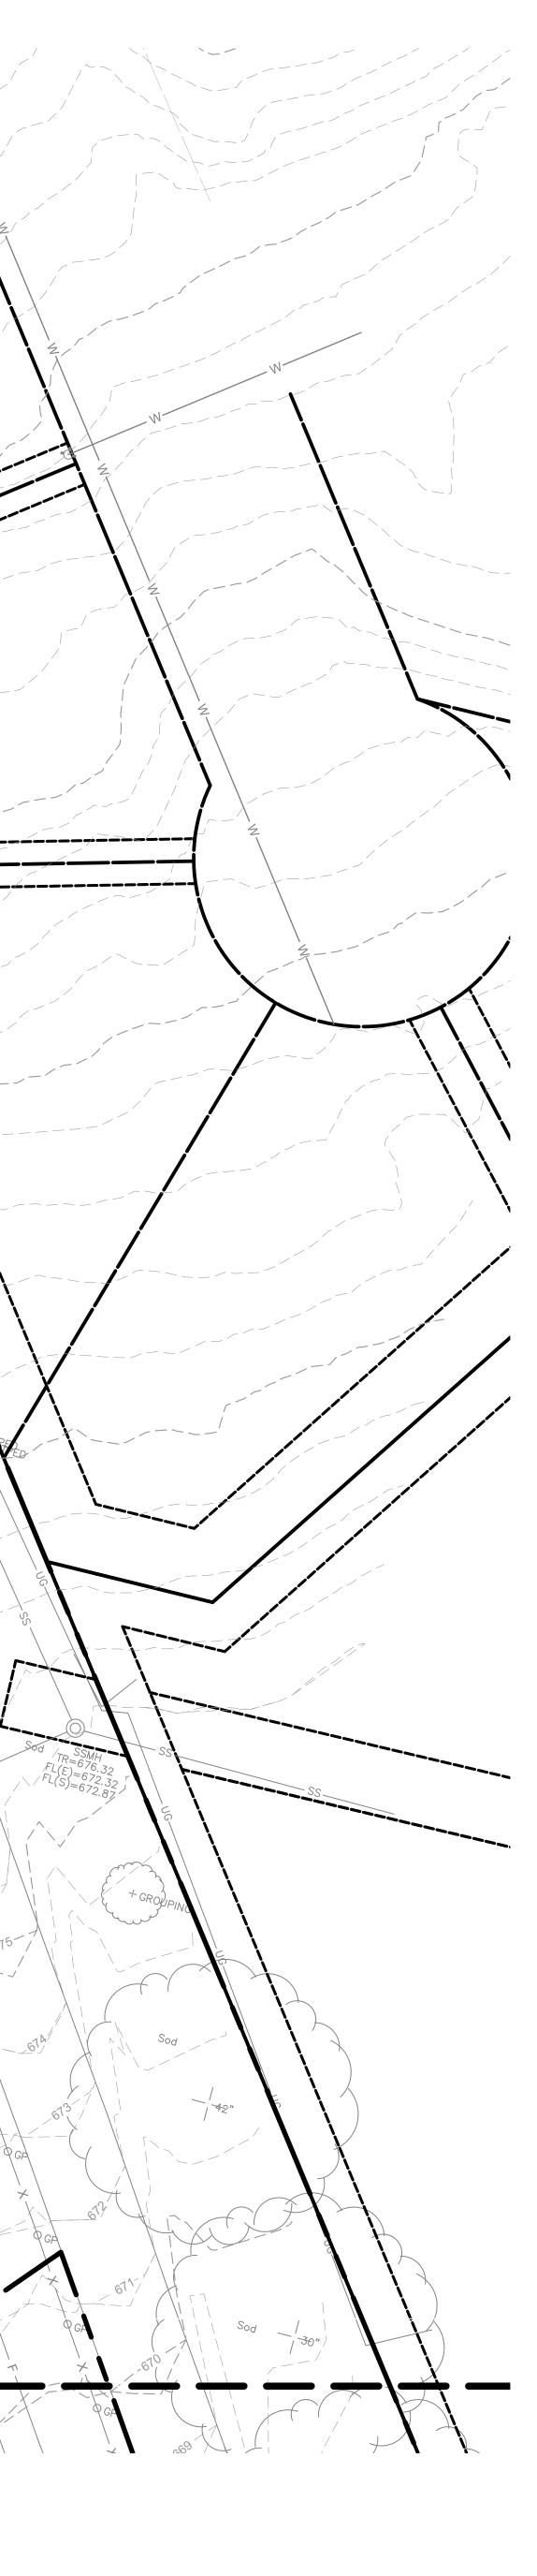
EXCAVATE TO INDICATED ELEVATIONS AND DIMENSIONS WITHIN A TOLERANCE OF PLUS OR MINUS 1 INCH. IF APPLICABLE, EXTEND EXCAVATIONS A SUFFICIENT DISTANCE FROM STRUCTURES FOR PLACING AND REMOVING CONCRETE FORMWORK, FOR INSTALLING SERVICES AND OTHER CONSTRUCTION, AND FOR INSPECTIONS. . PAVING CONTRACTOR IS RESPONSIBLE TO REVIEW ALL FIELD ESTABLISHED GRADES

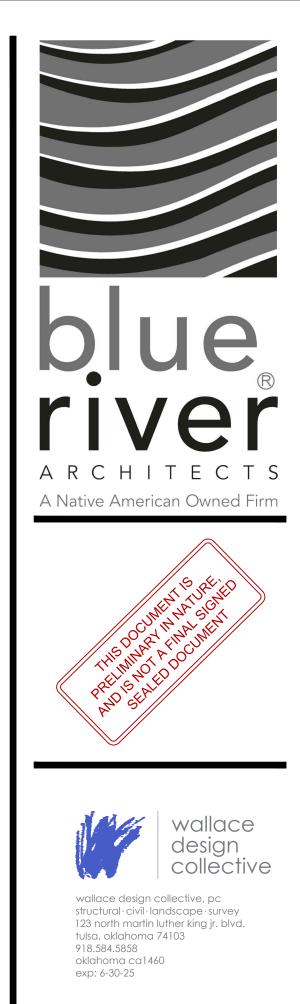
- CLEANOUTS WITH FINISHED PAVING GRADES. FINAL GRADES OF ABOVE SURFACE UTILITIES NOT IN PAVED AREAS, INCLUDING BUT NOT LIMITED TO JUNCTION BOX/MANHOLE LIDS, WATER METER LIDS, AND SEWER CLEANOUTS, ARE TO BE ADJUSTED BY THE UTILITY CONTRACTOR TO CONFORM TO LANDSCAPING SOD INSTALLATIONS.
- COMPLETION OF THE PROJECT.

- 8. CONTRACTOR SHALL REFER TO ARCHITECTURAL AND MEP PLANS FOR THE EXACT LOCATIONS AND DIMENSIONS OF ENTRY, EXIT PORCHES, PRECISE BUILDING DIMENSIONS, EXACT BUILDING UTILITY ENTRANCE LOCATIONS, AND DOWNSPOUTS. 19. EXISTING DRAINAGE STRUCTURES TO BE INSPECTED AND REPAIRED AS NEEDED. EXISTING PIPES ARE TO BE CLEANED OUT TO REMOVE ALL SILT AND DEBRIS AT THE

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BLUE RIVER PROJECT NUMBER:		
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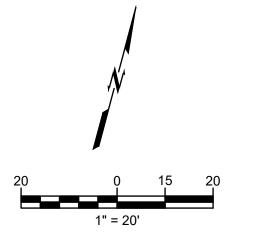
OTHER ISSUE DATES:

NO. DESCRIPTION

DATE

SHEET NAME: **GRADING PLAN** -NORTH

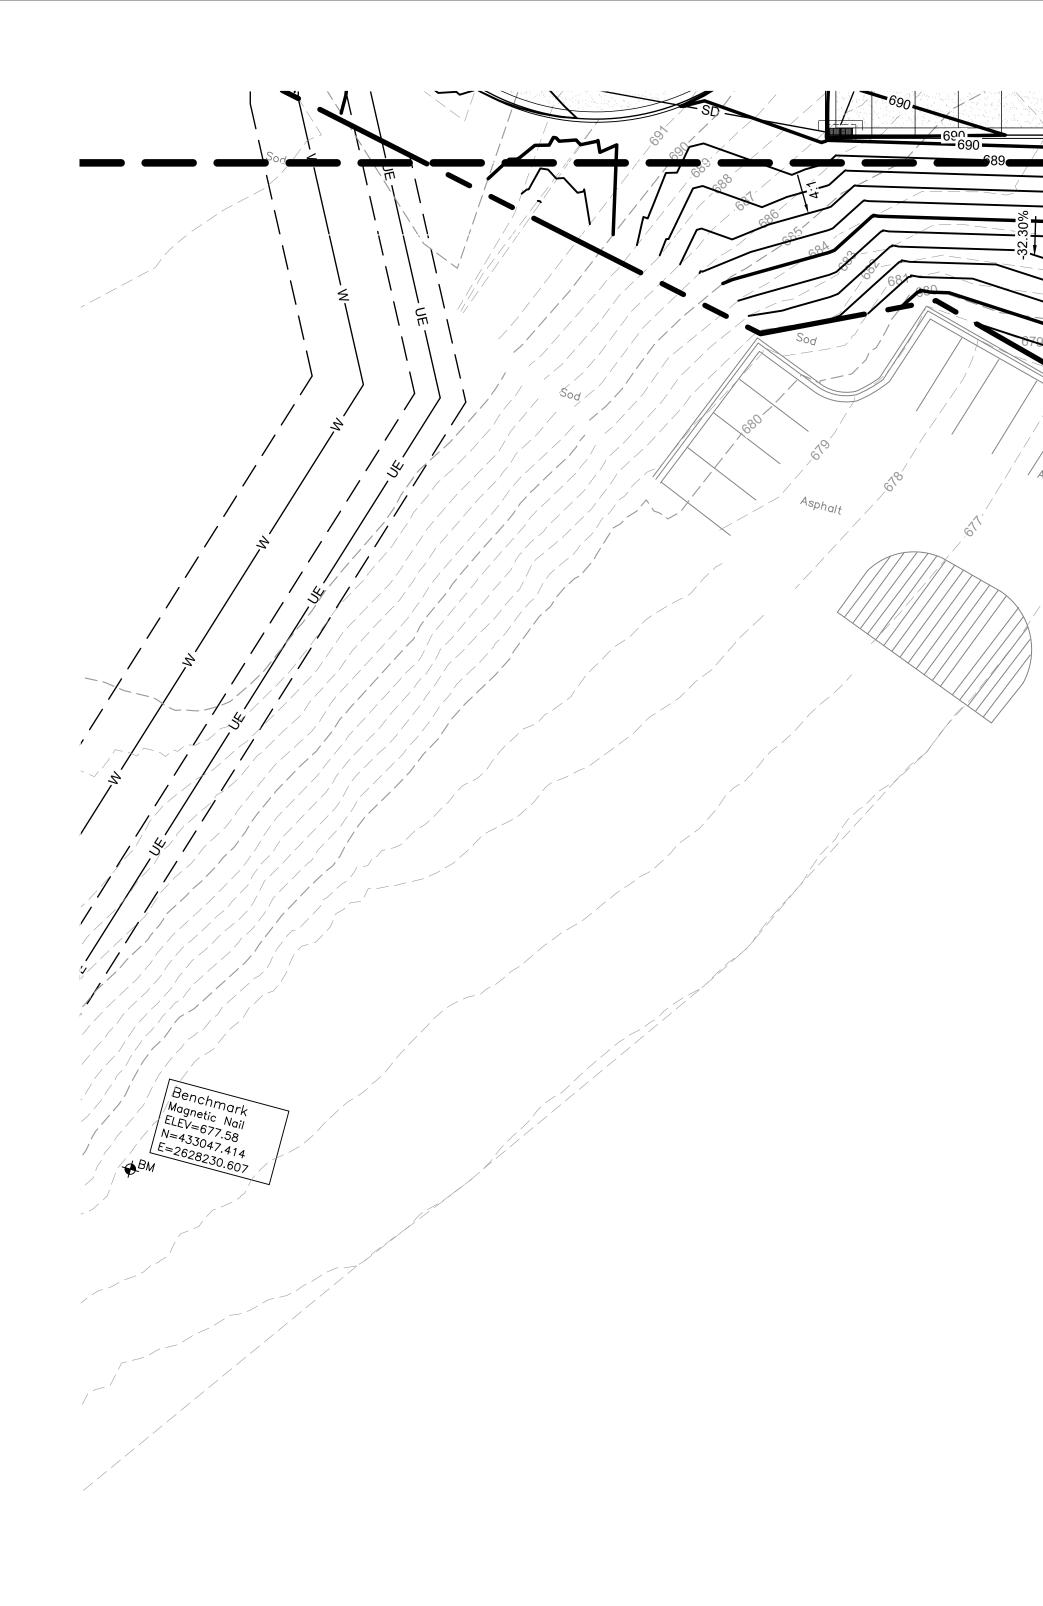




CAUTION



NOTICE TO CONTRACTOR THE CONTRACTOR IS SPECIFICALLY CAUTIONED THE LOCATION AND ELEVATION OF EXISTING UTILITIES AS SHOWN ON THESE PLANS ARE BASED ON RECORDS OF THE VARIOUS UTILITY COMPANIES AND MEASUREMENTS TAKEN IN THE FIELD. THE INFORMATION IS NOT TO BE RELIED ON AS BEING EXACT OR COMPLETE. THE CONTRACTOR MUST CALL THE LOCAL UTILITY LOCATION CENTER AT LEAST 72 HOURS BEFORE ANY EXCAVATION TO REQUEST EXACT FIELD LOCATIONS OF THE UTILITIES.



GE	ENERAL GRADING NOTES:		PRIC CASI
1.	CONSTRUCTION SHALL COMPLY WITH ALL APPLICABLE GOVERNING CODES. SITE GRADING SHALL NOT PROCEED UNTIL EROSION CONTROL MEASURES HAVE BEEN INSTALLED, INSPECTED, AND APPROVED BY LOCAL AUTHORITIES.	11.	CON INST OR N
2.	ALL BENCHMARKS, CONTROL POINTS, PROPERTY MARKERS, AND RIGHT-OF-WAY MONUMENTS DISTURBED OR DESTROYED SHALL BE RESET UNDER THE SUPERVISION OF A PROFESSIONAL LAND SURVEYOR LICENSED IN THE STATE OF ALL SURVEYING COSTS SHALL BE THE CONTRACTOR'S.	12.	GRA SLOI SLOI POSI
3.	THE CONTRACTOR SHALL VERIFY UTILITY LOCATIONS BEFORE EXCAVATING.	13.	CON
4.	TOPSOIL SHALL BE STRIPPED TO A DEPTH WHERE SOIL IS FREE OF ROOTS AND VEGETATION.		ADJA SITE GRA
5.	REFERENCE GEOTECHNICAL ENGINEERING REPORT BY DATED FOR COMPLETE PAVING AND SUBGRADE RECOMMENDATIONS. CIVIL ENGINEER WILL NOT INTERPRET SOILS REPORTS OR ACCEPT RESPONSIBILITY FOR ALTERNATIVE METHODS PROPOSED BY THE CONTRACTOR.	14.	ACC (EXC TO E APPI
6.	UNDERCUTTING OF SOFT SPOTS AND PLACEMENT OF EARTHWORK IS GOVERNED FIRST BY THE GEOTECHNICAL REPORT. OBSERVATION AND TESTING SHALL BE PERFORMED BY A QUALIFIED GEOTECHNICAL ENGINEER TO VERIFY THAT THE SOFT SPOTS ARE PROPERLY OVEREXCAVATED AND REPLACED OR STABILIZED.		ALL ( LANE CON
7.	IF EXCAVATED MATERIAL IS UNSUITABLE FOR COMPACTION, AS DETERMINED BY THE GEOTECHNICAL ENGINEER, THE CONTRACTOR SHALL FURNISH SUITABLE BORROW.		ALL S WAT
8.	STRIPPING, PROOFROLLING, SUBGRADE SCARIFICATION, COMPACTION, AND FILL CONSTRUCTION IN THE BUILDING AND PAVING AREAS SHALL BE PERFORMED ACCORDING TO THE GEOTECHNICAL REPORT. EMBANKMENT BENEATH BUILDING PADS OR FOR PAVING SUBGRADE SHALL BE PLACED IN LIFTS NOT EXCEEDING EIGHT (8) INCHES AND COMPACTED TO A MINIMUM OF 98% AND 95% STANDARD PROCTOR DENSITY, RESPECTIVELY, AT OPTIMUM MOISTURE CONTENT UNLESS OTHERWISE SPECIFIED THEREIN. CONTRACTOR SHALL PROVIDE WATER AS REQUIRED TO OBTAIN		CON CLEA UTIL BOX/ ADJU INST
	SPECIFIED COMPACTION.	10.	LOC
9.	EXCAVATE TO INDICATED ELEVATIONS AND DIMENSIONS WITHIN A TOLERANCE OF PLUS OR MINUS 1 INCH. IF APPLICABLE, EXTEND EXCAVATIONS A SUFFICIENT DISTANCE FROM STRUCTURES FOR PLACING AND REMOVING CONCRETE FORMWORK, FOR INSTALLING SERVICES AND OTHER CONSTRUCTION, AND FOR INSPECTIONS.	19.	DIME EXIS EXIS COM
10.	PAVING CONTRACTOR IS RESPONSIBLE TO REVIEW ALL FIELD ESTABLISHED GRADES		

- NTRACTOR SHALL COORDINATE AND PROVIDE ALL STAKING NECESSARY TO TALL CONDUITS SUFFICIENT FOR UTILITY AND IRRIGATION SERVICES WHETHER NOT SHOWN ON THE CIVIL ENGINEER'S PLANS.
- SITIVE SITE DRAINAGE.
- ADES ON ALL SIDES.
- LICABLE ACCESSIBLE DESIGN GUIDELINES.
- TER SHALL BE TRAPPED.
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- MPLETION OF THE PROJECT.

OR TO PLACEMENT OF MATERIALS SO AS TO PROVIDE POSITIVE DRAINAGE IN ALL

ADES NOT OTHERWISE INDICATED ON THE PLANS SHALL BE UNIFORM LEVELS OR DPES BETWEEN POINTS WHERE ELEVATIONS ARE GIVEN, ABRUPT CHANGES IN PES SHALL BE WELL ROUNDED. THE CONTRACTOR IS RESPONSIBLE FOR

NTRACTOR IS RESPONSIBLE TO MEET AND MATCH NEW PAVEMENT WITH EXISTING JACENT PAVEMENT AREAS. THE TRANSITION BETWEEN THIS SITE AND ADJACENT ES MUST BE SMOOTH AND MONOLITHIC. ALL GRADING MUST MEET AND MATCH

CESSIBLE ROUTES AND SIDEWALKS ARE NOT TO EXCEED 5% RUNNING SLOPE CEPT AT RAMPS) AND 2% CROSS. ACCESSIBLE PARKING AND ACCESS AISLES NOT EXCEED 2% SLOPE IN ANY DIRECTION. ALL RAMPS SHALL COMPLY WITH THE

L CUT OR FILL SLOPES SHALL BE 3H:1V OR FLATTER UNLESS OTHERWISE NOTED. DSCAPE ISLANDS TO BE FILLED WITH SOIL SUITABLE FOR VEGETATION. THE NTRACTOR WILL ENSURE THAT NO PONDING WILL OCCUR AT LANDSCAPE ISLANDS. \_ SURFACE WATER MUST DRAIN AROUND THE ISLAND WITH POSITIVE SLOPE. NO

NTRACTOR SHALL MEET AND MATCH TOP OF JUNCTION BOXES/MANHOLES OR ANOUTS WITH FINISHED PAVING GRADES. FINAL GRADES OF ABOVE SURFACE LITIES NOT IN PAVED AREAS, INCLUDING BUT NOT LIMITED TO JUNCTION (/MANHOLE LIDS, WATER METER LIDS, AND SEWER CLEANOUTS, ARE TO BE USTED BY THE UTILITY CONTRACTOR TO CONFORM TO LANDSCAPING SOD

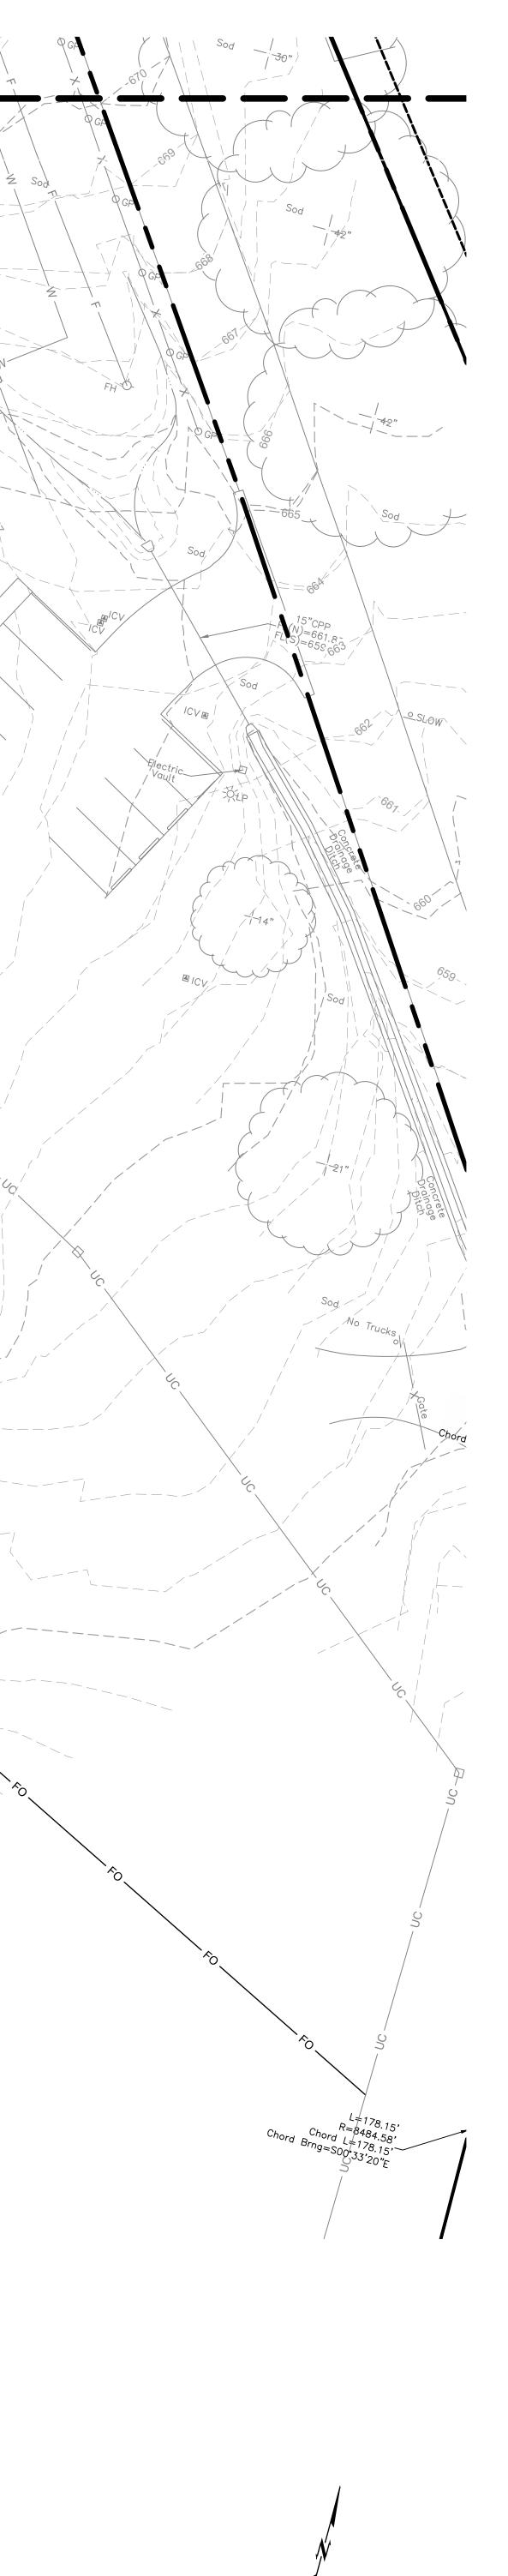
NTRACTOR SHALL REFER TO ARCHITECTURAL AND MEP PLANS FOR THE EXACT ATIONS AND DIMENSIONS OF ENTRY, EXIT PORCHES, PRECISE BUILDING ENSIONS, EXACT BUILDING UTILITY ENTRANCE LOCATIONS, AND DOWNSPOUTS. STING DRAINAGE STRUCTURES TO BE INSPECTED AND REPAIRED AS NEEDED. STING PIPES ARE TO BE CLEANED OUT TO REMOVE ALL SILT AND DEBRIS AT THE 20. IF ANY EXISTING STRUCTURES TO REMAIN ARE DAMAGED DURING CONSTRUCTION, IT SHALL BE THE CONTRACTOR'S RESPONSIBILITY TO REPAIR OR REPLACE THE EXISTING STRUCTURE AS NECESSARY.

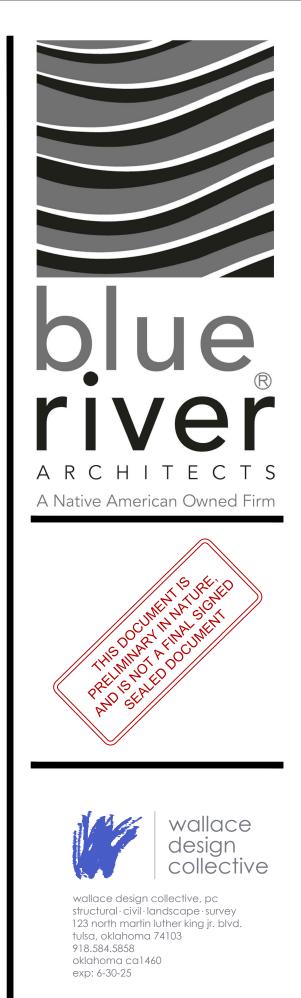
DETENTION AREA

- 21. ALL STORM PIPE ENTERING CONCRETE STRUCTURES SHALL BE GROUTED TO ENSURE CONNECTION AT STRUCTURE IS WATER TIGHT.
- 22. CONTRACTOR IS RESPONSIBLE FOR TEMPORARY ACCESS ROADS AND SHALL MAINTAIN POSITIVE DRAINAGE AWAY FROM BUILDING AND STRUCTURES FOR ALL GRASSED AND PAVED AREAS OF ENTIRE SITE THROUGHOUT CONSTRUCTION AND AVOID PONDING OR RUTTING. TEMPORARY DEWATERING, INCLUDING PUMPING, MAY BE REQUIRED AND SHALL BE INCLUDED IN THE SCOPE OF WORK.
- 23. UNLESS OTHERWISE INDICATED, ALL DISTURBED SOIL AREAS SHALL RECEIVE FOUR (4) INCHES OF TOPSOIL AND SHALL BE PERMANENTLY STABILIZED WITH SEED OR SOD.
- 24. REMOVE ALL TREES (INCLUDING ROOTBALLS), GRASS, WEEDS, ROOTS, AND OTHER DEBRIS FROM THE AREA TO BE EXCAVATED, FILLED, OR GRADED.
- 25. EXISTING TREES WHERE INDICATED SHALL BE PROTECTED FROM CONSTRUCTION ACTIVITIES. ALL TREE PROTECTION MEASURES SHALL BE INSTALLED PRIOR TO GRADING. ALL TREE PROTECTION FENCING TO BE INSPECTED DAILY AND ALL GRADING ACTIVITIES TO REMAIN OUTSIDE THE DRIP LINES.

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BLUE RIVER PROJECT NUMBER: 20230011 ISSUE DATE: 03/14/2024 ISSUE: CM PACKAGE

OTHER ISSUE DATES: NO. DESCRIPTION

DATE

SHEET NAME: **GRADING PLAN** -SOUTH

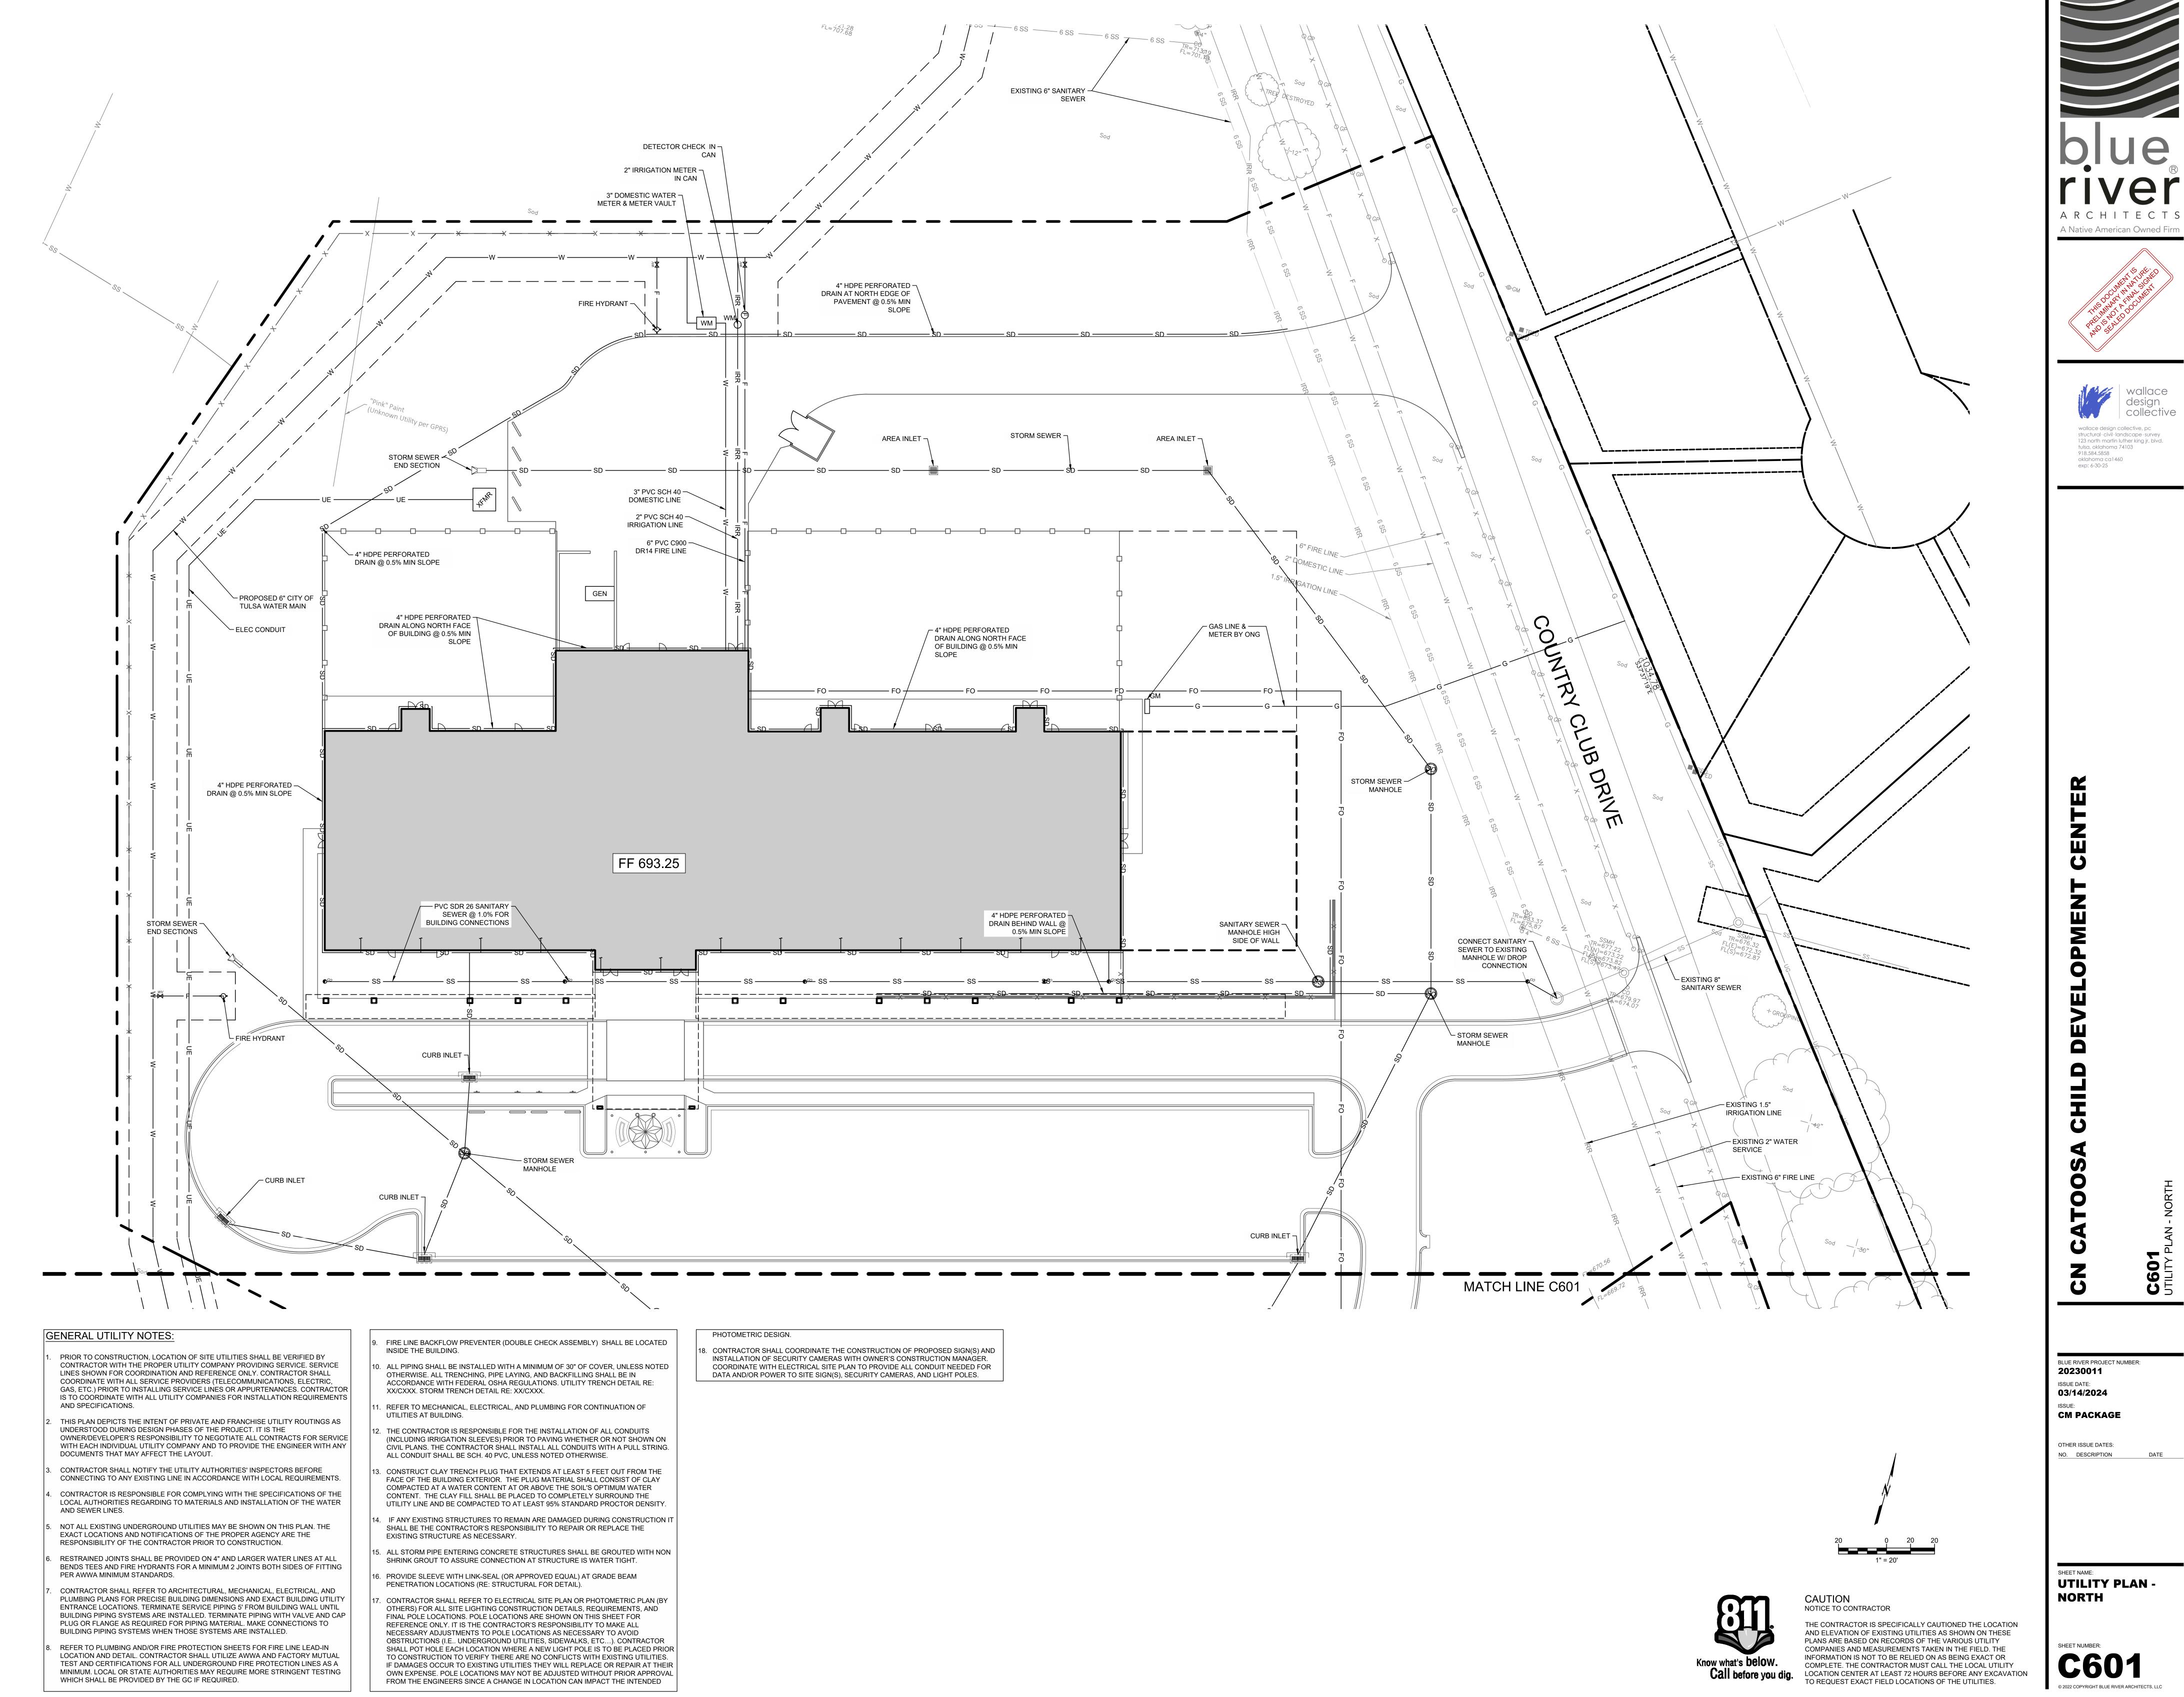


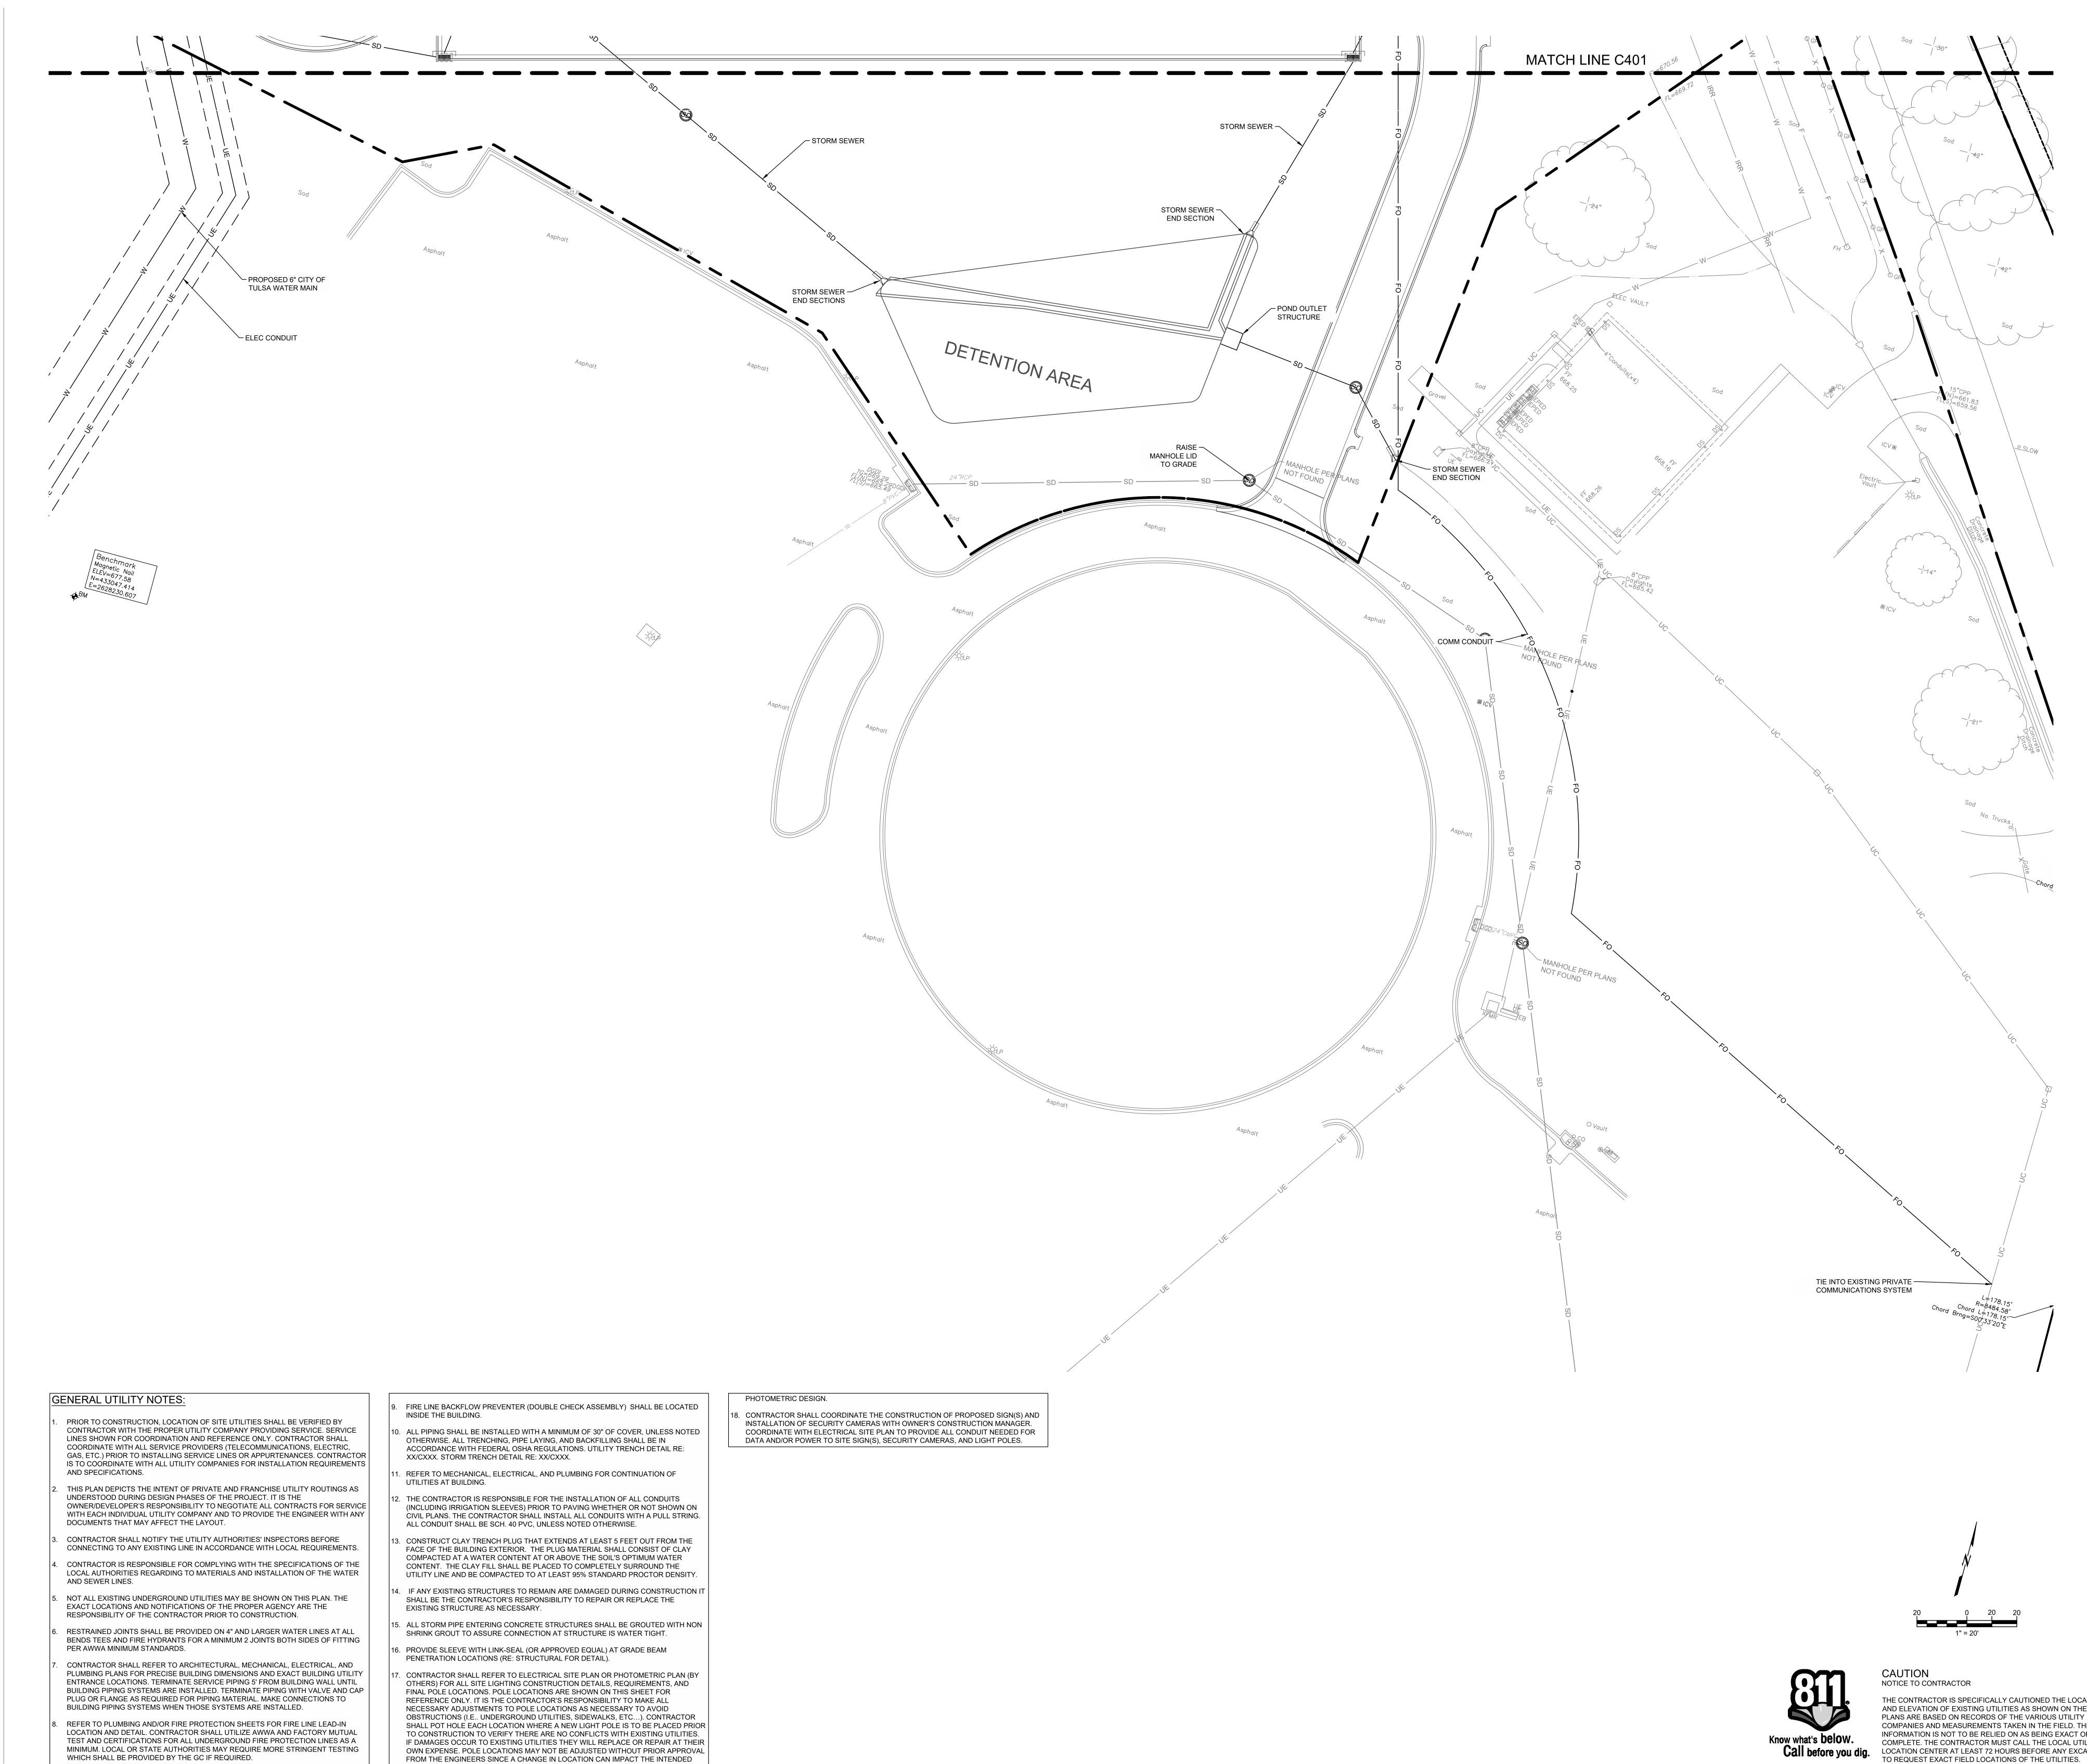
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1" = 20'

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