

CHEROKEE HARD ROCK CASINO EXTERIOR RENOVATION PHASE I CONSTRUCTION SET



CHEROKEE NATION ENTERTAINMENT
CONSTRUCTION SET

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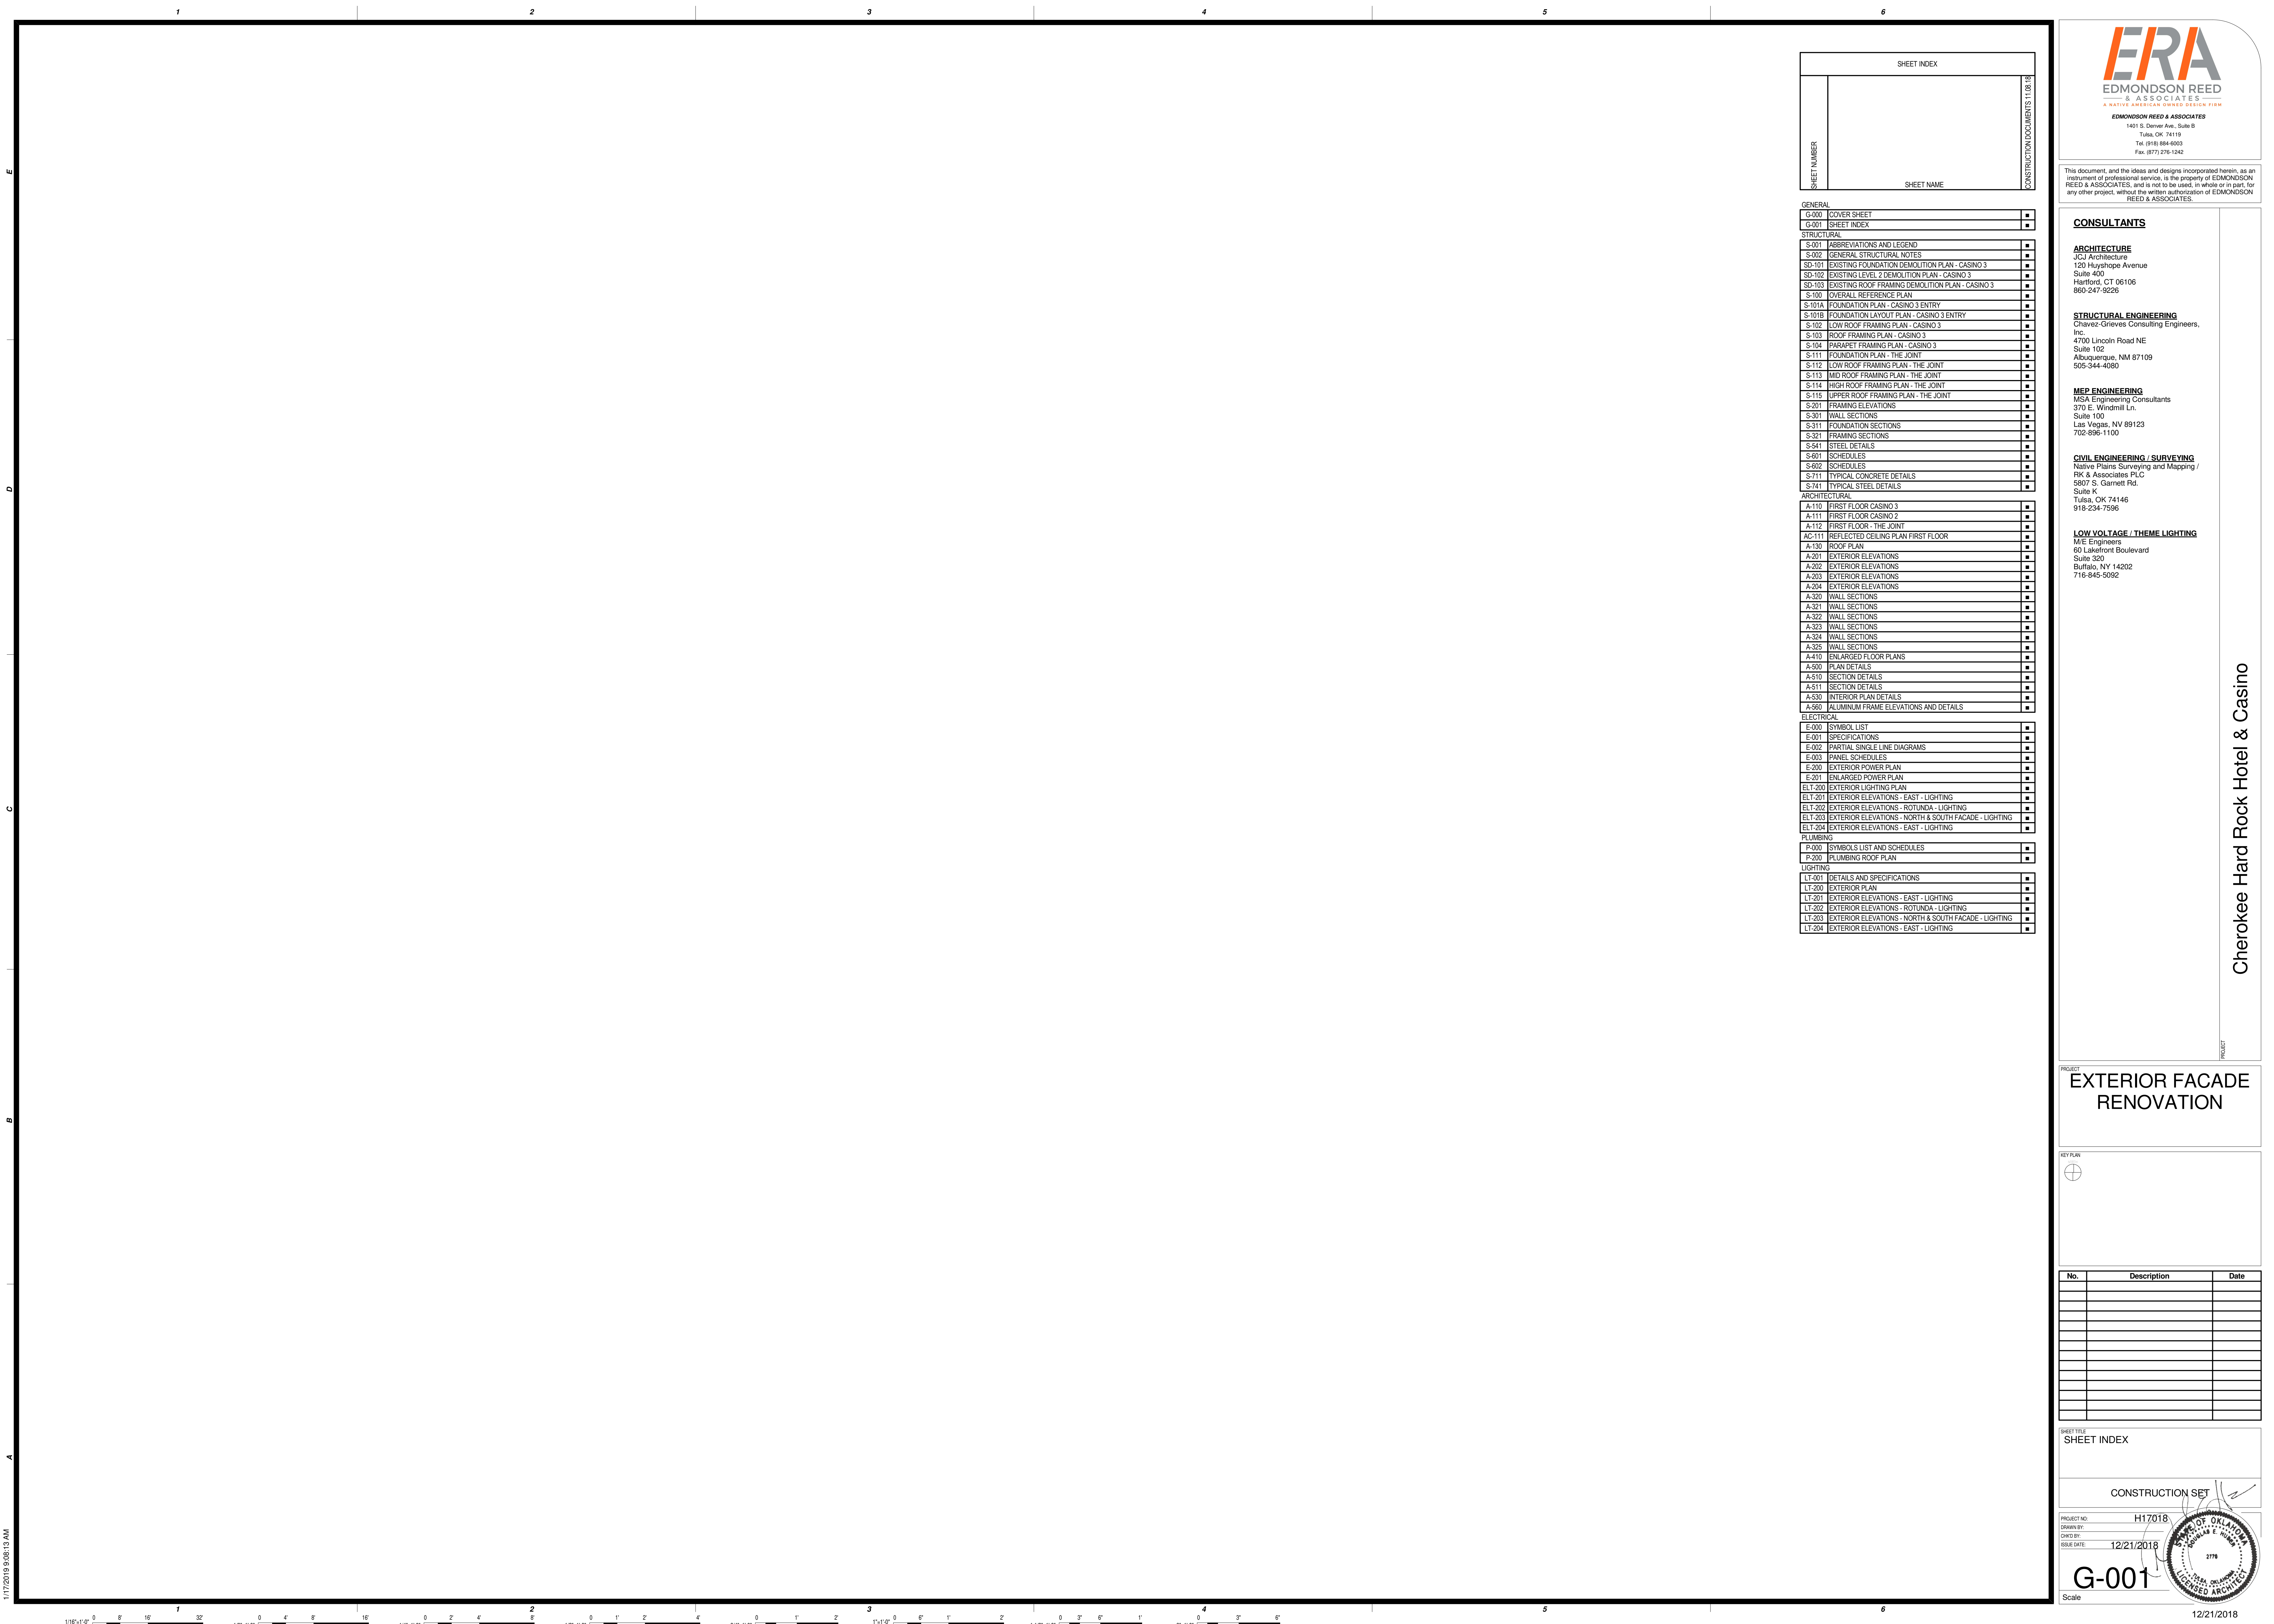
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Cherokee Hard Rock Hotel & Casino

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EXTERIOR FACADE RENOVATION

KEY PLAN




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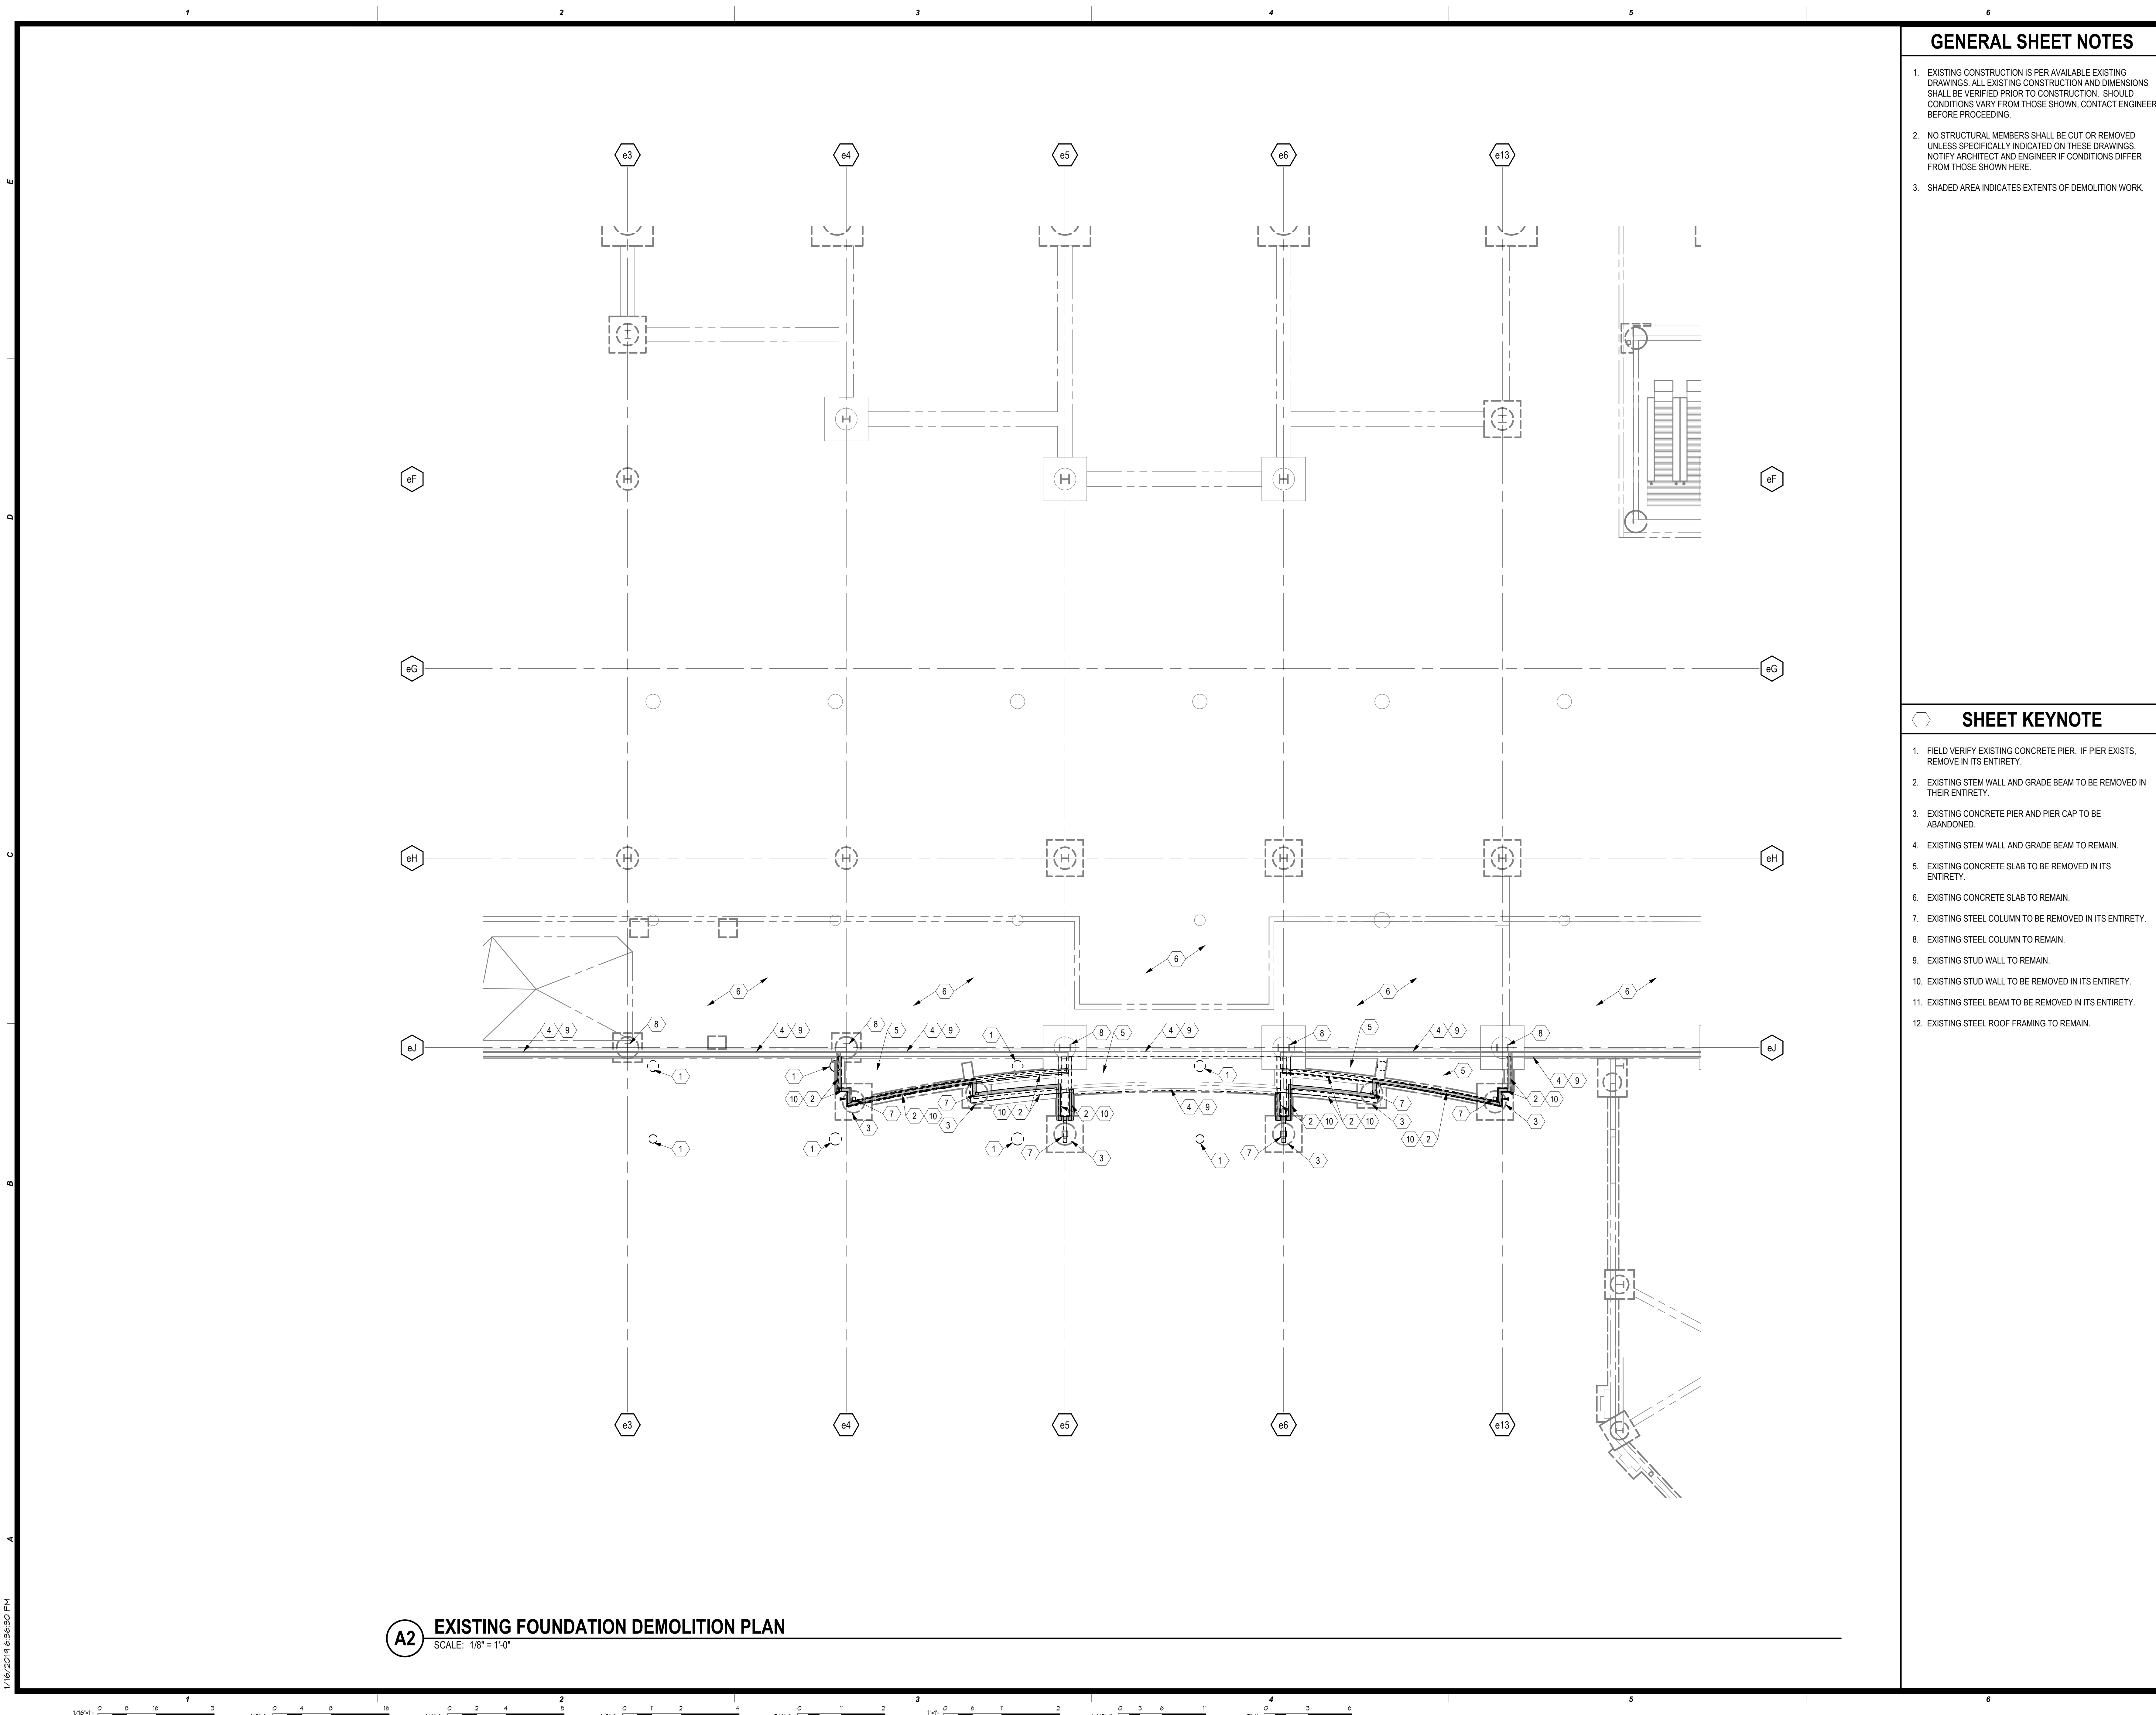
SHEET INDEX

CONSTRUCTION SET

PROJECT NO: H17018
 DRAWN BY:
 CHECKED BY:
 ISSUE DATE: 12/21/2018
 Scale

G-001



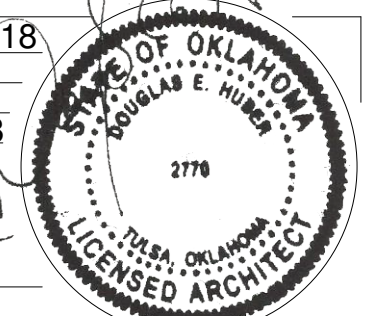

GENERAL SHEET NOTES

- EXISTING CONSTRUCTION IS PER AVAILABLE EXISTING DRAWINGS. ALL EXISTING CONSTRUCTION AND DIMENSIONS SHALL BE VERIFIED PRIOR TO CONSTRUCTION. SHOULD CONDITIONS VARY FROM THOSE SHOWN, CONTACT ENGINEER BEFORE PROCEEDING.
- NO STRUCTURAL MEMBERS SHALL BE CUT OR REMOVED UNLESS SPECIFICALLY INDICATED ON THESE DRAWINGS. NOTIFY ARCHITECT AND ENGINEER IF CONDITIONS DIFFER FROM THOSE SHOWN HERE.
- SHADED AREA INDICATES EXTENTS OF DEMOLITION WORK.



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SHEET KEYNOTE

- FIELD VERIFY EXISTING CONCRETE PIER. IF PIER EXISTS, REMOVE IN ITS ENTIRETY.
- EXISTING STEM WALL AND GRADE BEAM TO BE REMOVED IN THEIR ENTIRETY.
- EXISTING CONCRETE PIER AND PIER CAP TO BE ABANDONED.
- EXISTING STEM WALL AND GRADE BEAM TO REMAIN.
- EXISTING CONCRETE SLAB TO BE REMOVED IN ITS ENTIRETY.
- EXISTING CONCRETE SLAB TO REMAIN.
- EXISTING STEEL COLUMN TO BE REMOVED IN ITS ENTIRETY.
- EXISTING STEEL COLUMN TO REMAIN.
- EXISTING STUD WALL TO REMAIN.
- EXISTING STUD WALL TO BE REMOVED IN ITS ENTIRETY.
- EXISTING STEEL BEAM TO BE REMOVED IN ITS ENTIRETY.
- EXISTING STEEL ROOF FRAMING TO REMAIN.

EXTERIOR FACADE RENOVATION



No.	Description	Date

PROJECT: EXISTING FOUNDATION DEMOLITION PLAN - CASINO 3
 SHEET: A2
 DATE: 01/16/2019

A2 EXISTING FOUNDATION DEMOLITION PLAN
 SCALE: 1/8" = 1'-0"


PROJ: H11018.01
 DRAWN: J. ANDERSON
 CHECKED: C. ROMERO
 DATE: 01/16/2019

SD-101
 Scale: As Indicated

Cherokee Hard Rock Hotel & Casino

1/16/2019 6:30 PM



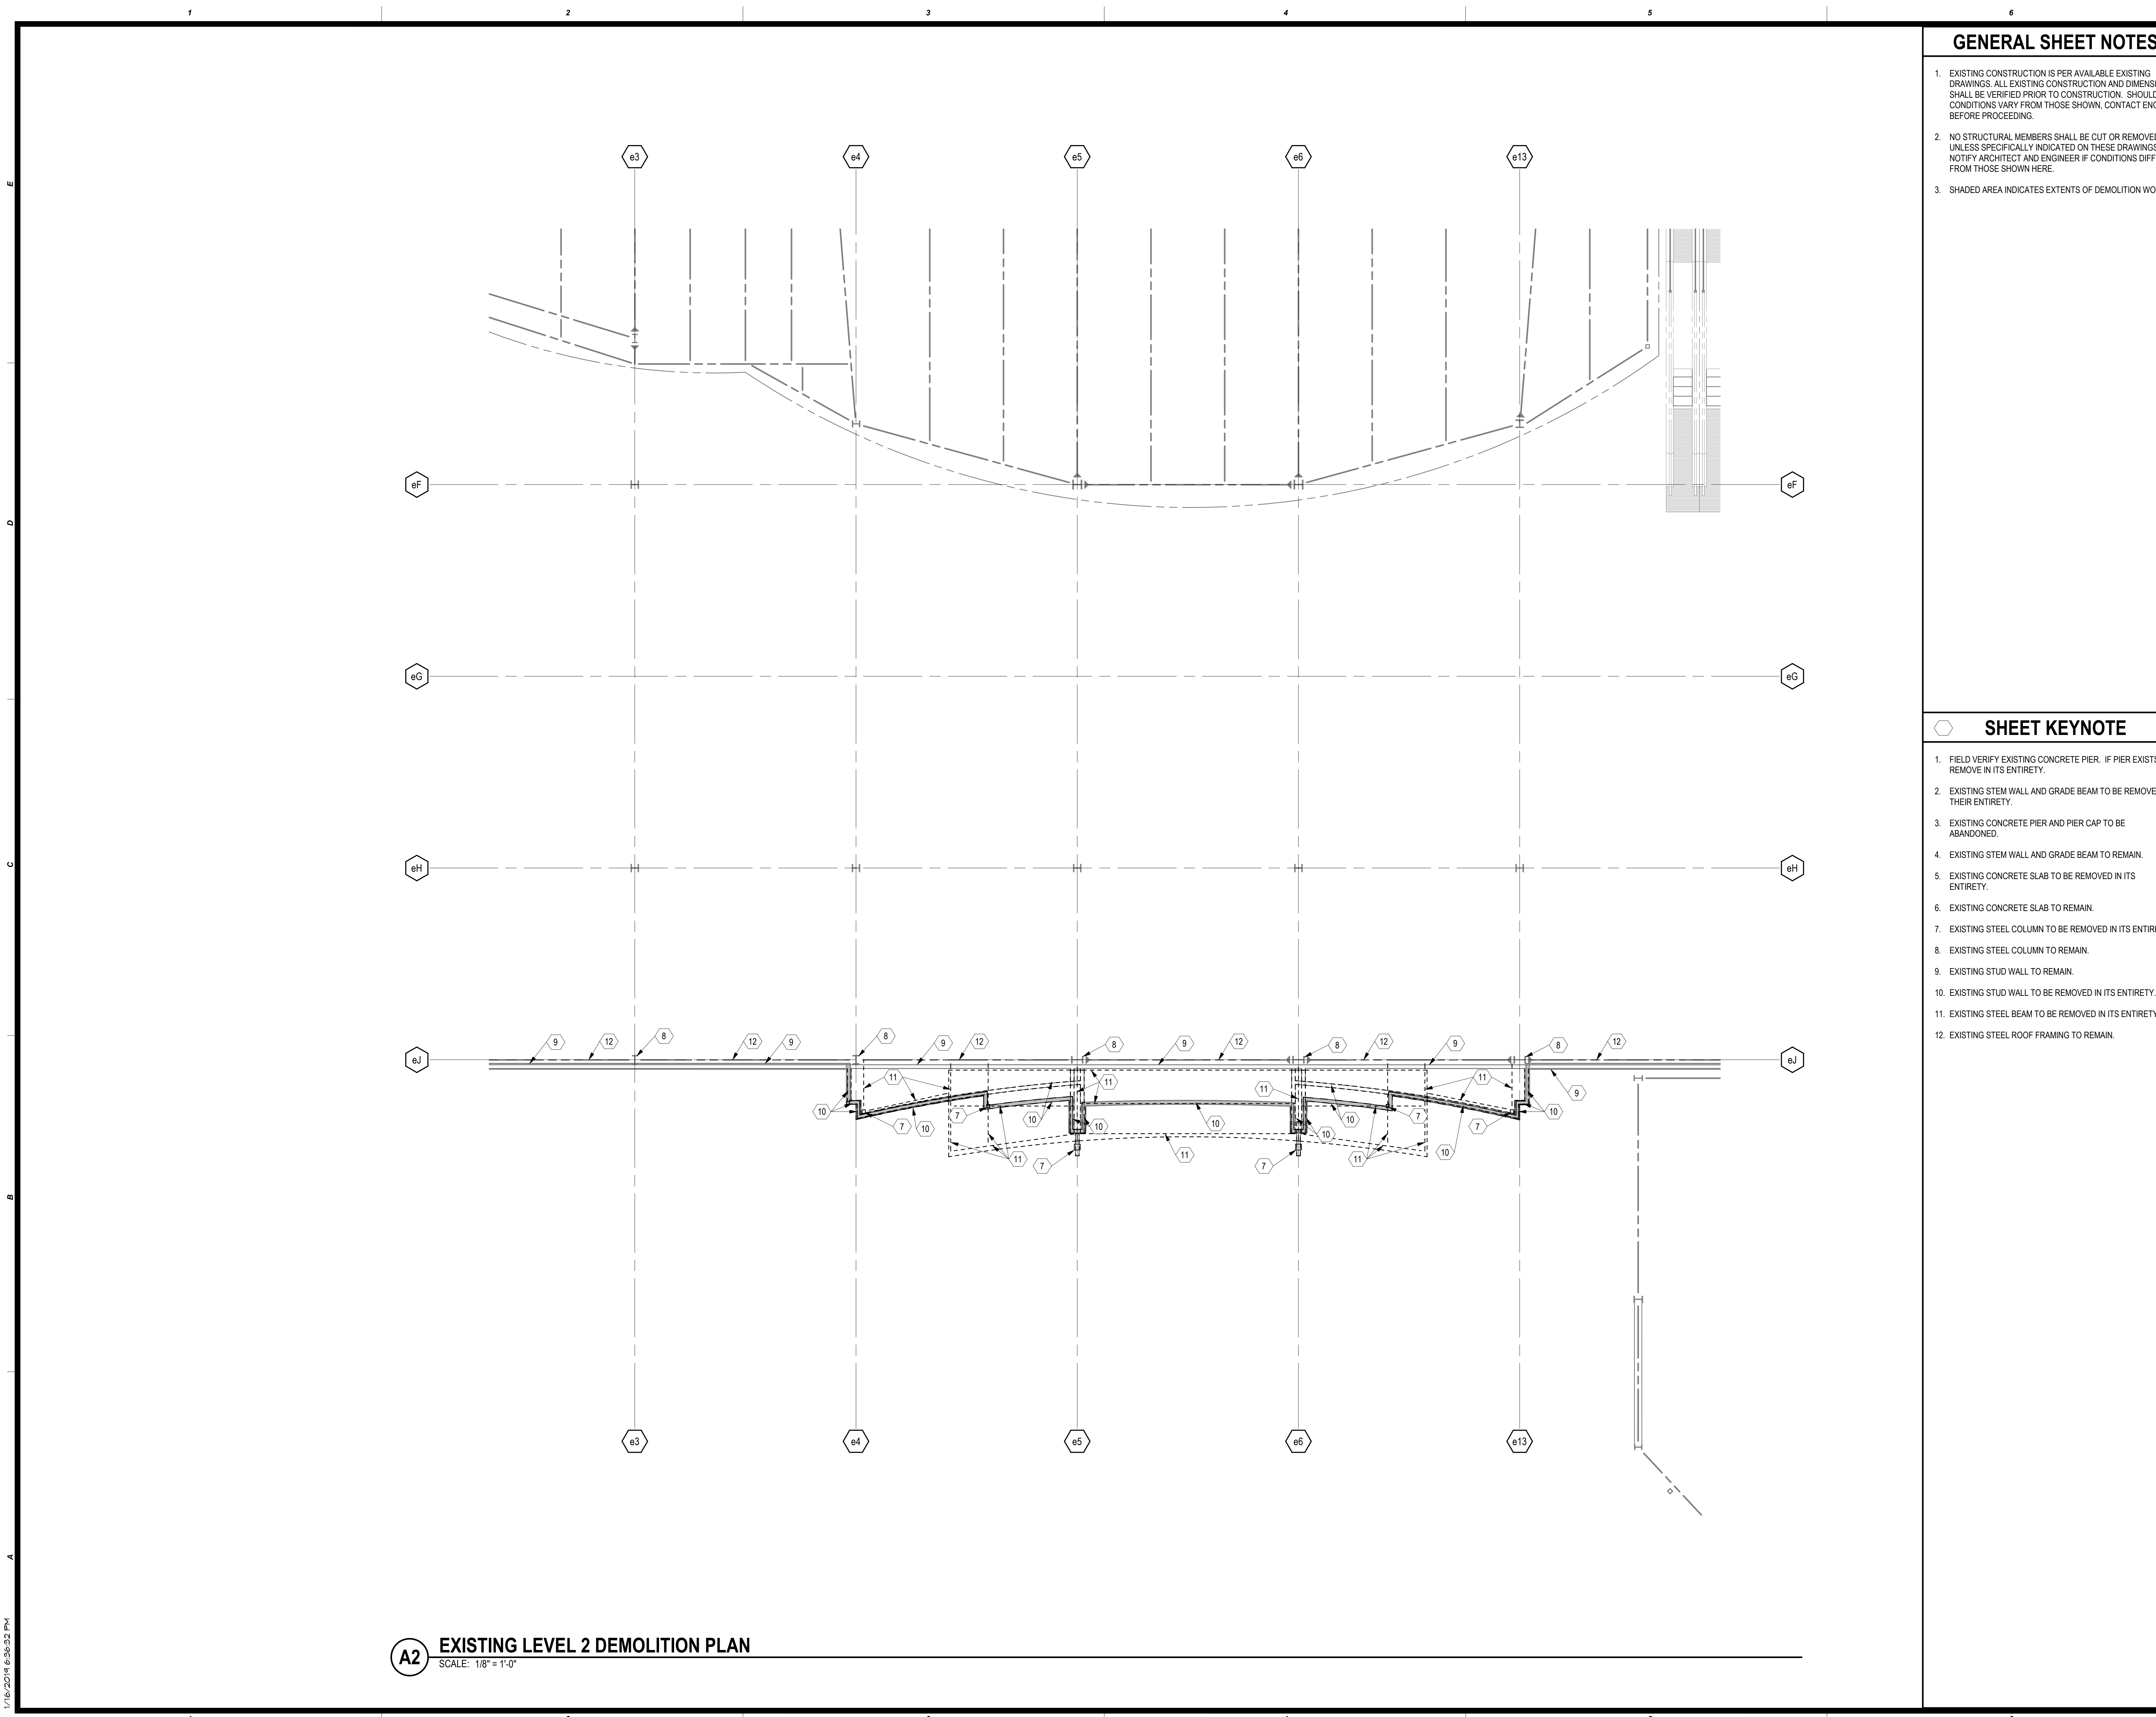

A2 EXISTING LEVEL 2 DEMOLITION PLAN
SCALE: 1/8" = 1'-0"

GENERAL SHEET NOTES

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- SHADED AREA INDICATES EXTENTS OF DEMOLITION WORK.

SHEET KEYNOTE

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- EXISTING STEM WALL AND GRADE BEAM TO REMAIN.
- EXISTING CONCRETE SLAB TO BE REMOVED IN ITS ENTIRETY.
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- EXISTING STEEL BEAM TO BE REMOVED IN ITS ENTIRETY.
- EXISTING STEEL ROOF FRAMING TO REMAIN.

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EXTERIOR FACADE RENOVATION




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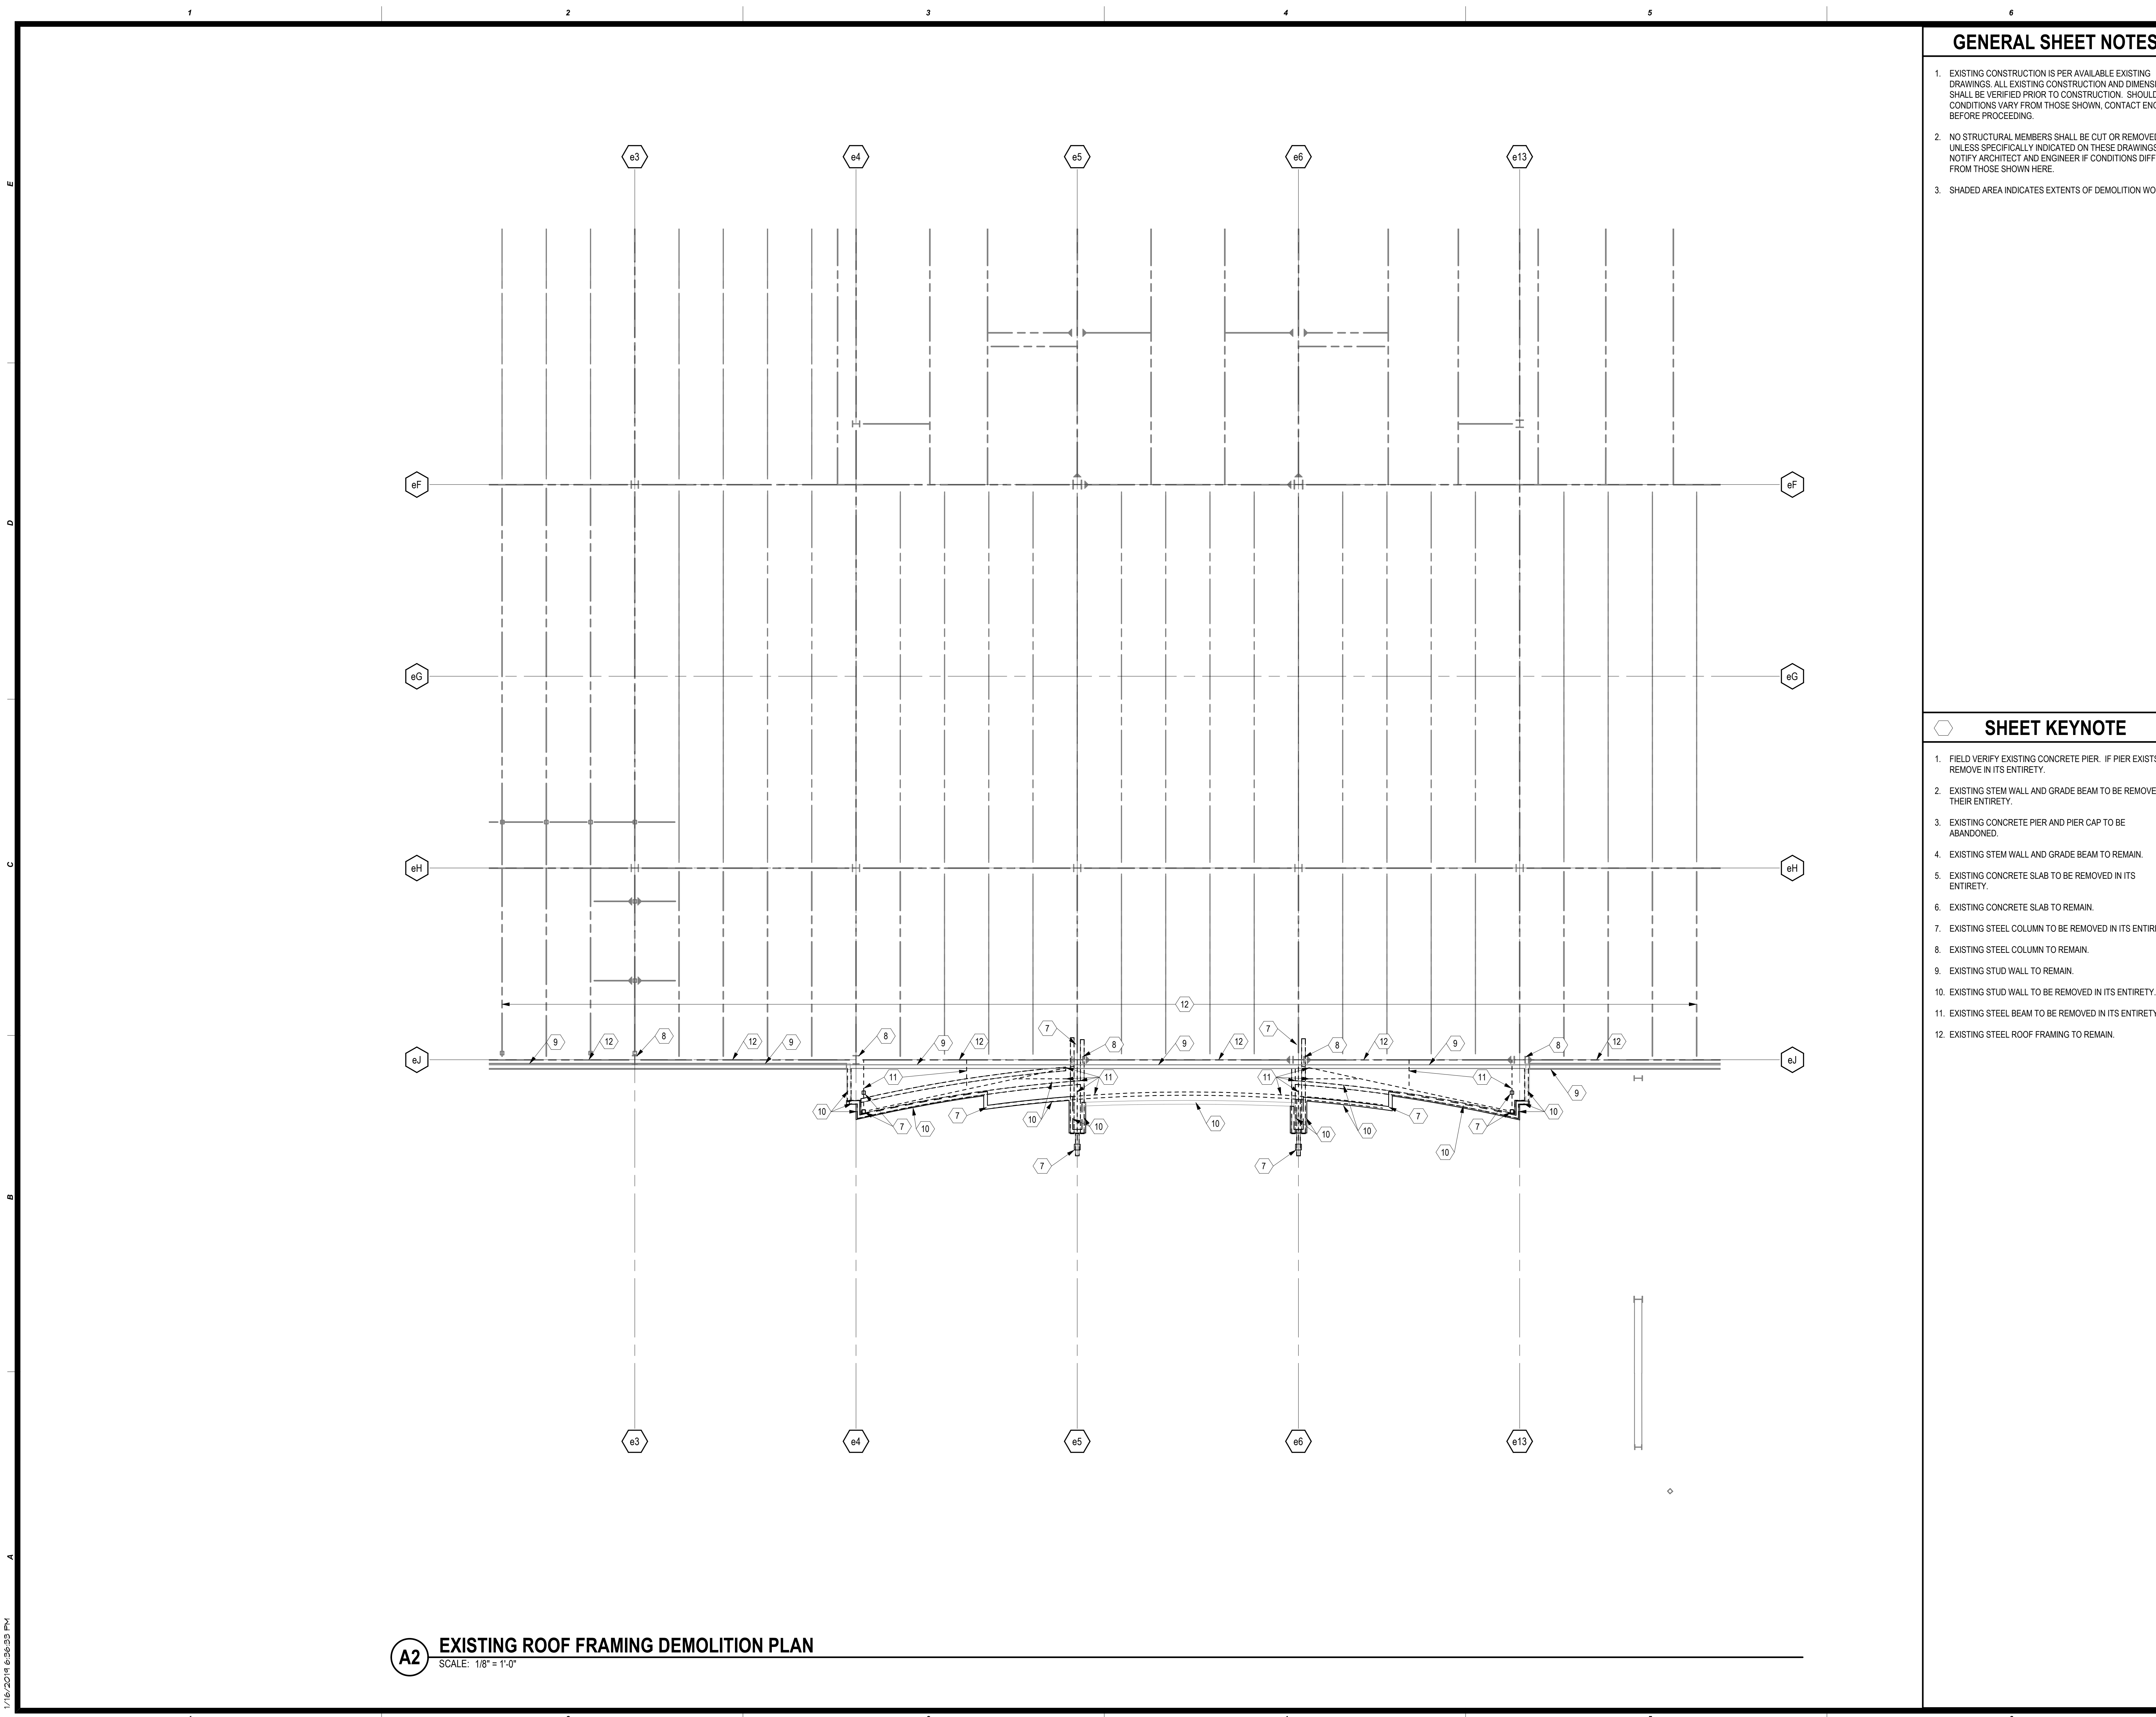
PROJ: EXISTING LEVEL 2 DEMOLITION PLAN - CASINO 3
PROGRESS SET

PROJ: H11018.01
DRAWN: J ANDERSON
CHKD: C ROMERO
DATE: 01/16/2019

SD-102
Scale: As Indicated

Cherokee Hard Rock Hotel & Casino



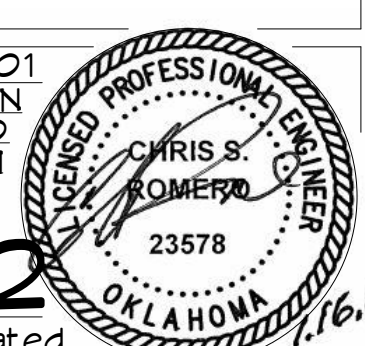

GENERAL SHEET NOTES

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SHEET KEYNOTE

1. FIELD VERIFY EXISTING CONCRETE PIER. IF PIER EXISTS, REMOVE IN ITS ENTIRETY.
2. EXISTING STEM WALL AND GRADE BEAM TO BE REMOVED IN THEIR ENTIRETY.
3. EXISTING CONCRETE PIER AND PIER CAP TO BE ABANDONED.
4. EXISTING STEM WALL AND GRADE BEAM TO REMAIN.
5. EXISTING CONCRETE SLAB TO BE REMOVED IN ITS ENTIRETY.
6. EXISTING CONCRETE SLAB TO REMAIN.
7. EXISTING STEEL COLUMN TO BE REMOVED IN ITS ENTIRETY.
8. EXISTING STEEL COLUMN TO REMAIN.
9. EXISTING STUD WALL TO REMAIN.
10. EXISTING STUD WALL TO BE REMOVED IN ITS ENTIRETY.
11. EXISTING STEEL BEAM TO BE REMOVED IN ITS ENTIRETY.
12. EXISTING STEEL ROOF FRAMING TO REMAIN.

EXTERIOR FACADE RENOVATION

No.	Description	Date

A2 EXISTING ROOF FRAMING DEMOLITION PLAN
 SCALE: 1/8" = 1'-0"

PROJECT: H11018.01
 DRAWN: J. ANDERSON
 CHECKED: C. ROMERO
 DATE: 01/16/2019

PROGRESS SET

SD-103
 Scale: As Indicated

Cherokee Hard Rock Hotel & Casino

GENERAL SHEET NOTES



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SHEET KEYNOTE

1. LED DISPLAY. SEE ARCHITECTURAL PLANS FOR EXACT SIZE AND LOCATION.

A2 OVERALL REFERENCE PLAN
 SCALE: 1/32" = 1'-0"

EXTERIOR FACADE RENOVATION


No.	Description	Date


OVERALL REFERENCE PLAN

PROGRESS SET

PROJECT: H11018.01
 DRAWN: J. ANDERSON
 CHECKED: C. ROMERO
 DATE: 01/16/2019
 SHEET: S-100
 Scale: As Indicated

Cherokee Hard Rock Hotel & Casino

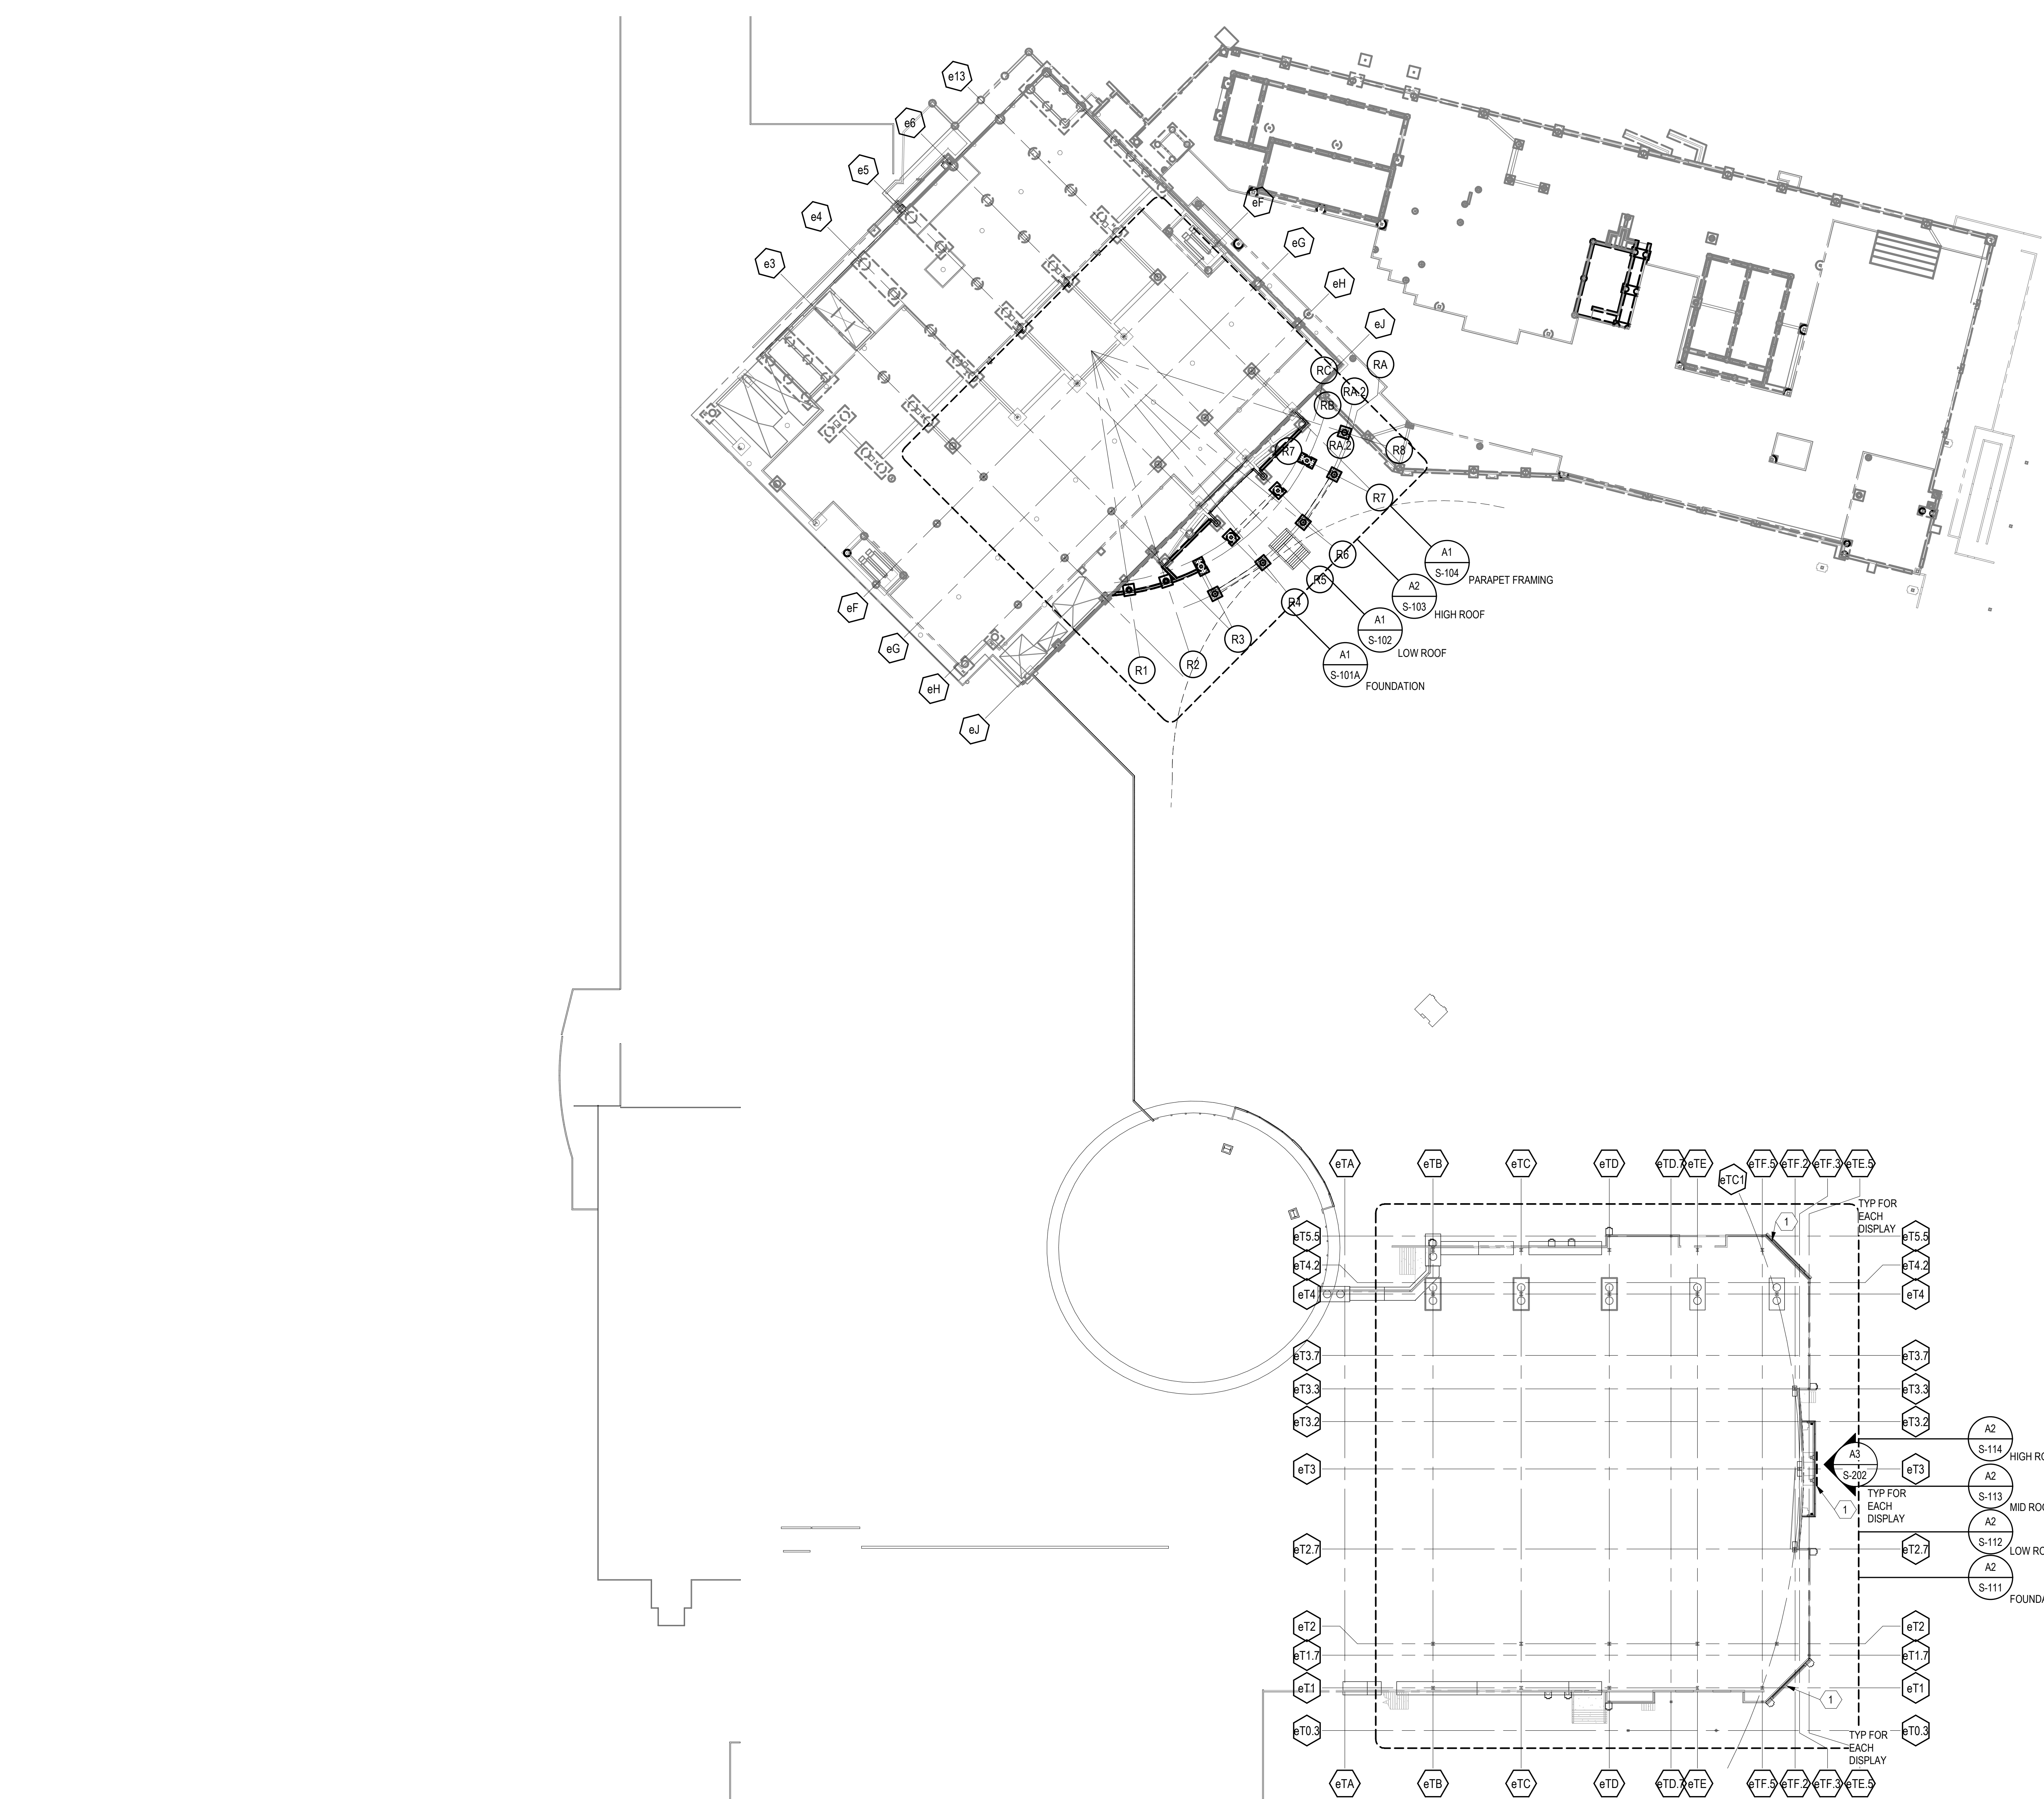

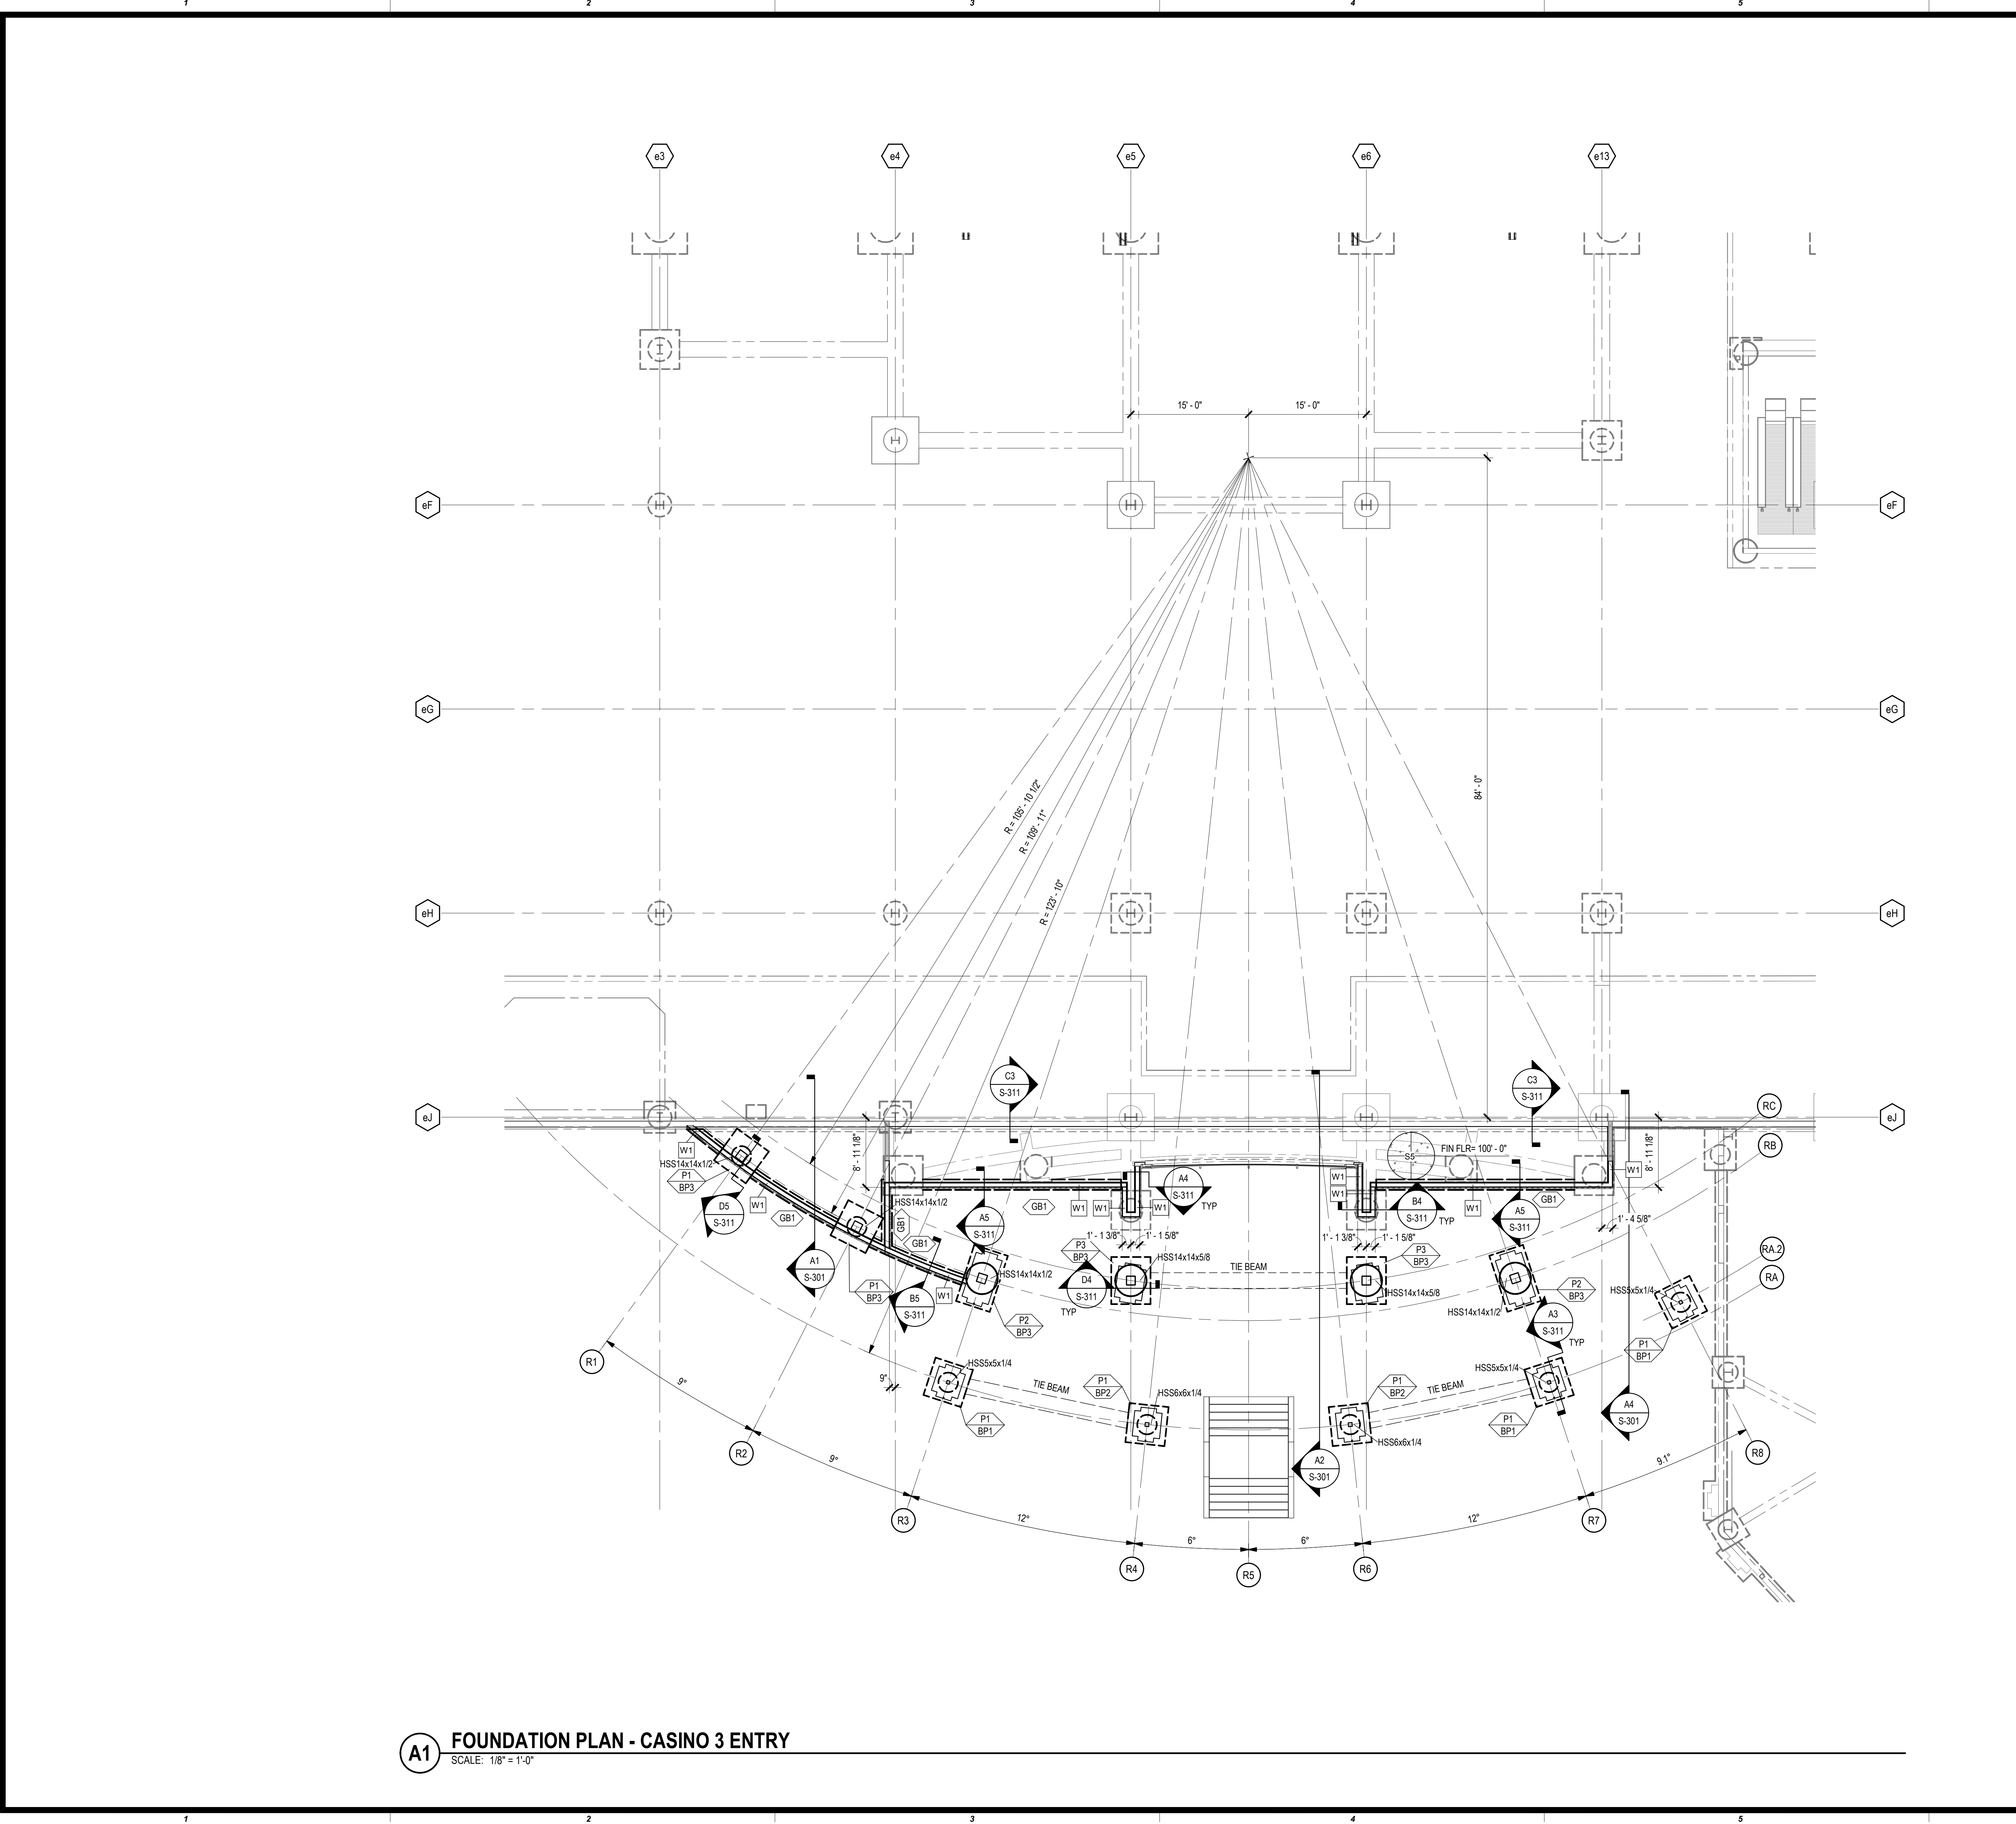

GENERAL SHEET NOTES

- SOME SHEET KEYNOTES MAY NOT APPLY TO THIS SHEET.
- REFERENCE FINISH FLOOR ELEVATION 100'-0" MEAN SEA FINISH FLOOR ELEVATION. SEE CIVIL DRAWINGS.
- NOTE TO ERECTOR: LATERAL STABILITY OF THE STEEL FRAME IS DEPENDENT UPON THE MOMENT FRAMES. THE ERECTOR SHALL PROVIDE TEMPORARY BRACING OF THE STEEL FRAME IN ACCORDANCE WITH SECTION 7.10 OF THE AISC CODE OF STANDARD PRACTICES.
- DIMENSIONS ARE TO THE FACE OF CONCRETE, OR GRID LINE, UNLESS NOTED OTHERWISE.
- EXISTING CONSTRUCTION IS PER AVAILABLE EXISTING DRAWINGS. ALL EXISTING CONSTRUCTION AND DIMENSIONS SHALL BE VERIFIED PRIOR TO CONSTRUCTION. SHOULD CONDITIONS VARY FROM THOSE SHOWN, CONTACT ENGINEER BEFORE PROCEEDING.
- TOP OF PIER CAP ELEVATION = 98'-0", UNLESS NOTED OTHERWISE.
- TOP OF GRADE BEAM ELEVATION = TOP OF PIER CAP ELEVATION, UNLESS NOTED OTHERWISE.
- TOP OF THE BEAM = TOP OF PIER CAP ELEVATION, UNLESS NOTED OTHERWISE.
- PROVIDE SLAB JOINTS AT 12'-0" ON CENTER MAXIMUM. THE AREA OF THE CONTROL JOINT SHALL NOT EXCEED A 2:1 RATIO. CONTROL JOINTS SHALL BE LOCATED AT COLUMN LINES WHERE THE LAYOUT PERMITS. AT RE-ENTRANT CORNERS THAT DO NOT HAVE CONTROL JOINTS, PROVIDE 2-#4 x 3'-0" DIAGONAL TO THE RE-ENTRANT CORNER.
- STRUCTURAL COLD FORMED METAL STUDS SHALL BE 6" STUDS, DESIGNED BY OTHERS.
- SEE SHEET S-311 FOR TYPICAL FOUNDATION SECTIONS.
- SEE SHEET S-711 THRU S-741 FOR TYPICAL DETAILS.
- SEE SHEET S-601 FOR SCHEDULES.

SHEET KEYNOTE

- FLOOR DRAIN, SLOPE SLAB TO DRAIN 1/8" PER FOOT. COORDINATE EXACT SIZE AND LOCATION WITH ARCHITECTURAL AND MECHANICAL DRAWINGS.



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Cherokee Hard Rock Hotel & Casino

EXTERIOR FACADE RENOVATION



No.	Description	Date

A1 FOUNDATION PLAN - CASINO 3 ENTRY
 SCALE: 1/8" = 1'-0"

PROJ: H11018.01
 DRAWN: J. ANDERSON
 CHECKED: C. ROMERO
 DATE: 01/16/2019

PROF. SEAL: J. ANDERSON
 23578
 1/16/2019

S-101A
 Scale: As Indicated

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Cherokee Hard Rock Hotel & Casino

**EXTERIOR
FACADE
RENOVATION**

KEY


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No.	Description	Date


FOUNDATION LAYOUT PLAN - CASINO 3 ENTRY

PROGRESS SET

PROJECT: H11018.01
DRAWN: J. ANDERSON
CHECKED: C. ROMERO
DATE: 01/16/2019

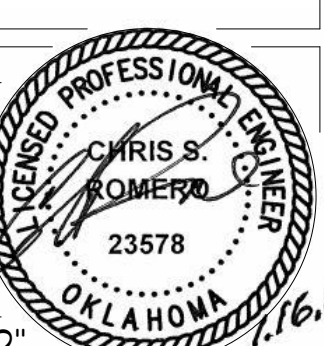


S-101B
Scale: 1/8" = 1'-0"

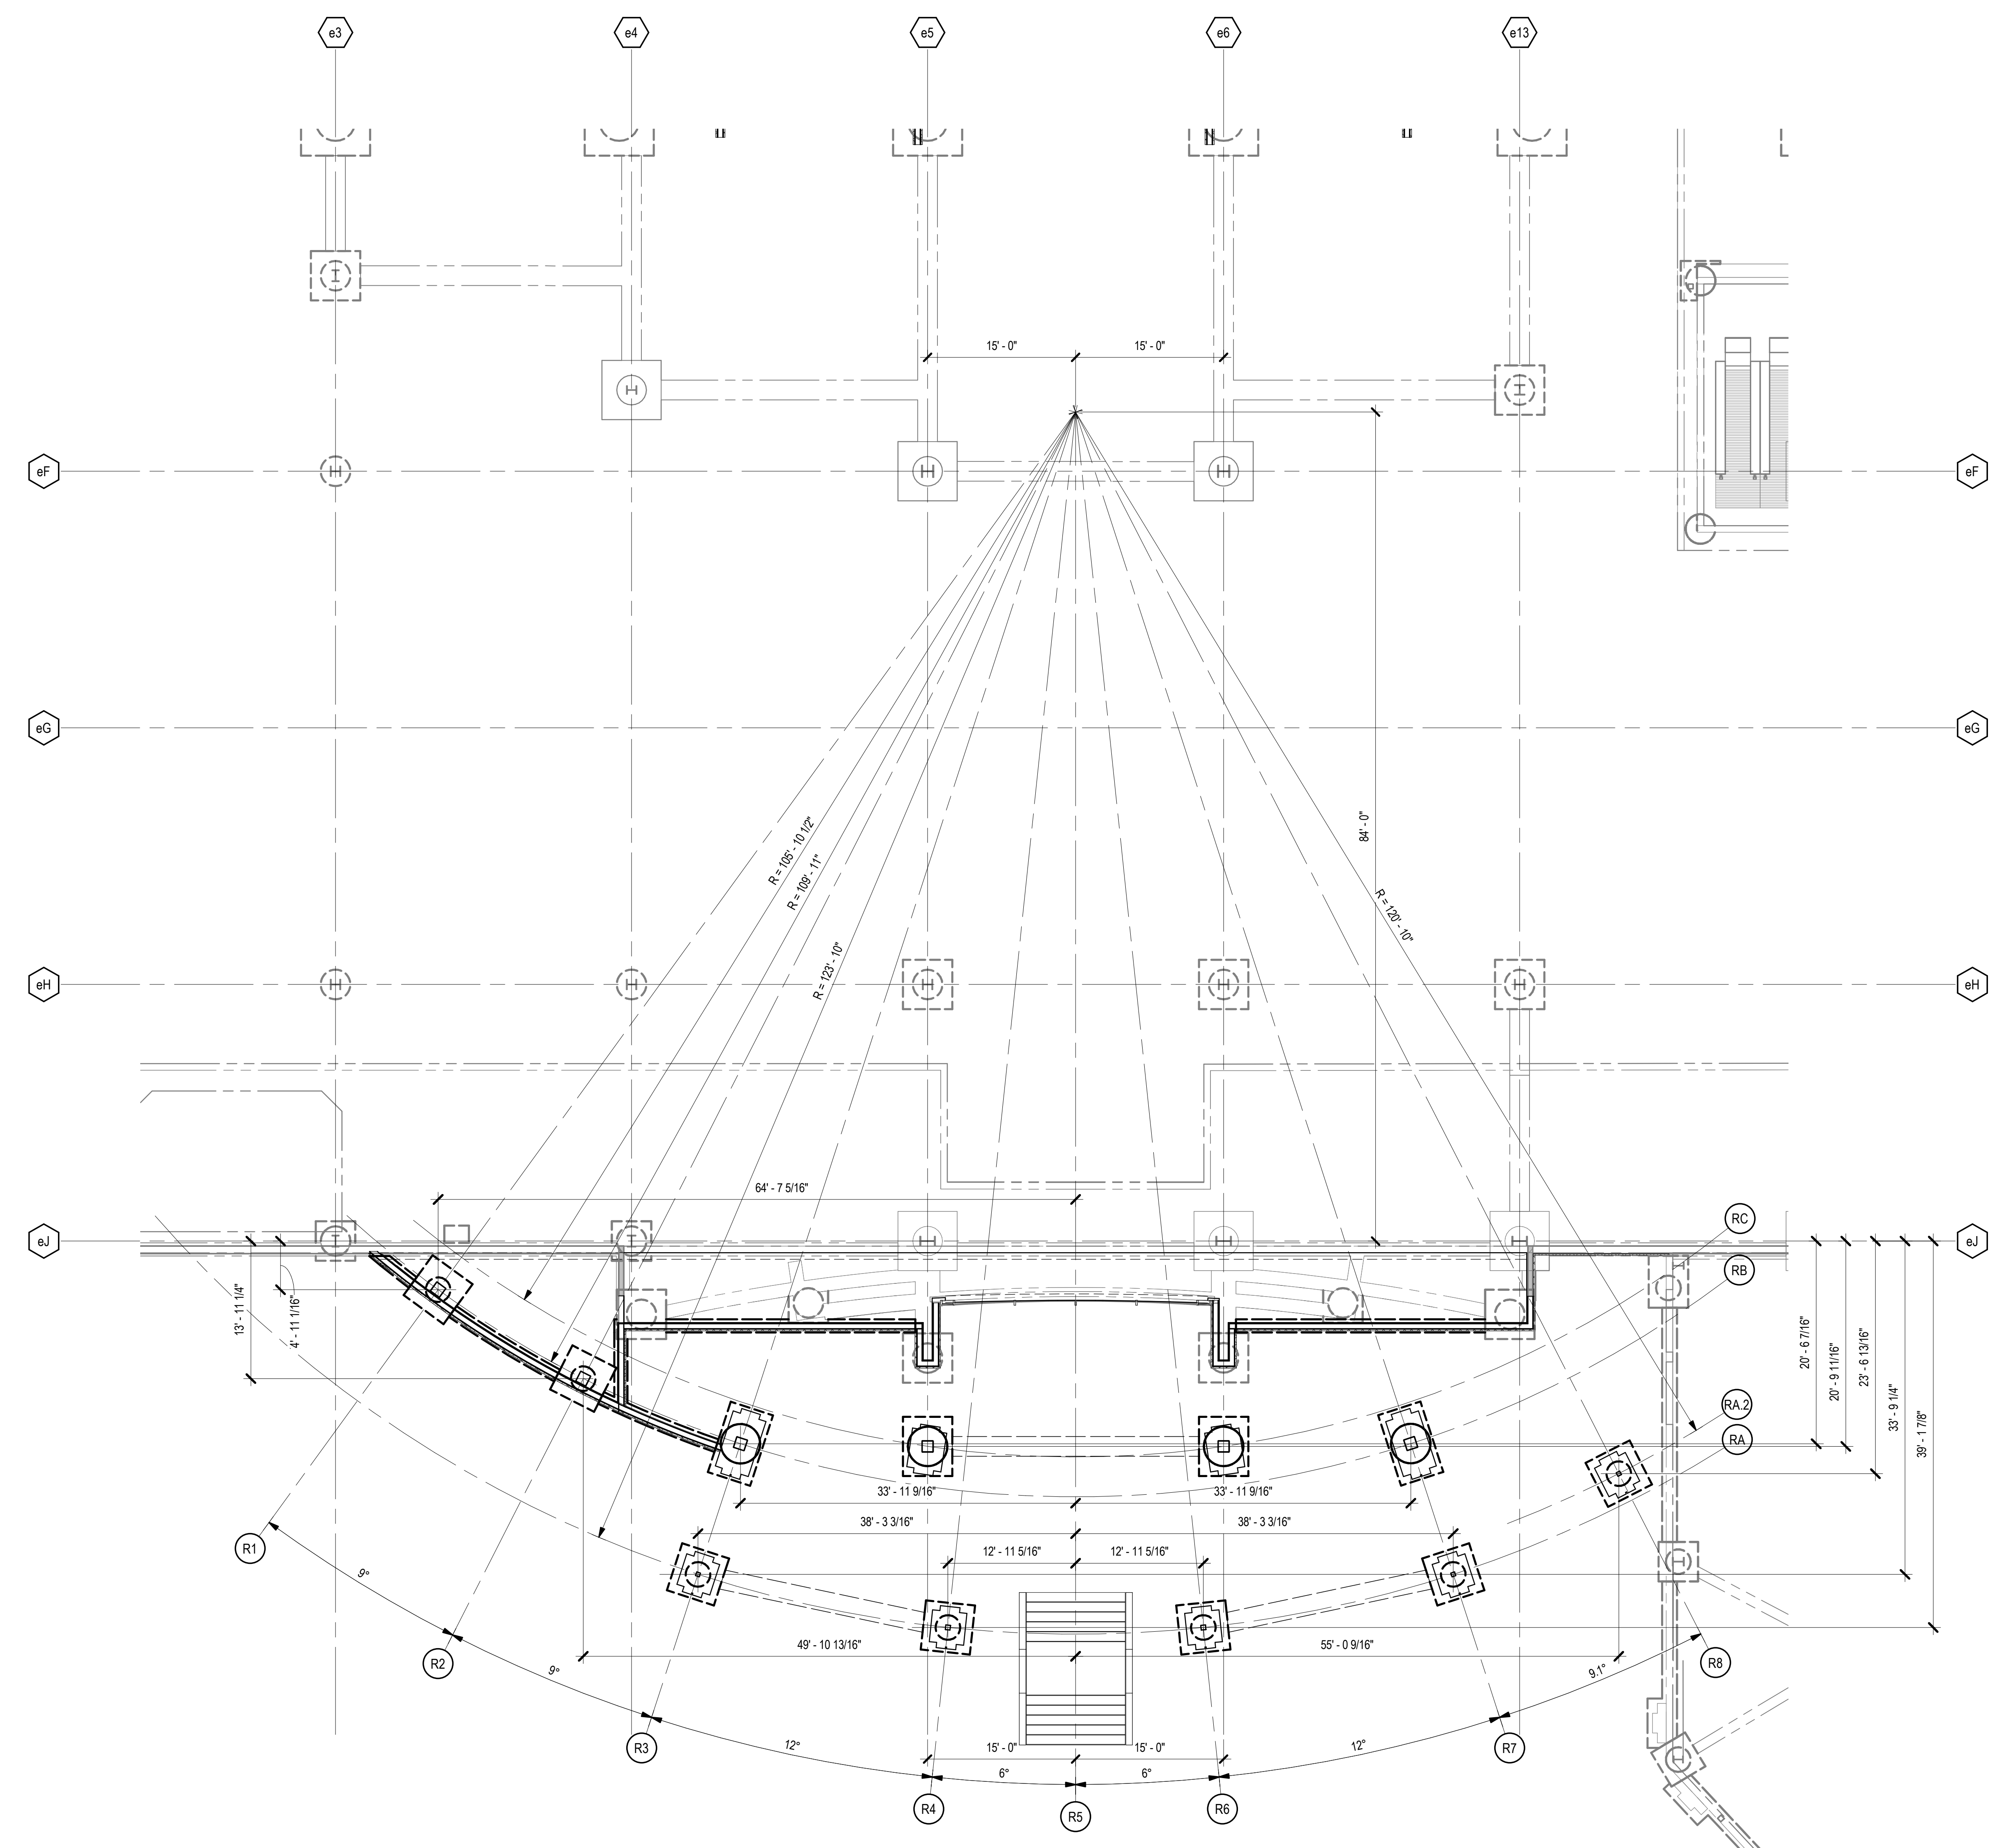

A2 FOUNDATION LAYOUT PLAN - CASINO 3 ENTRY
SCALE: 1/8" = 1'-0"



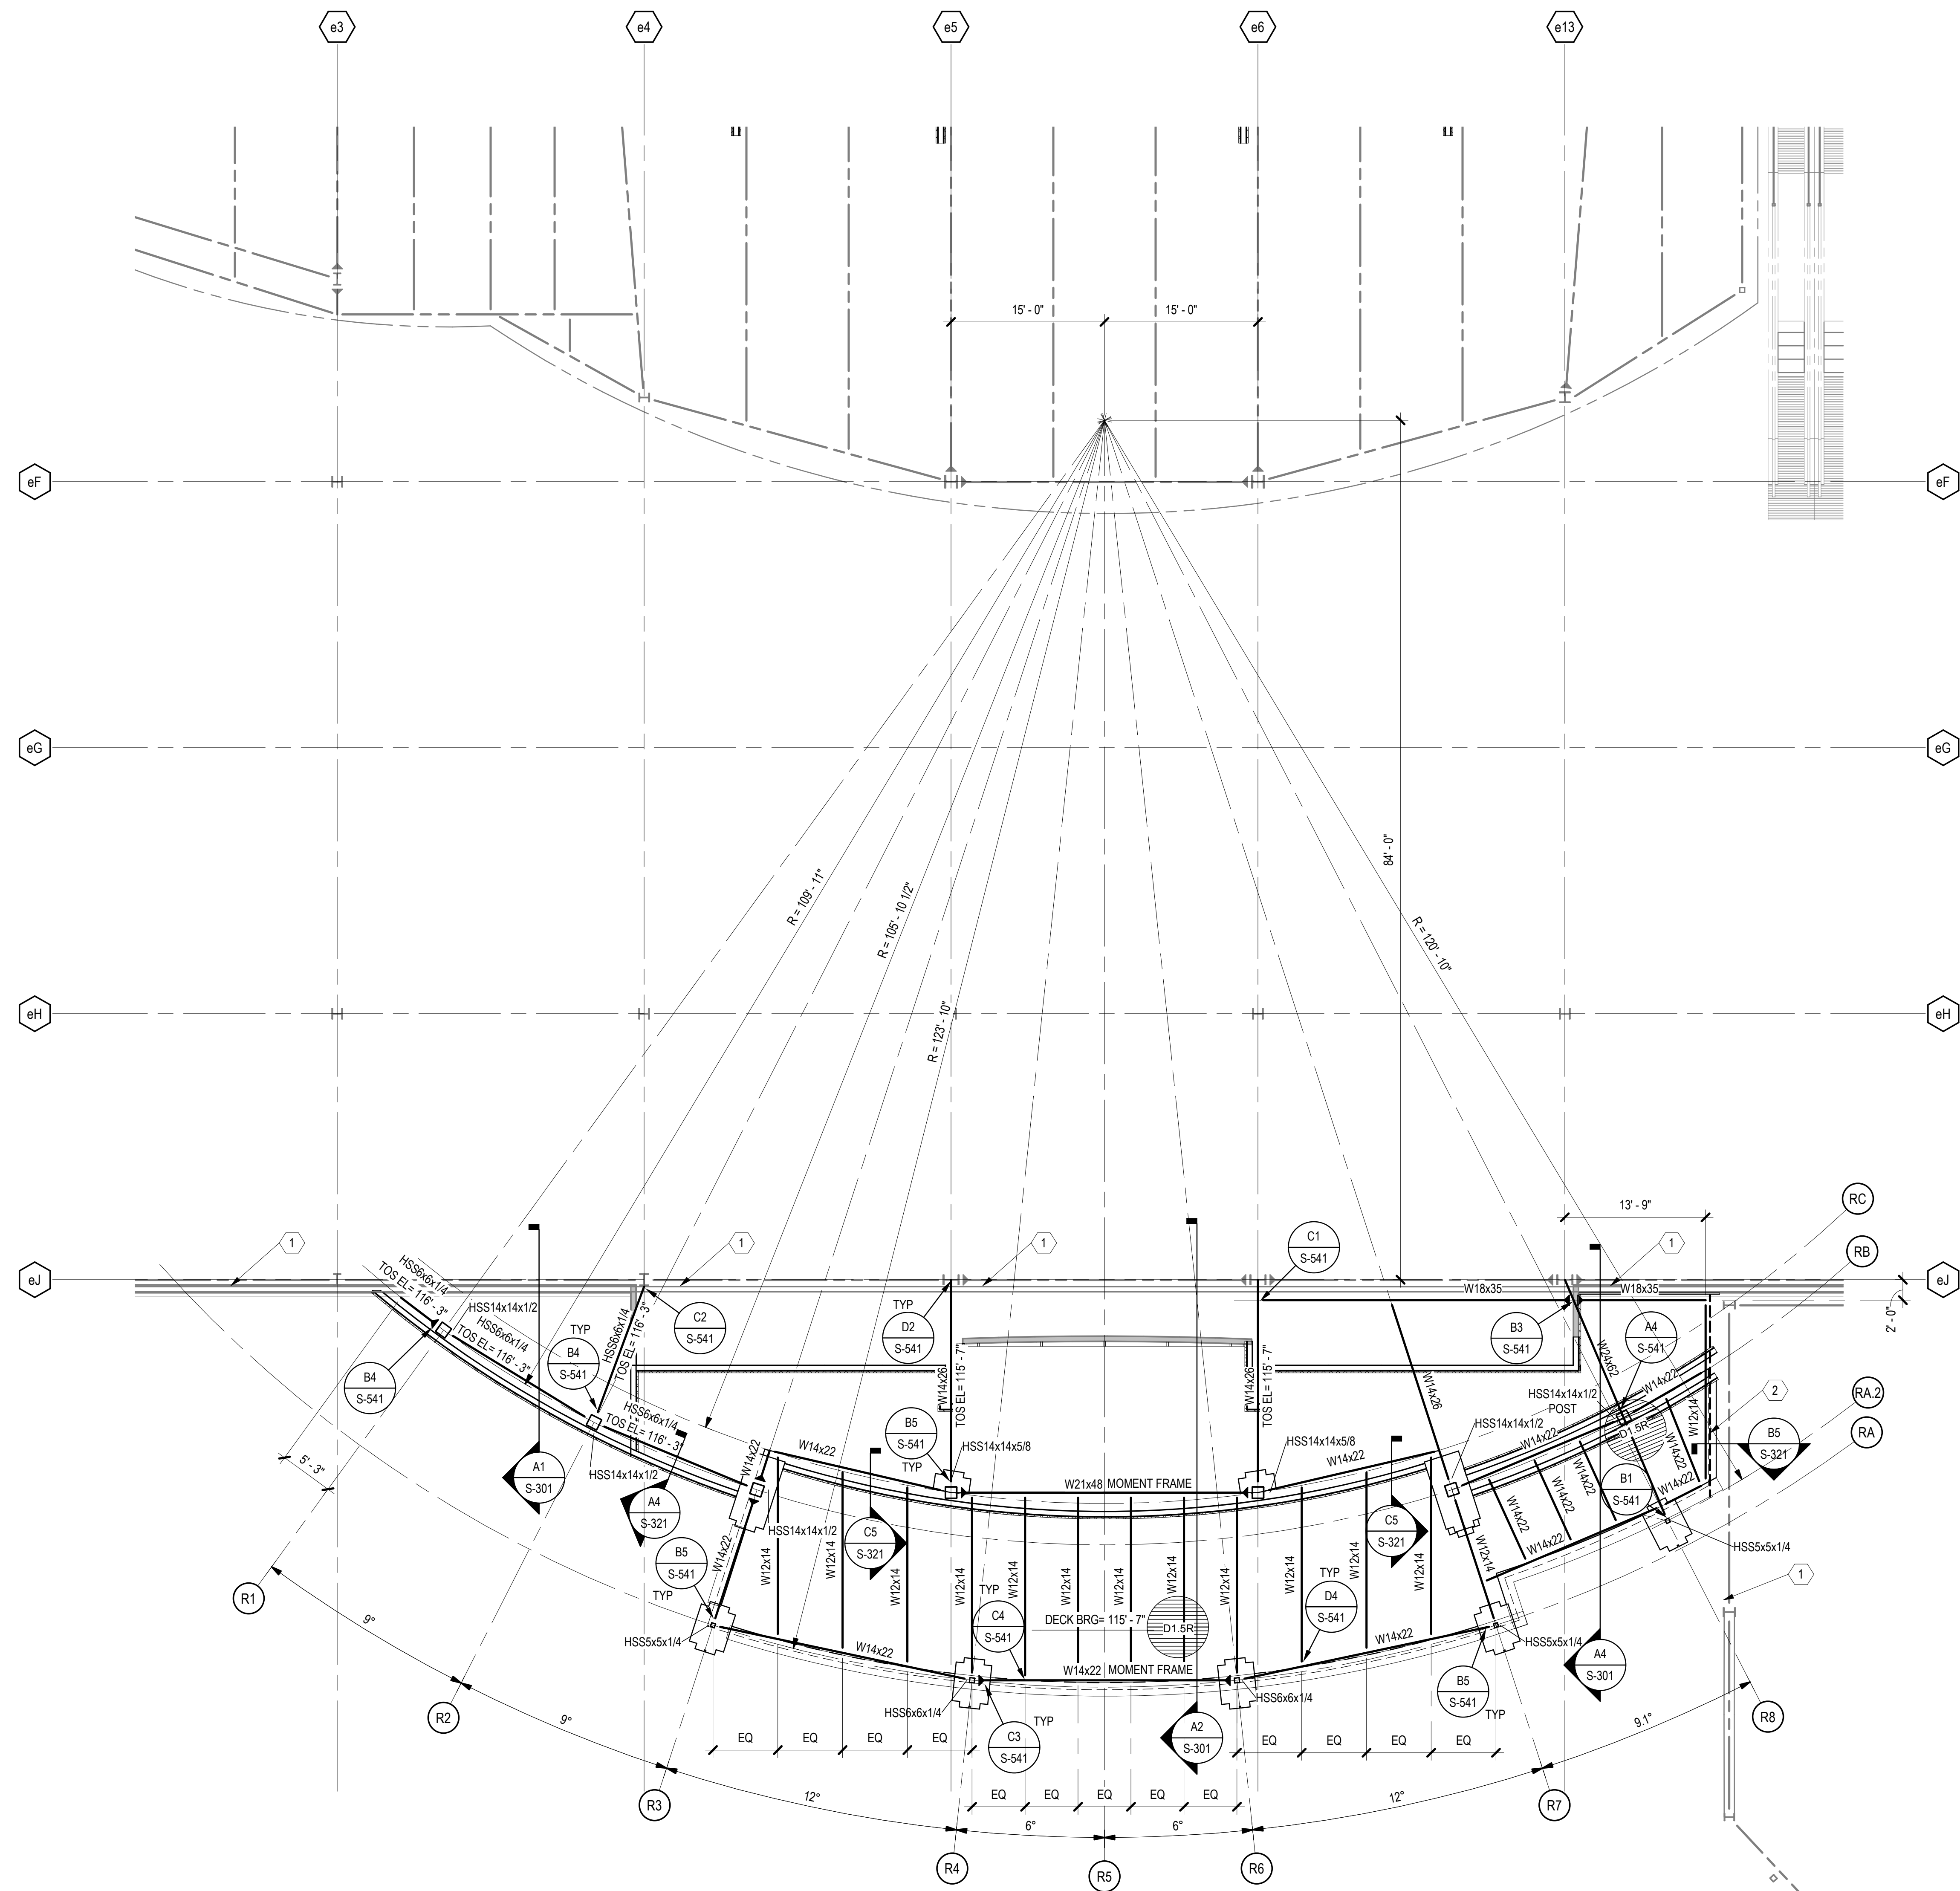

A1 LOW ROOF FRAMING PLAN - CASINO 3 ENTRY
SCALE: 1/8" = 1'-0"

GENERAL SHEET NOTES

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- NOTE TO ERECTOR: LATERAL STABILITY OF THE STEEL FRAME IS DEPENDENT UPON THE MOMENT FRAMES. THE ERECTOR SHALL PROVIDE TEMPORARY BRACING OF THE STEEL FRAME IN ACCORDANCE WITH SECTION 7.10 OF THE AISC CODE OF STANDARD PRACTICES.
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- BEAMS ARE SPACED EQUALLY BETWEEN SUPPORTS, UNLESS NOTED OTHERWISE.
- STRUCTURAL COLD FORMED METAL STUDS SHALL BE 6" STUDS, DESIGNED BY OTHERS.
- SEE SHEET S-321 FOR TYPICAL ROOF FRAMING SECTIONS.
- SEE SHEET S-711 THRU S-741 FOR TYPICAL DETAILS.
- SEE SHEET S-541 FOR TYPICAL FRAMING DETAILS.
- SEE SHEET S-601 FOR SCHEDULES.

SHEET KEYNOTE

- EXISTING WALL AND FRAMING TO REMAIN.
- 4" BUILDING EXPANSION JOINT.



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60 Lakefront Boulevard
Suite 320
Buffalo, NY 14202

EXTERIOR FACADE RENOVATION



No.	Description	Date


LOCA ROOF FRAMING PLAN - CASINO 3 ENTRY

PROGRESS SET

PROJ: H11018.01
DRAWN: J. ANDERSON
CHECKED: C. ROMERO
DATE: 01/16/2019

S-102
Scale: As Indicated

CHEROKEE HARD ROCK HOTEL & CASINO

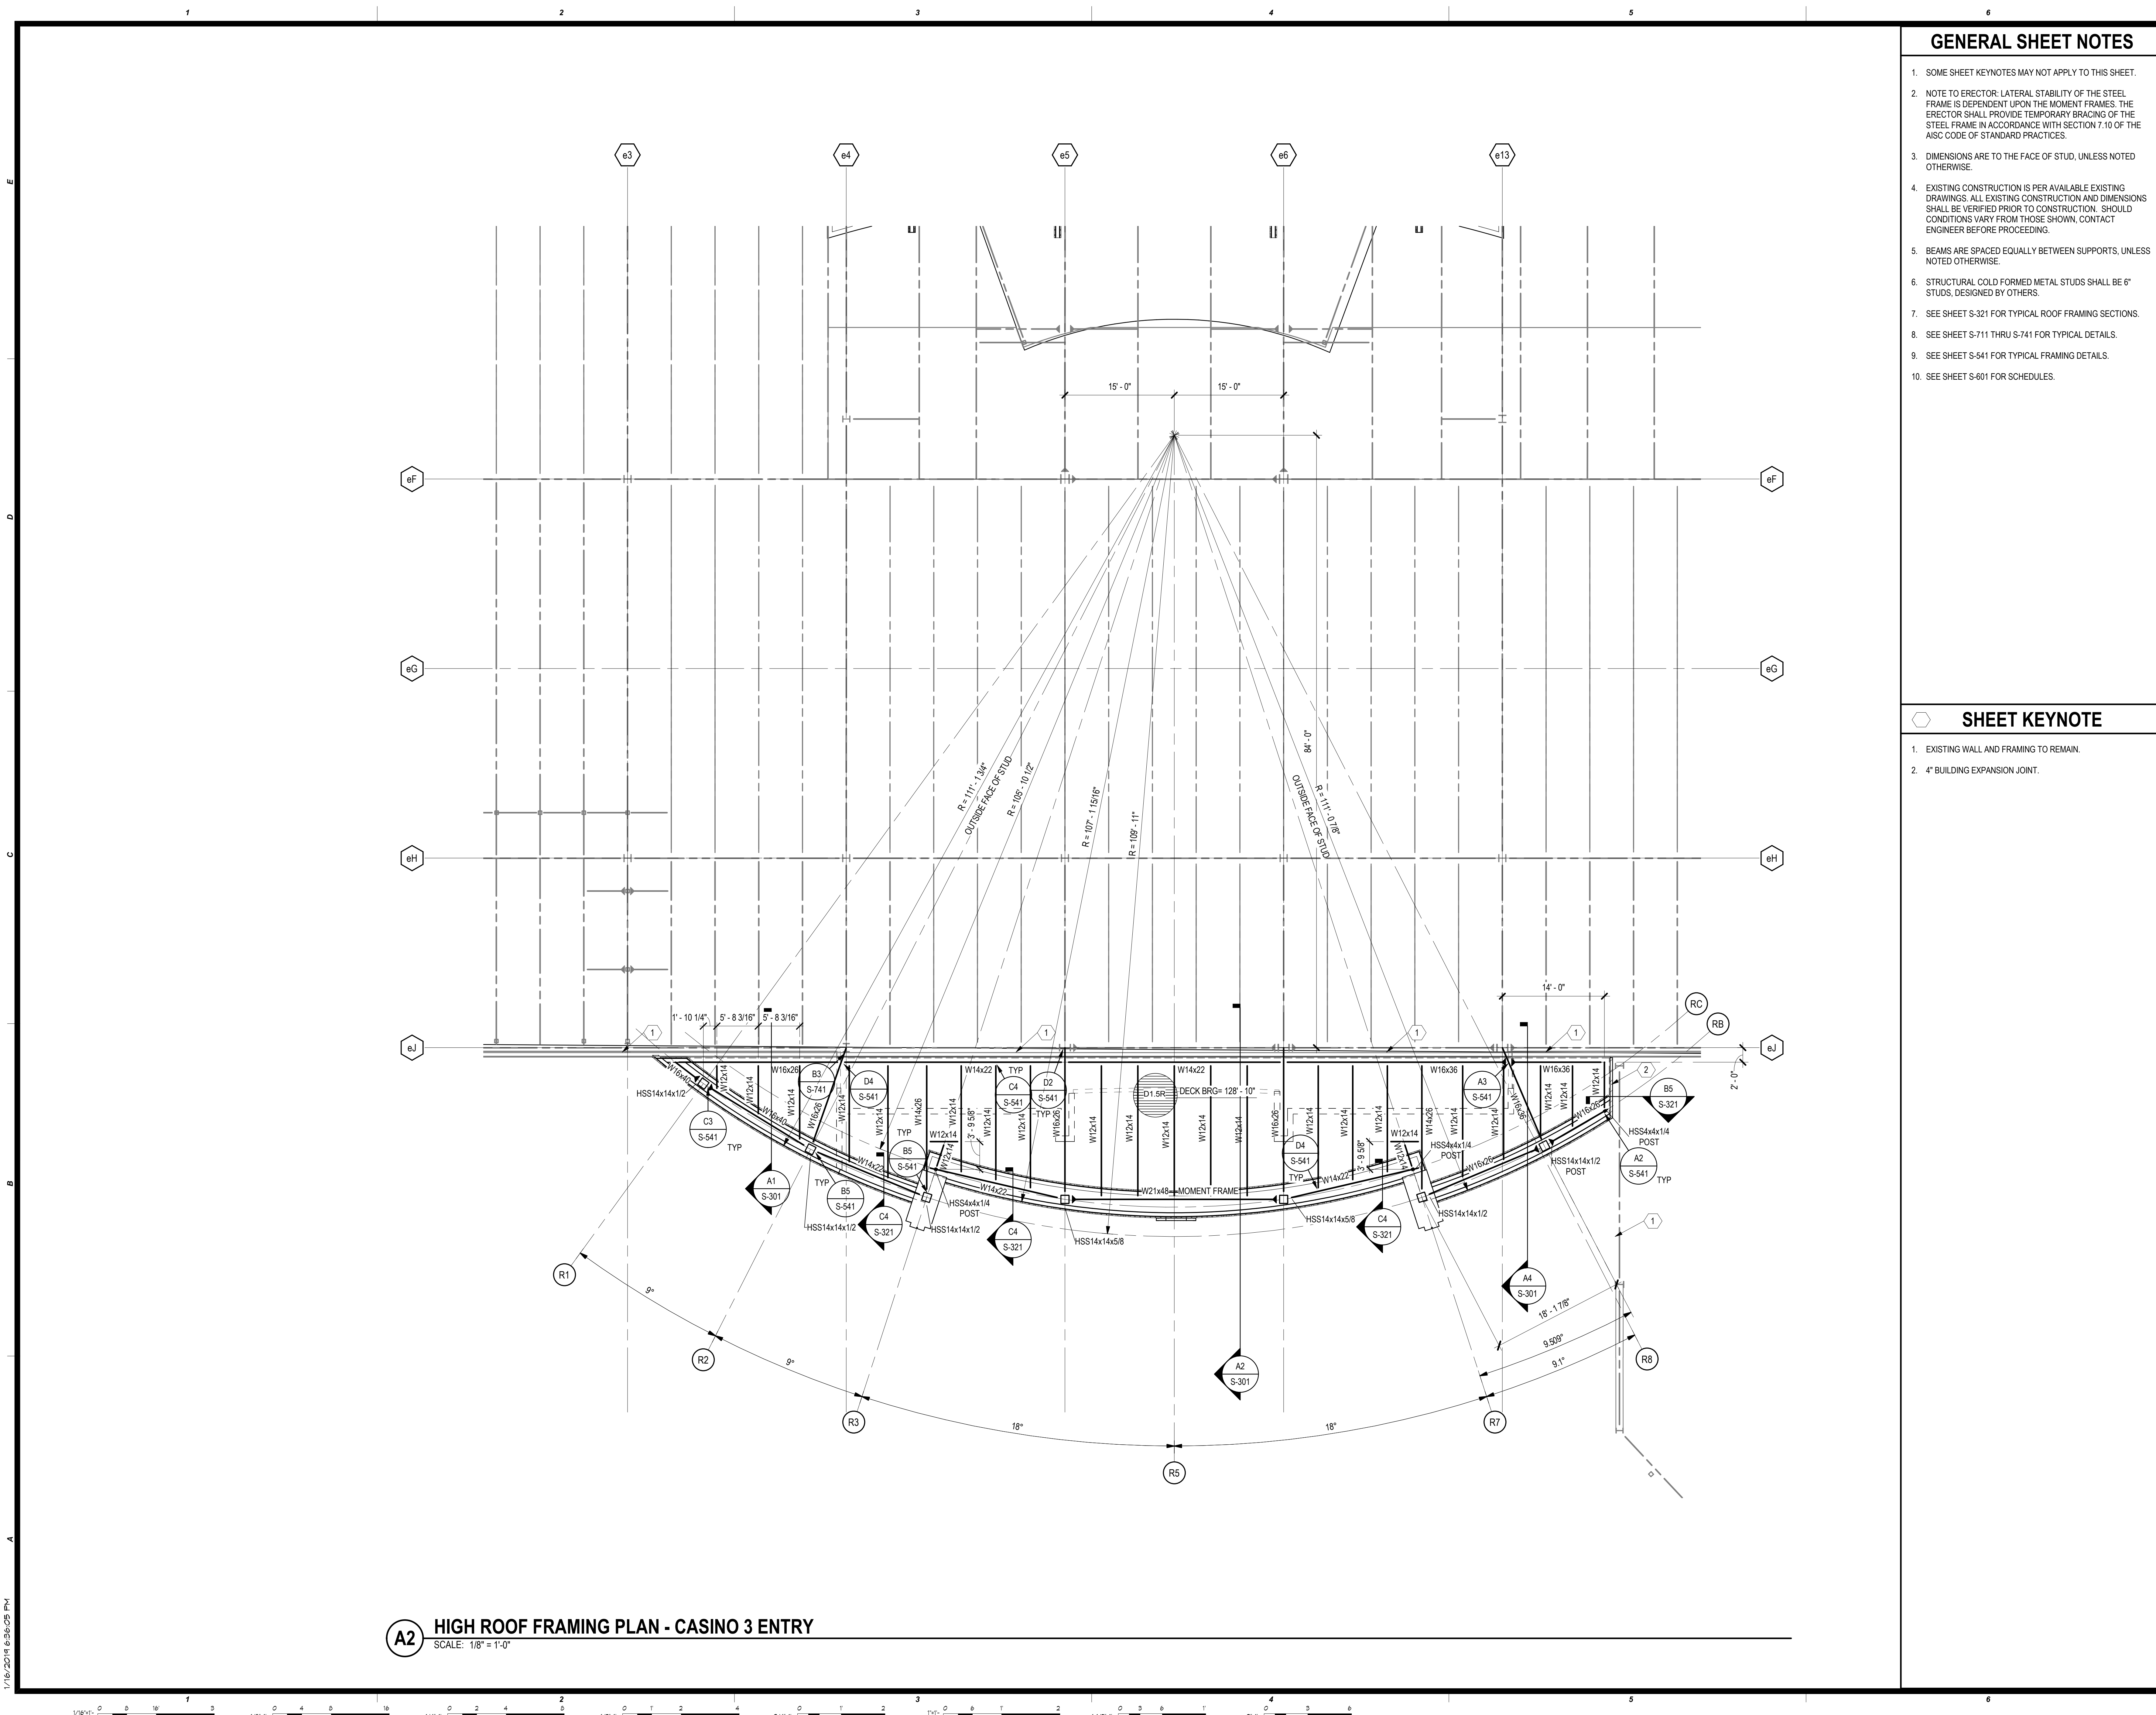

GENERAL SHEET NOTES

1. SOME SHEET KEYNOTES MAY NOT APPLY TO THIS SHEET.
2. NOTE TO ERECTOR: LATERAL STABILITY OF THE STEEL FRAME IS DEPENDENT UPON THE MOMENT FRAMES. THE ERECTOR SHALL PROVIDE TEMPORARY BRACING OF THE STEEL FRAME IN ACCORDANCE WITH SECTION 7.10 OF THE AISC CODE OF STANDARD PRACTICES.
3. DIMENSIONS ARE TO THE FACE OF STUD, UNLESS NOTED OTHERWISE.
4. EXISTING CONSTRUCTION IS PER AVAILABLE EXISTING DRAWINGS. ALL EXISTING CONSTRUCTION AND DIMENSIONS SHALL BE VERIFIED PRIOR TO CONSTRUCTION. SHOULD CONDITIONS VARY FROM THOSE SHOWN, CONTACT ENGINEER BEFORE PROCEEDING.
5. BEAMS ARE SPACED EQUALLY BETWEEN SUPPORTS, UNLESS NOTED OTHERWISE.
6. STRUCTURAL COLD FORMED METAL STUDS SHALL BE 6" STUDS, DESIGNED BY OTHERS.
7. SEE SHEET S-321 FOR TYPICAL ROOF FRAMING SECTIONS.
8. SEE SHEET S-711 THRU S-741 FOR FRAMING DETAILS.
9. SEE SHEET S-541 FOR TYPICAL FRAMING DETAILS.
10. SEE SHEET S-601 FOR SCHEDULES.

**ERA
EDMONDSON REED
& ASSOCIATES**
A NATIVE AMERICAN OWNER DESIGN FIRM

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Fax: (918) 278-

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918-234-7596

LOW VOLTAGE / THEME LIGHTING
M/E Engineers
80 Lakelwood Boulevard
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Buffalo, NY 14202

SHEET KEYNOTE

1. EXISTING WALL AND FRAMING TO REMAIN.
2. 4" BUILDING EXPANSION JOINT.

A2 HIGH ROOF FRAMING PLAN - CASINO 3 ENTRY
SCALE: 1/8" = 1'-0"

EXTERIOR FACADE RENOVATION


No.	Description	Date

PROJ: H11019.01
DATE: J. ANDERSON
C.D.: C. ROMERO
DATE: 01/16/2019

PROFESSIONAL ENGINEER
CHRIS S. ROMERO
23578
OKLAHOMA 1/16/19

S-103
Scale: As Indicated

Cherokee Hard Rock Hotel & Casino

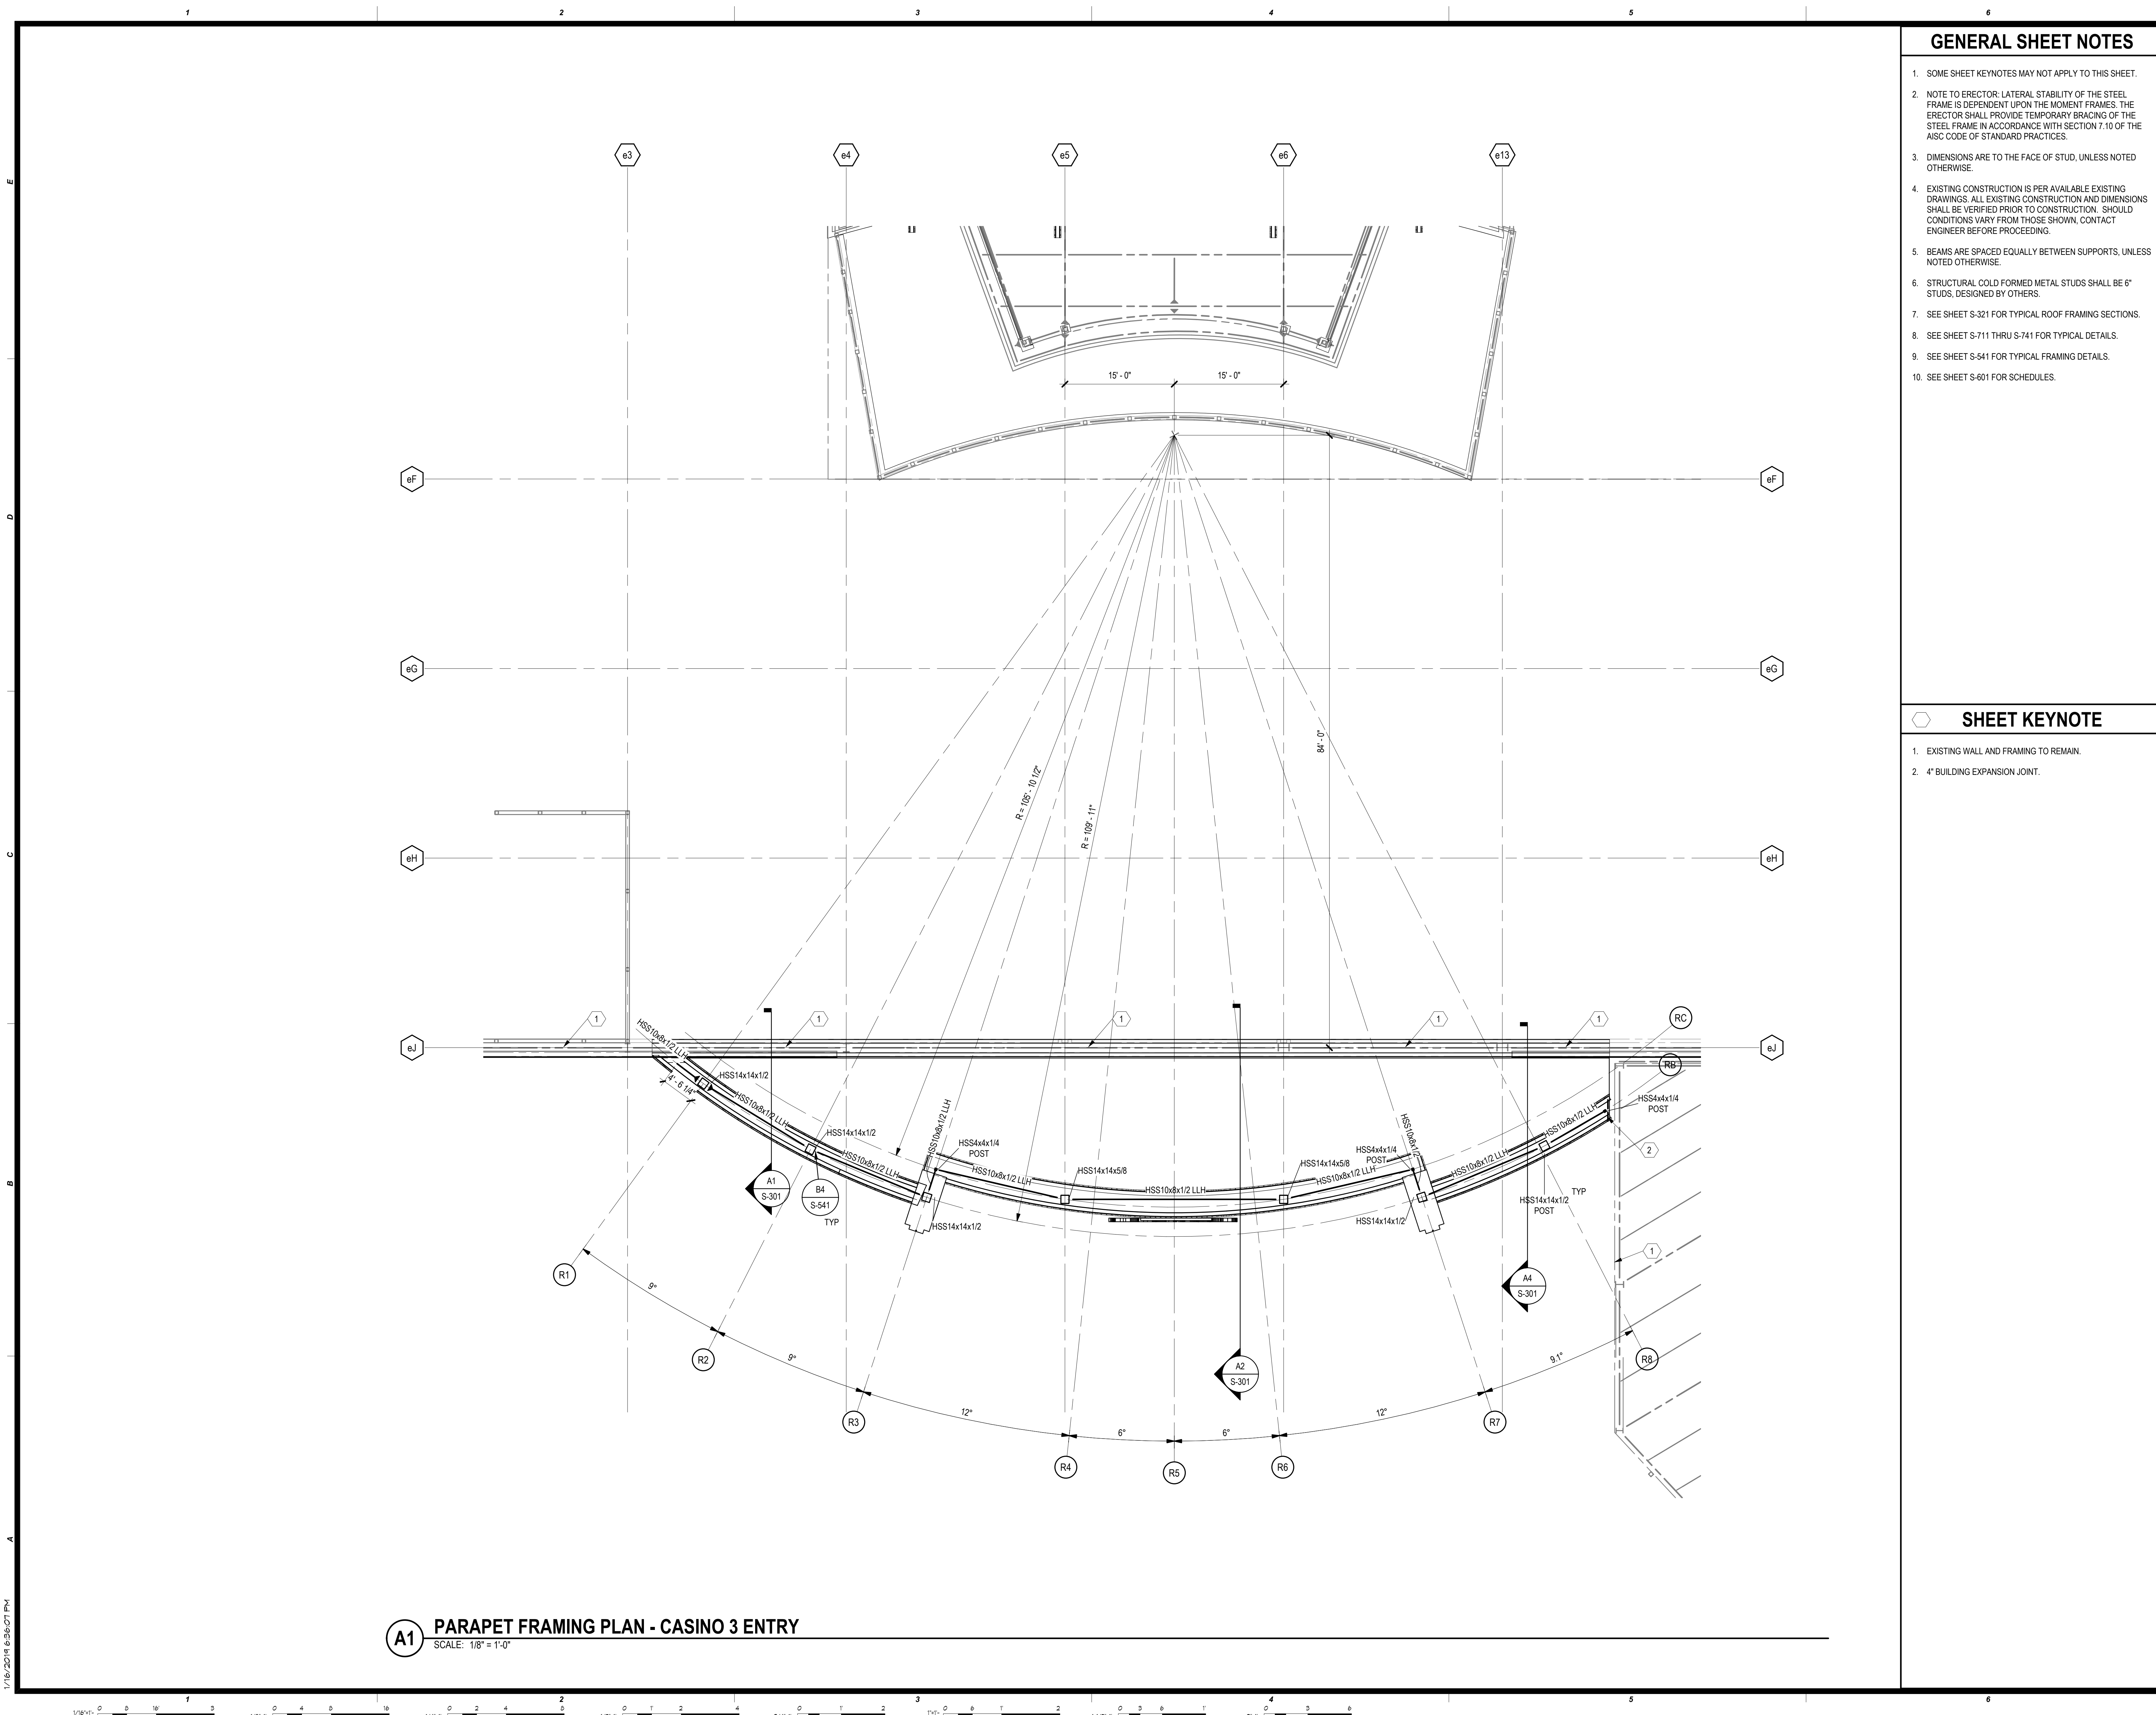

GENERAL SHEET NOTES

- SOME SHEET KEYNOTES MAY NOT APPLY TO THIS SHEET.
- NOTE TO ERECTOR: LATERAL STABILITY OF THE STEEL FRAME IS DEPENDENT UPON THE MOMENT FRAMES. THE ERECTOR SHALL PROVIDE TEMPORARY BRACING OF THE STEEL FRAME IN ACCORDANCE WITH SECTION 7.10 OF THE AISC CODE OF STANDARD PRACTICES.
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- BEAMS ARE SPACED EQUALLY BETWEEN SUPPORTS, UNLESS NOTED OTHERWISE.
- STRUCTURAL COLD FORMED METAL STUDS SHALL BE 6" STUDS, DESIGNED BY OTHERS.
- SEE SHEET S-321 FOR TYPICAL ROOF FRAMING SECTIONS.
- SEE SHEET S-711 THRU S-741 FOR TYPICAL DETAILS.
- SEE SHEET S-541 FOR TYPICAL FRAMING DETAILS.
- SEE SHEET S-601 FOR SCHEDULES.

SHEET KEYNOTE

- EXISTING WALL AND FRAMING TO REMAIN.
- 4' BUILDING EXPANSION JOINT.



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MBA Engineering Consultants
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M/E Engineers
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Cherokee Hard Rock Hotel & Casino

EXTERIOR FACADE RENOVATION

No.	Description	Date


A1 PARAPET FRAMING PLAN - CASINO 3 ENTRY
SCALE: 1/8" = 1'-0"

PROJ: 111018.01
SHEET: PARAPET FRAMING PLAN - CASINO 3 ENTRY
DATE: 01/16/2019
PROG: SET

PROJ: 111018.01
DRAWN: J. ANDERSON
CHECKED: C. ROMERO
DATE: 01/16/2019

PROF: MORIS B. ROMERO
23578
OKLAHOMA
7/16/19

S-104
Scale: As Indicated

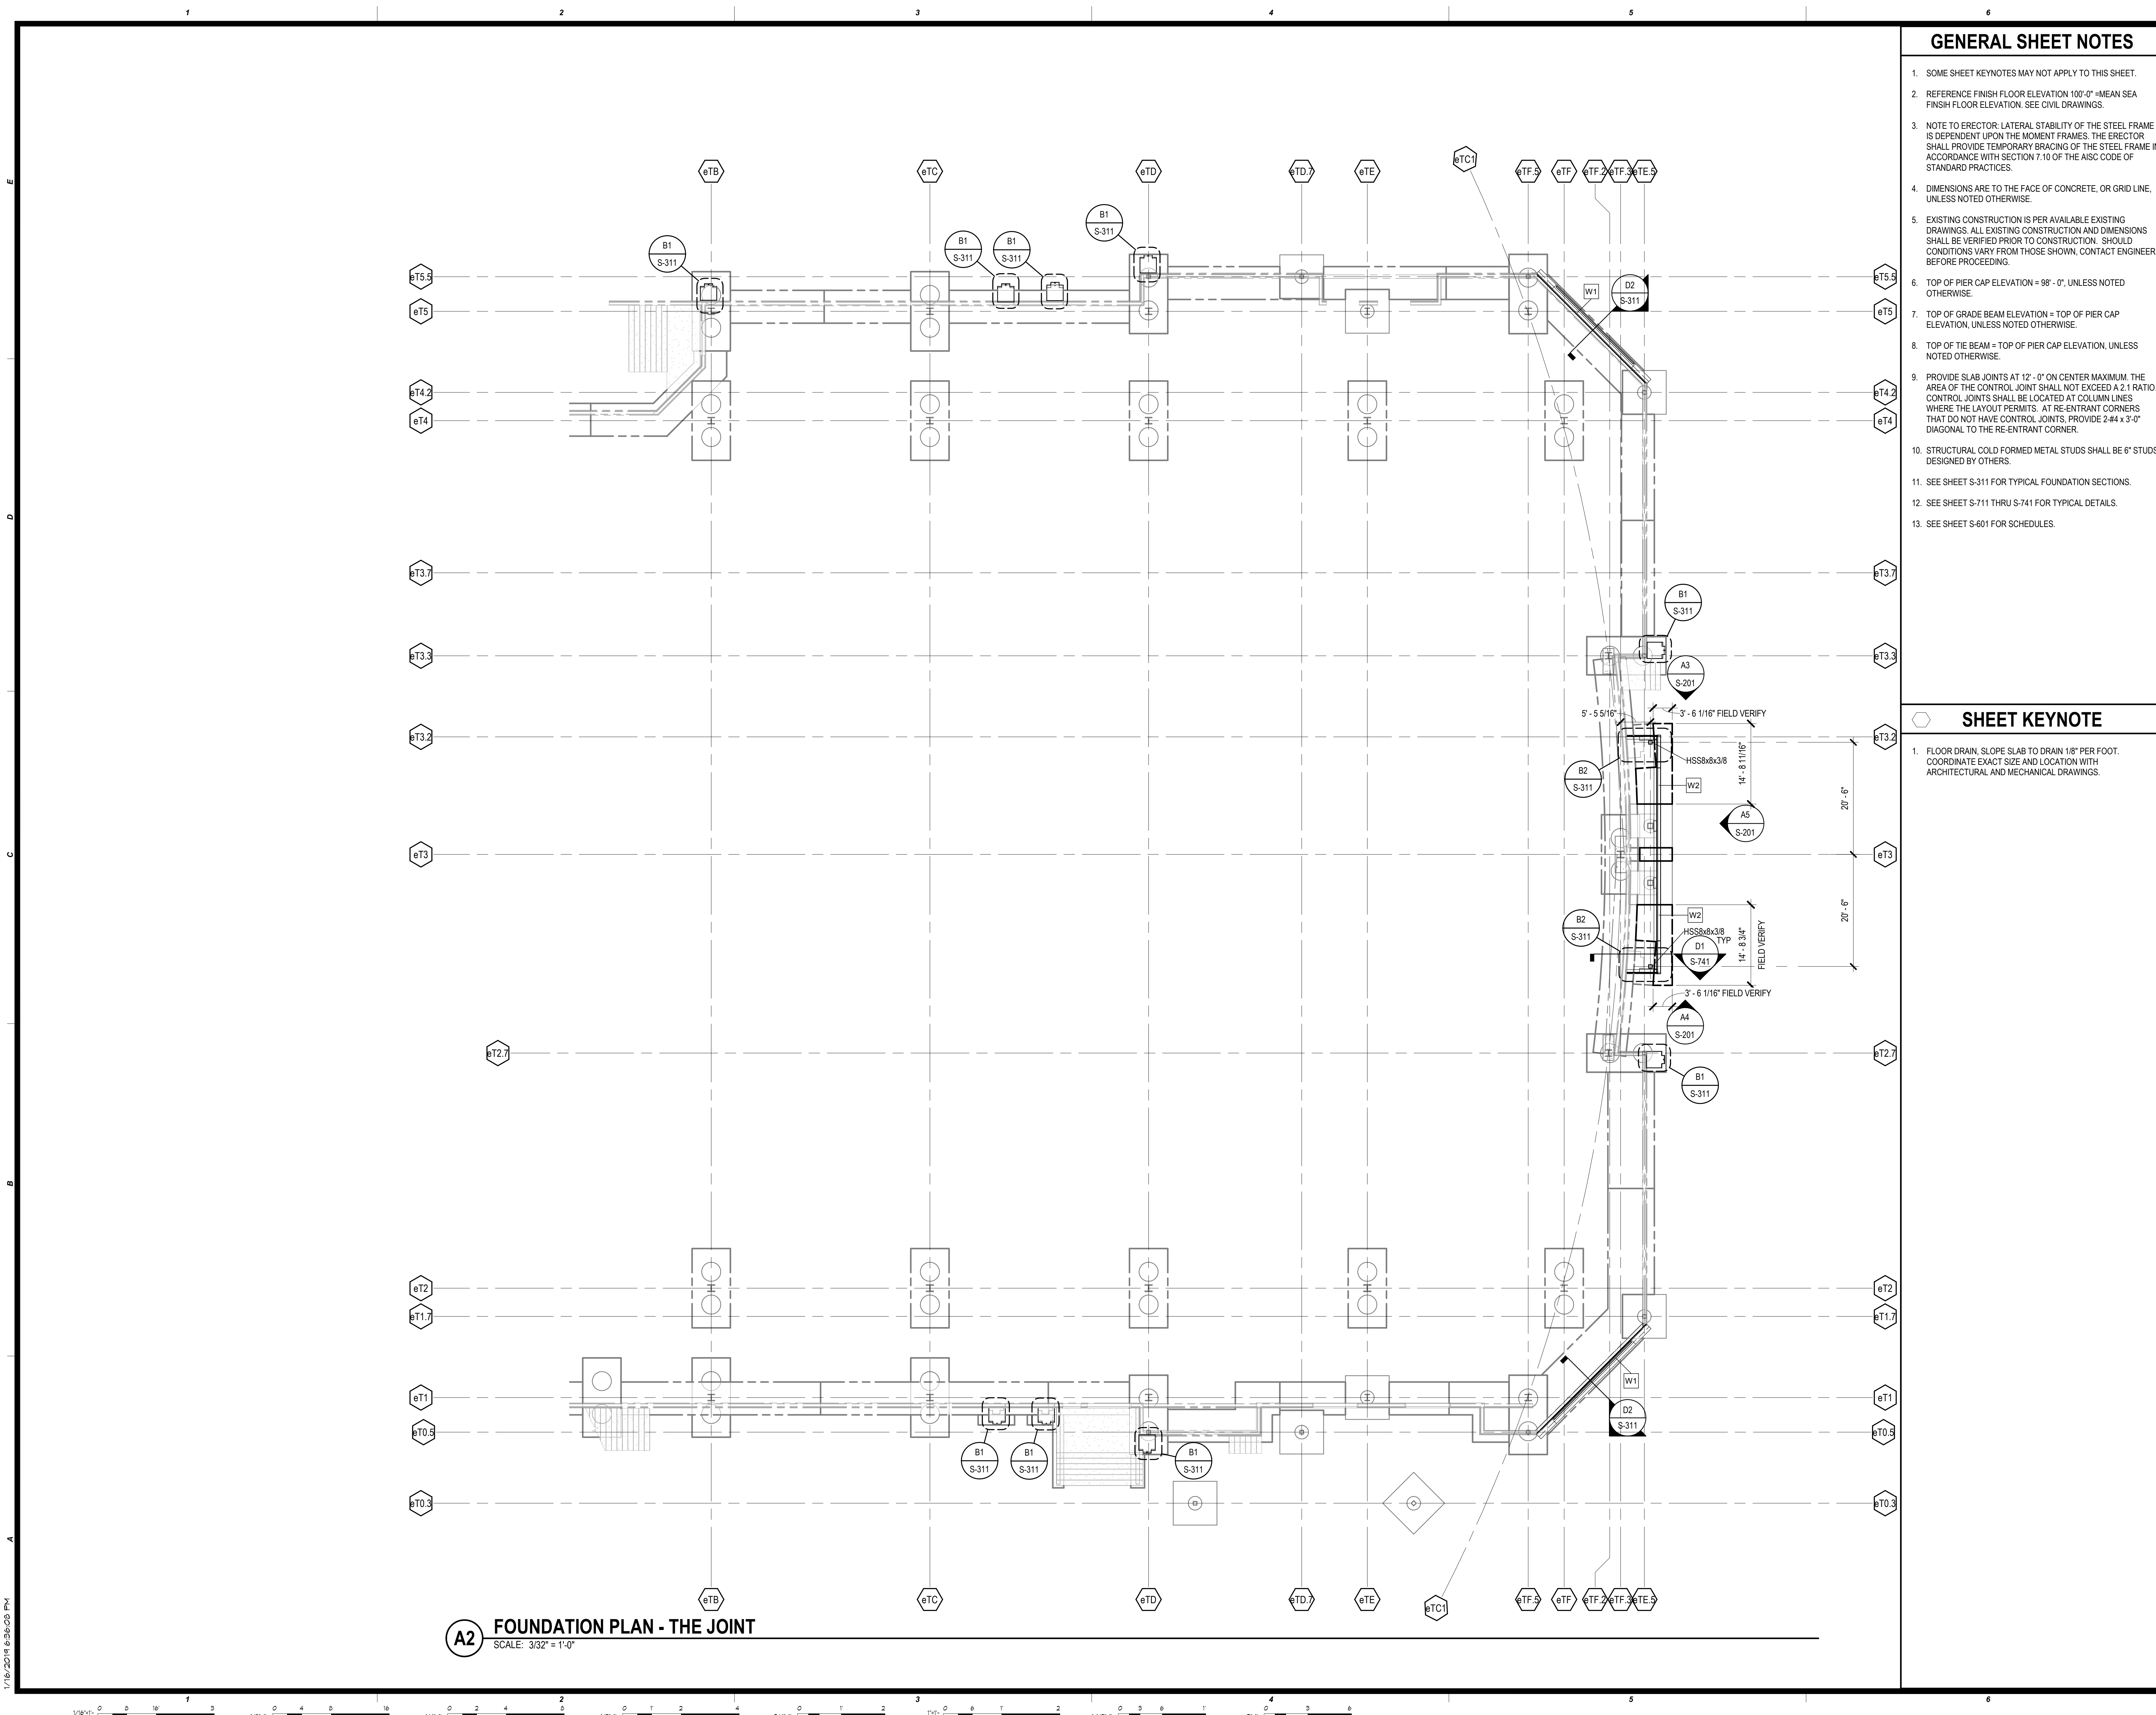

GENERAL SHEET NOTES

- SOME SHEET KEYNOTES MAY NOT APPLY TO THIS SHEET.
- REFERENCE FINISH FLOOR ELEVATION 100'-0" = MEAN SEA FINISH FLOOR ELEVATION. SEE CIVIL DRAWINGS.
- NOTE TO ERECTOR: LATERAL STABILITY OF THE STEEL FRAME IS DEPENDENT UPON THE MOMENT FRAMES. THE ERECTOR SHALL PROVIDE TEMPORARY BRACING OF THE STEEL FRAME IN ACCORDANCE WITH SECTION 7.10 OF THE AISC CODE OF STANDARD PRACTICES.
- DIMENSIONS ARE TO THE FACE OF CONCRETE, OR GRID LINE, UNLESS NOTED OTHERWISE.
- EXISTING CONSTRUCTION IS PER AVAILABLE EXISTING DRAWINGS. ALL EXISTING CONSTRUCTION AND DIMENSIONS SHALL BE VERIFIED PRIOR TO CONSTRUCTION. SHOULD CONDITIONS VARY FROM THOSE SHOWN, CONTACT ENGINEER BEFORE PROCEEDING.
- TOP OF PIER CAP ELEVATION = 98'-0", UNLESS NOTED OTHERWISE.
- TOP OF GRADE BEAM ELEVATION = TOP OF PIER CAP ELEVATION, UNLESS NOTED OTHERWISE.
- TOP OF THE BEAM = TOP OF PIER CAP ELEVATION, UNLESS NOTED OTHERWISE.
- PROVIDE SLAB JOINTS AT 12'-0" ON CENTER MAXIMUM. THE AREA OF THE CONTROL JOINT SHALL NOT EXCEED A 2:1 RATIO. CONTROL JOINTS SHALL BE LOCATED AT COLUMN LINES WHERE THE LAYOUT PERMITS. AT RE-ENTRANT CORNERS THAT DO NOT HAVE CONTROL JOINTS, PROVIDE 2# x 3'-0" DIAGONAL TO THE RE-ENTRANT CORNER.
- STRUCTURAL COLD FORMED METAL STUDS SHALL BE 6" STUDS, DESIGNED BY OTHERS.
- SEE SHEET S-311 FOR TYPICAL FOUNDATION SECTIONS.
- SEE SHEET S-711 THRU S-741 FOR TYPICAL DETAILS.
- SEE SHEET S-601 FOR SCHEDULES.

SHEET KEYNOTE

- FLOOR DRAIN, SLOPE SLAB TO DRAIN 1/8" PER FOOT. COORDINATE EXACT SIZE AND LOCATION WITH ARCHITECTURAL AND MECHANICAL DRAWINGS.



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 918-254-7596
- LOW VOLTAGE / THEME LIGHTING**
 M/E Engineers
 60 Lakewood Boulevard
 Suite 320
 Buffalo, NY 14202

EXTERIOR FACADE RENOVATION



No.	Description	Date

FOUNDATION PLAN - THE JOINT

PROGRESS SET

A2 FOUNDATION PLAN - THE JOINT
 SCALE: 3/32" = 1'-0"


PROJ: H11018.01
 DRAWN: J. ANDERSON
 CHECK: C. ROMERO
 DATE: 01/16/2019

PROFESSIONAL ENGINEER
 CHRIS S. ROMERO
 23578
 OKLAHOMA

S-111
 Scale: As Indicated

Cherokee Hard Rock Hotel & Casino

1/16/2019 6:36:00 PM

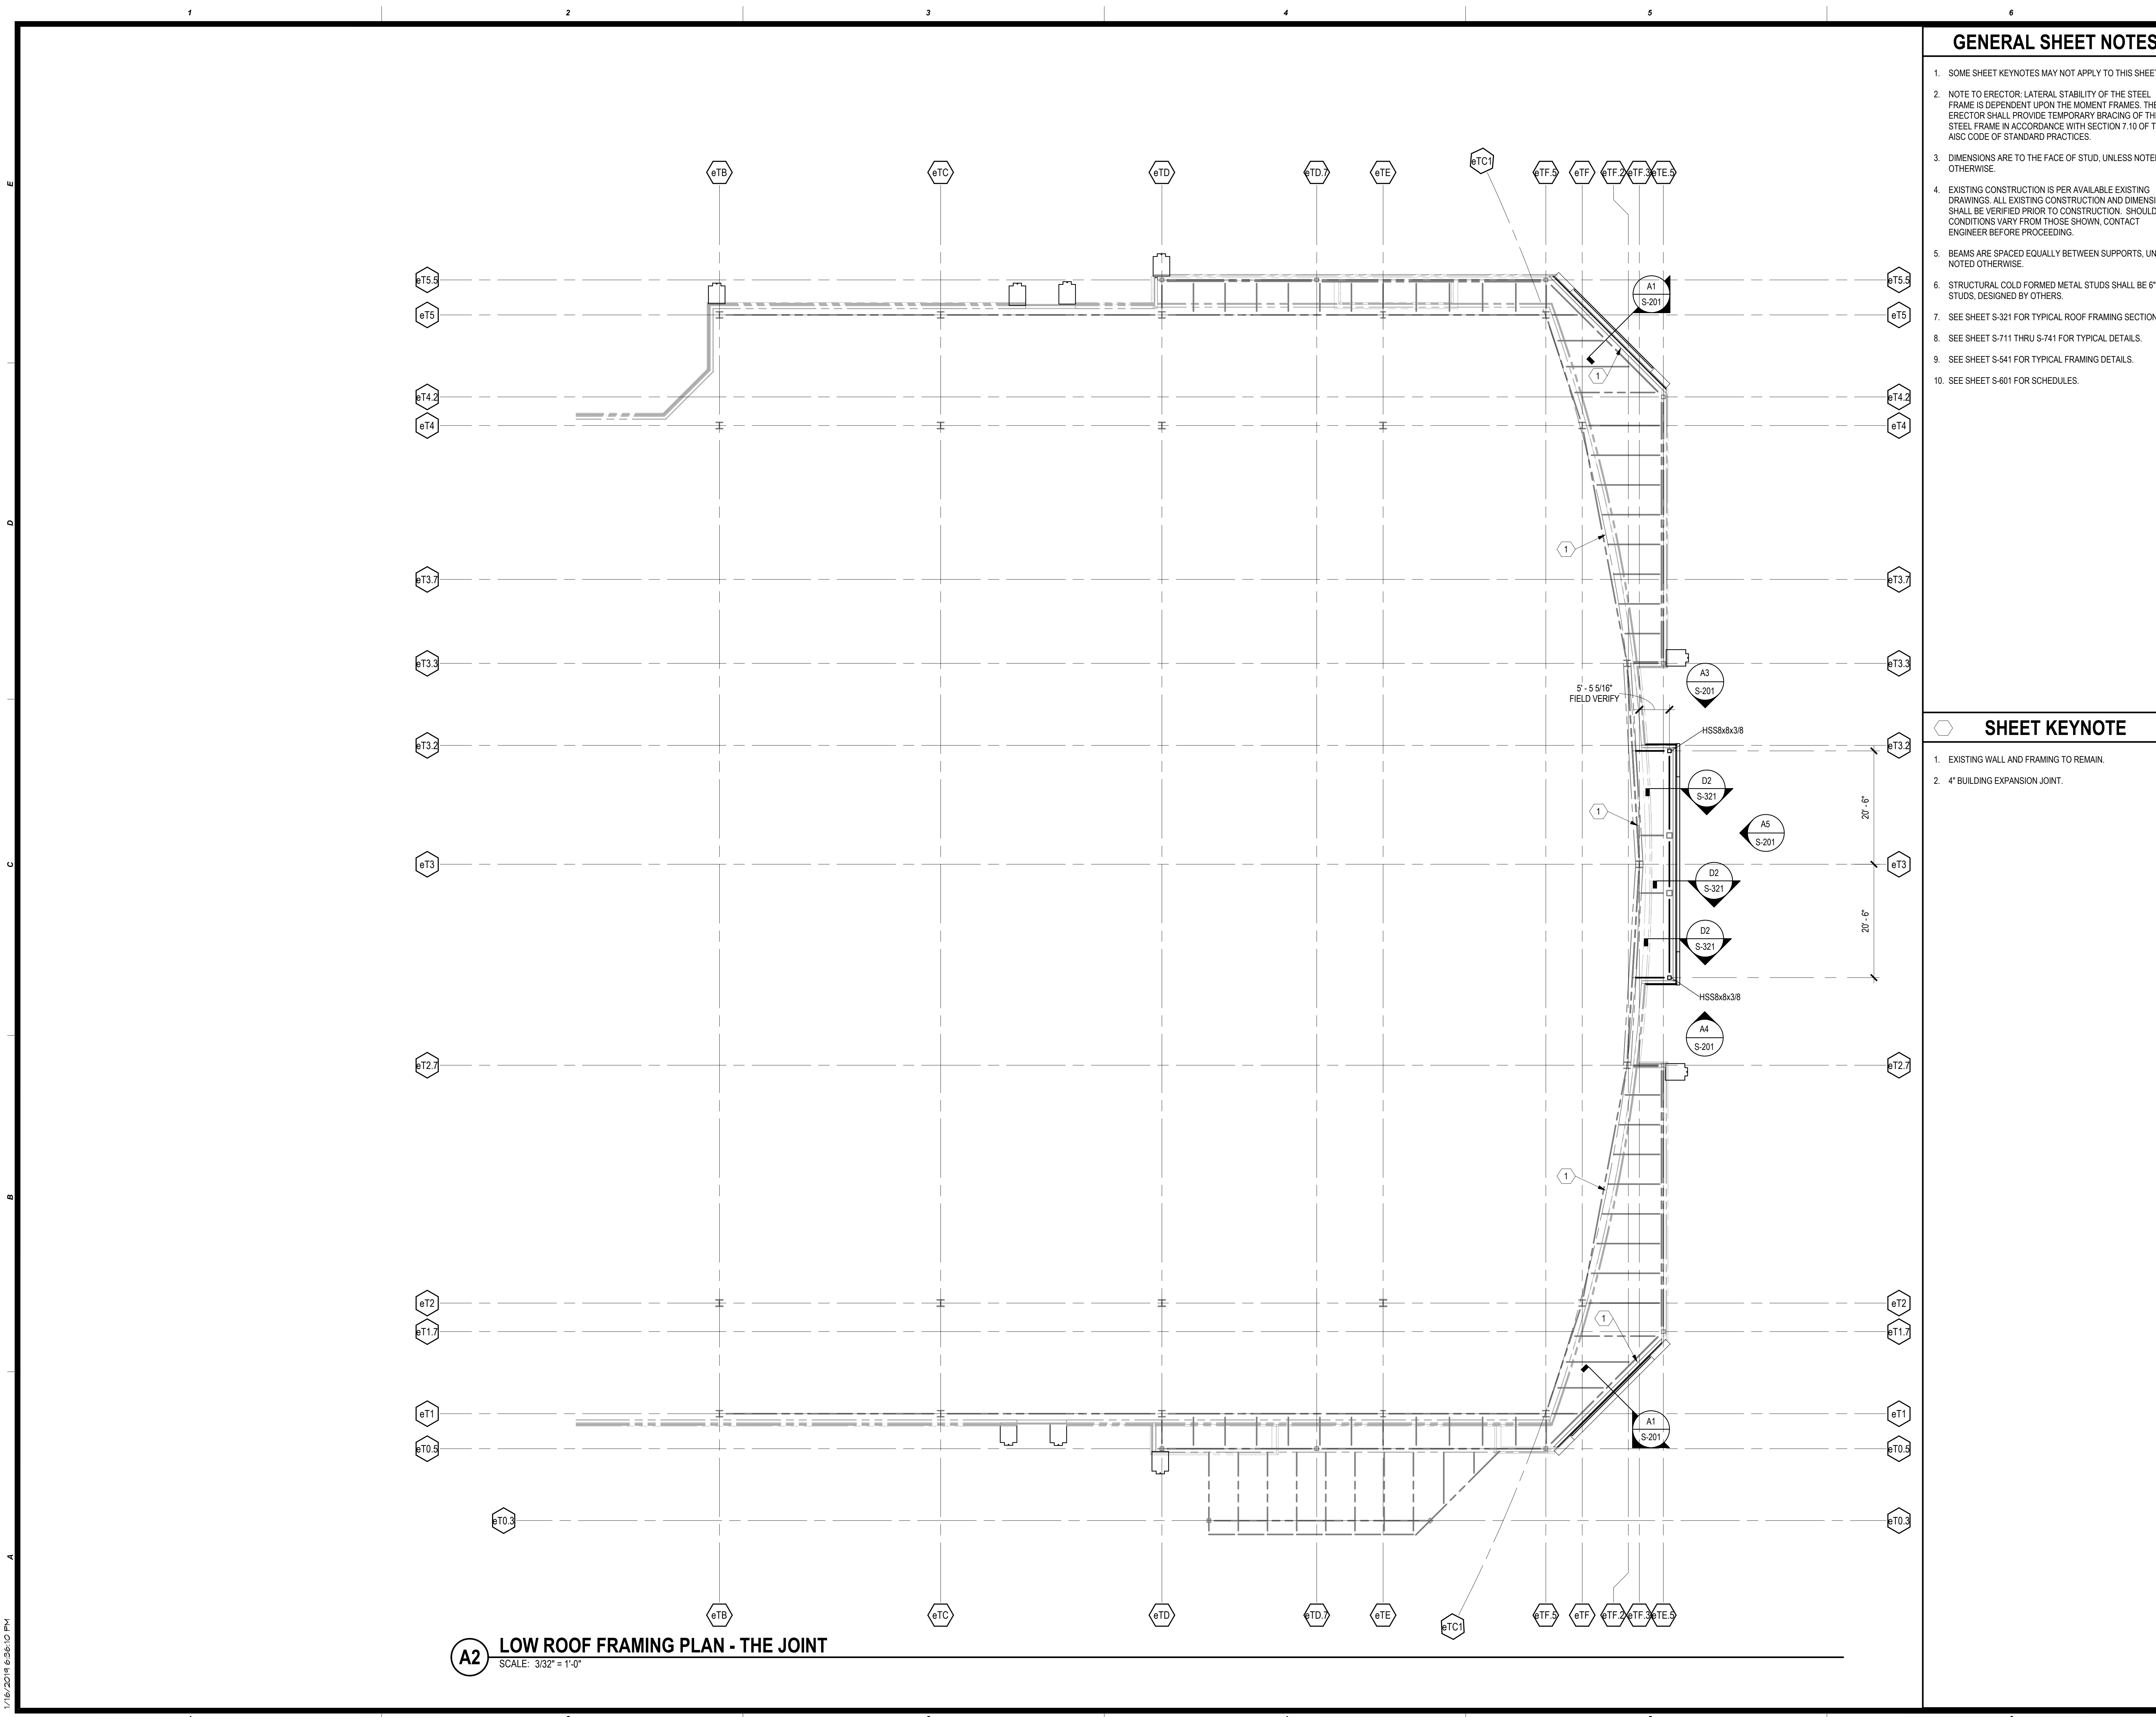

A2 LOW ROOF FRAMING PLAN - THE JOINT
SCALE: 3/32" = 1'-0"

GENERAL SHEET NOTES

- SOME SHEET KEYNOTES MAY NOT APPLY TO THIS SHEET.
- NOTE TO ERECTOR: LATERAL STABILITY OF THE STEEL FRAME IS DEPENDENT UPON THE MOMENT FRAMES. THE ERECTOR SHALL PROVIDE TEMPORARY BRACING OF THE STEEL FRAME IN ACCORDANCE WITH SECTION 7.10 OF THE AISC CODE OF STANDARD PRACTICES.
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- BEAMS ARE SPACED EQUALLY BETWEEN SUPPORTS, UNLESS NOTED OTHERWISE.
- STRUCTURAL COLD FORMED METAL STUDS SHALL BE 6" STUDS, DESIGNED BY OTHERS.
- SEE SHEET S-321 FOR TYPICAL ROOF FRAMING SECTIONS.
- SEE SHEET S-711 THRU S-741 FOR TYPICAL DETAILS.
- SEE SHEET S-541 FOR TYPICAL FRAMING DETAILS.
- SEE SHEET S-601 FOR SCHEDULES.

SHEET KEYNOTE

- EXISTING WALL AND FRAMING TO REMAIN.
- 4" BUILDING EXPANSION JOINT.



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918-254-7546
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M/E Engineers
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EXTERIOR FACADE RENOVATION

KEY

No.	Description	Date

PROJ: H11018.01
 DRAWN: J. ANDERSON
 CHECKED: C. ROMERO
 DATE: 01/16/2019

PROFESSIONAL ENGINEER
 MORIS S. ROMERO
 23578
 OKLAHOMA

S-112
 Scale: As Indicated

1/16/2019 8:10:10 PM

Cherokee Hard Rock Hotel & Casino

GENERAL SHEET NOTES

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- NOTE TO ERECTOR: LATERAL STABILITY OF THE STEEL FRAME IS DEPENDENT UPON THE MOMENT FRAMES. THE ERECTOR SHALL PROVIDE TEMPORARY BRACING OF THE STEEL FRAME IN ACCORDANCE WITH SECTION 7.10 OF THE AISC CODE OF STANDARD PRACTICES.
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- SEE SHEET S-711 THRU S-741 FOR TYPICAL DETAILS.
- SEE SHEET S-641 FOR TYPICAL FRAMING DETAILS.
- SEE SHEET S-601 FOR SCHEDULES.

SHEET KEYNOTE

- EXISTING WALL AND FRAMING TO REMAIN.
- 4" BUILDING EXPANSION JOINT.



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Cherokee Hard Rock Hotel & Casino

EXTERIOR FACADE RENOVATION




No.	Description	Date

MID ROOF FRAMING PLAN - THE JOINT

PROGRESS SET


PROJECT: H11018.01
 DRAWN BY: J. ANDERSON
 CHECKED BY: C. ROMERO
 DATE: 01/16/2019


S-113
 Scale: As Indicated

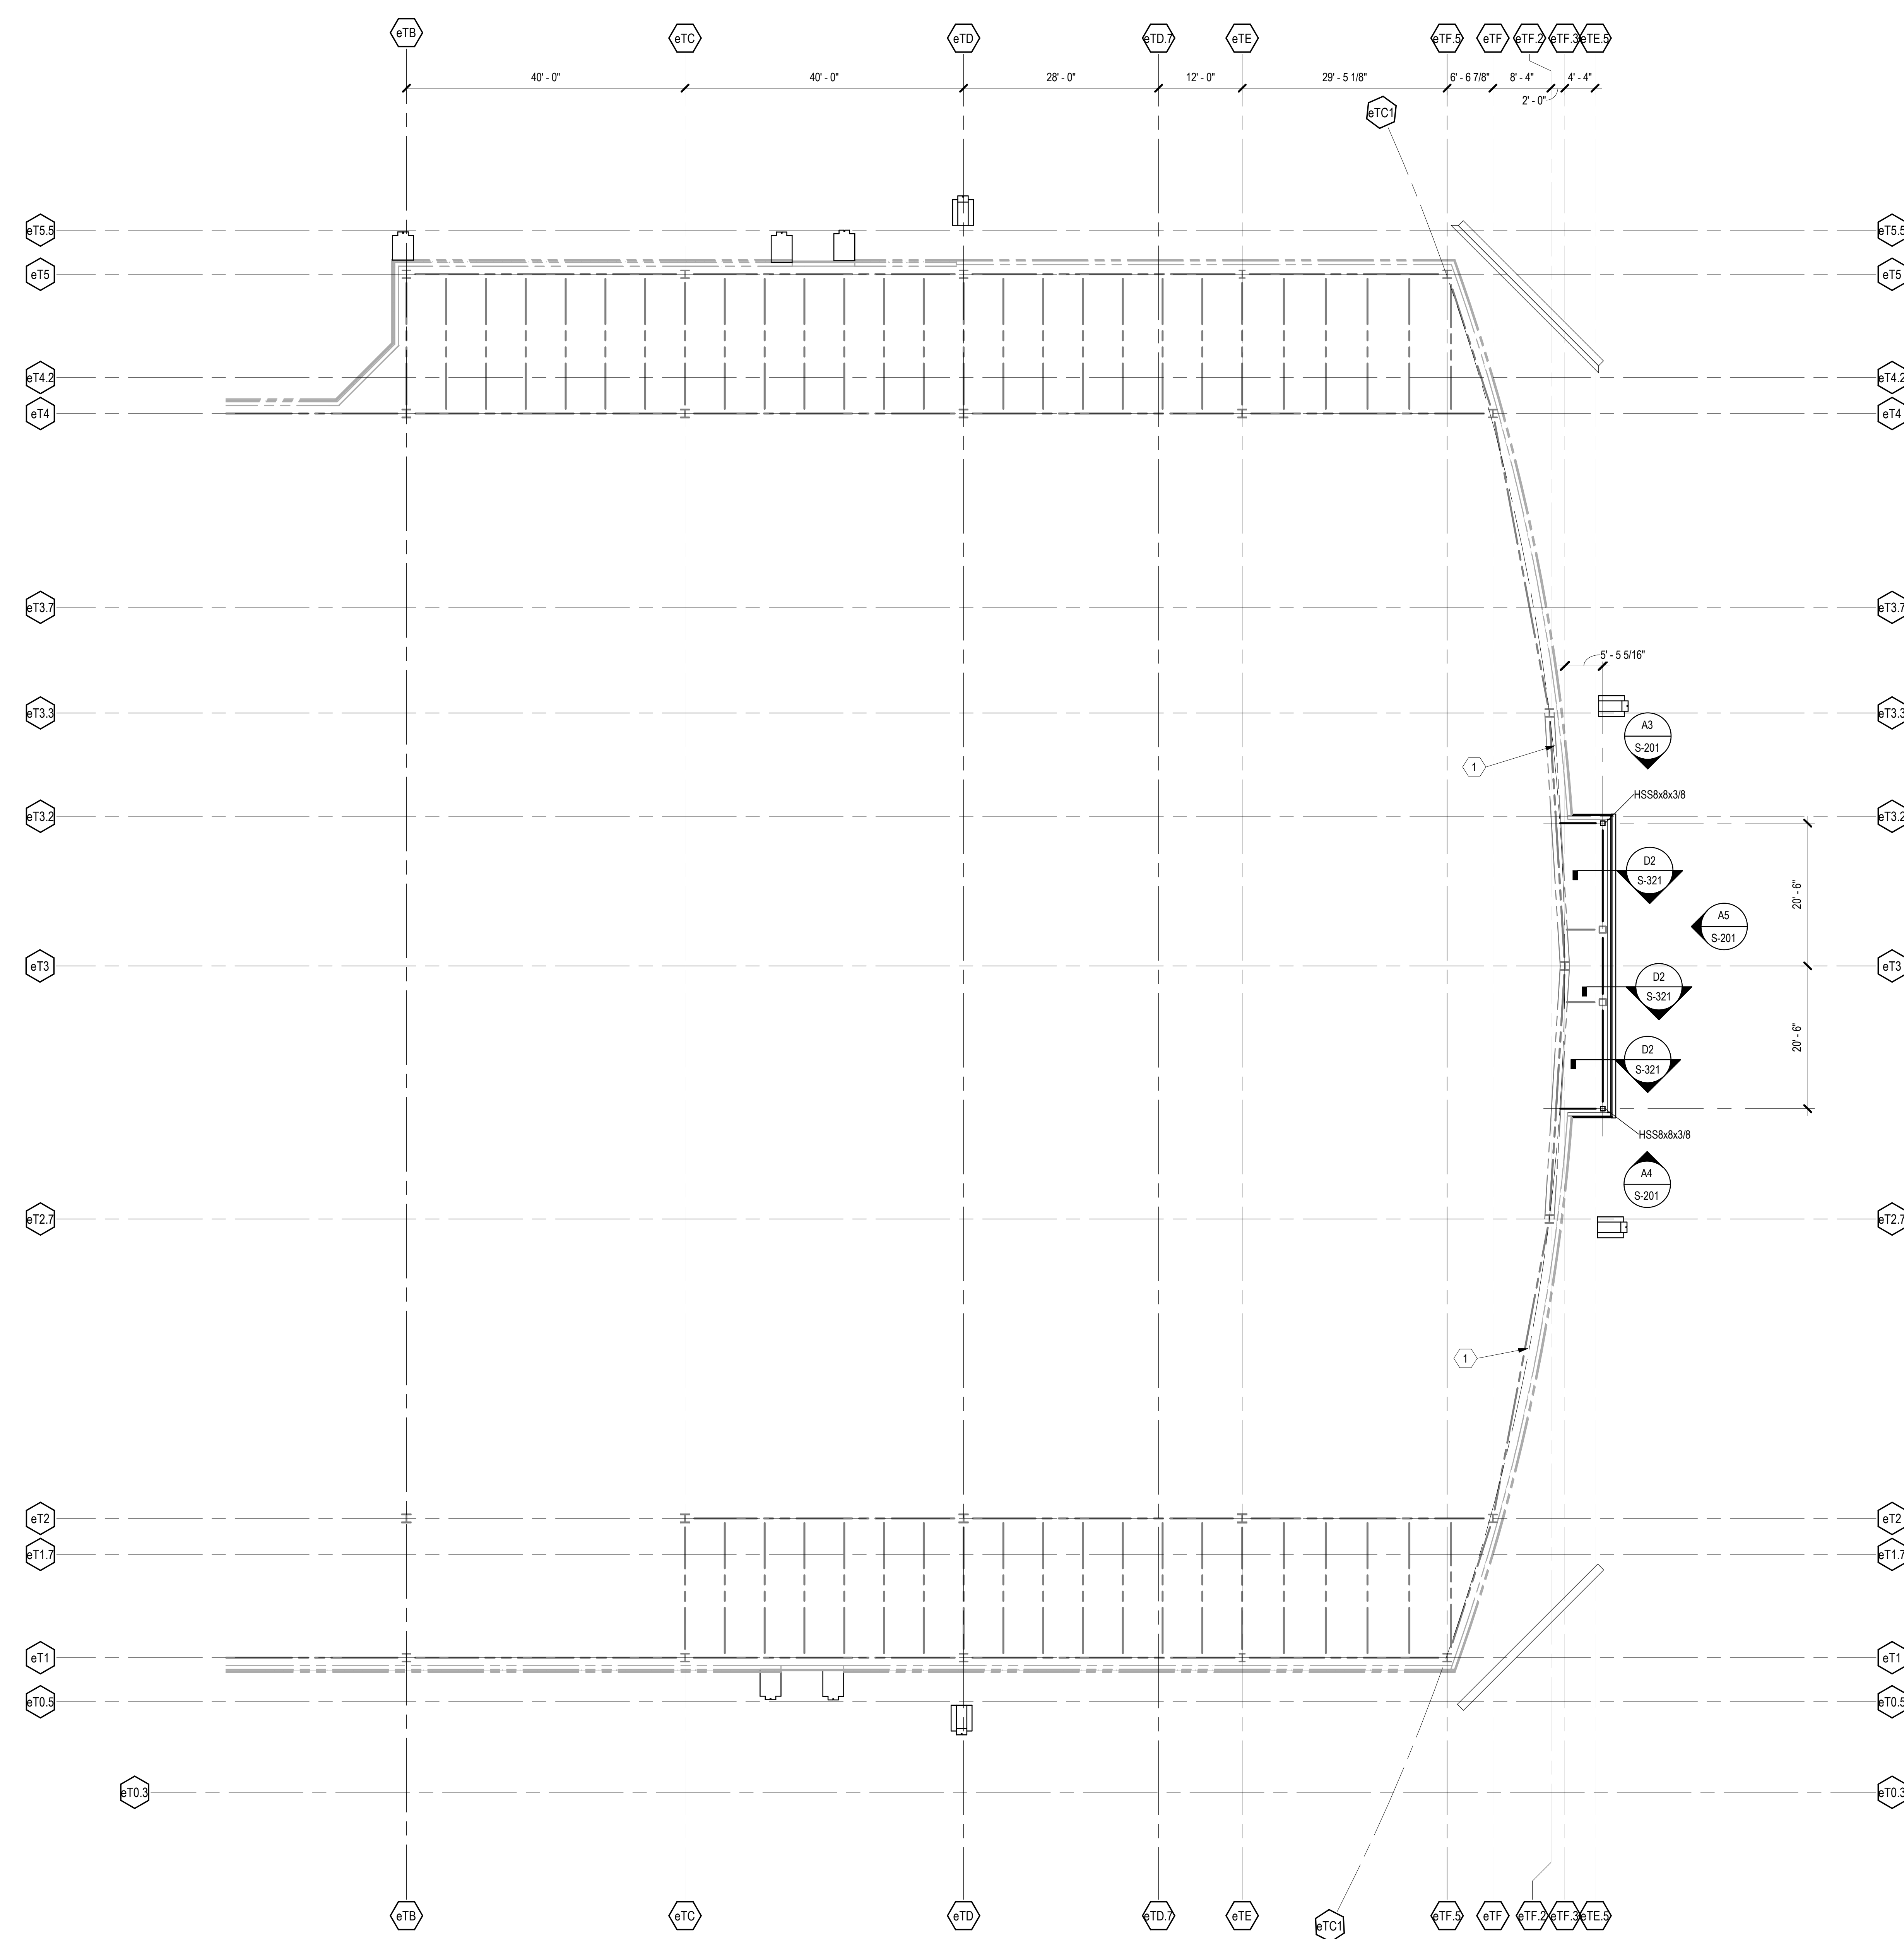

A2 MID ROOF FRAMING PLAN - THE JOINT
 SCALE: 3/32" = 1'-0"

1/16/2019 6:06:11 PM

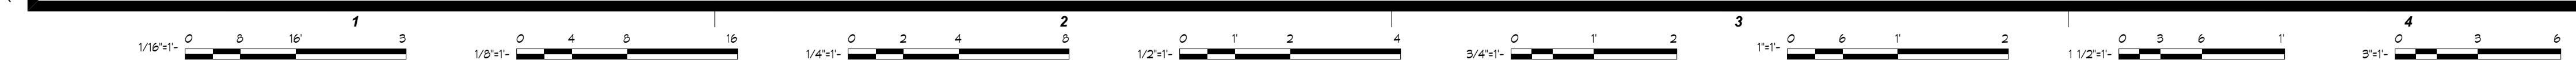

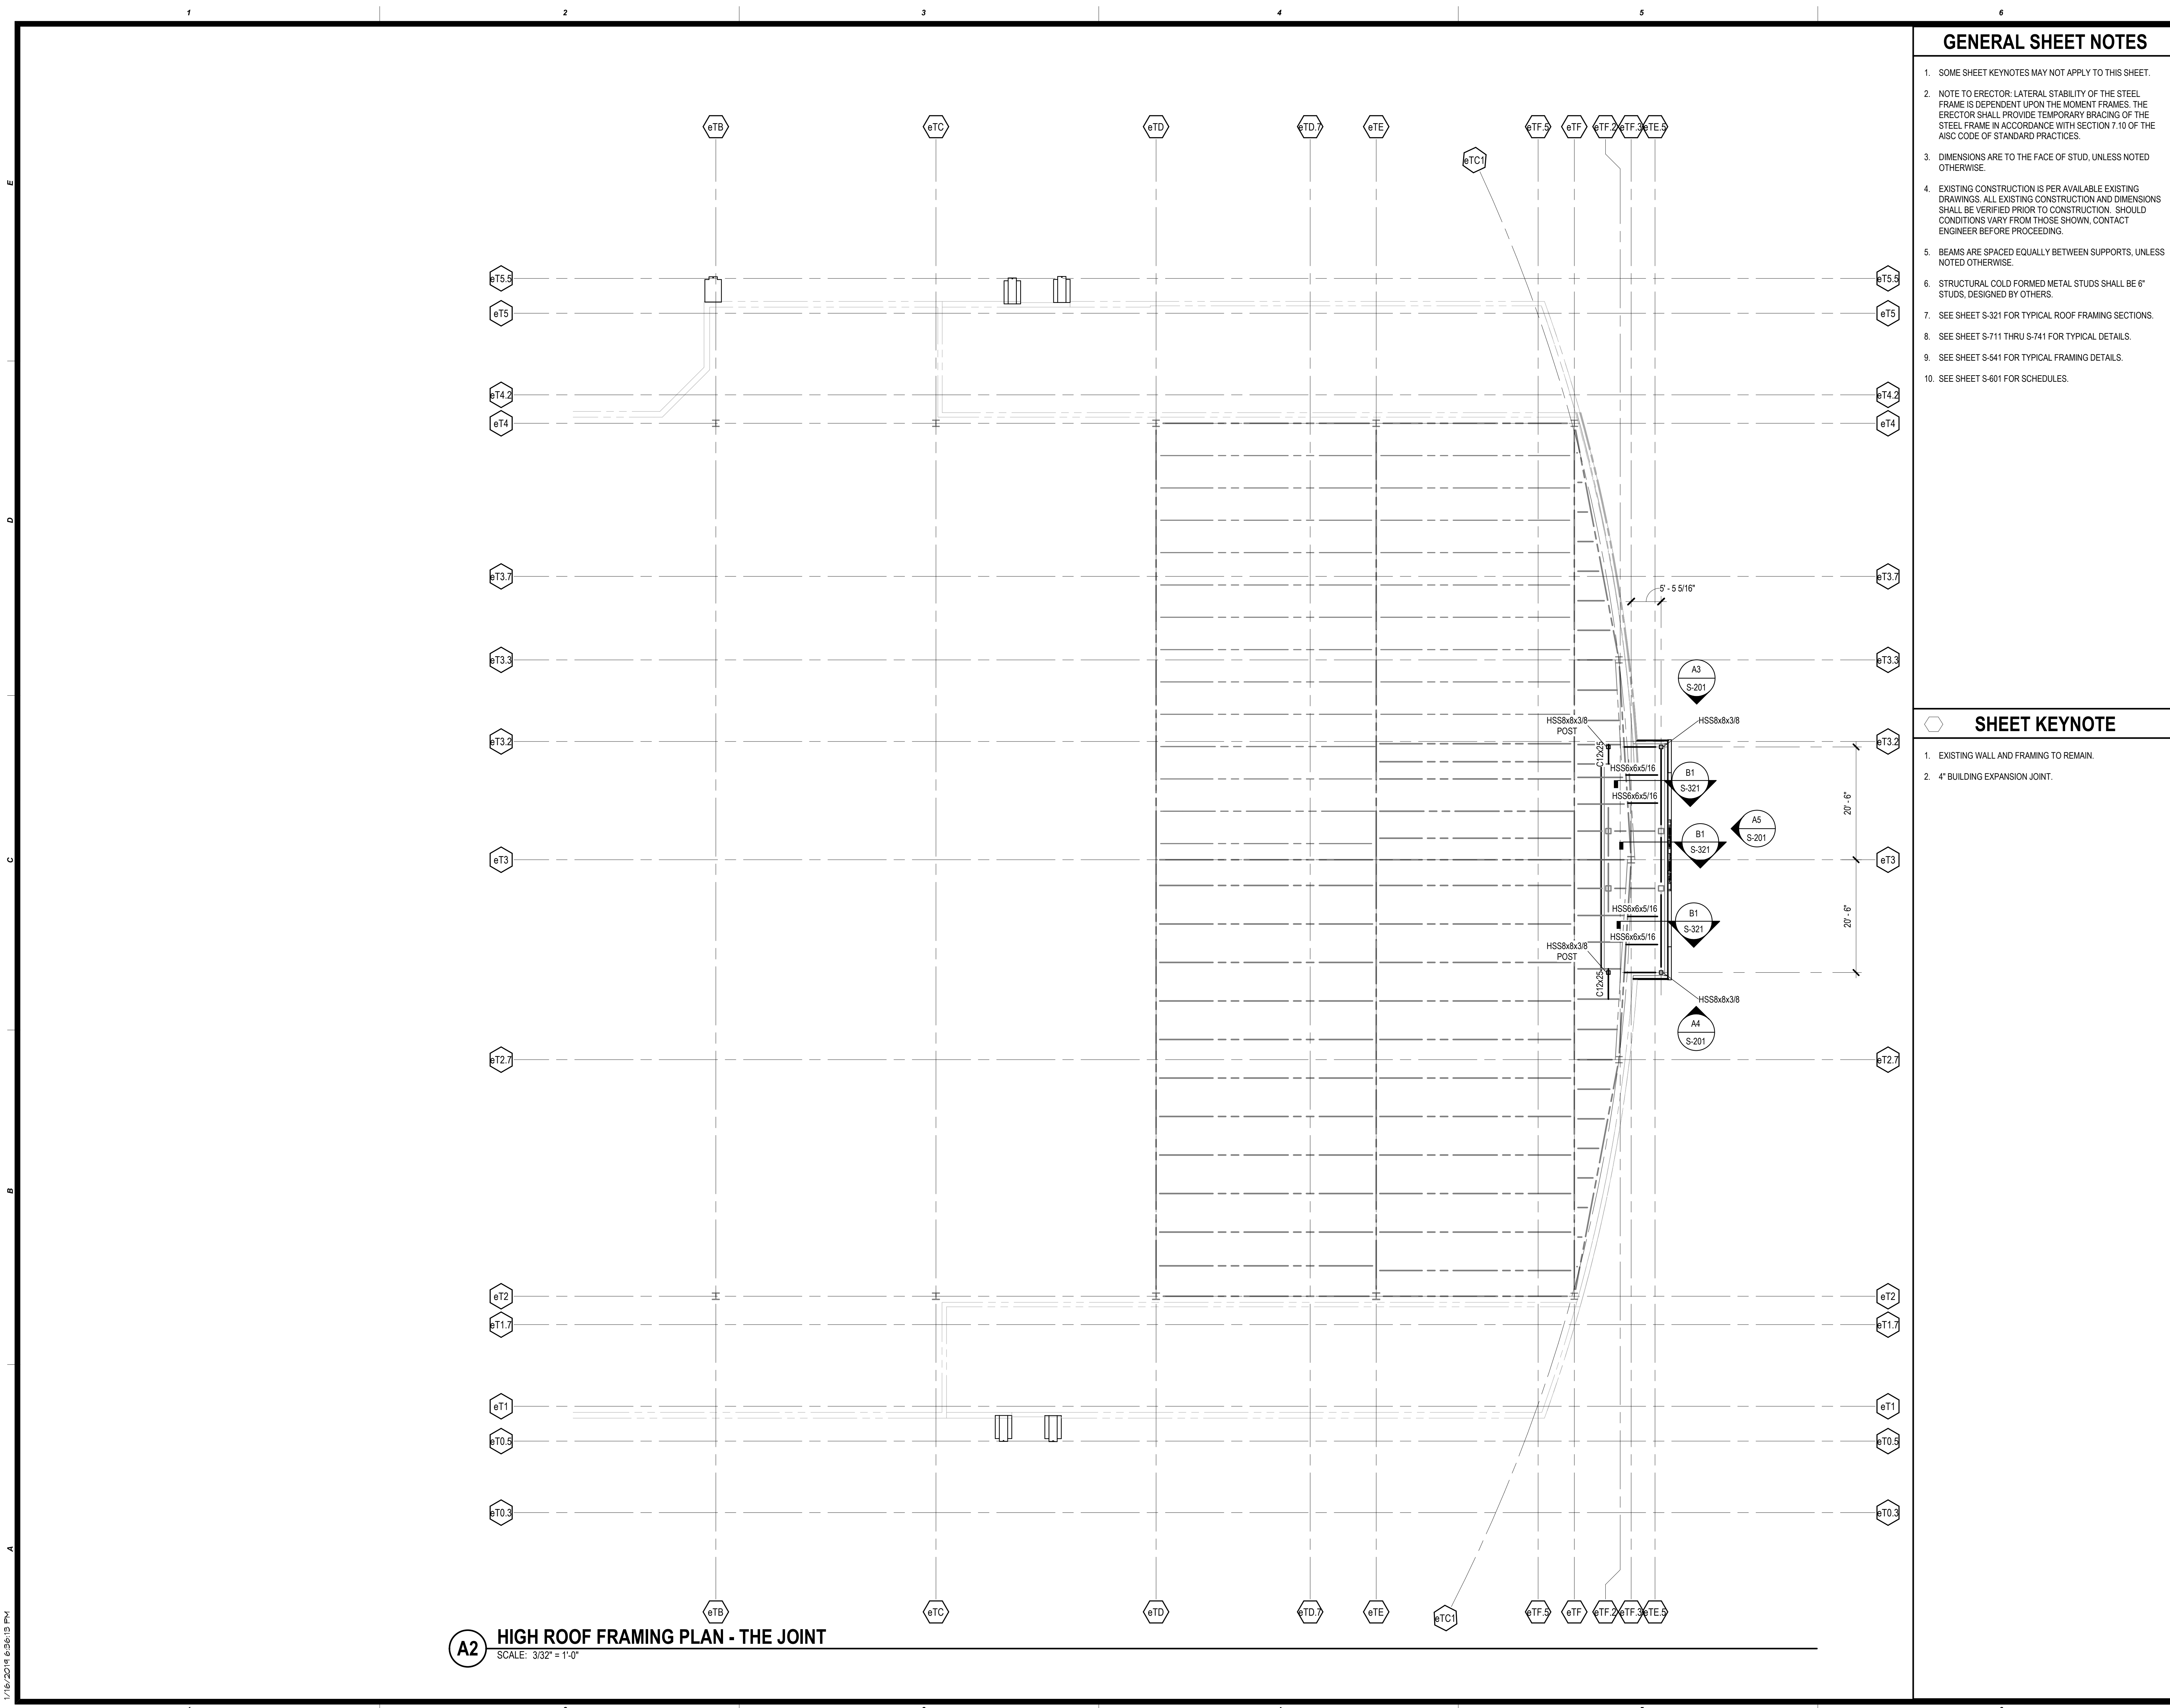

GENERAL SHEET NOTES

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- SEE SHEET S-711 THRU S-741 FOR TYPICAL DETAILS.
- SEE SHEET S-541 FOR TYPICAL FRAMING DETAILS.
- SEE SHEET S-601 FOR SCHEDULES.

SHEET KEYNOTE

- EXISTING WALL AND FRAMING TO REMAIN.
- 4" BUILDING EXPANSION JOINT.



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 M/E Engineers
 60 Lakefront Boulevard
 Suite 330
 Buffalo, NY 14202

Cherokee Hard Rock Hotel & Casino

EXTERIOR FACADE RENOVATION

KEY

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No.	Description	Date

SHEET: HIGH ROOF FRAMING PLAN - THE JOINT

PROJECT: H11018.01

DATE: 01/16/2018


ISSUE: 01/16/2018


PROGRESS SET

A2 HIGH ROOF FRAMING PLAN - THE JOINT
 SCALE: 3/32" = 1'-0"

Scale: As Indicated

PROFESSIONAL ENGINEER
 J. ANDERSON
 23578
 1/16/2018

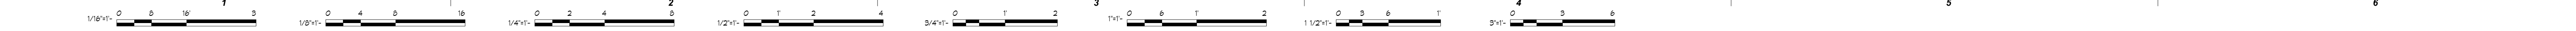

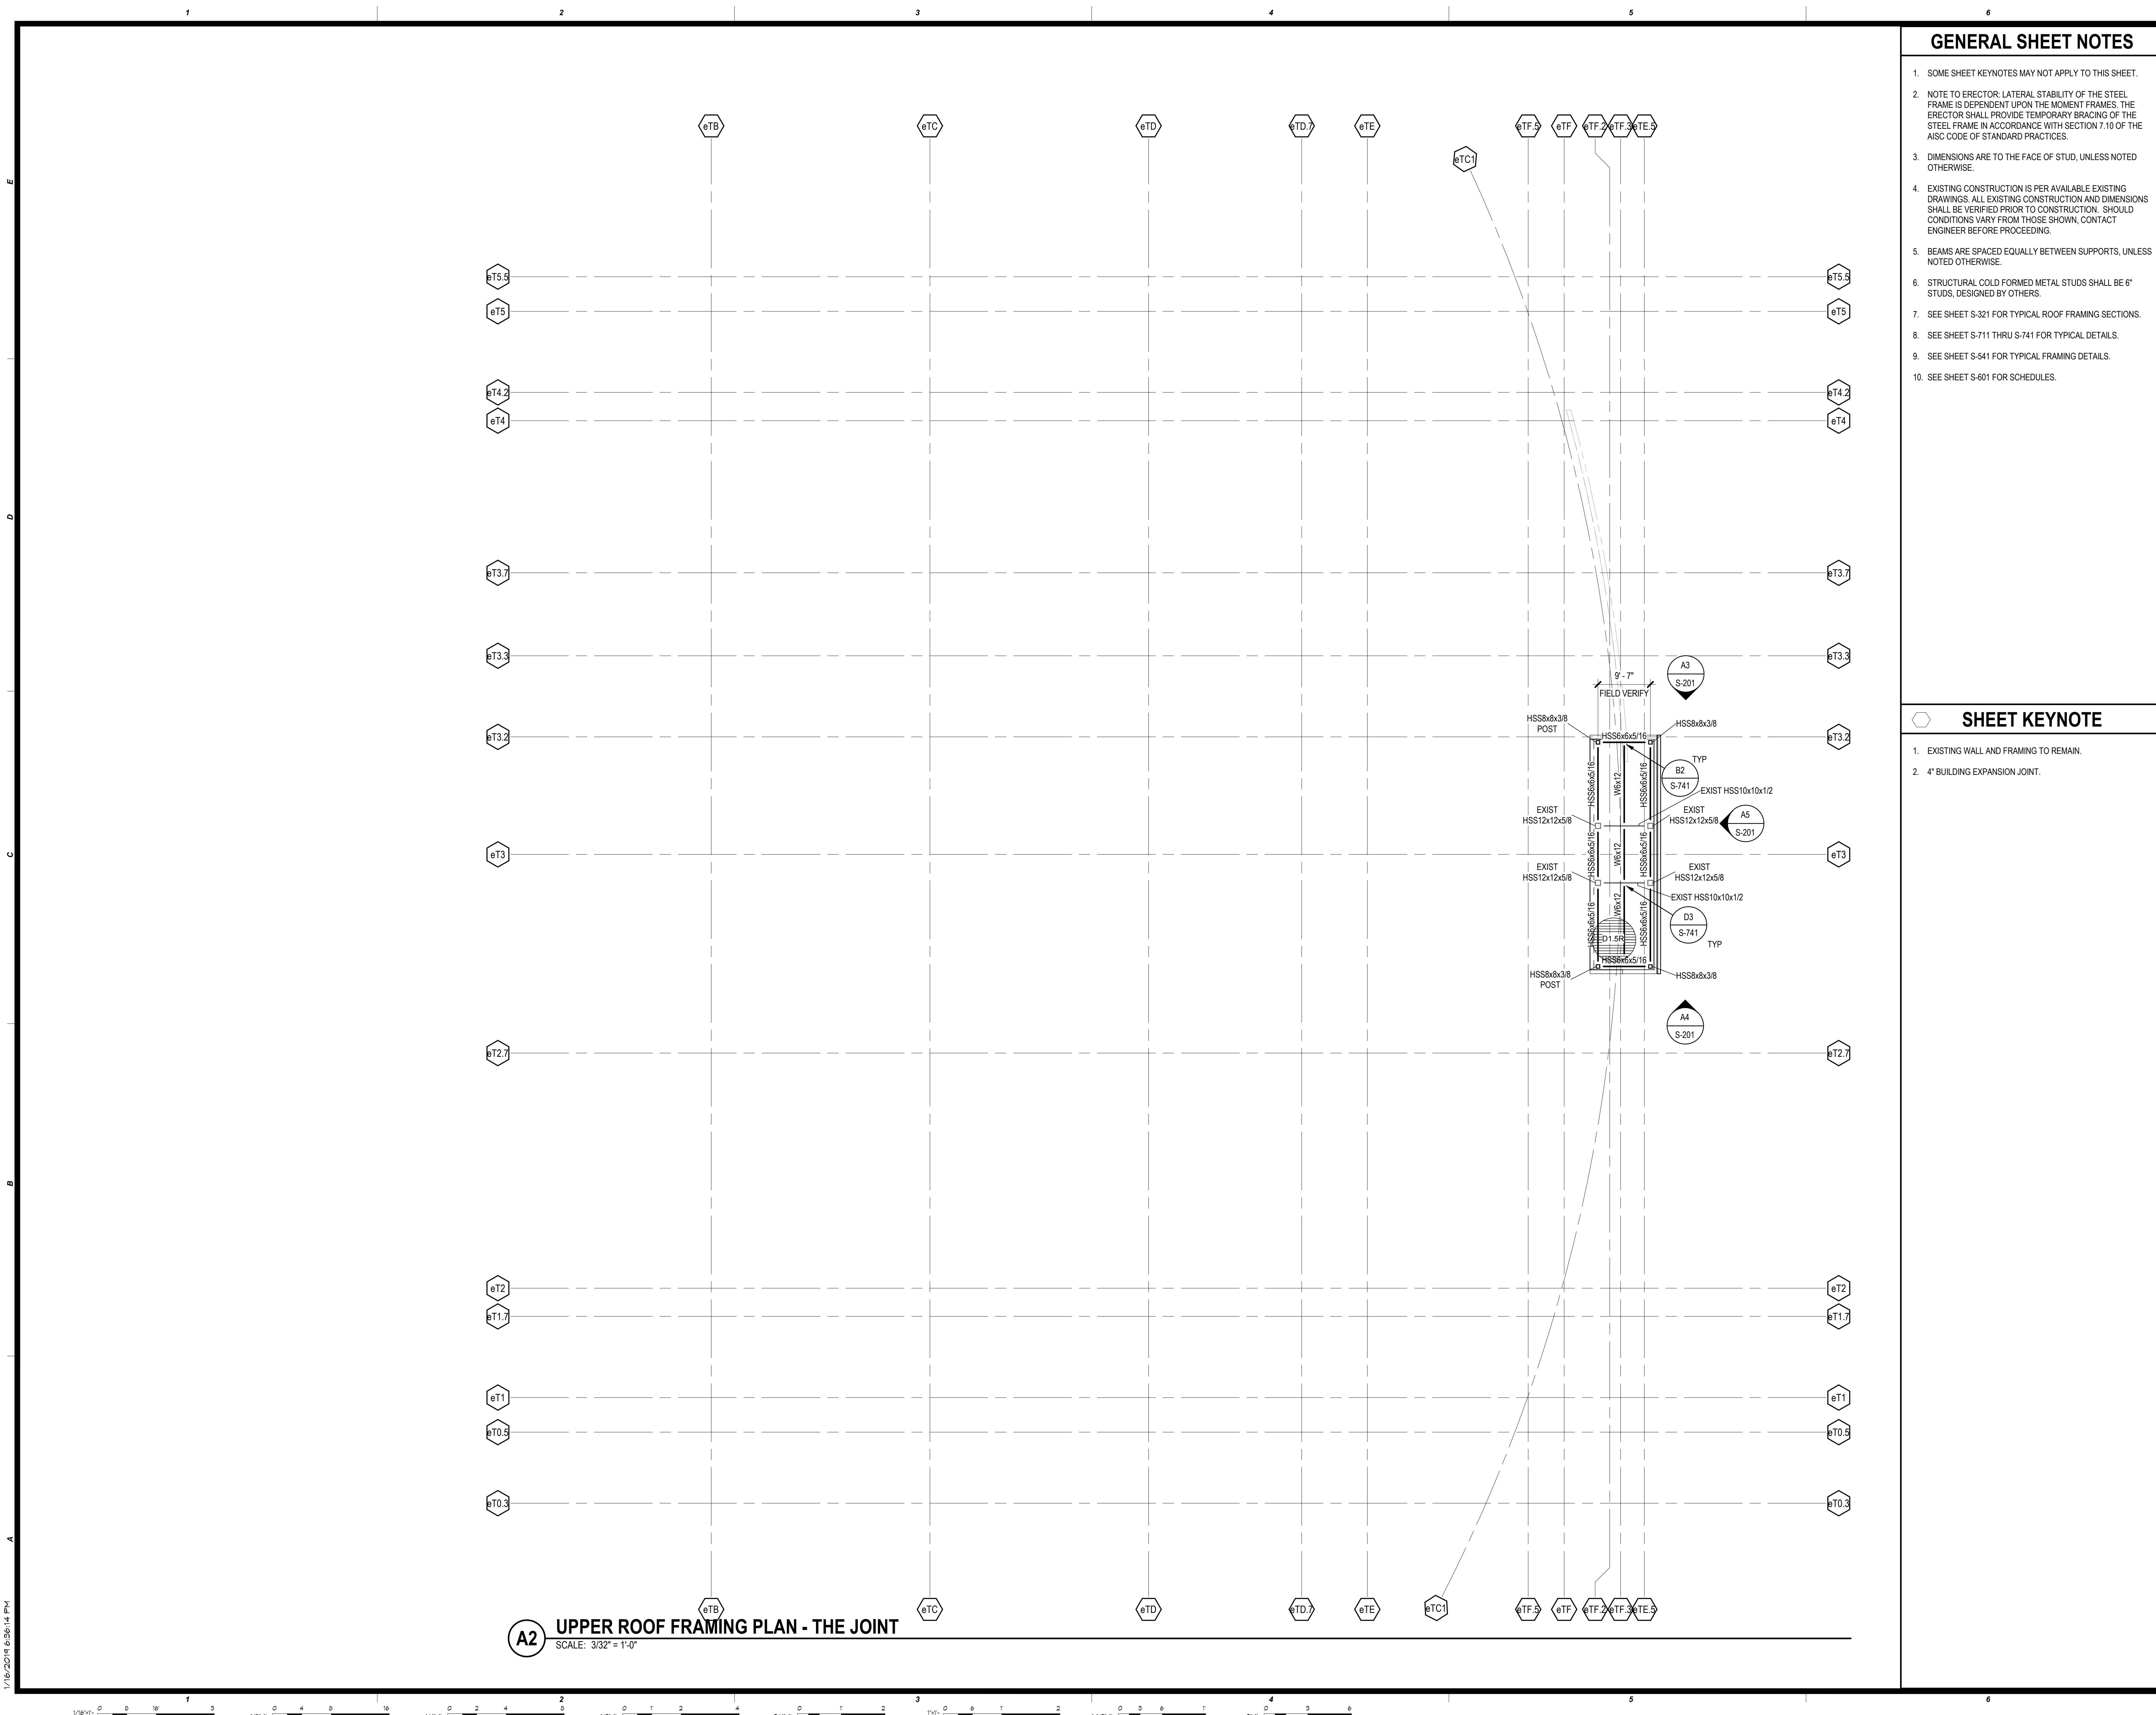

A2 UPPER ROOF FRAMING PLAN - THE JOINT
SCALE: 3/32" = 1'-0"

GENERAL SHEET NOTES

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- SEE SHEET S-321 FOR TYPICAL ROOF FRAMING SECTIONS.
- SEE SHEET S-711 THRU S-741 FOR TYPICAL DETAILS.
- SEE SHEET S-541 FOR TYPICAL FRAMING DETAILS.
- SEE SHEET S-601 FOR SCHEDULES.

SHEET KEYNOTE

- EXISTING WALL AND FRAMING TO REMAIN.
- 4' BUILDING EXPANSION JOINT.



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EXTERIOR FACADE RENOVATION



No.	Description	Date

UPPER ROOF FRAMING PLAN - THE JOINT

PROGRESS SET

PROJECT: H11018.01
DRAWN: J. ANDERSON
CHECKED: C. ROMERO
DATE: 01/16/2019

23578

S-115
Scale: As Indicated

Cherokee Hard Rock Hotel & Casino

1/16/2019 8:36:14 PM

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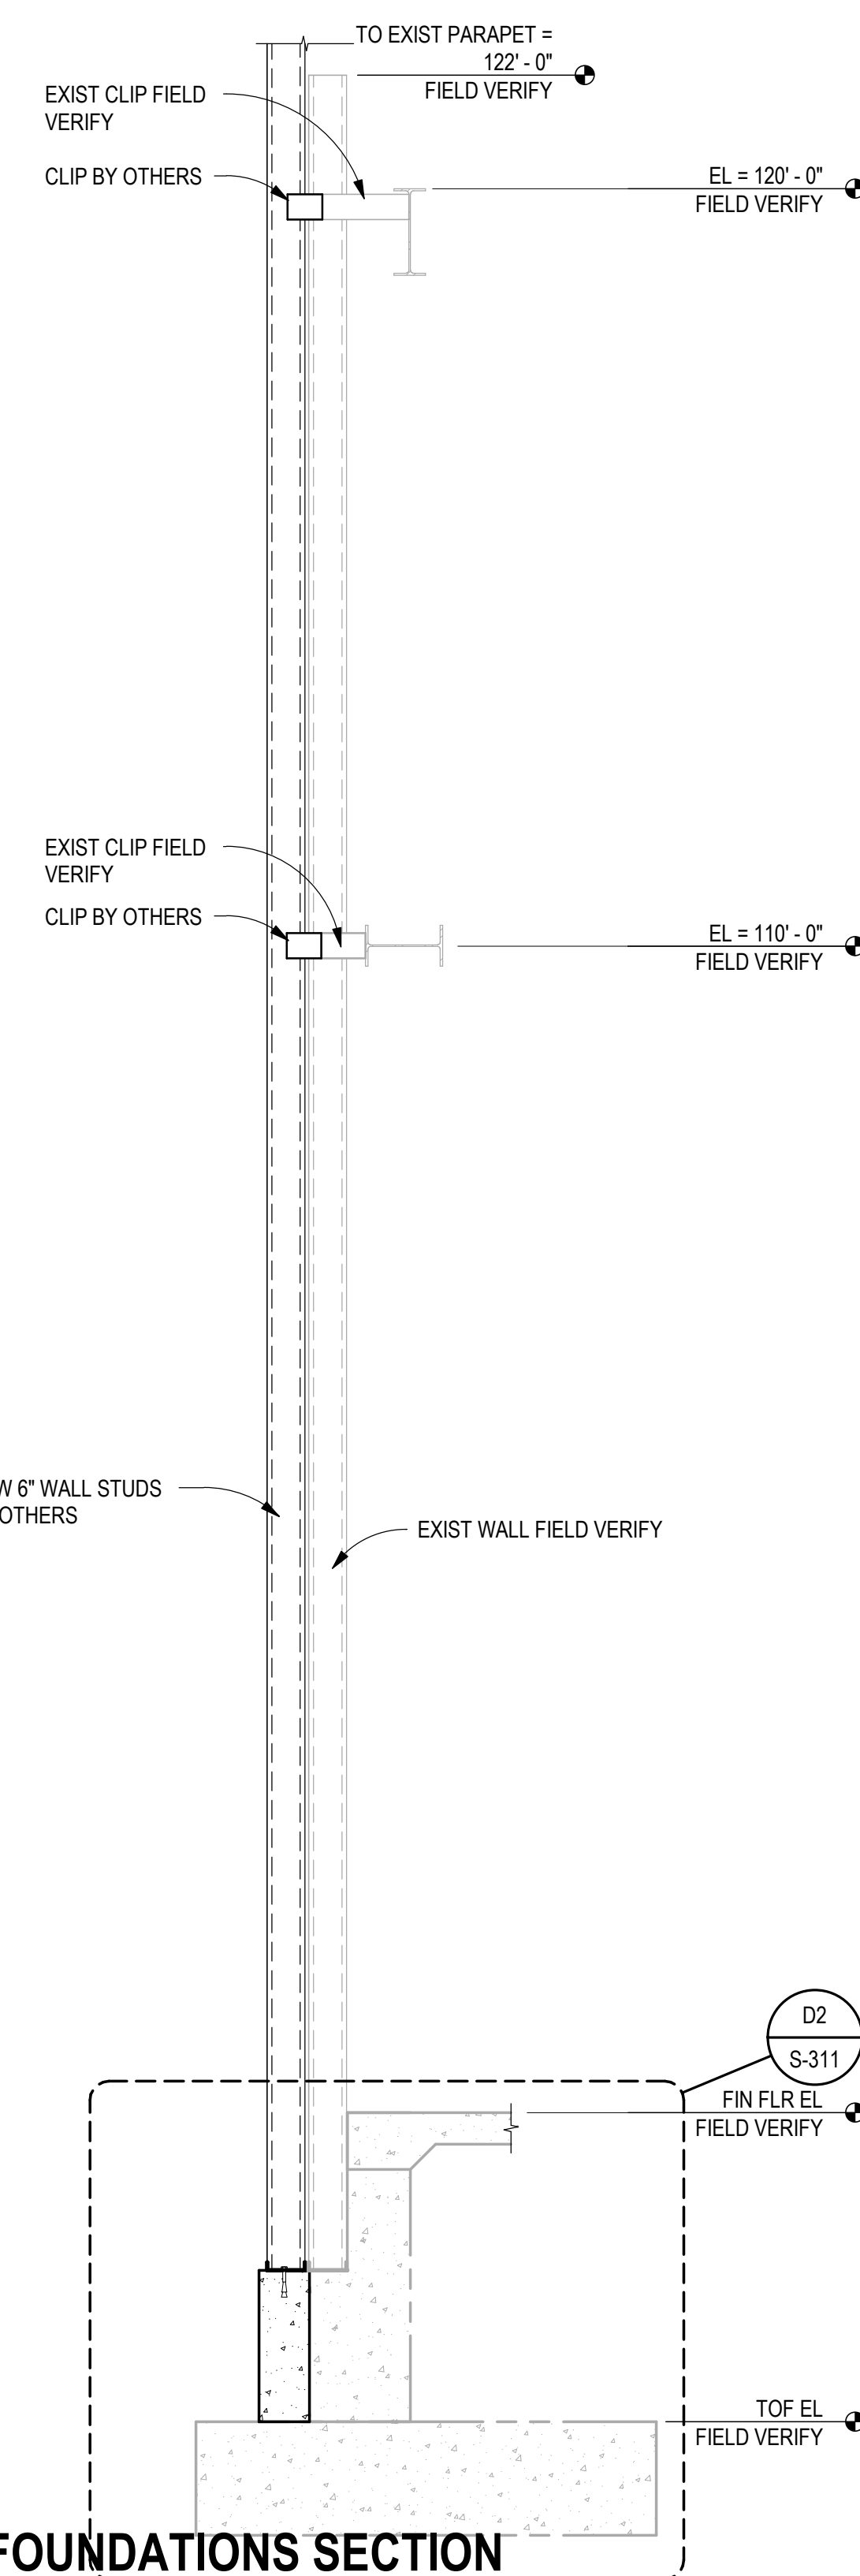
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Engineers, Inc.
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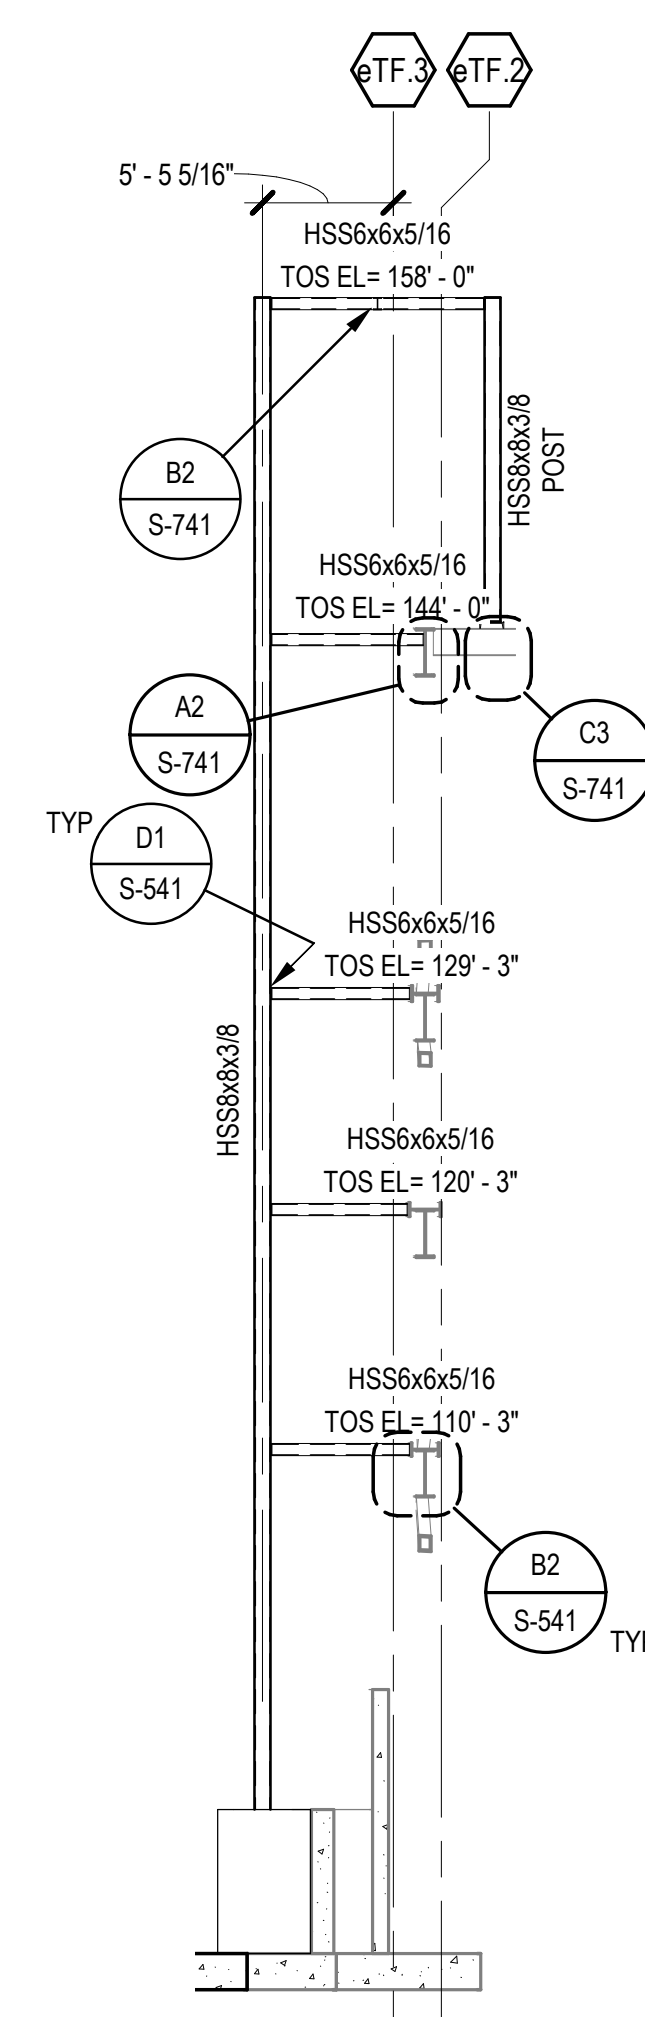
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Native Plains Surveying and
Mapping / R.K. & Associates P.L.C.
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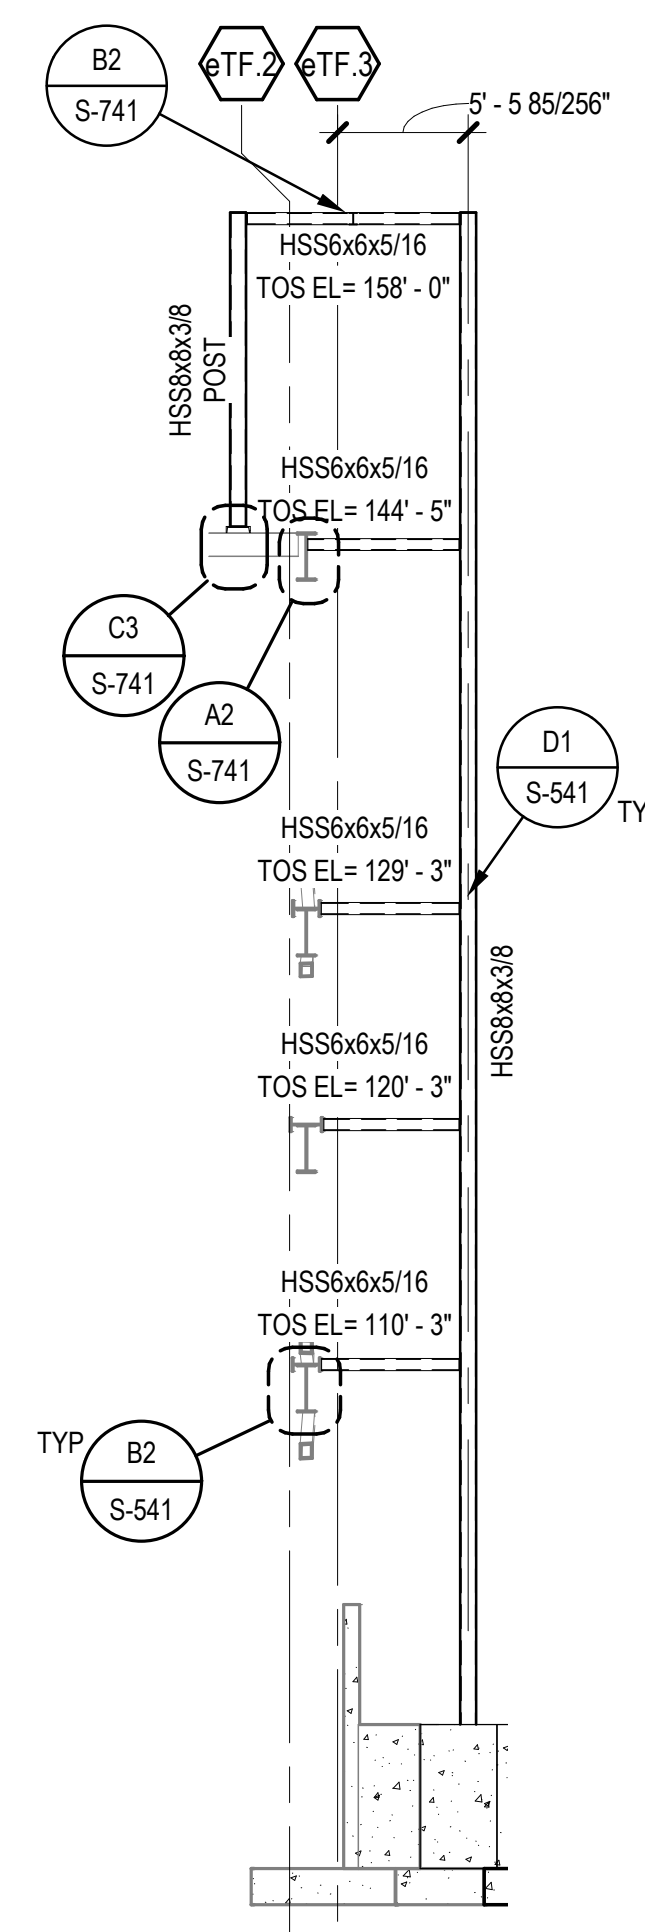
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Buffalo, NY 14202




A1 FOUNDATIONS SECTION
SCALE: 1/2" = 1'-0"



A3 THE JOINT - NORTH WALL FRAME ELEV
SCALE: 1/8" = 1'-0"



A4 THE JOINT - SOUTH WALL FRAME ELEV
SCALE: 1/8" = 1'-0"

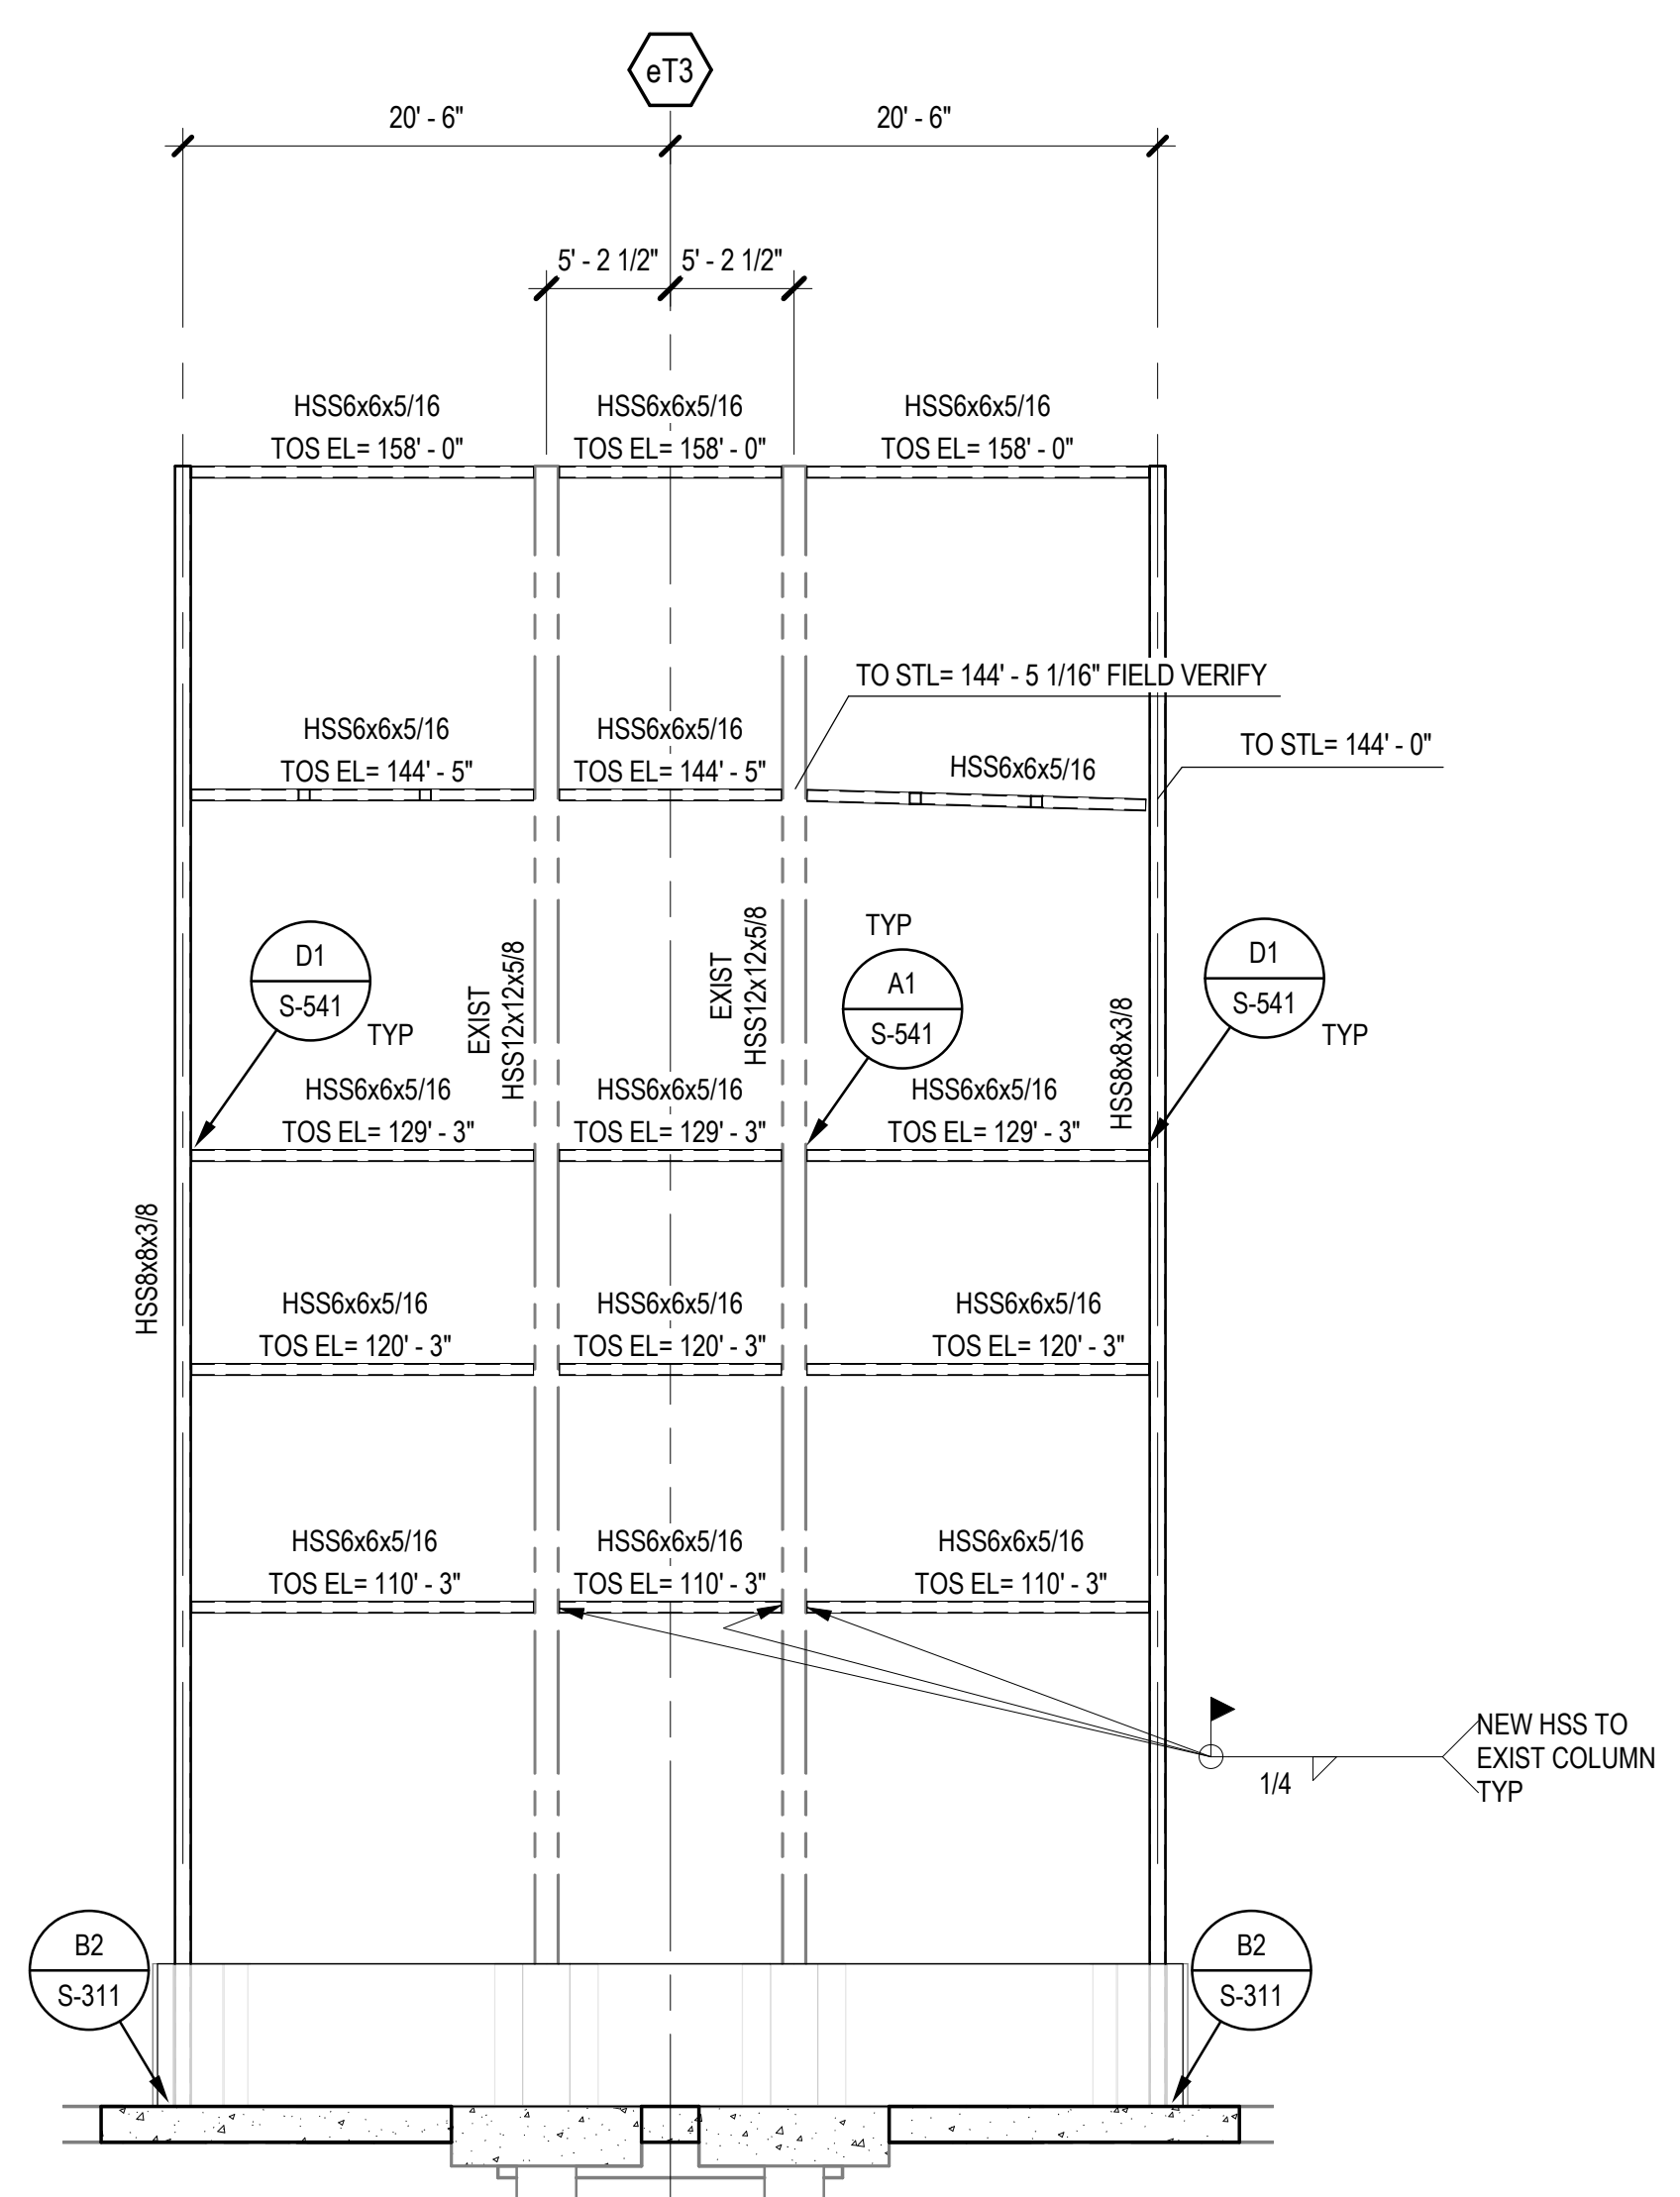

A5 THE JOINT - EAST WALL FRAME ELEVATION
SCALE: 1/8" = 1'-0"

NOTE: CONTRACTOR TO FIELD VERIFY ALL EXISTING TOP OF STEEL ELEVATIONS PRIOR TO FABRICATION OF NEW STEEL

EXTERIOR FACADE RENOVATION

No.	Description	Date

FRAMING ELEVATIONS

PROGRESS SET

PROJECT: H11018.01
DRAWN BY: J. ANDERSON
CHECKED BY: C. ROMERO
DATE: 01/16/2019

PROFESSIONAL ENGINEER
CHRIS S. ROMERO
23678
OKLAHOMA
1/16/19

S-201
Scale: As Indicated

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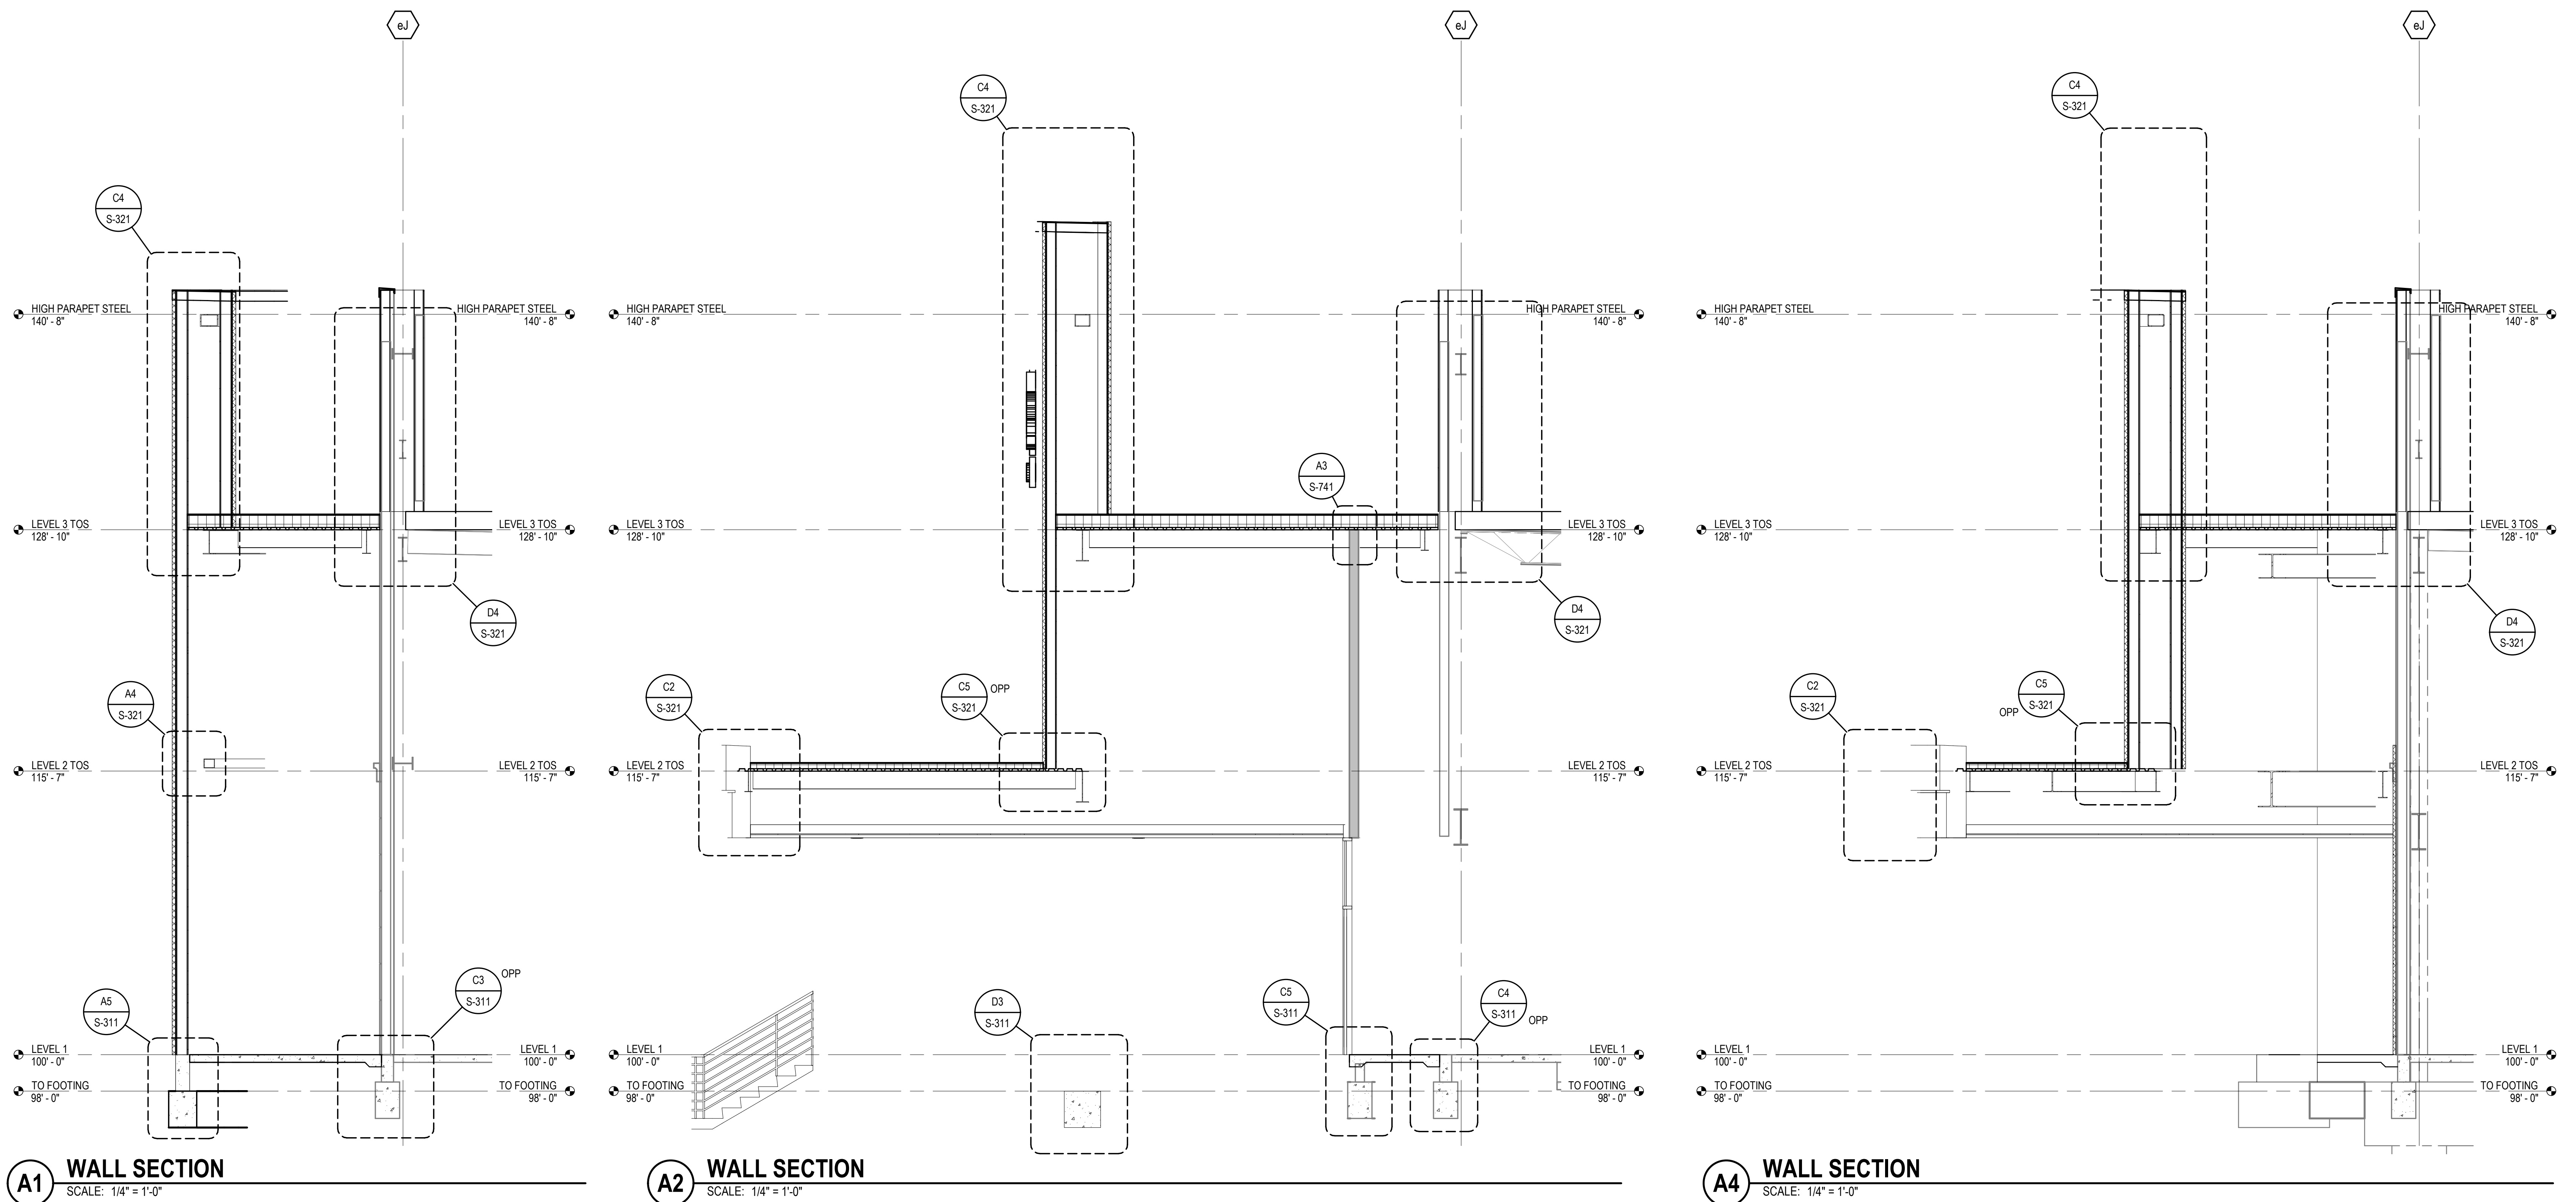
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LOW VOLTAGE / THEME LIGHTING
M/E Engineers
60 Lakefront Boulevard
Suite 320
Buffalo, NY 14202



A1 WALL SECTION
SCALE: 1/4" = 1'-0"

A2 WALL SECTION
SCALE: 1/4" = 1'-0"

A4 WALL SECTION
SCALE: 1/4" = 1'-0"

EXTERIOR FACADE RENOVATION




No.	Description	Date

PROJ: 11/16/2018
SHEET: WALL SECTIONS
DATE: 01/16/2019
PROGRESS SET

PROJ: H11018.01
DRAWN: J. ANDERSON
CHECKED: C. ROMERO
DATE: 01/16/2019
SCALE: 1/4" = 1'-0"

S-301
Scale: 1/4" = 1'-0"

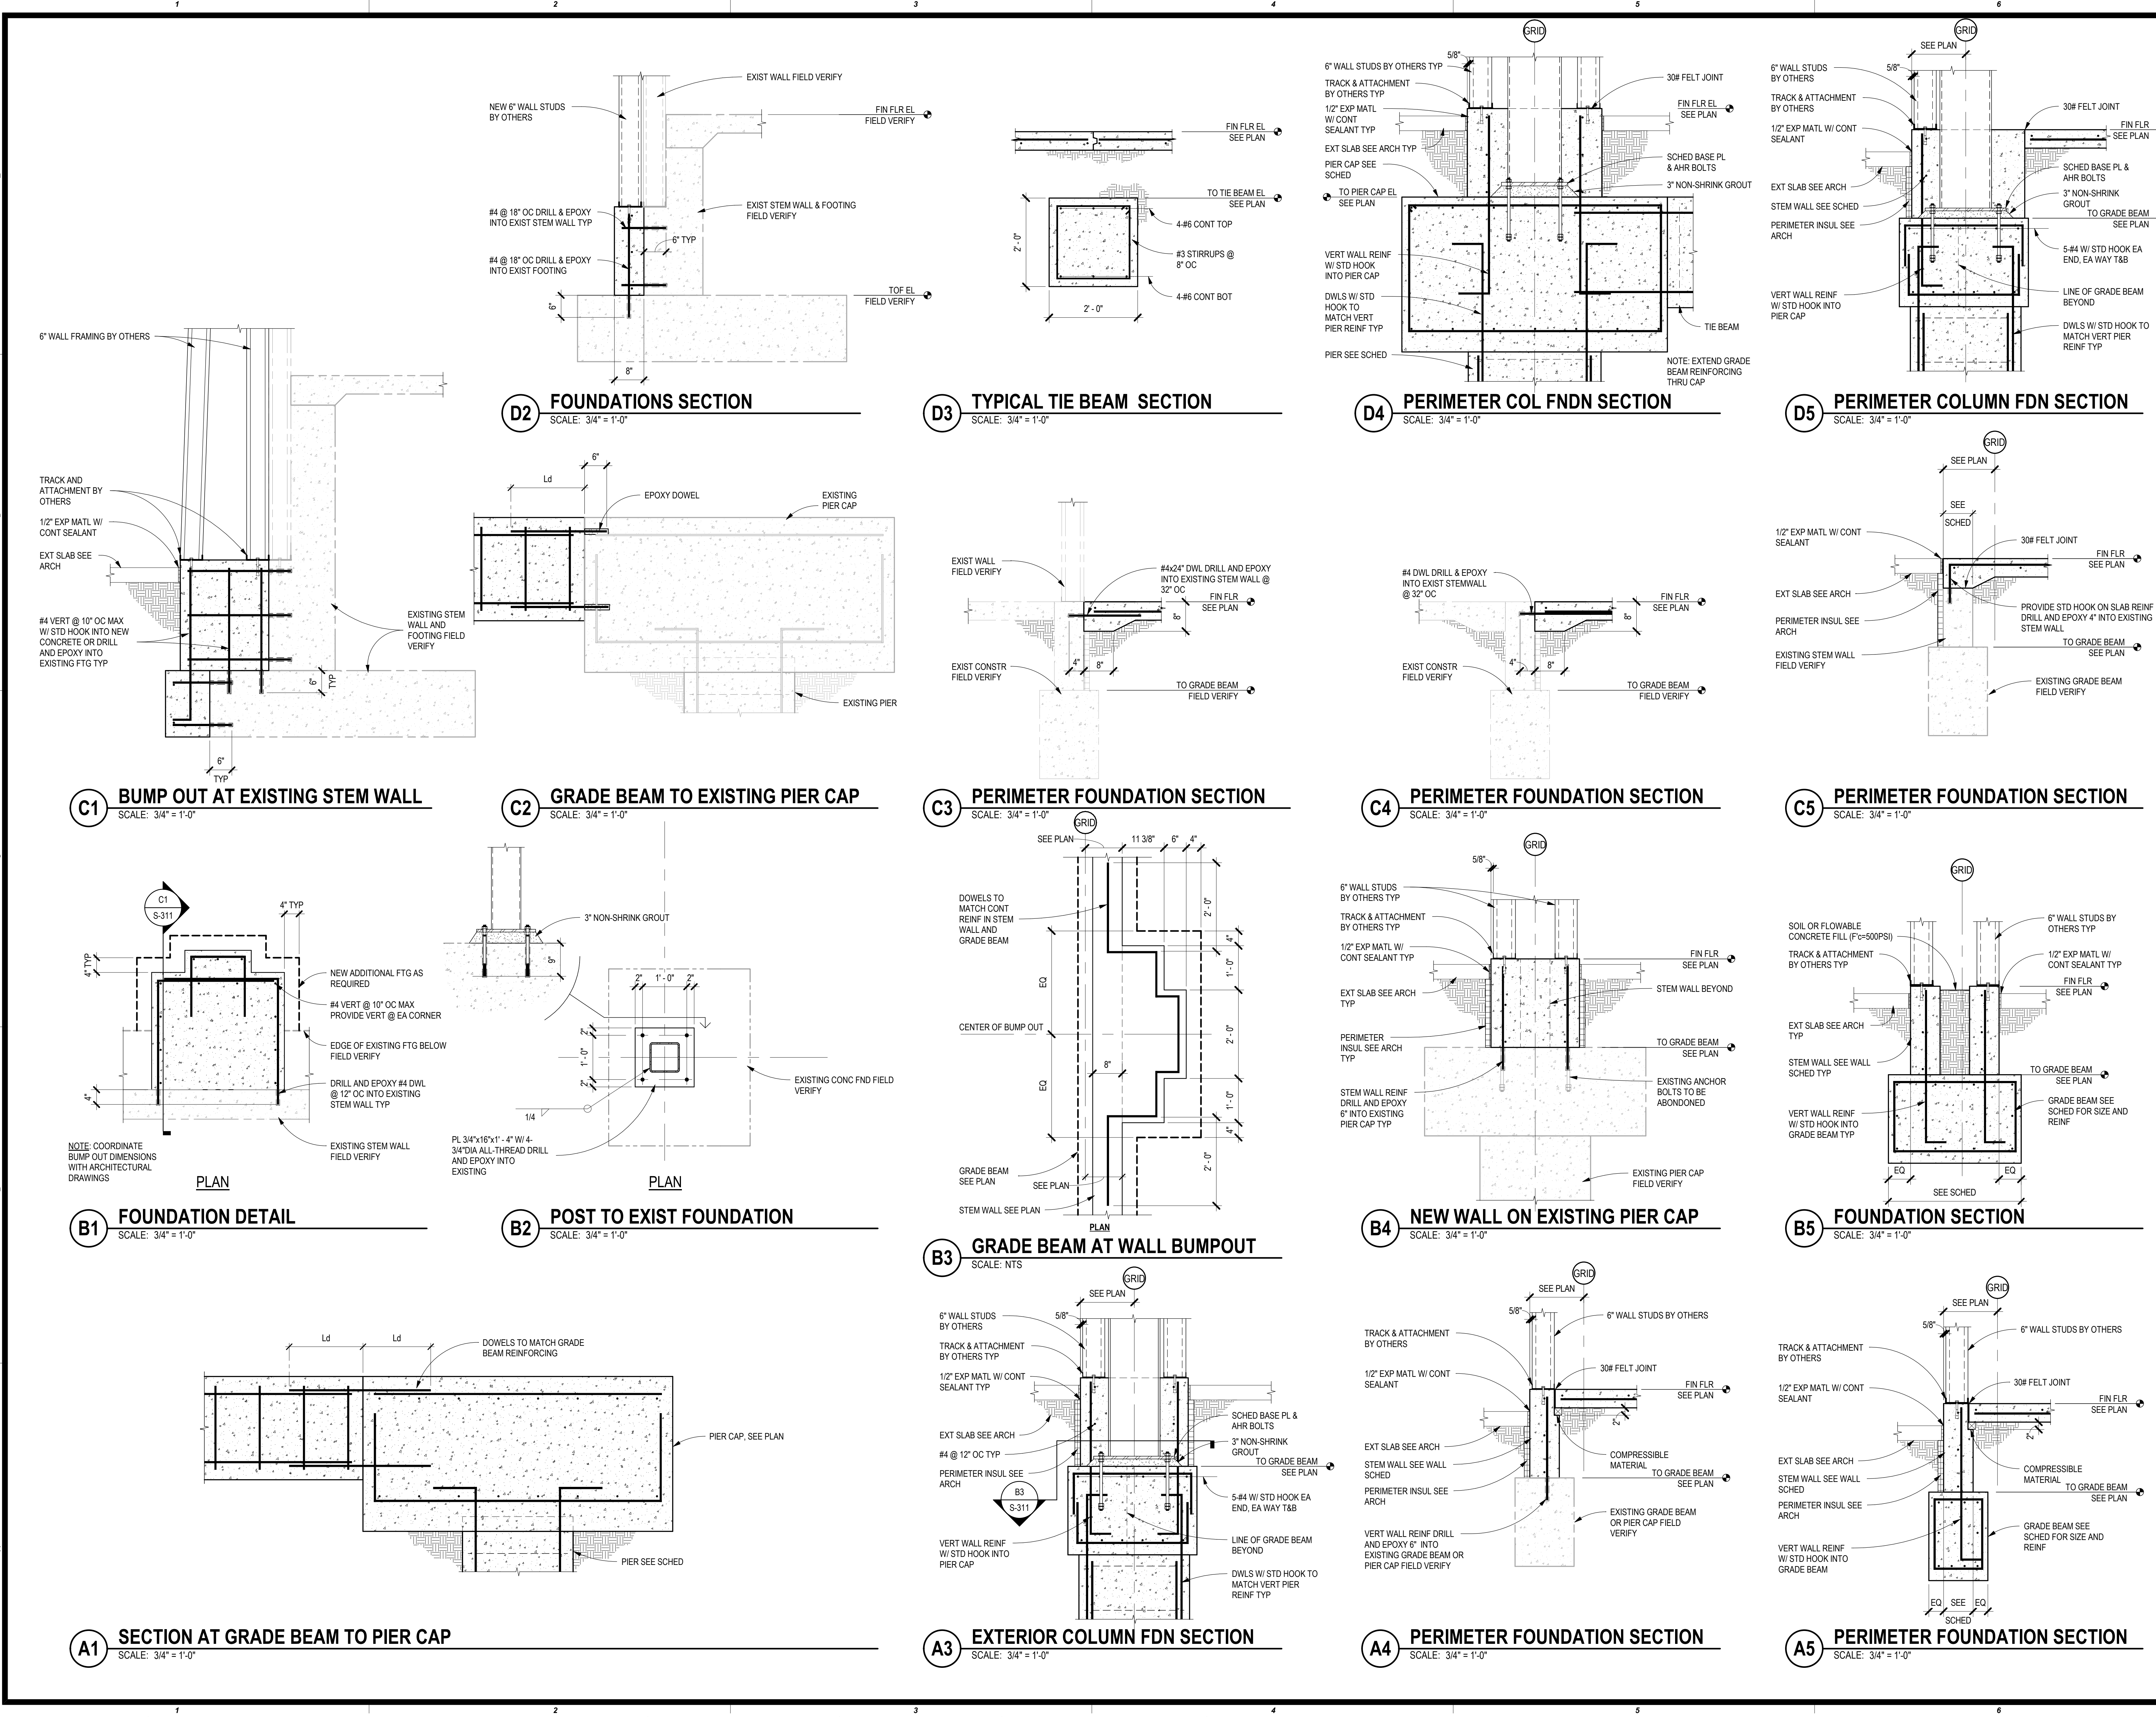

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EXTERIOR FACADE RENOVATION

No.	Description	Date

FOUNDATION SECTIONS
 PROGRESS SET

PROJECT: H11018.01
 DRAWN BY: J. ANDERSON
 CHECKED BY: C. ROMERO
 DATE: 01/16/2019
 SHEET: S-311
 SCALE: 3/4" = 1'-0"
 PROFESSIONAL ENGINEER
 CHRIS S. ROMERO
 23578
 OKLAHOMA
 1/16/19

1/16/2019 9:36:20 PM

Cherokee Hard Rock Hotel & Casino

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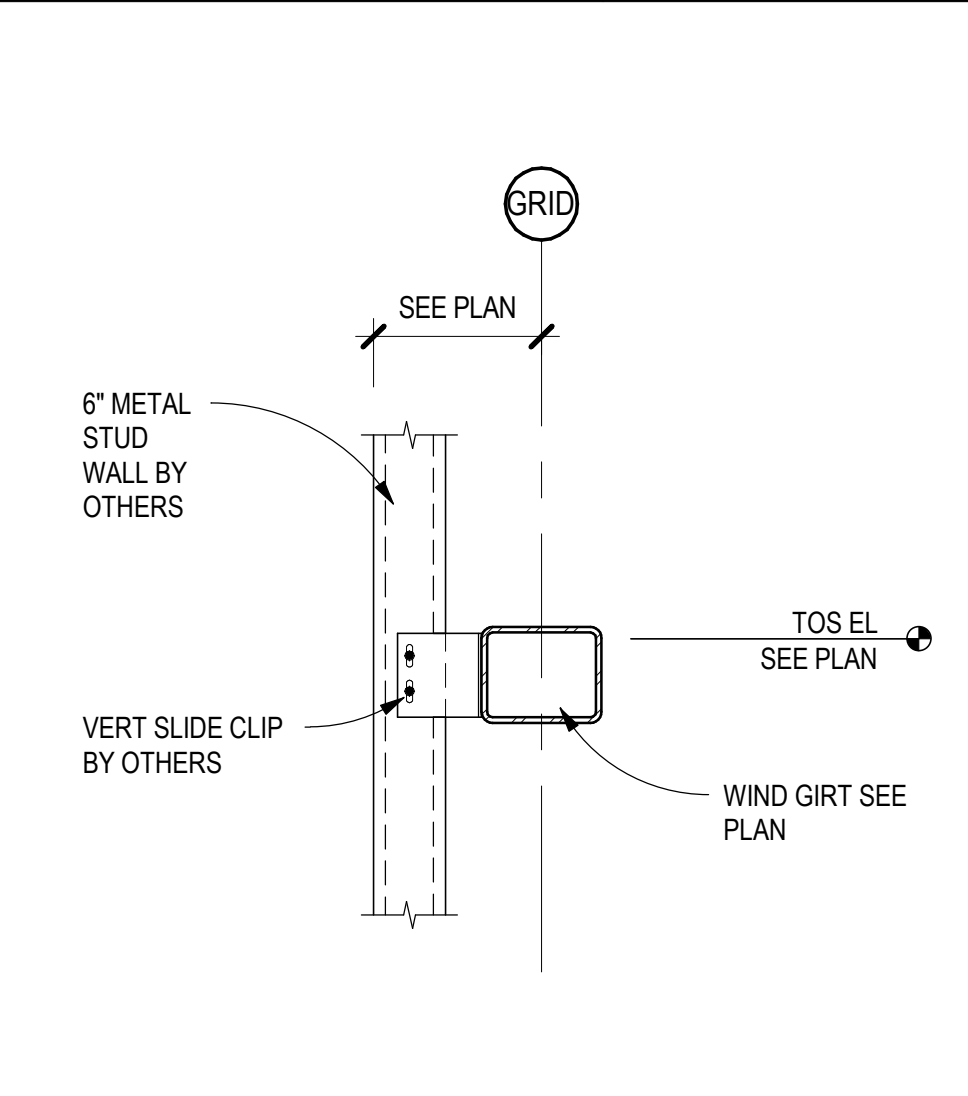
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No.	Description	Date


PROJECT: H11018.01
DRAWN: J. ANDERSON
CHECKED: C. ROMERO
DATE: 01/16/2019

PROFESSIONAL ENGINEER
MORIS S. ROMERO
23578
OKLAHOMA
1/16/19


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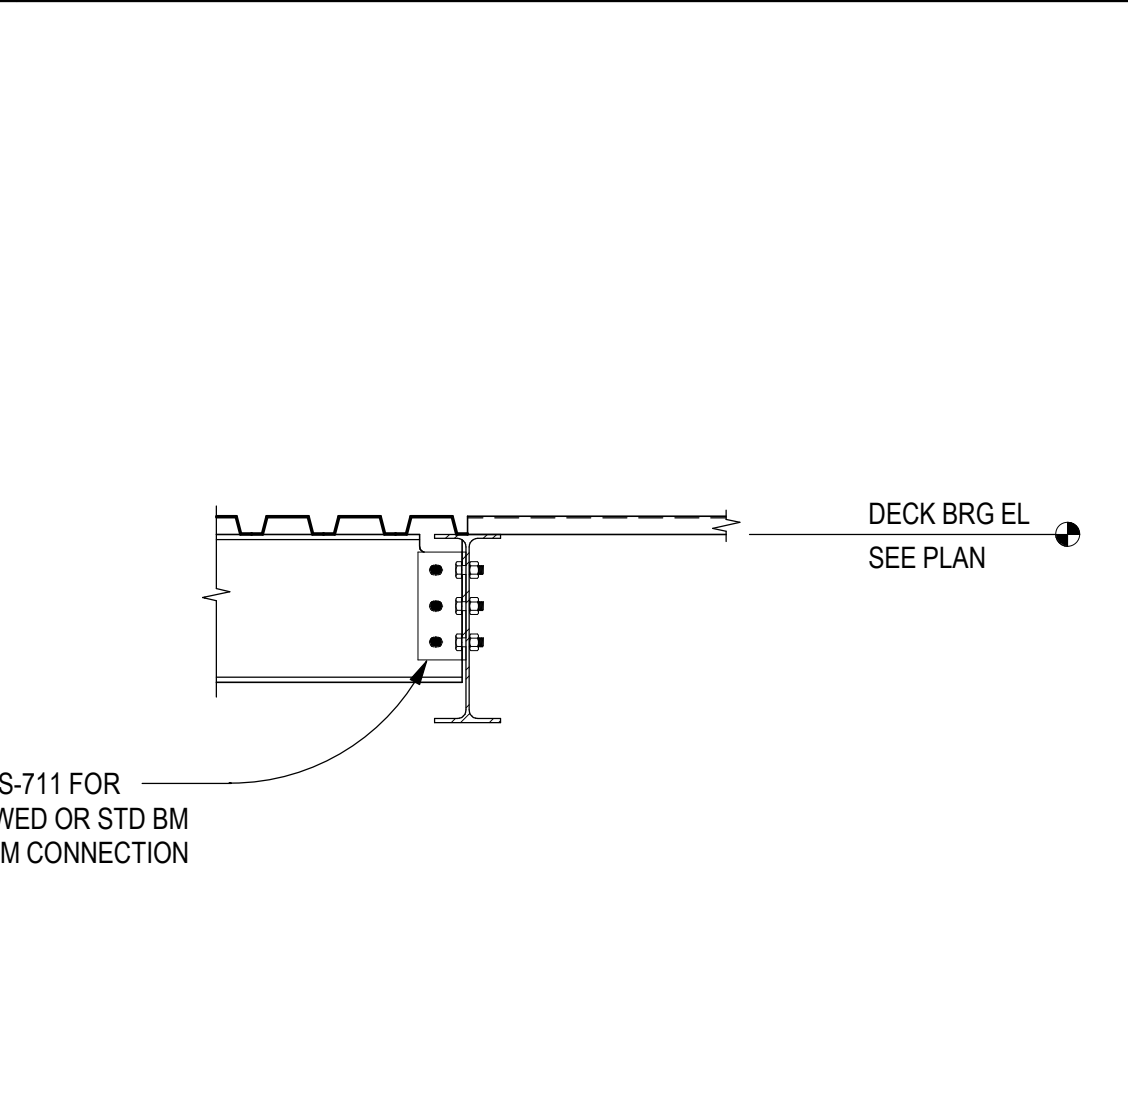
D2 FRAMING SECTION
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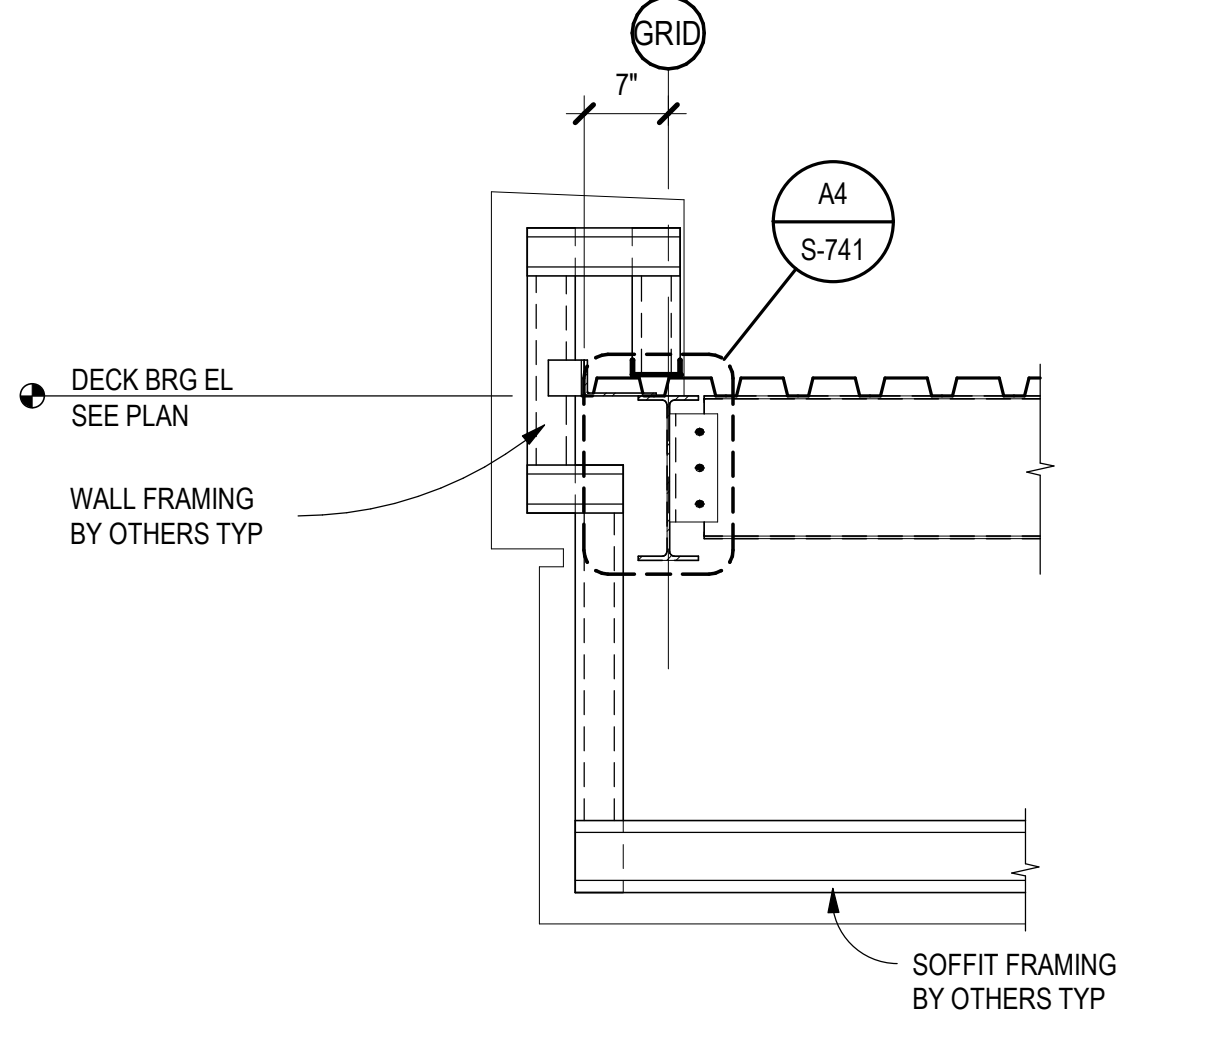
D3 TYPICAL ROOF OPENING > 12\"/>




D4 ROOF @ EXISTING ROOF PARAPET
SCALE: 3/4" = 1'-0"

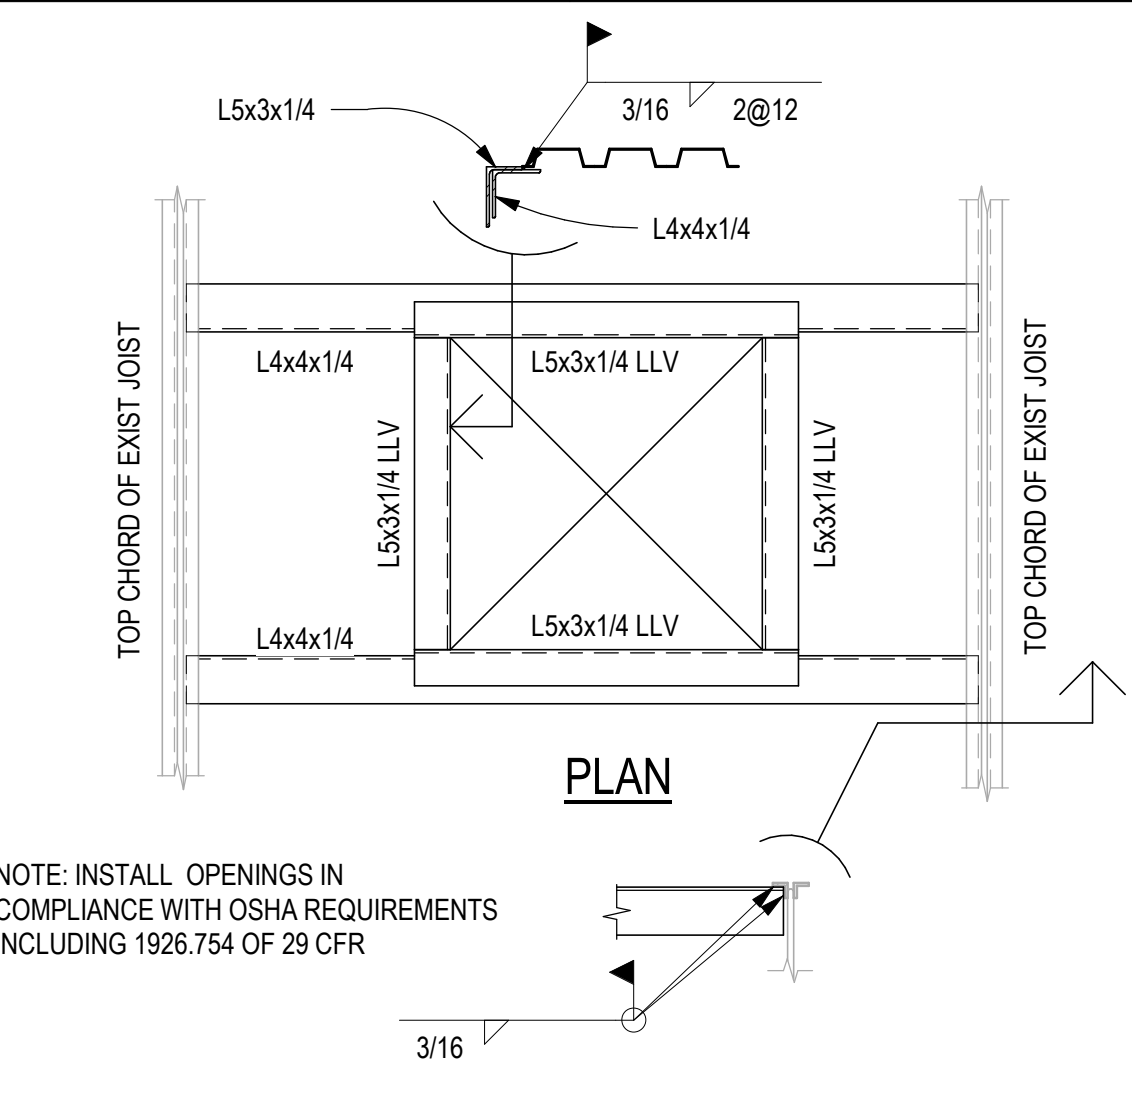


D5 METAL DECK TRANSITION AT ROOF
SCALE: 3/4" = 1'-0"

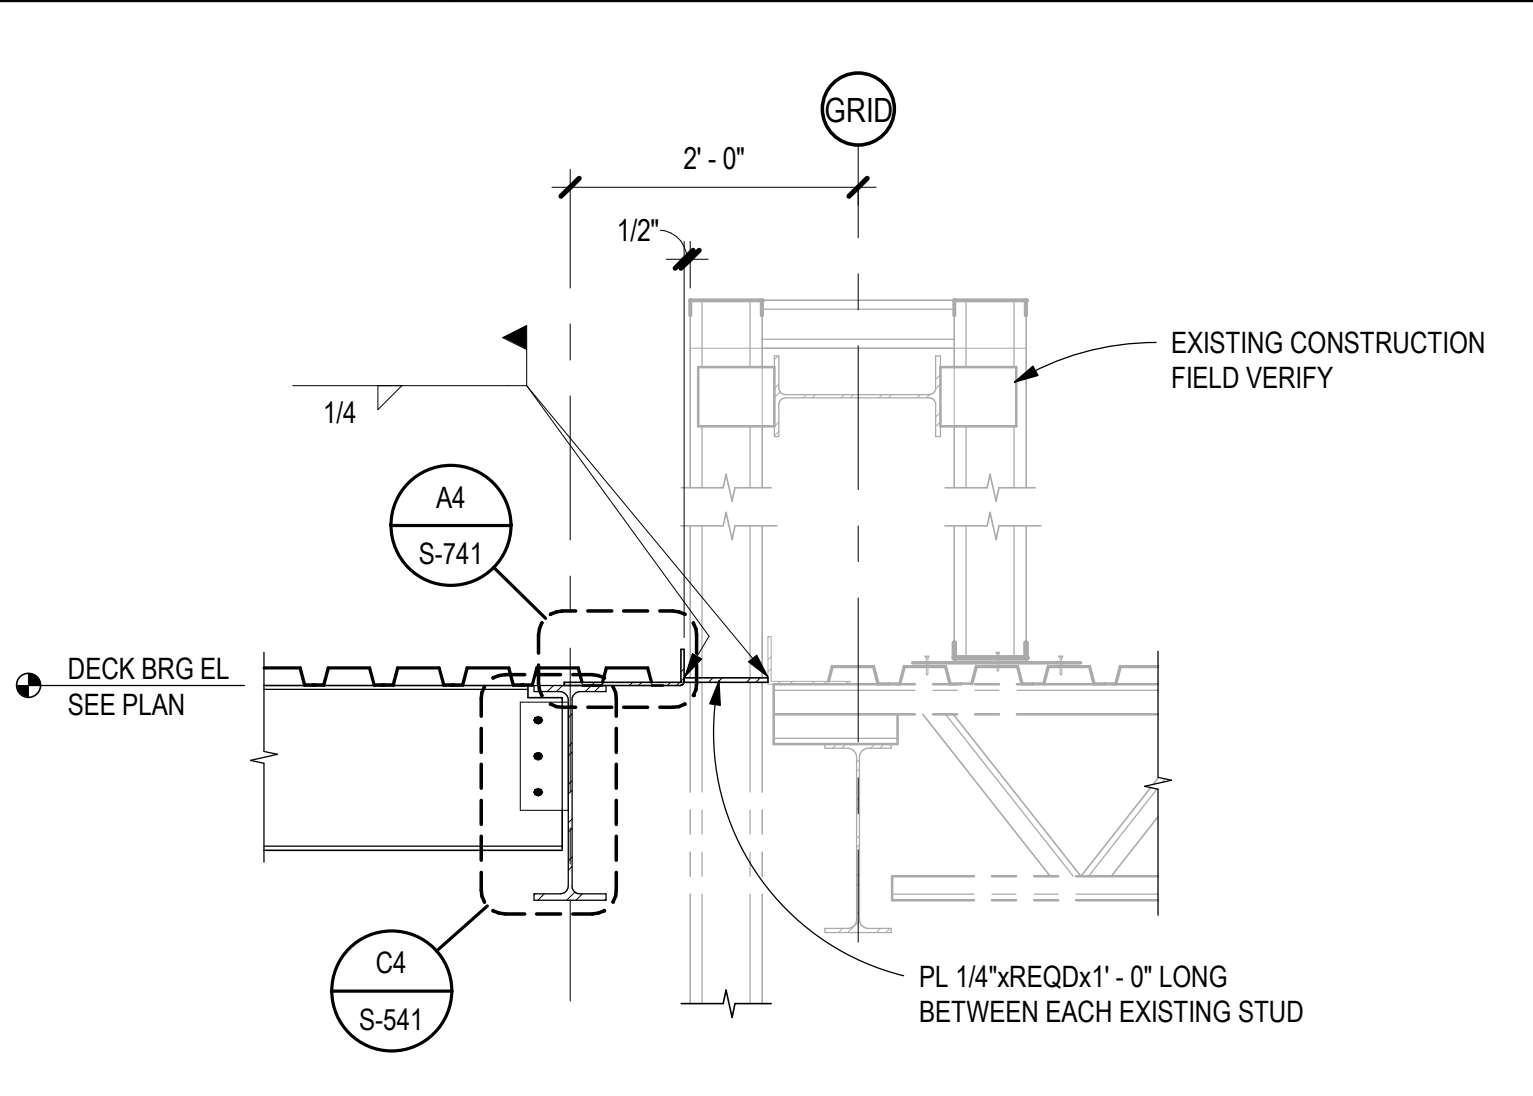


C2 ROOF FRAMING SECTION
SCALE: 3/4" = 1'-0"

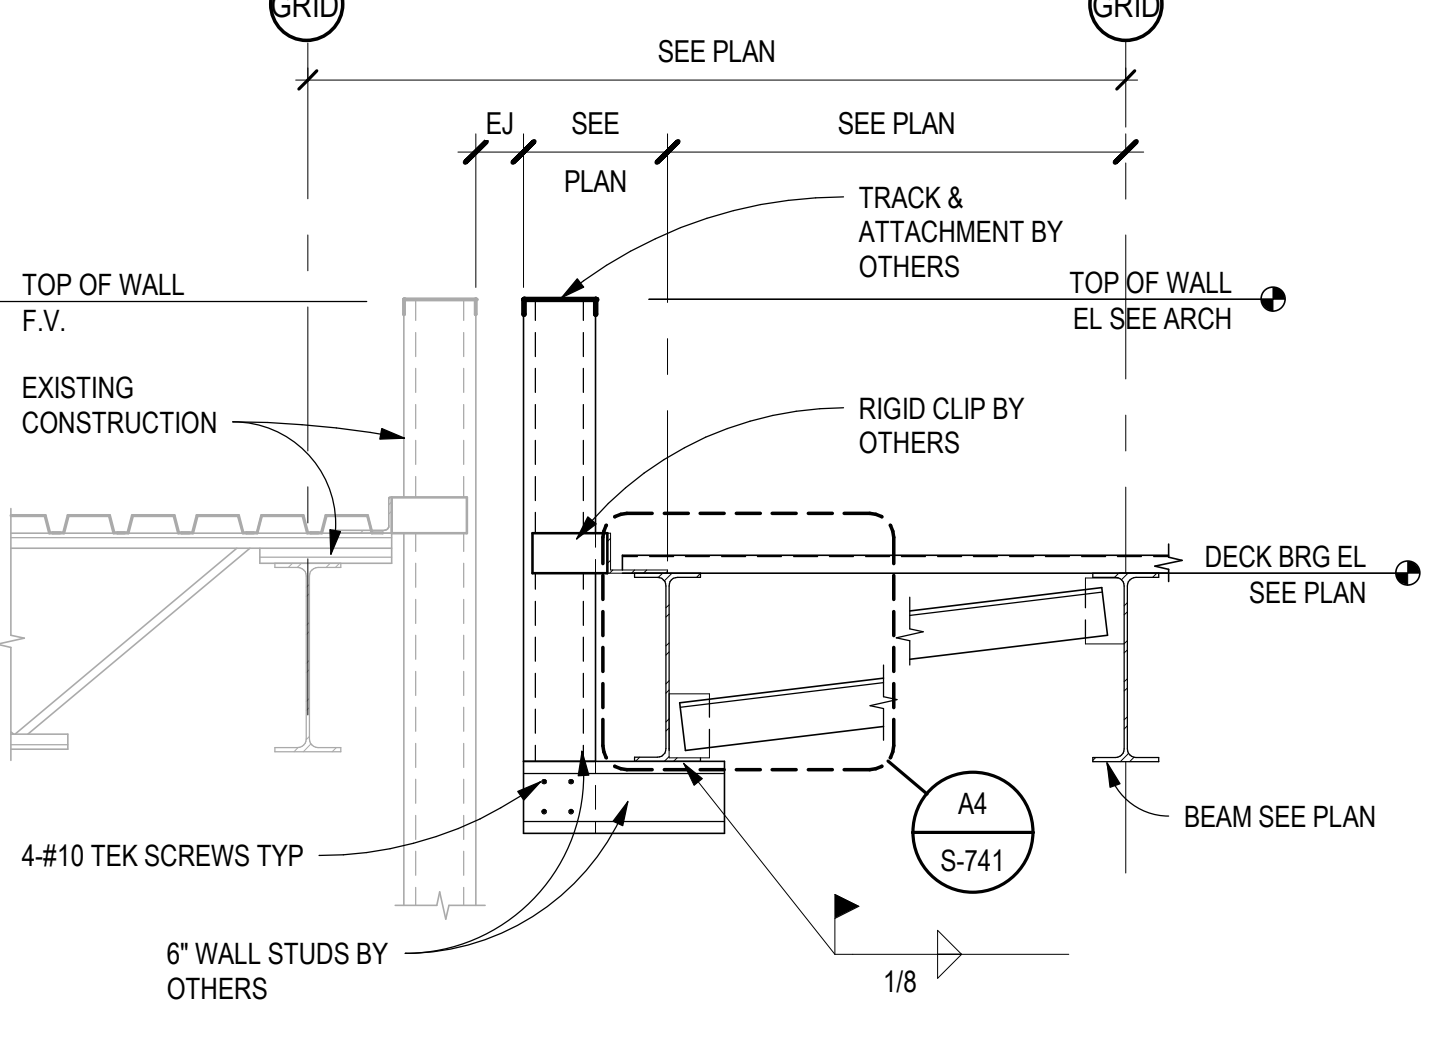


C3 ROOF FRAMING SECTION
SCALE: 3/4" = 1'-0"

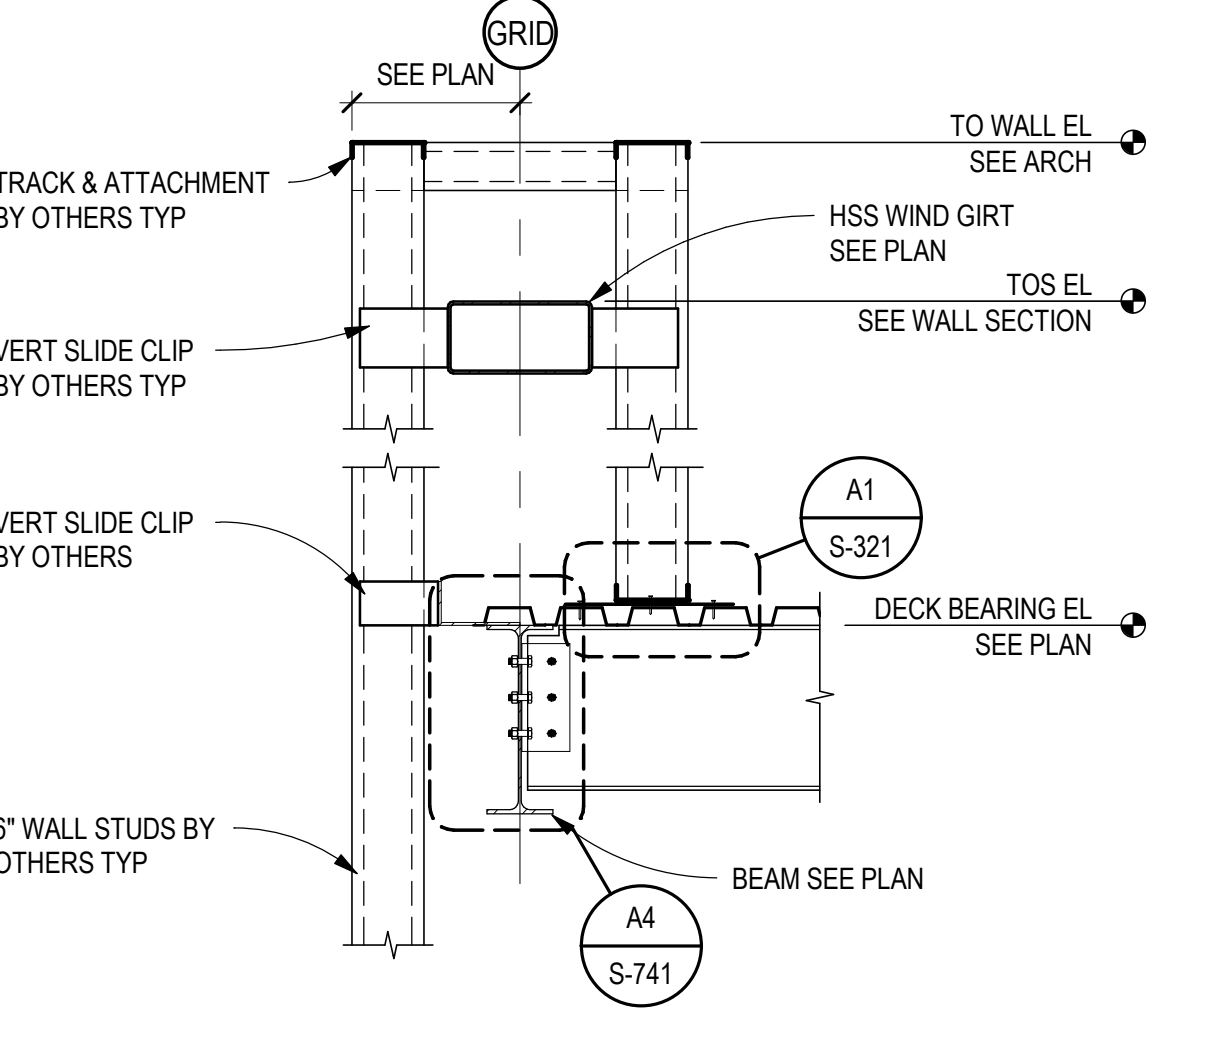


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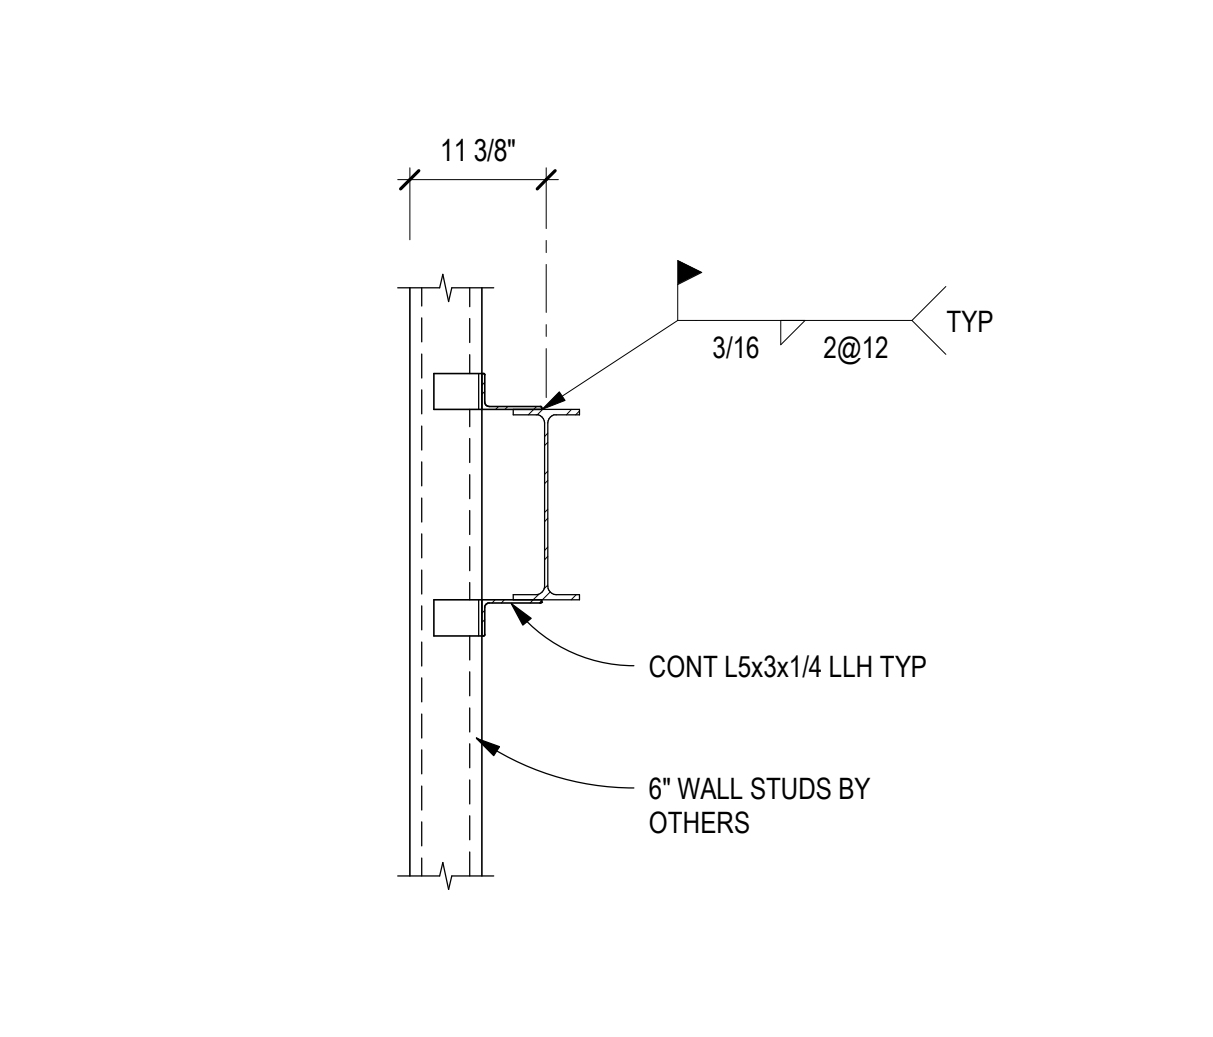
C5 ROOF FRAMING SECTION
SCALE: 3/4" = 1'-0"

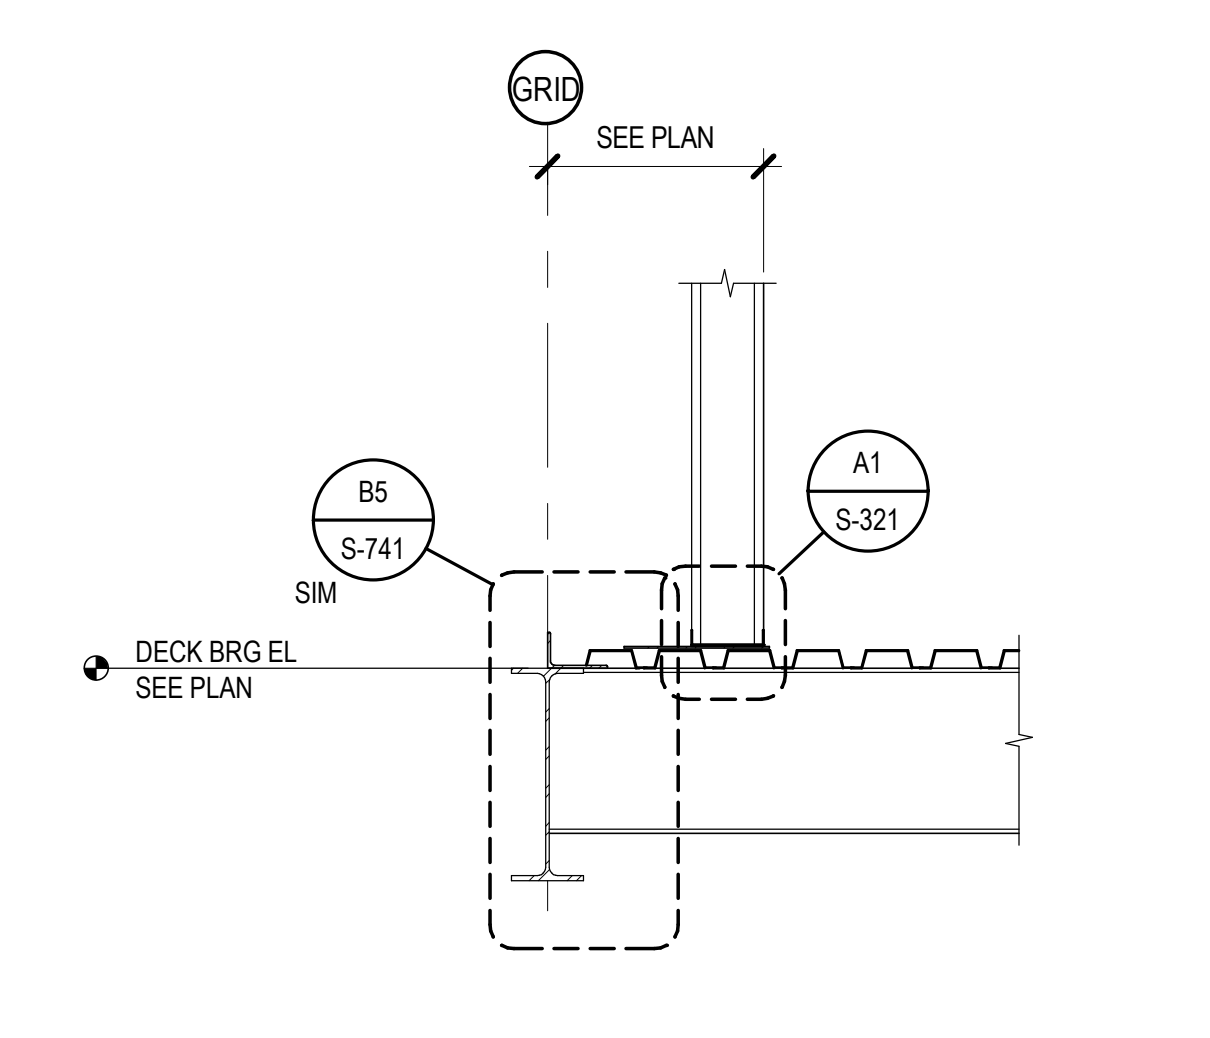


B1 NEW PARAPET AT EXISTING PARAPET
SCALE: 3/4" = 1'-0"

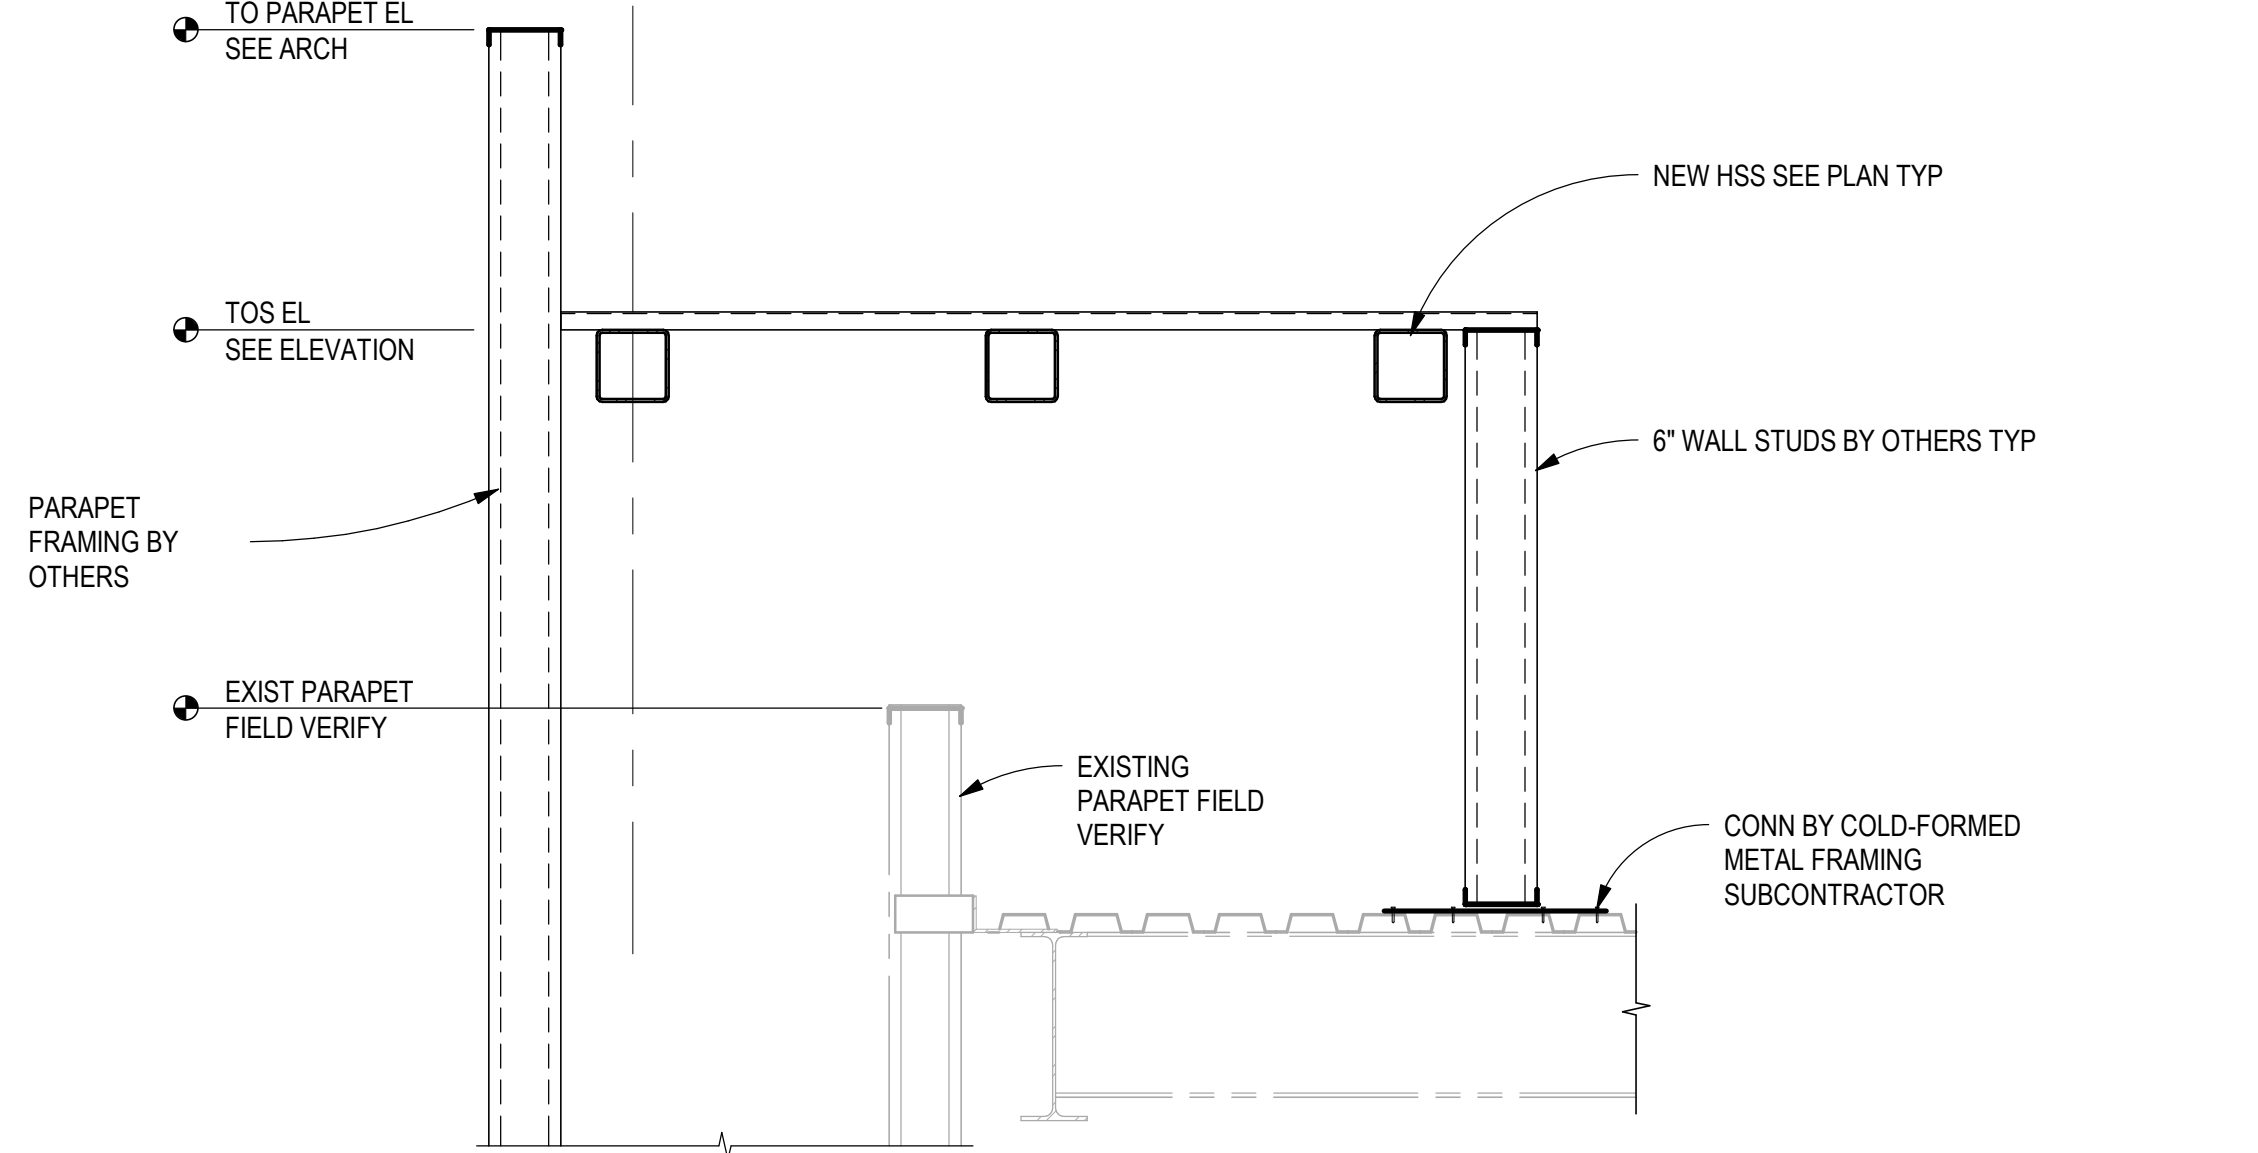


B3 ROOF FRAMING SECTION
SCALE: 3/4" = 1'-0"

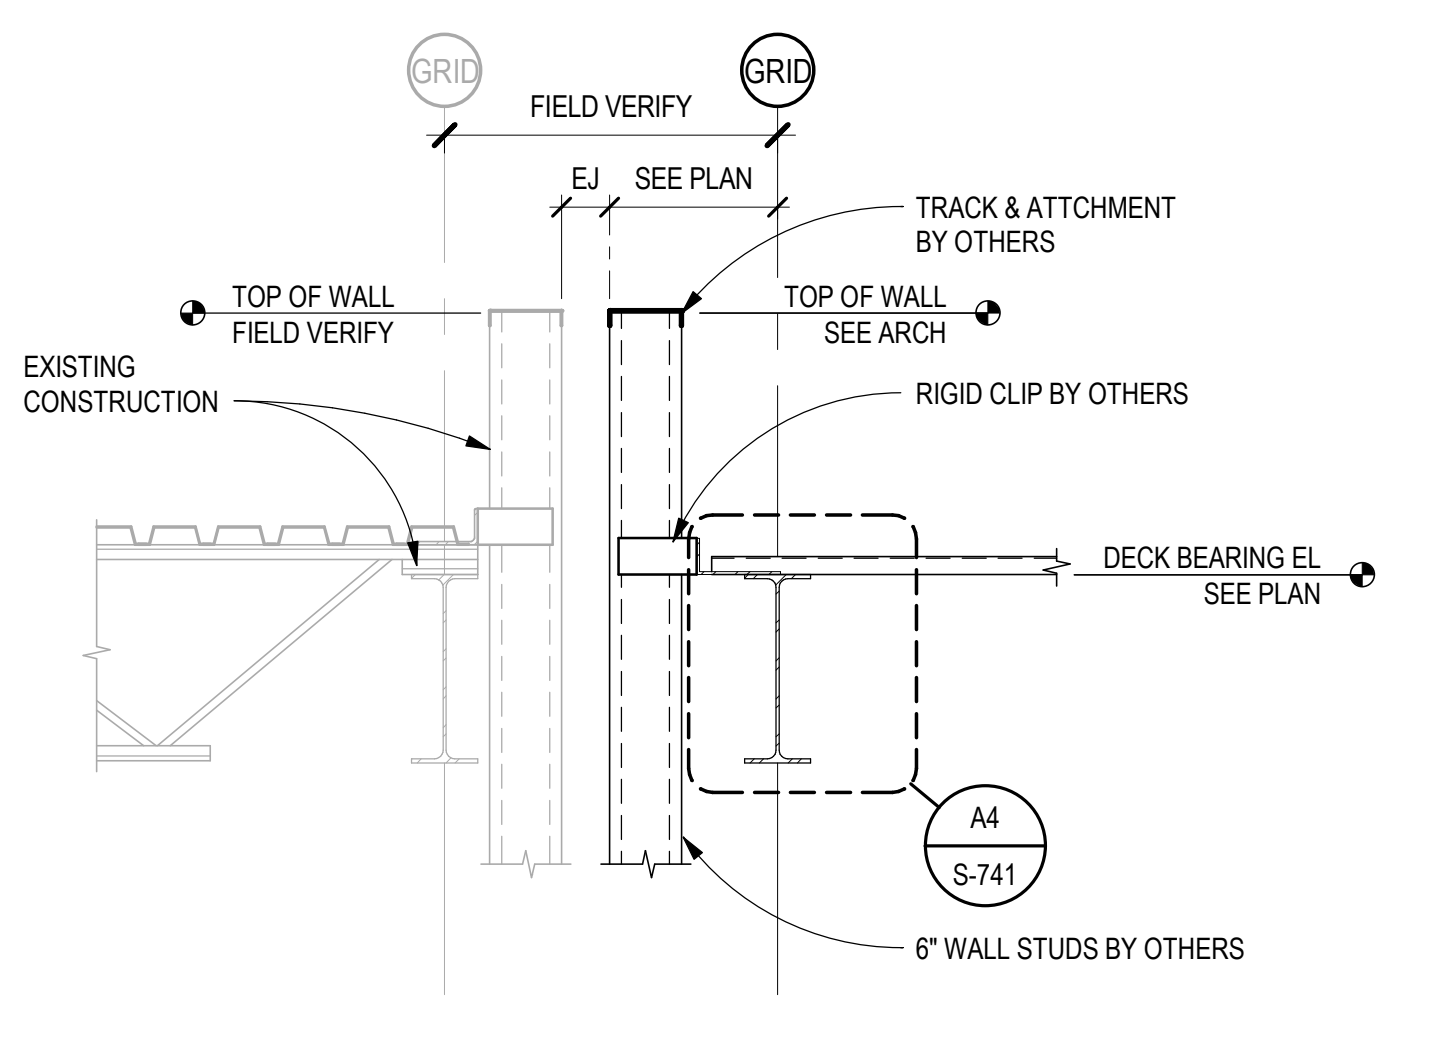


B4 FRAMING SECTION
SCALE: 3/4" = 1'-0"

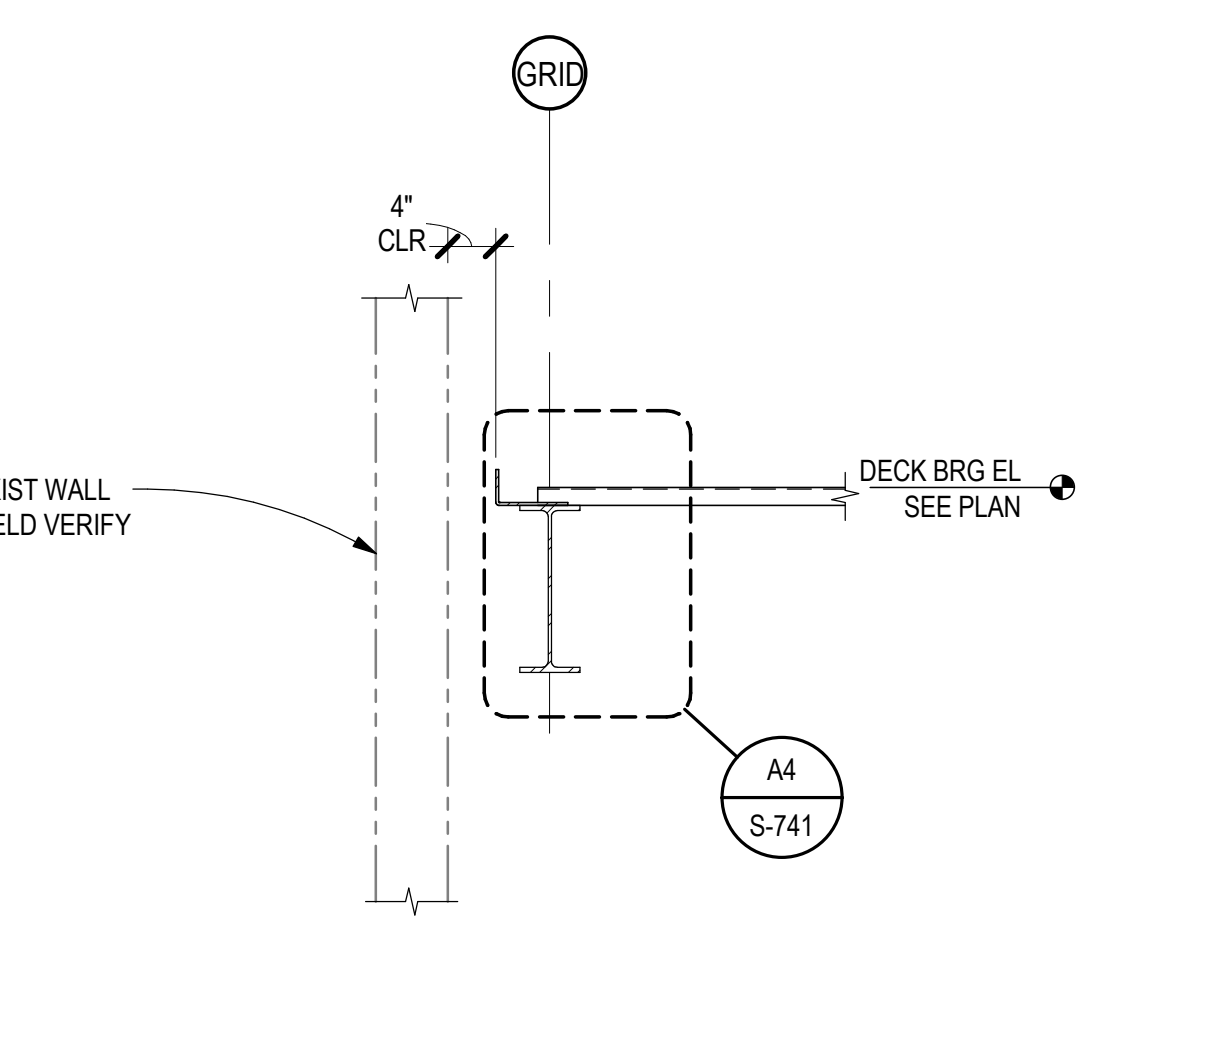


B5 ROOF FRAMING SECTION
SCALE: 3/4" = 1'-0"

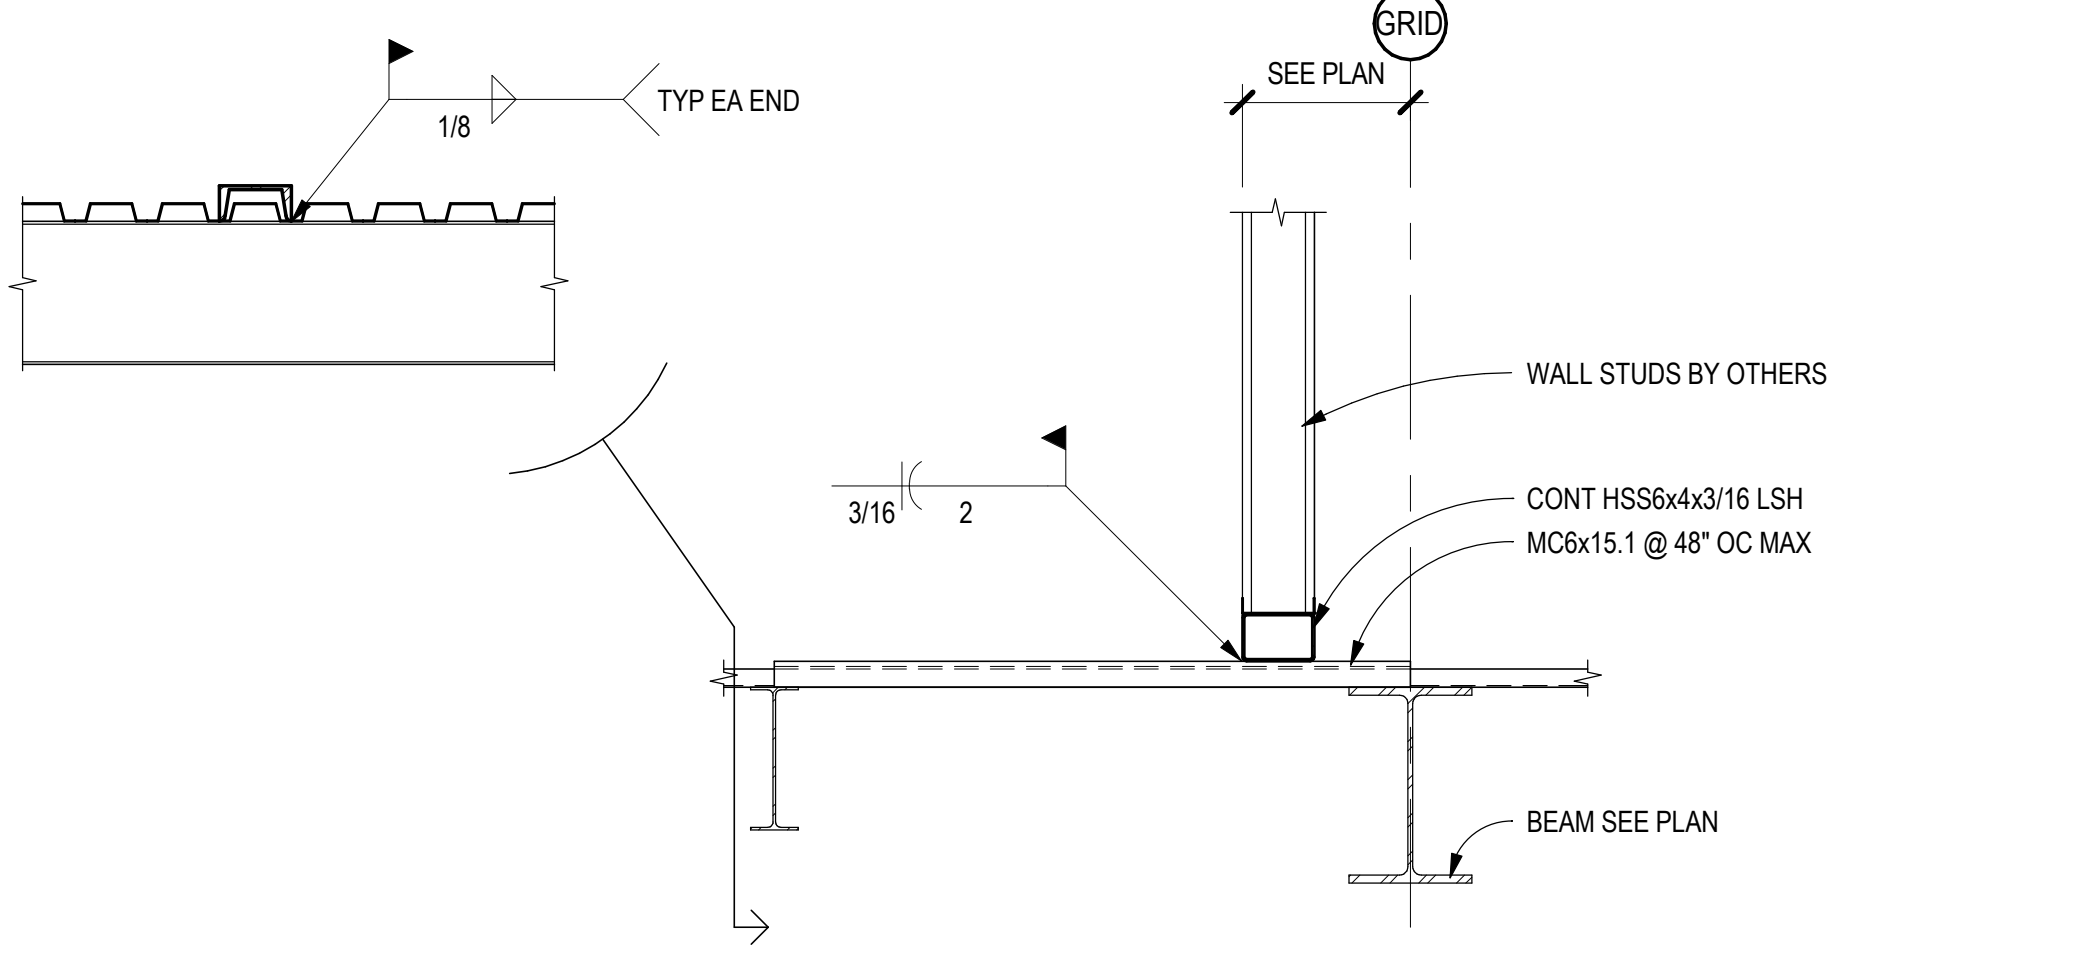


A1 TYPICAL STUD AT METAL DECK
SCALE: 3/4" = 1'-0"

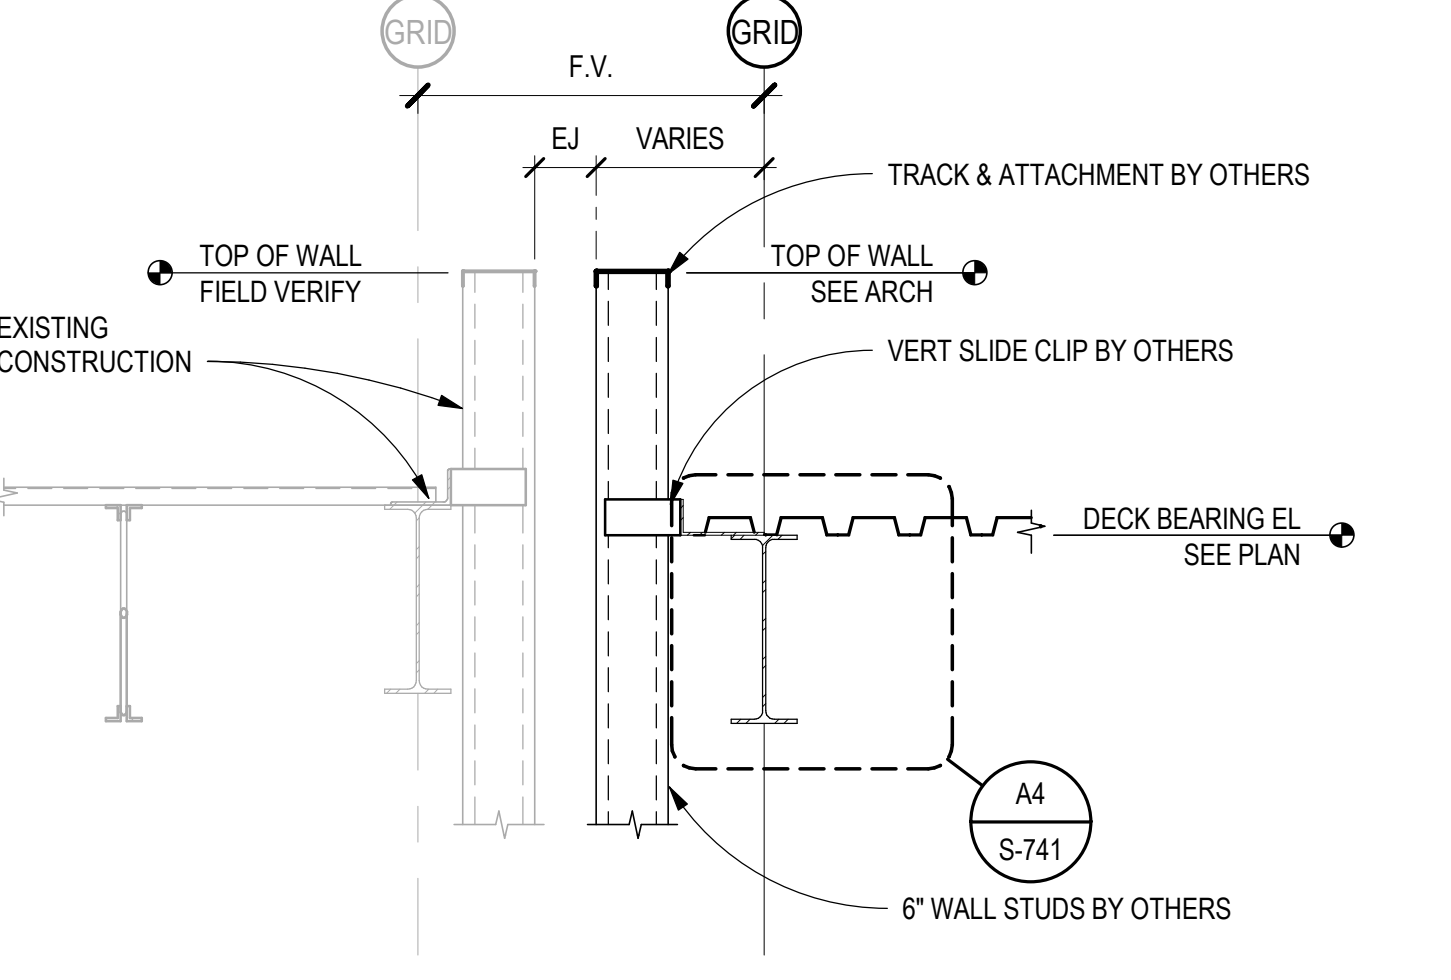

A3 SECTION AT EXISTING ROOF
SCALE: 3/4" = 1'-0"

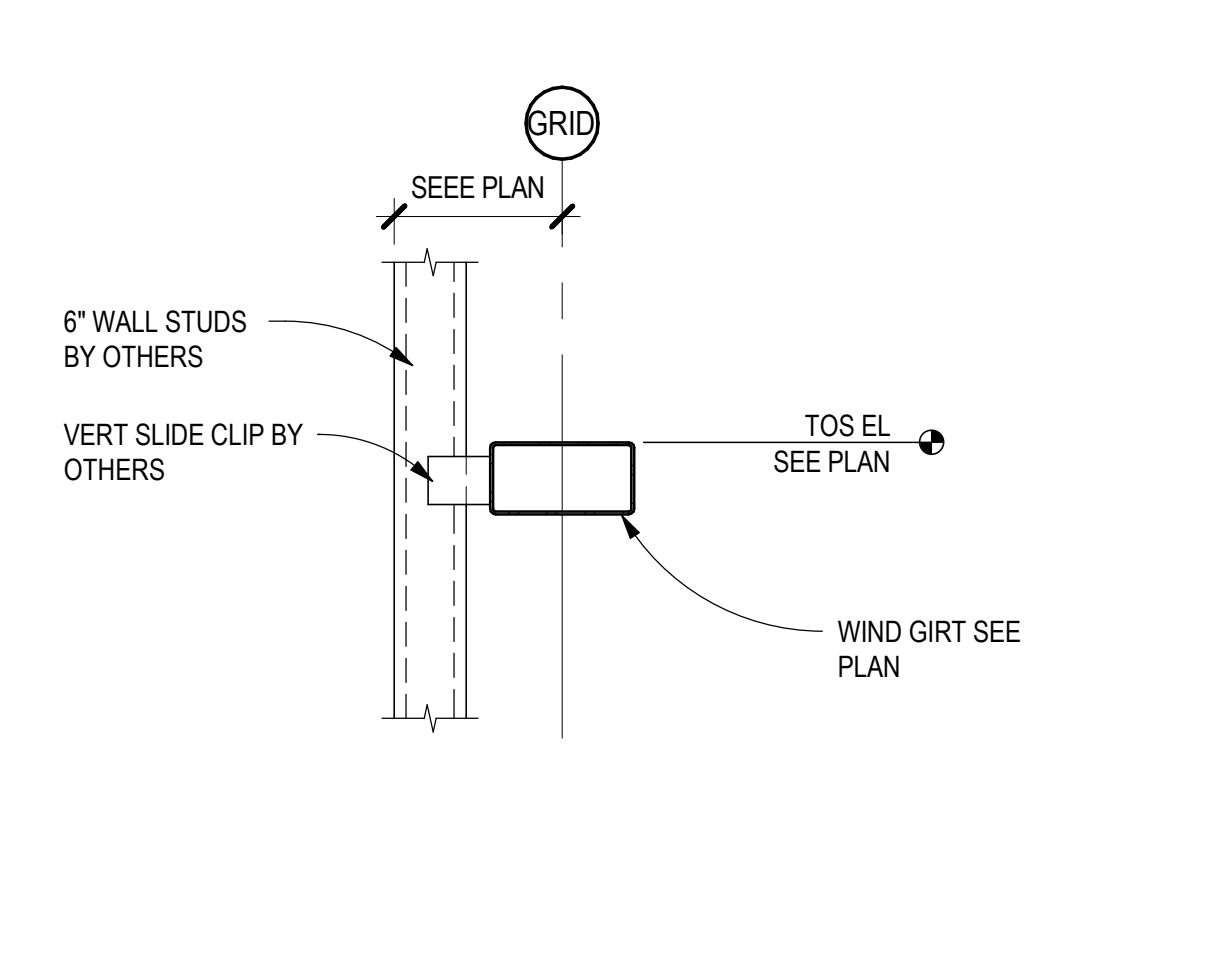

A4 FRAMING SECTION
SCALE: 3/4" = 1'-0"

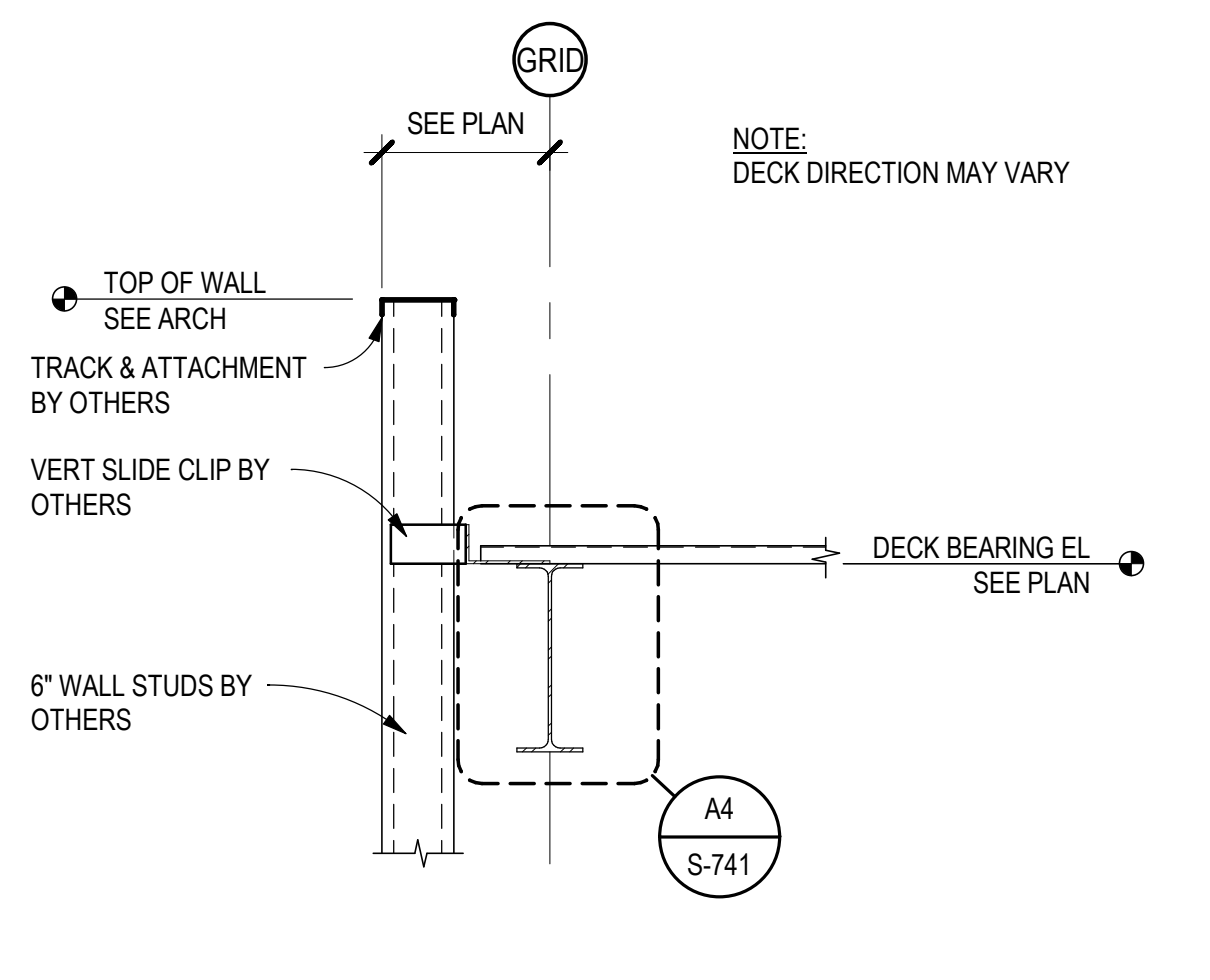

A5 ROOF FRAMING SECTION
SCALE: 3/4" = 1'-0"

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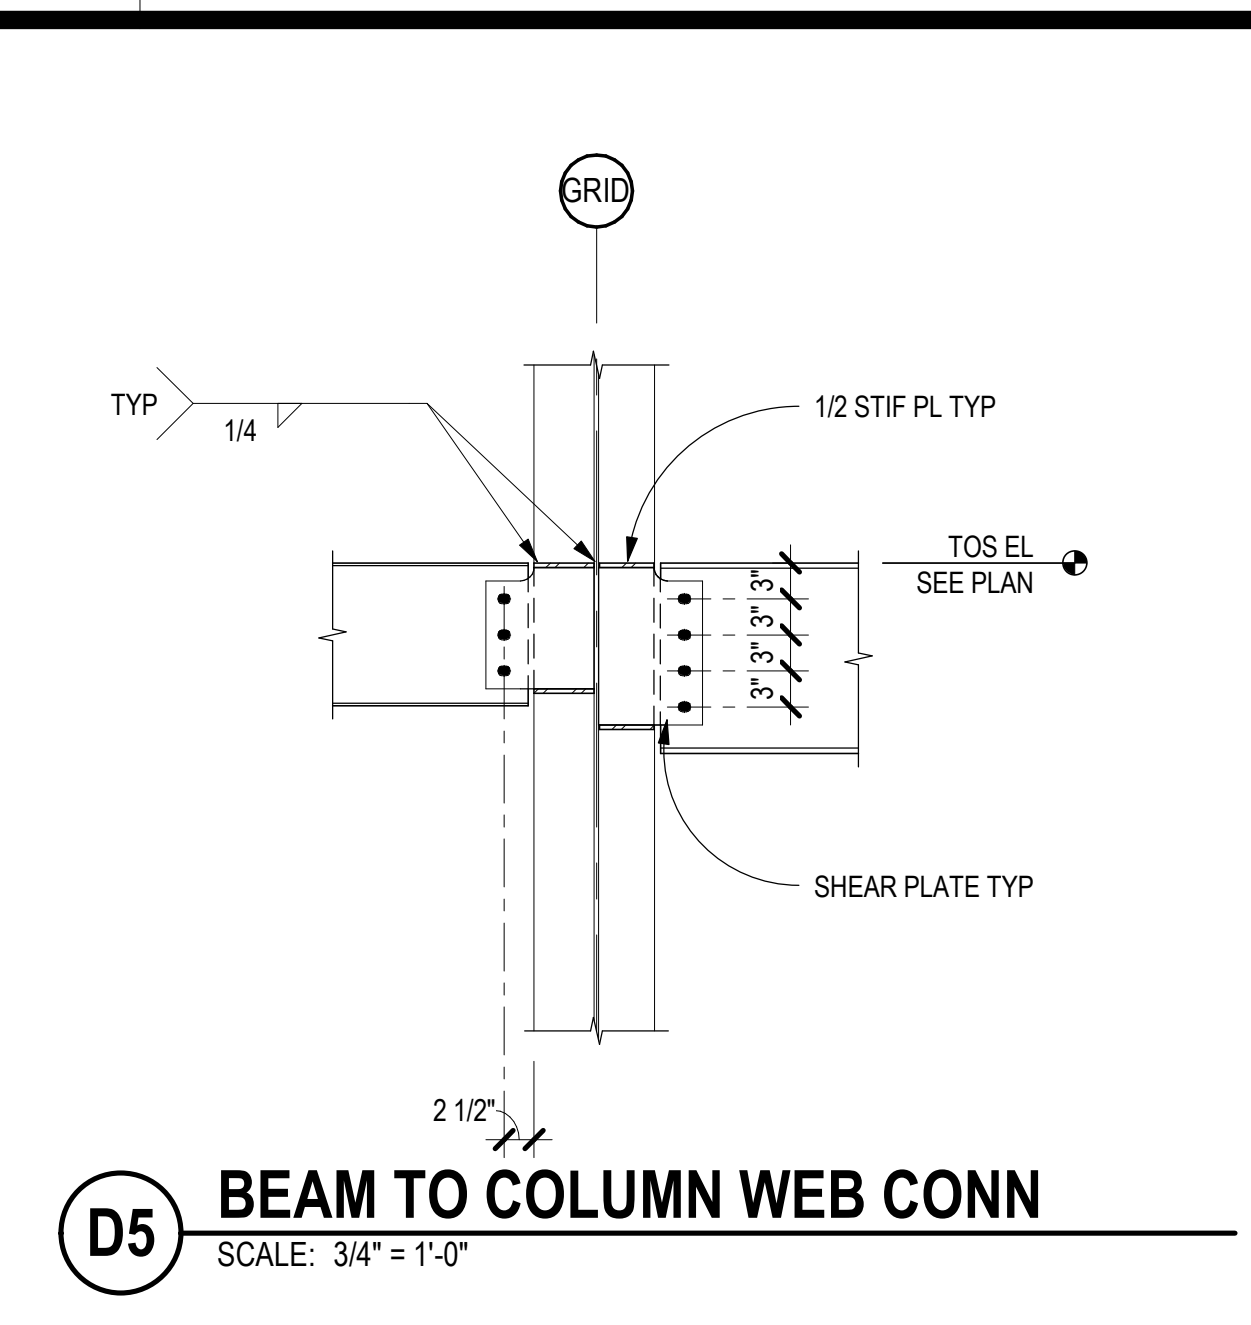
EXTERIOR FACADE RENOVATION

No.	Description	Date


PROJ: H11018.01
DRAWN: J. ANDERSON
CHECKED: C. ROMERO
DATE: 01/16/2019

PROFESSIONAL ENGINEER
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1/16/19


S-541
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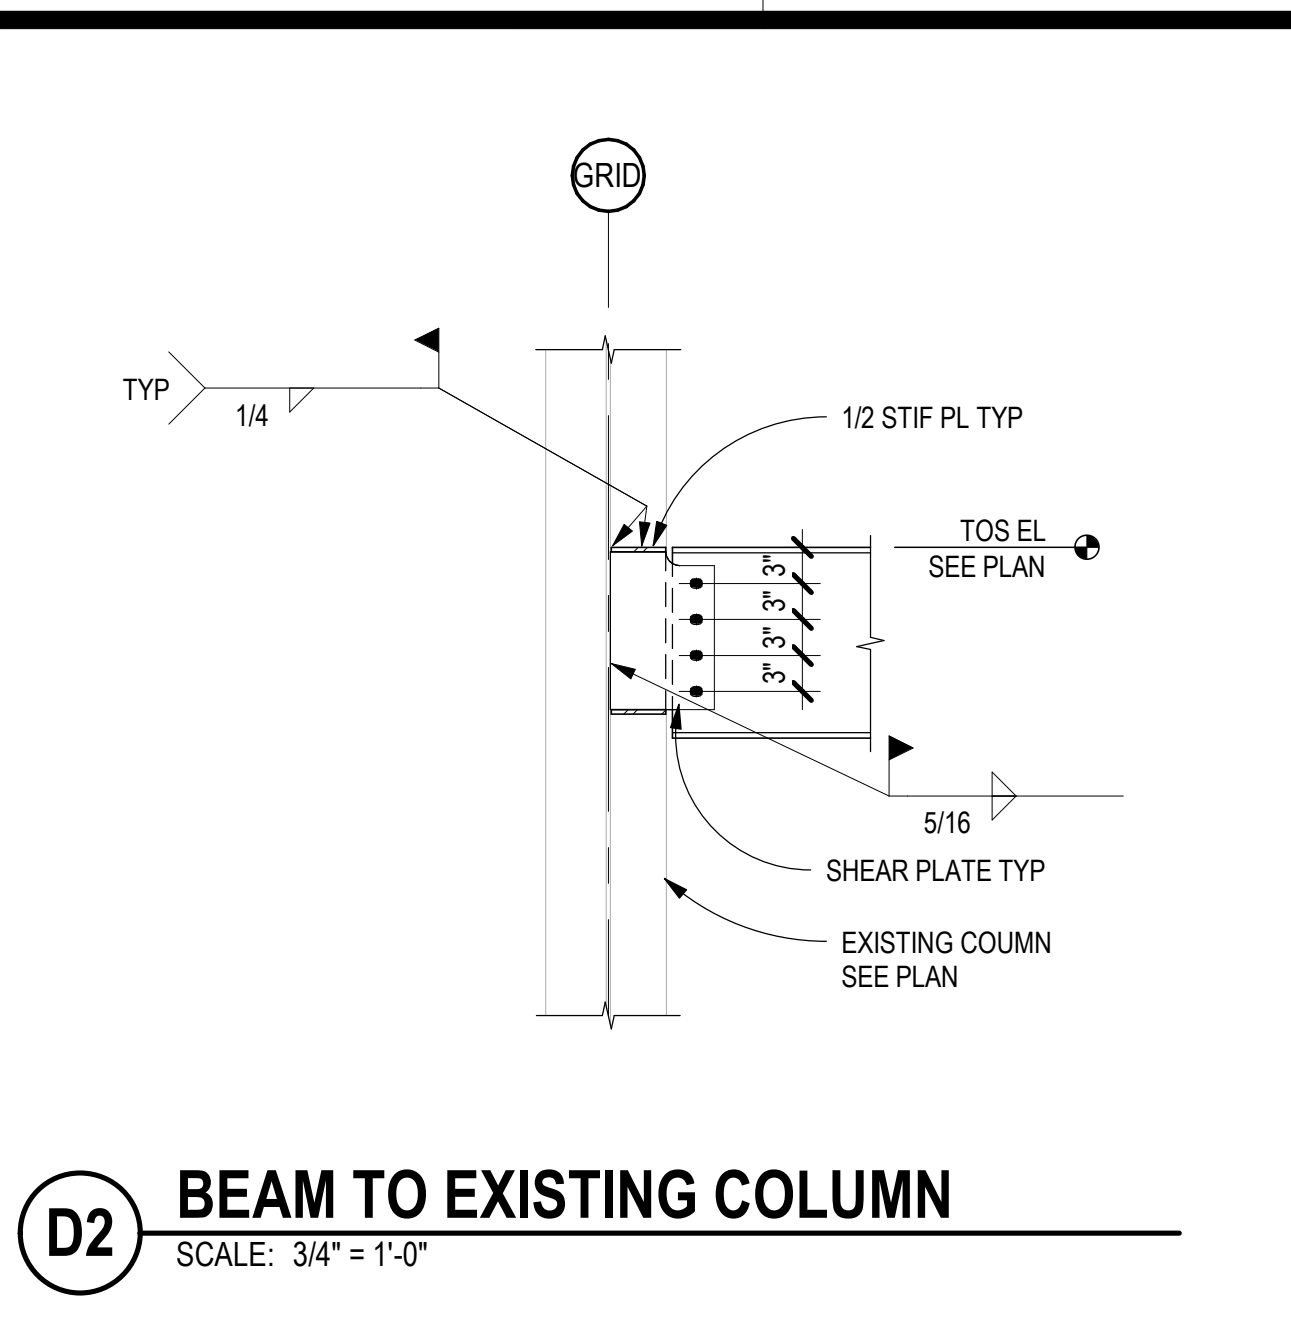
D5 BEAM TO COLUMN WEB CONN
SCALE: 3/4" = 1'-0"




D4 SKEWED BEAM TO BEAM CONN
SCALE: 3/4" = 1'-0"

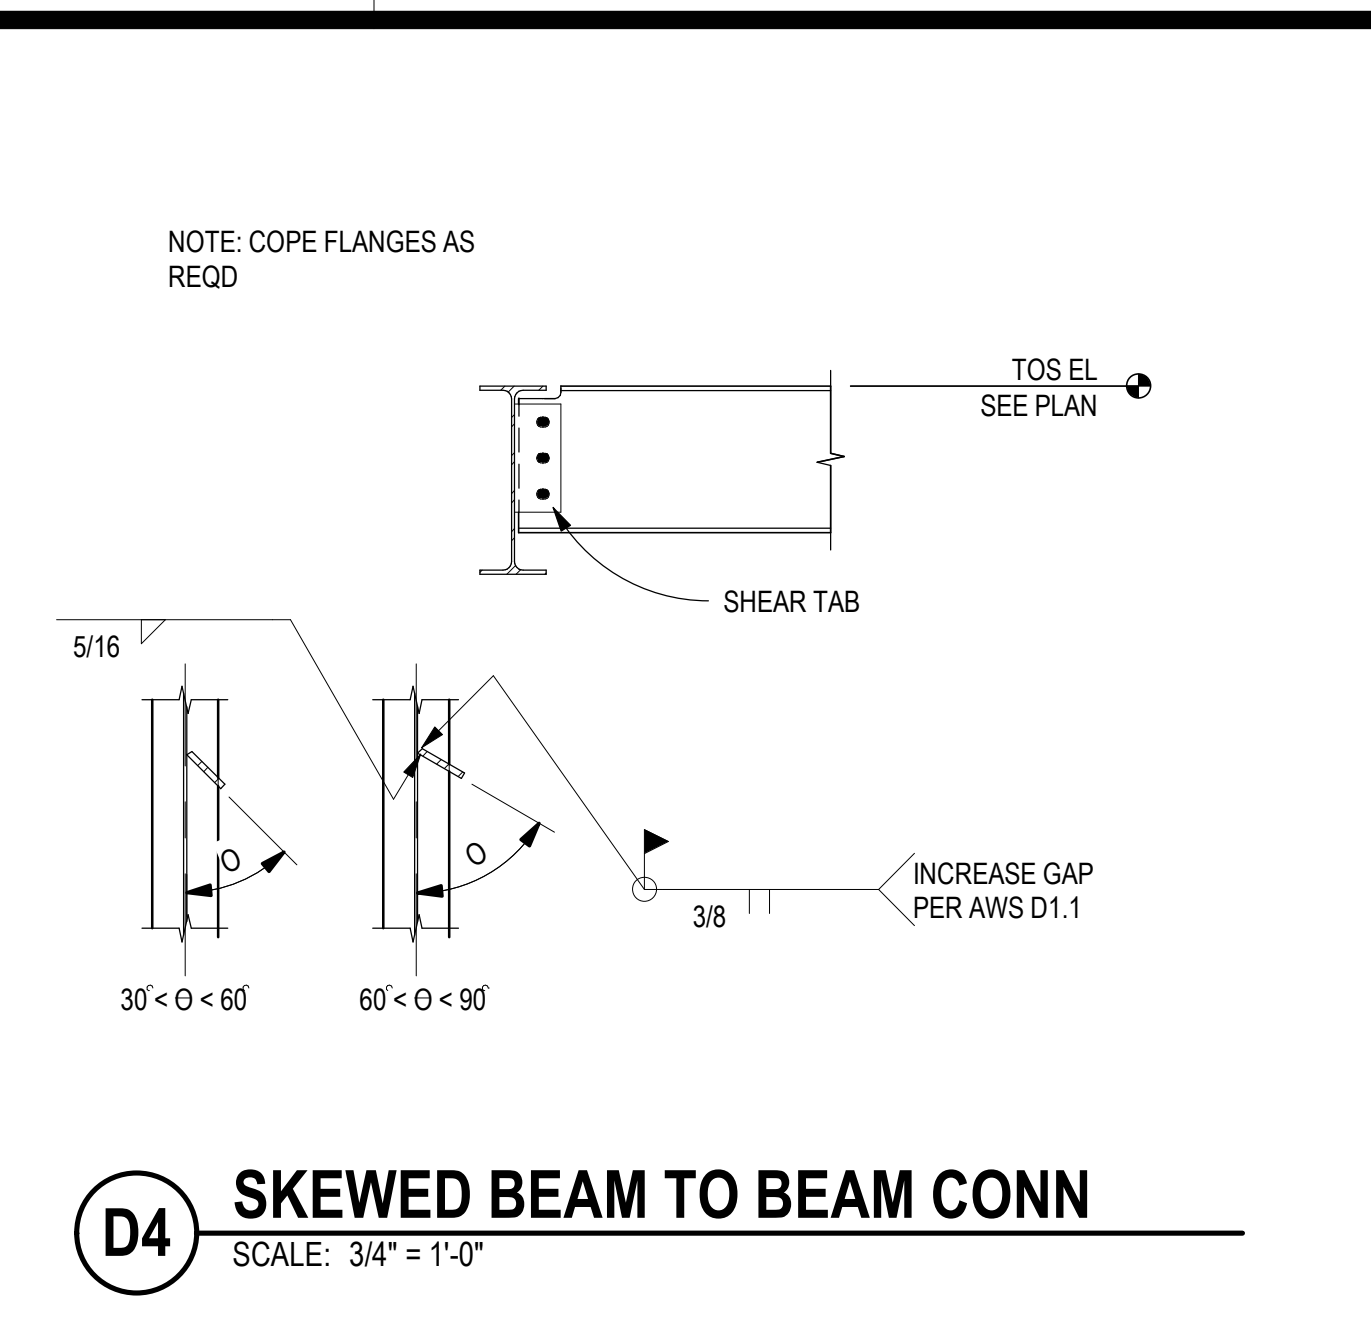


D3 WF POST TO TRANSFER GIRDER
SCALE: 3/4" = 1'-0"

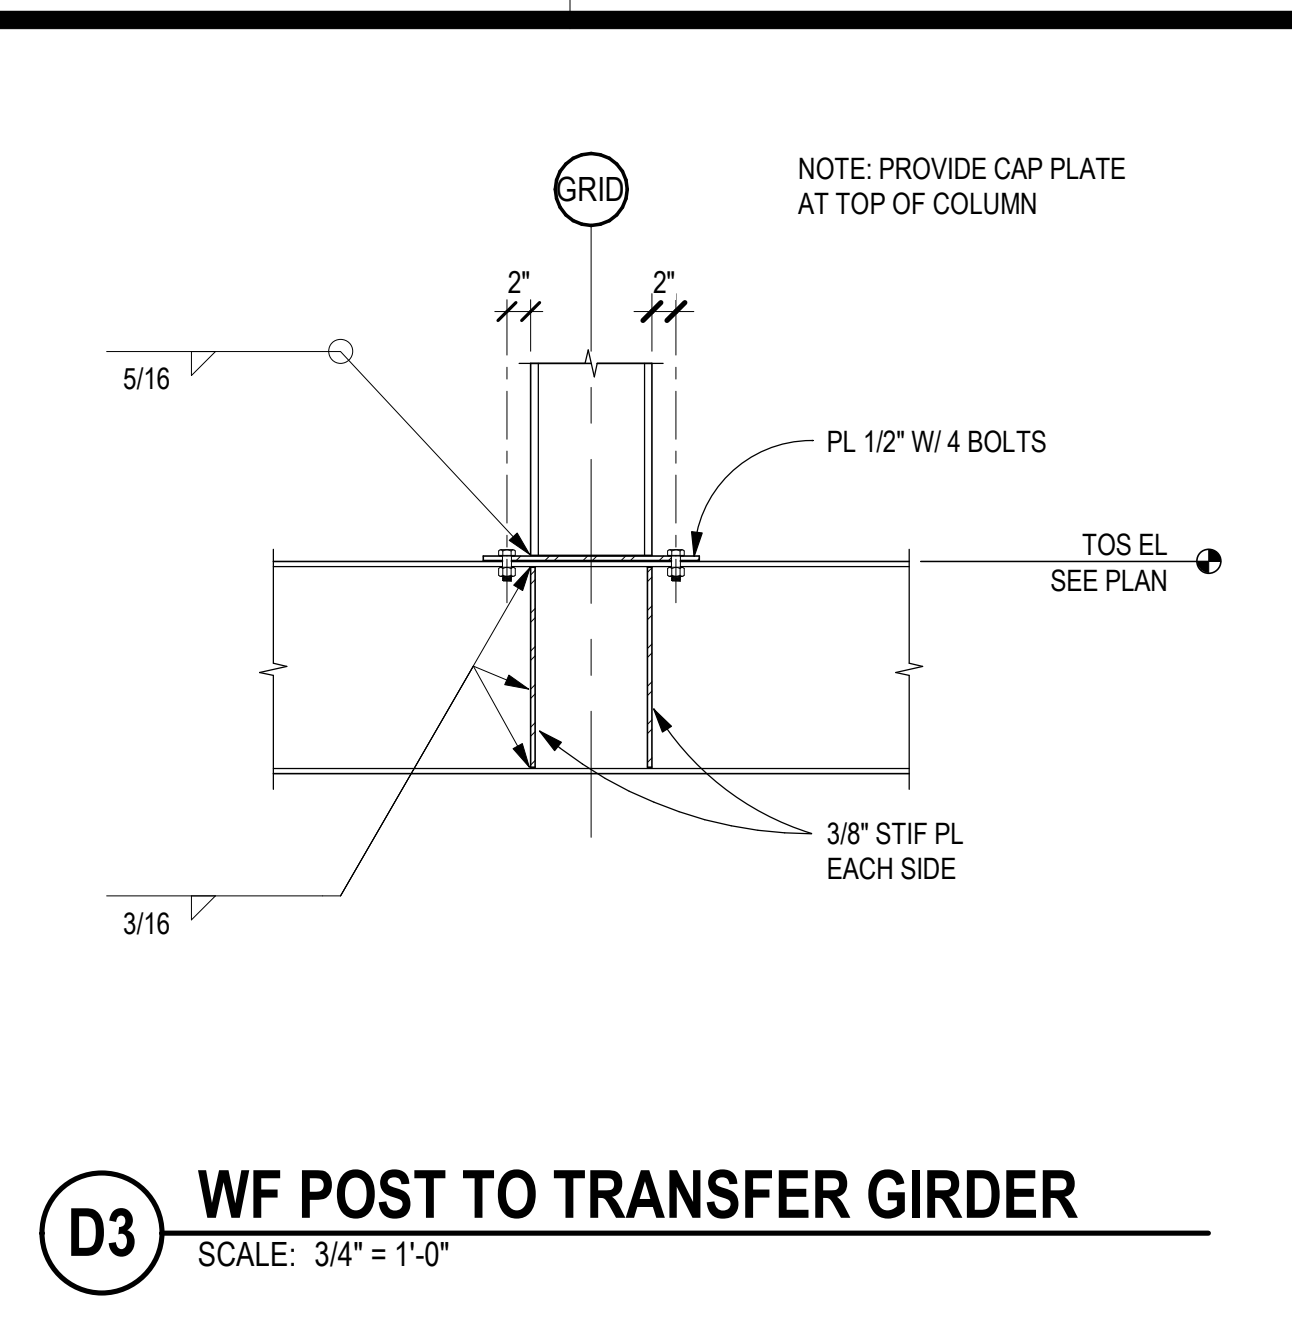


D2 BEAM TO EXISTING COLUMN
SCALE: 3/4" = 1'-0"

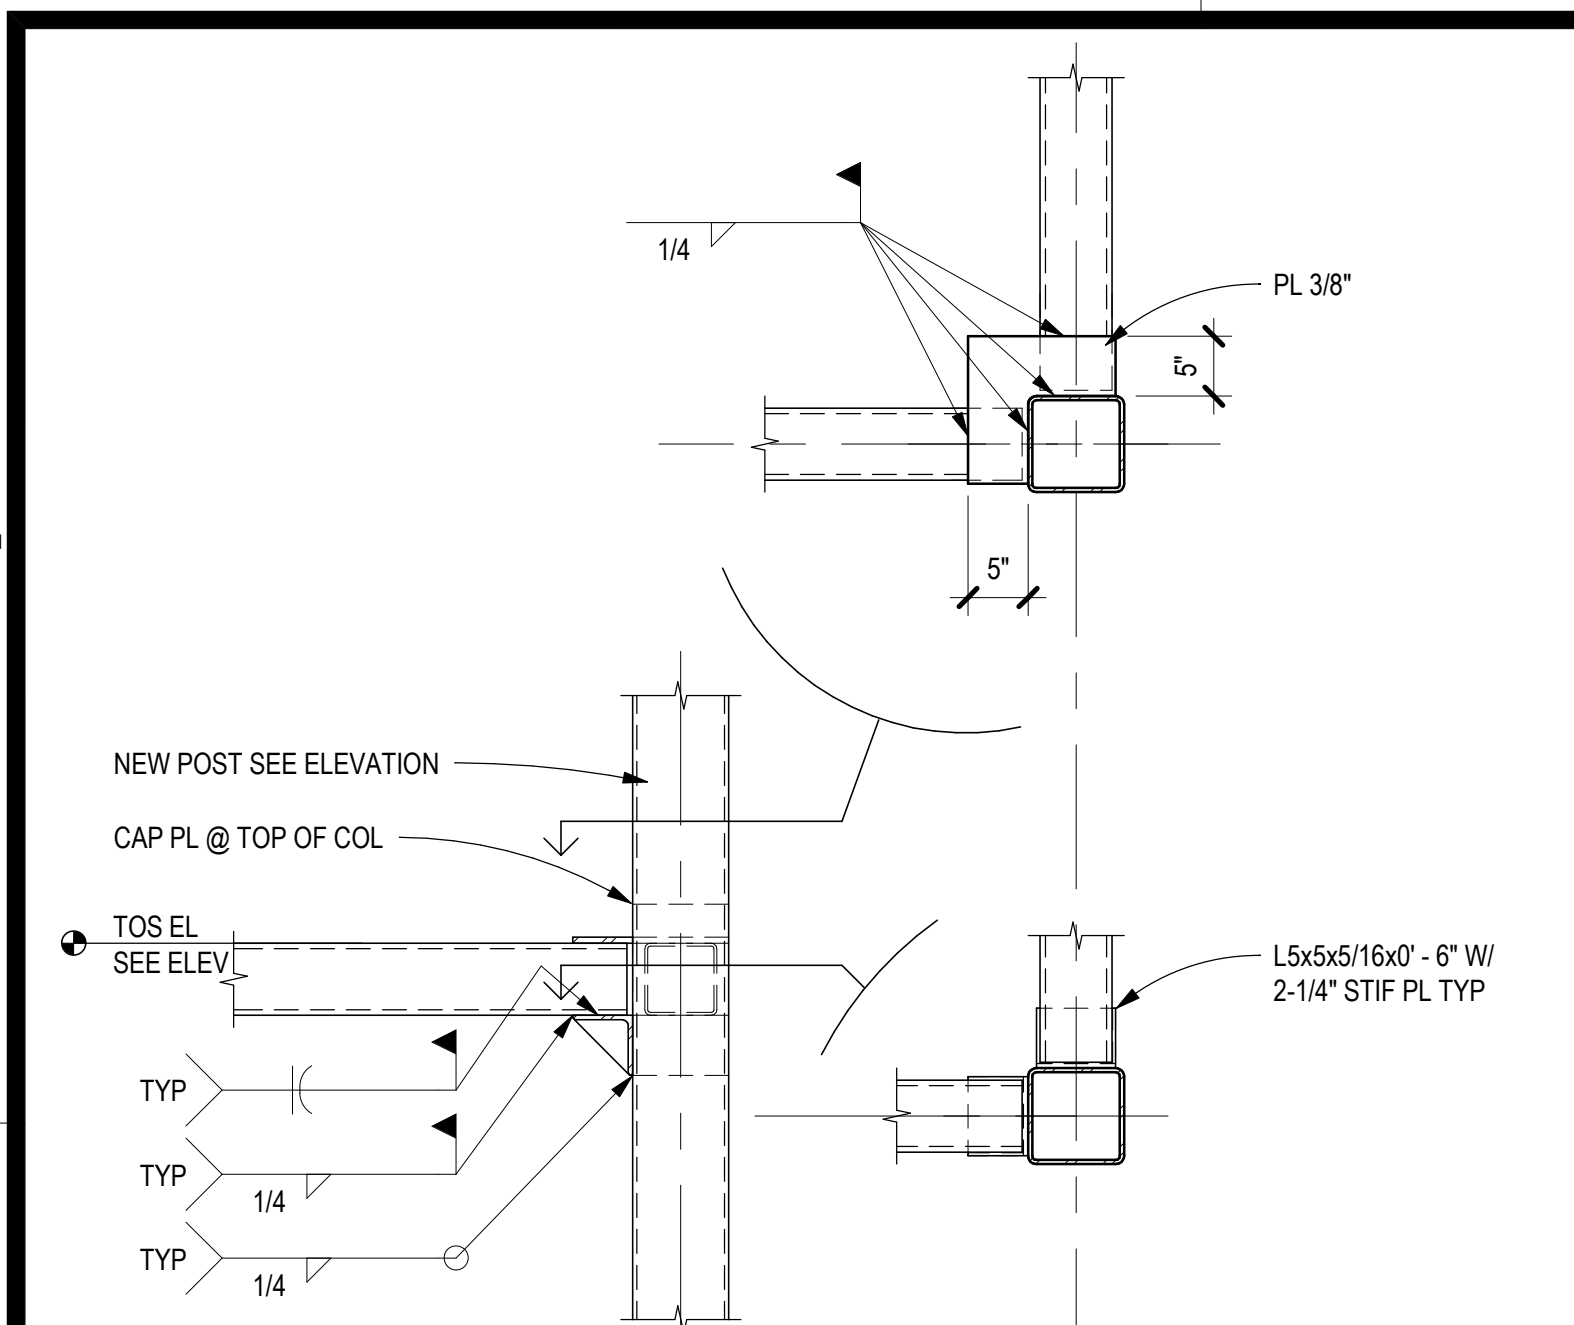


D1 HSS WIND GIRTS TO HSS POST
SCALE: 3/4" = 1'-0"

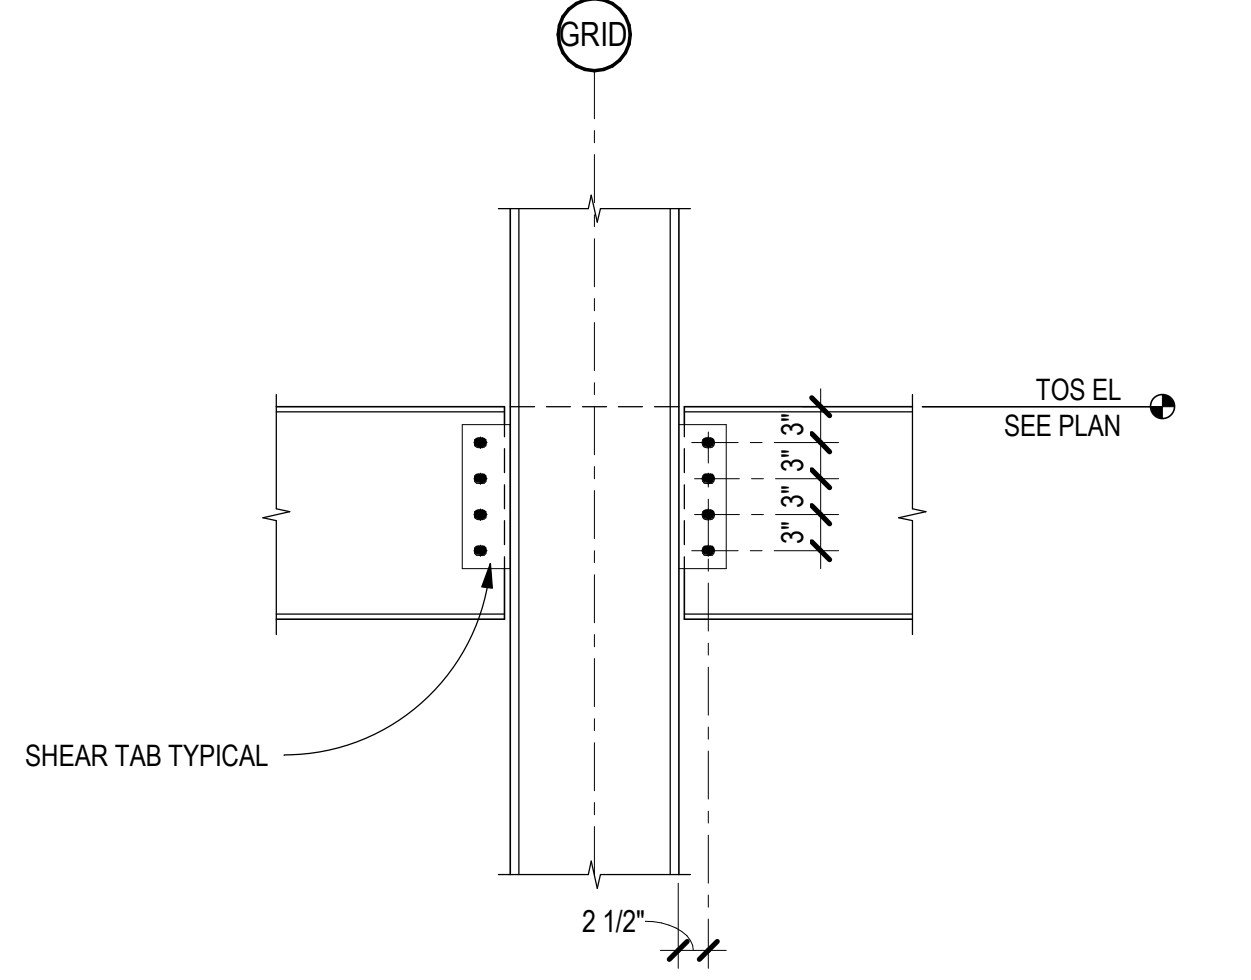


C5 BEAM TO COLUMN FLANGE CONN
SCALE: 3/4" = 1'-0"

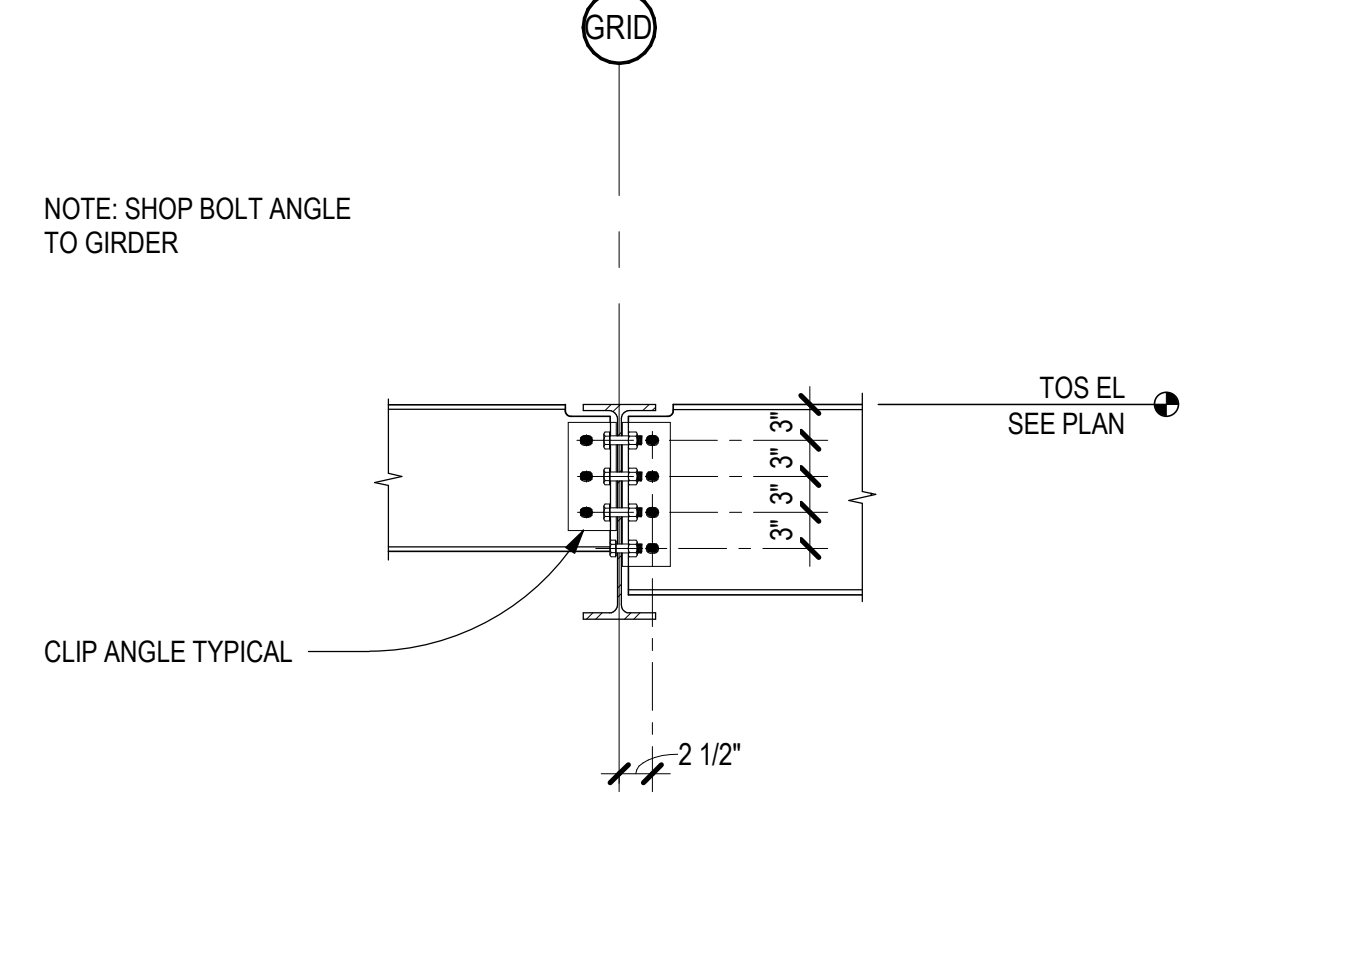


C4 TYPICAL BEAM TO BEAM CONN
SCALE: 3/4" = 1'-0"

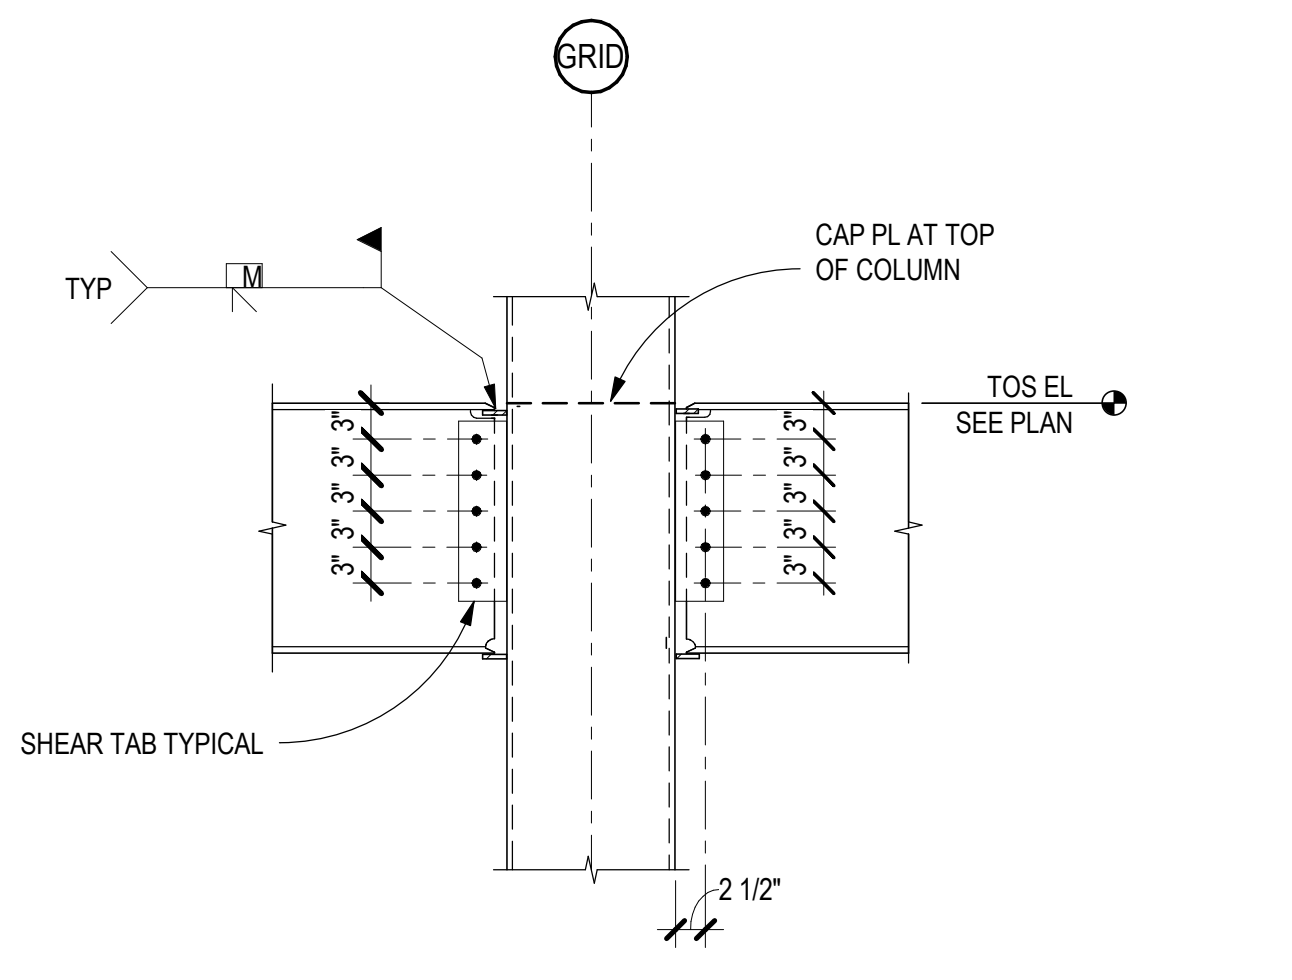


C3 BM TO HSS COL MOMENT CONN
SCALE: 3/4" = 1'-0"

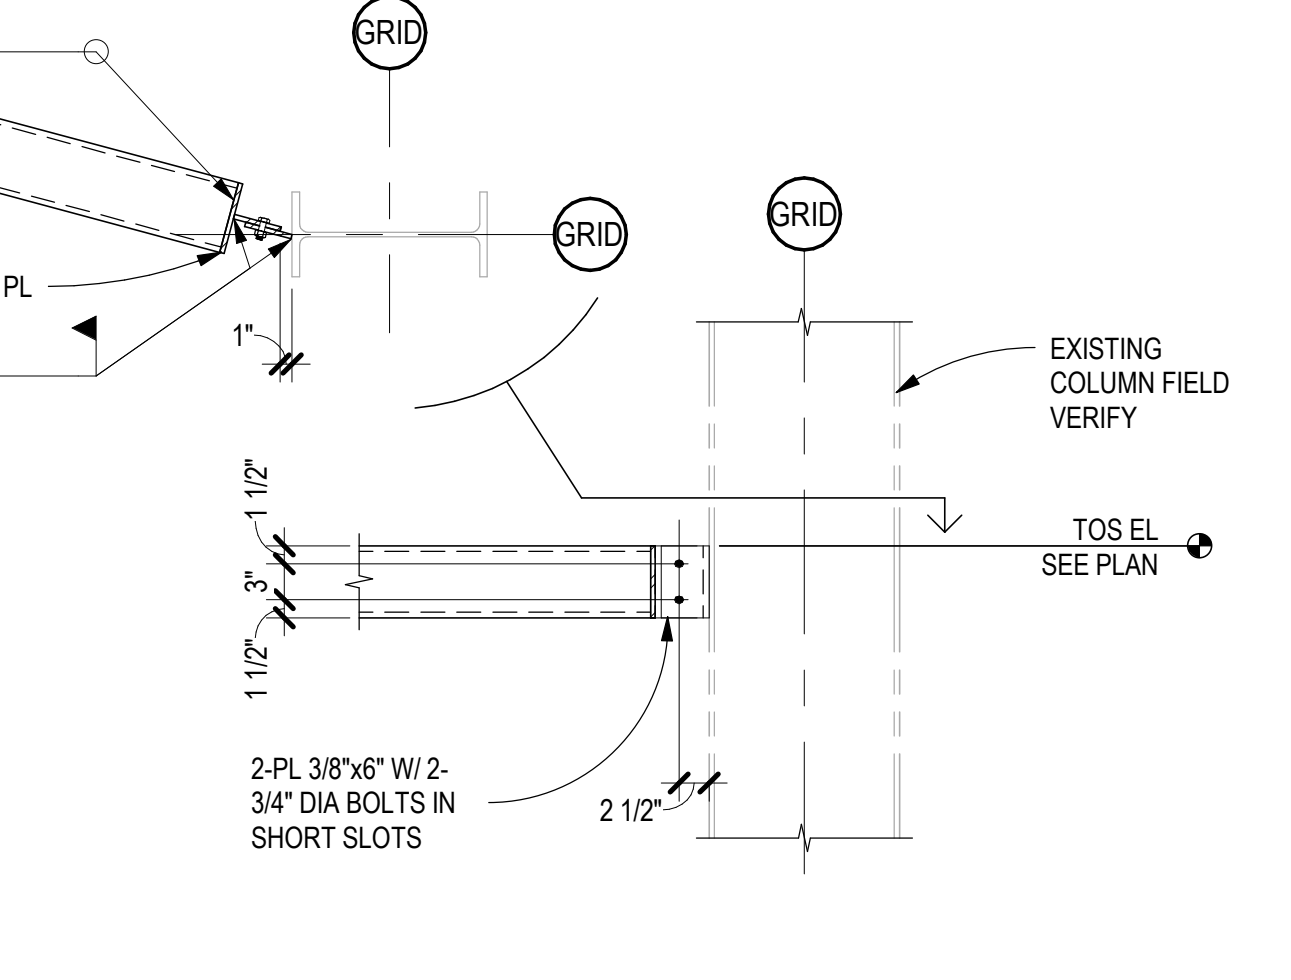


C2 NEW HSS TO EXISTING COL FLANGE
SCALE: 3/4" = 1'-0"

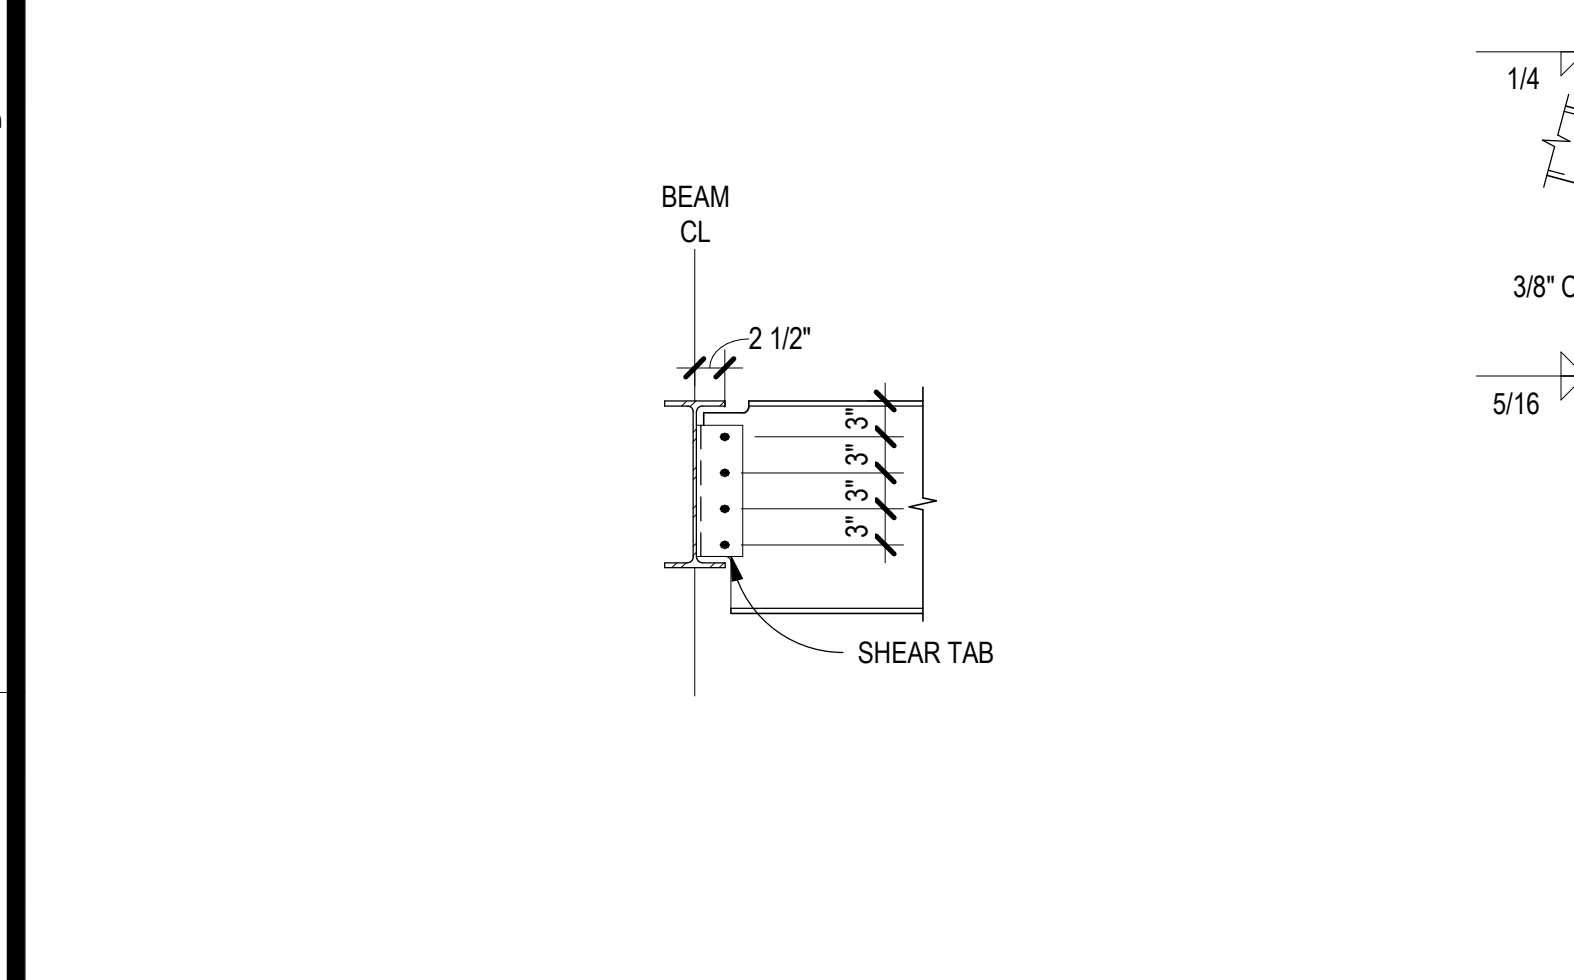


C1 BEAM TO SHALLOW GIRDER
SCALE: 3/4" = 1'-0"

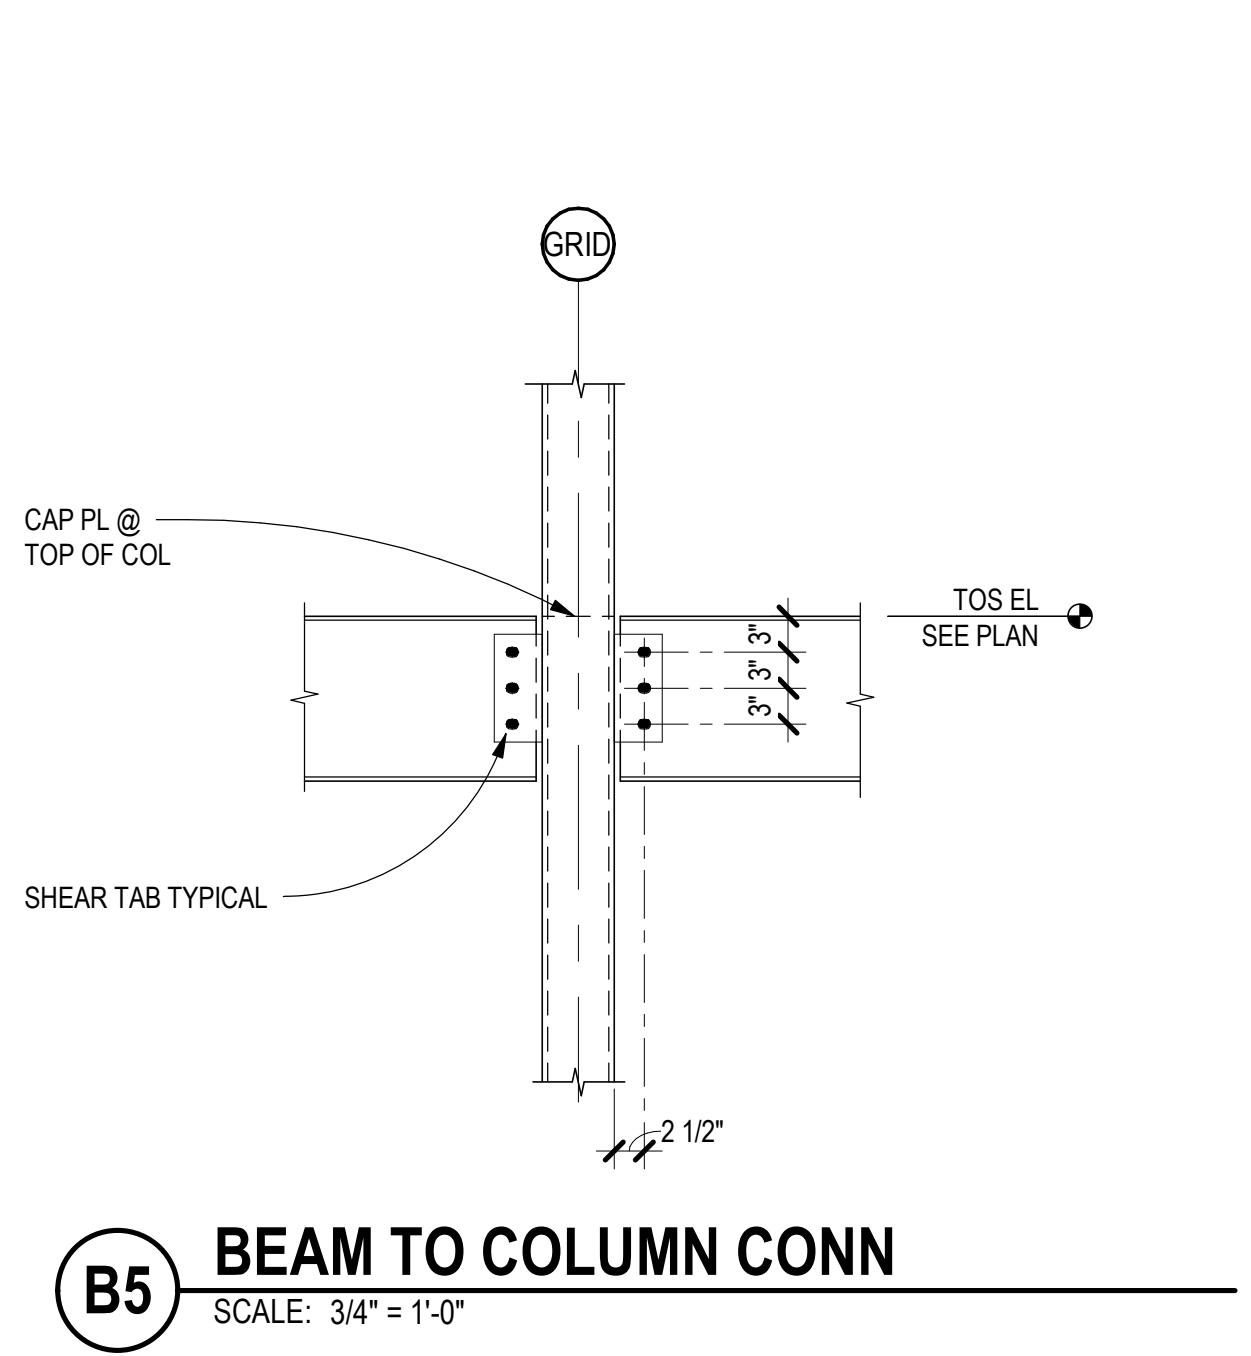


B5 BEAM TO COLUMN CONN
SCALE: 3/4" = 1'-0"

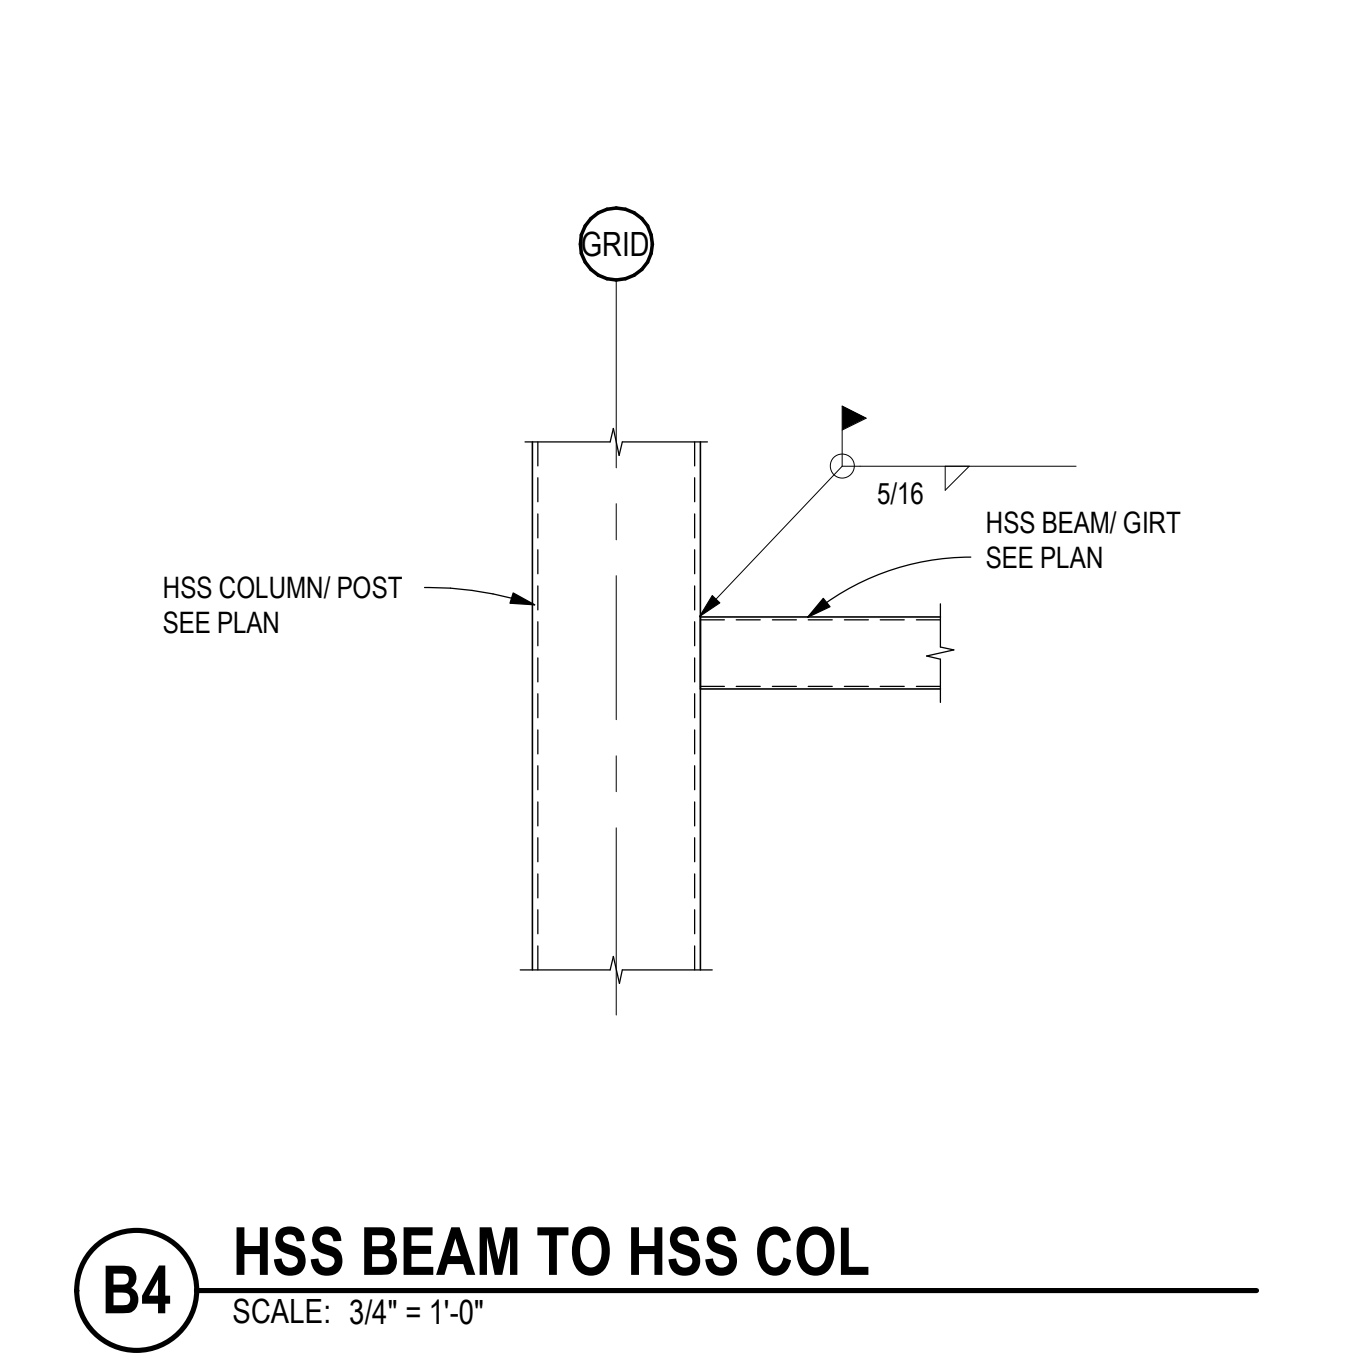


B4 HSS BEAM TO HSS COL
SCALE: 3/4" = 1'-0"

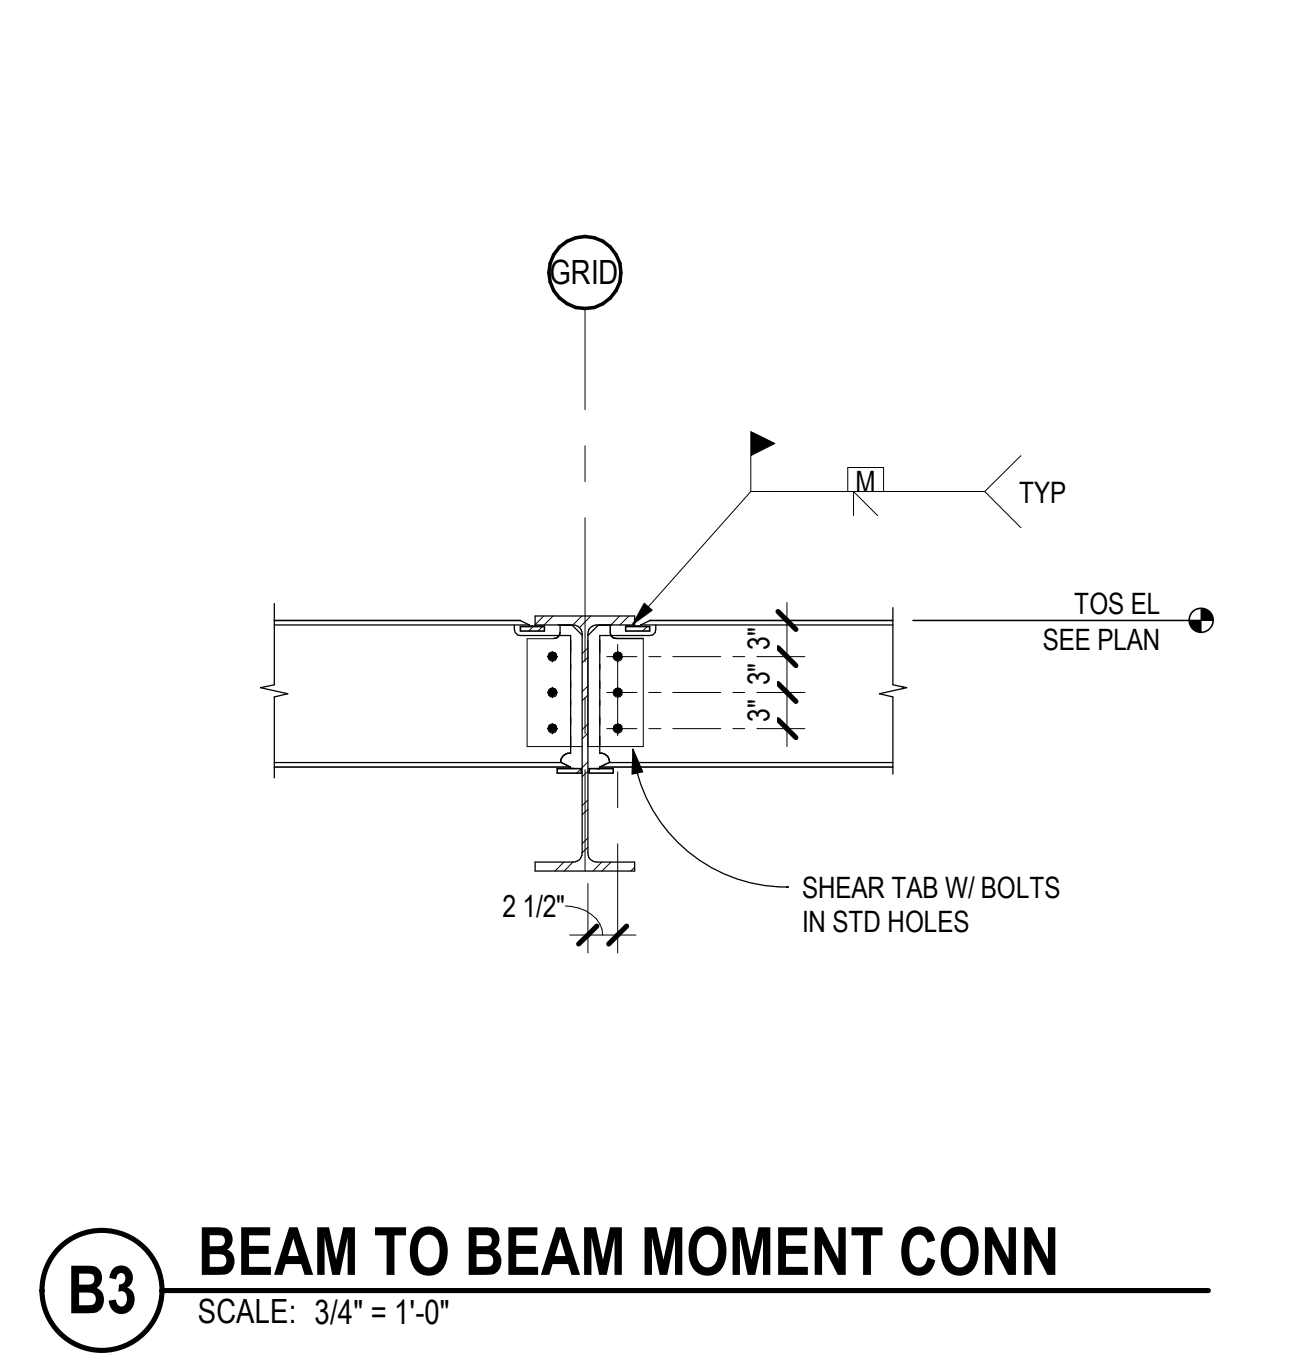

B3 BEAM TO BEAM MOMENT CONN
SCALE: 3/4" = 1'-0"

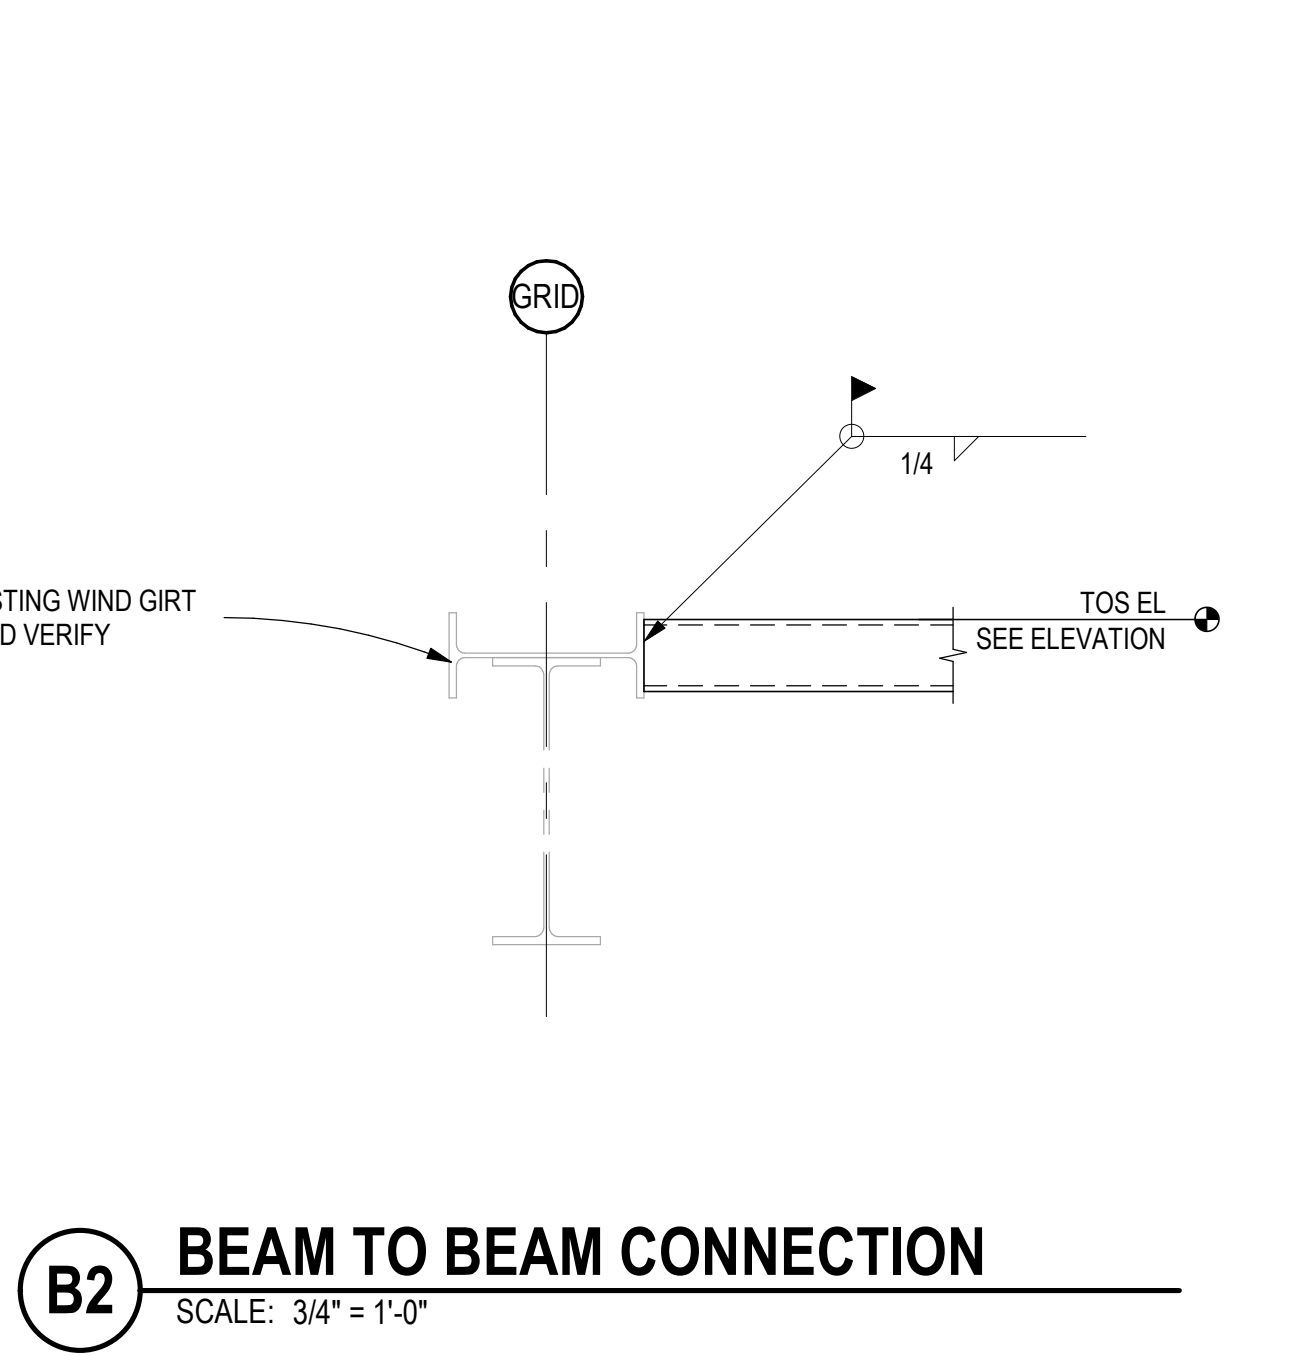


B2 BEAM TO BEAM CONNECTION
SCALE: 3/4" = 1'-0"

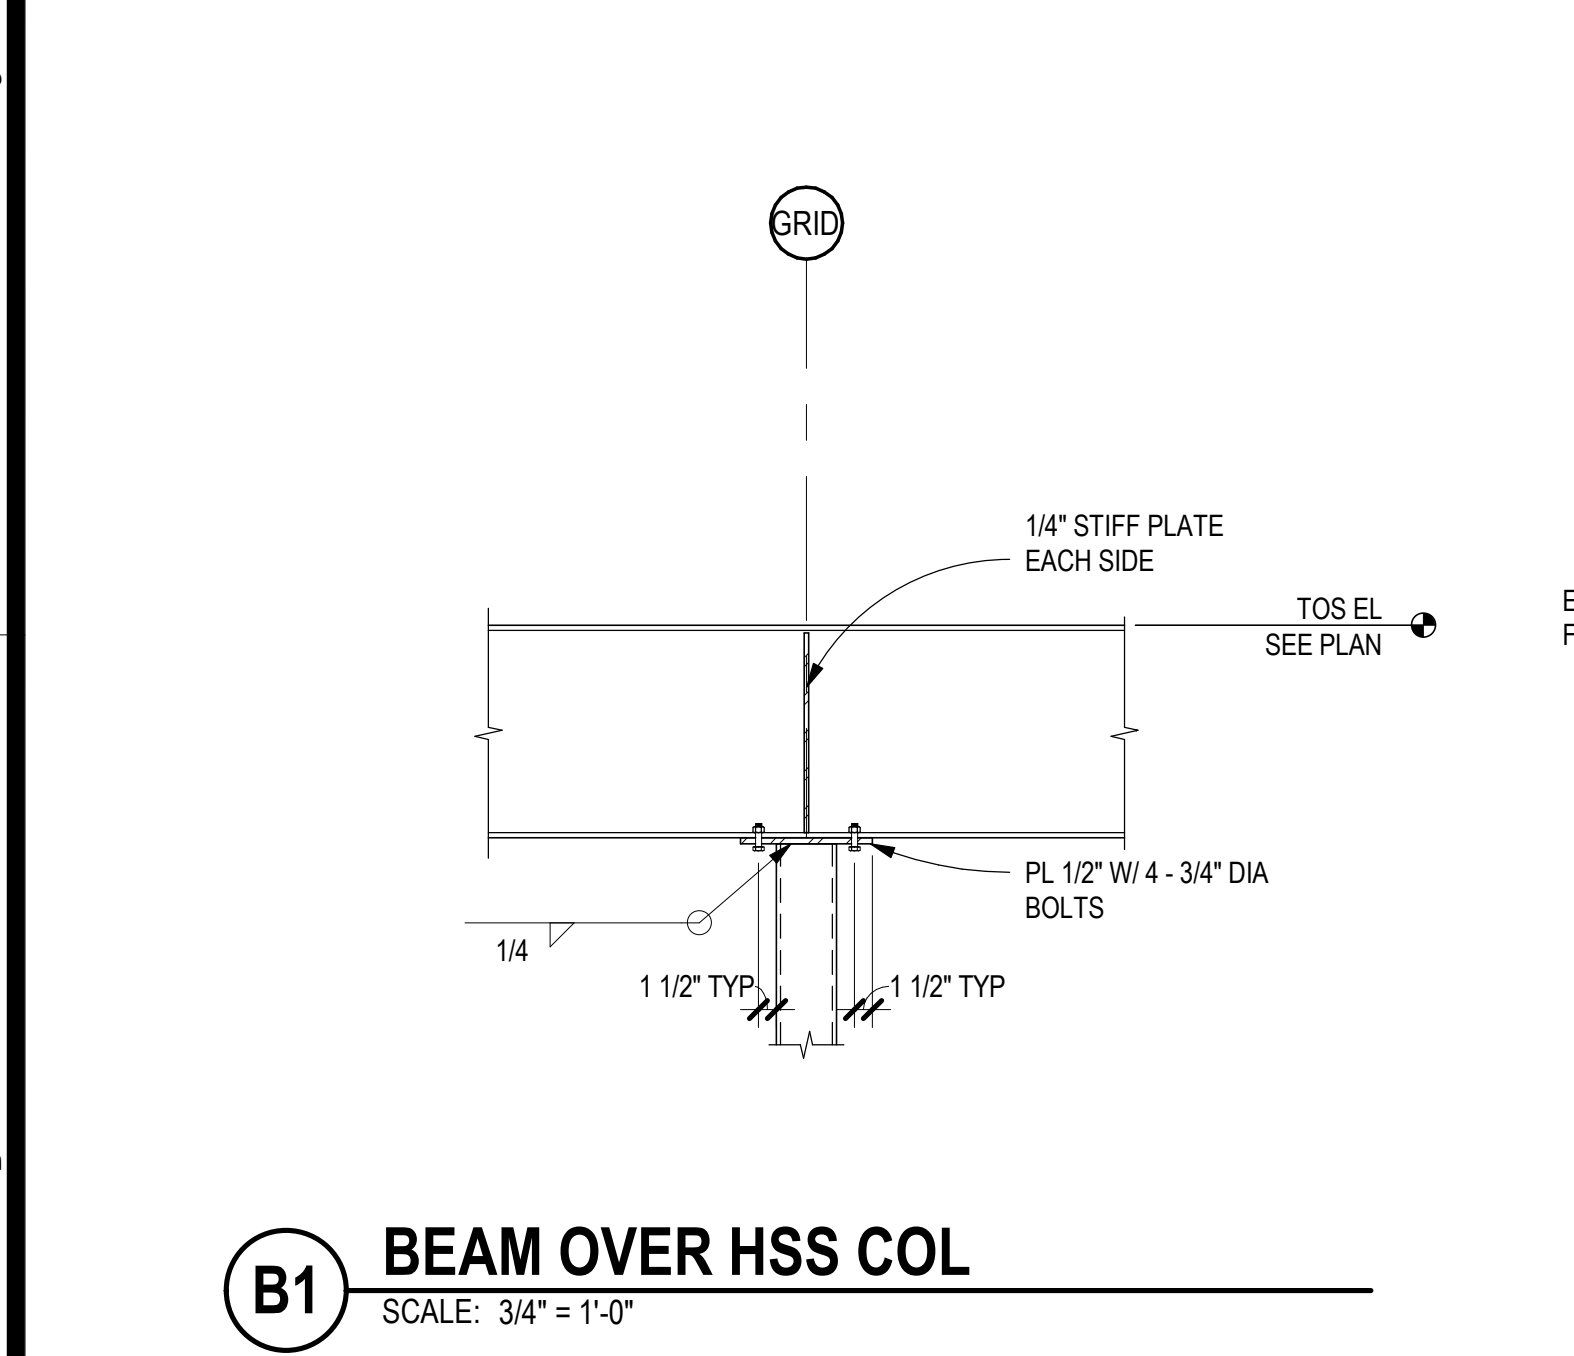


B1 BEAM OVER HSS COL
SCALE: 3/4" = 1'-0"


- A5 TYPICAL STEEL CONN NOTES**
SCALE: 3/4" = 1'-0"
- PROVIDE 1/4" CAP PLATE AT THE TOP OF ALL HOLLOW STRUCTURAL STEEL (HSS) COLUMNS UNLESS NOTED OTHERWISE.
 - PROVIDE 1/4" CAP PLATE AT THE TOP OF ALL PIPE COLUMNS UNLESS NOTED OTHERWISE.
 - PROVIDE 1/2" CAP PLATE AT THE TOP OF ALL WIDE FLANGE COLUMNS UNLESS NOTED OTHERWISE.
 - PROVIDE 1/4" END PLATE AT ALL EXPOSED HSS MEMBERS UNLESS NOTED OTHERWISE.
 - ALL CONNECTION CLIP ANGLES SHALL BE L4x4x3/8 UNLESS NOTED OTHERWISE. BOLT ANGLE TO SUPPORTING MEMBER UNLESS NOTED OTHERWISE.
 - ALL CONNECTION SHEAR TABS SHALL BE PL 3/8" UNLESS NOTED OTHERWISE. PROVIDE 5/16" FILLET WELD EACH SIDE OF SHEAR TAB TO SUPPORTING MEMBER.
 - ALL BOLTS SHALL BE 3/4" DIAMETER A325N IN SHORT SLOTS AS FOLLOWS UNLESS NOTED OTHERWISE:
2 @ W8, W10
3 @ W12
4 @ W14, W16
5 @ W18, S21
6 @ W24
7 @ W27

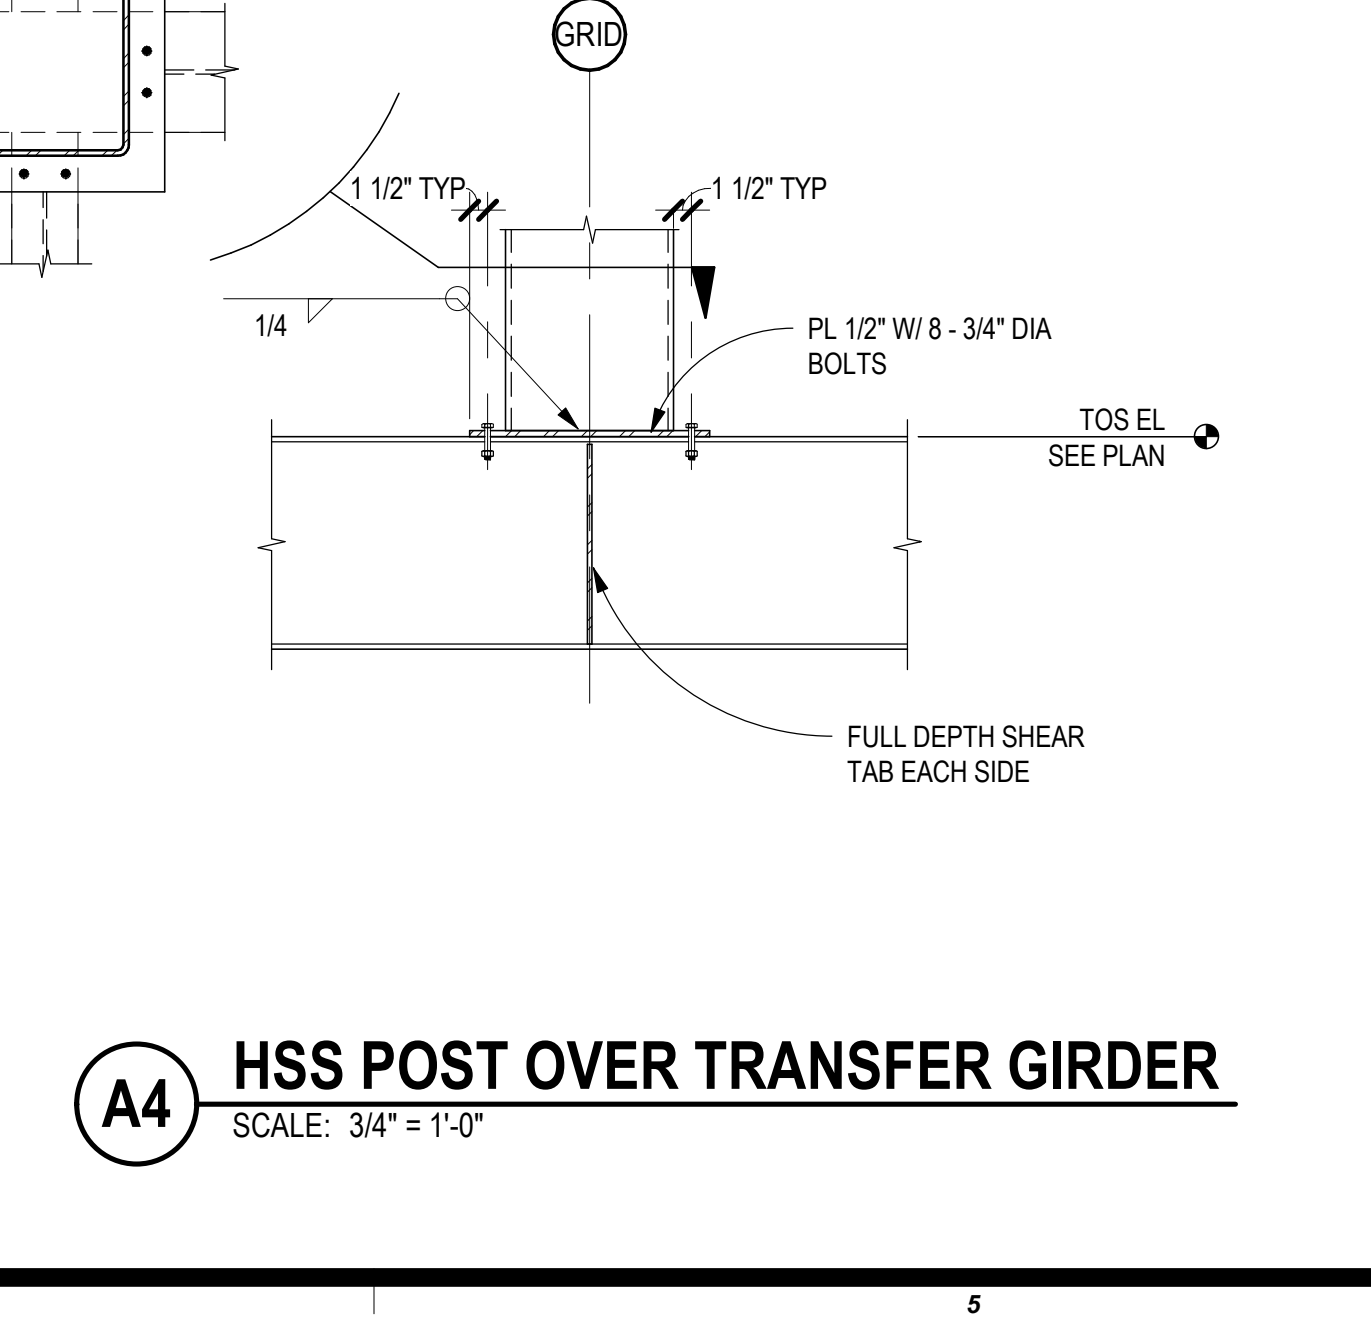


A4 HSS POST OVER TRANSFER GIRDER
SCALE: 3/4" = 1'-0"

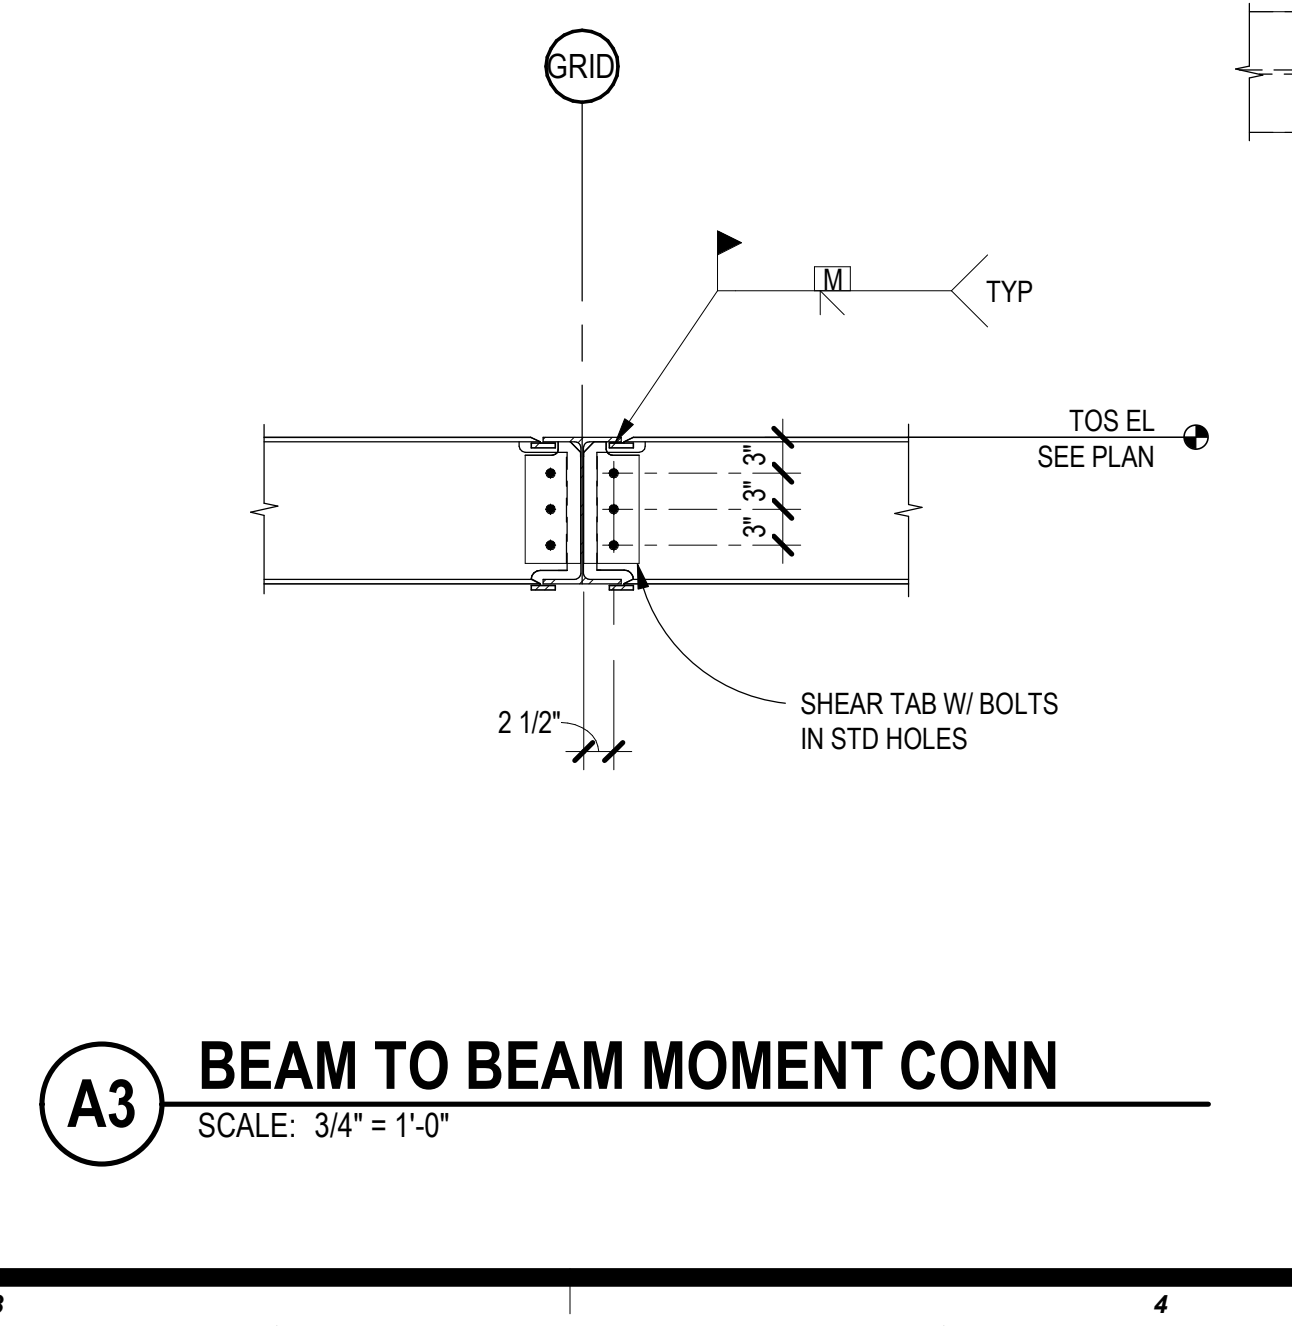

A3 BEAM TO BEAM MOMENT CONN
SCALE: 3/4" = 1'-0"

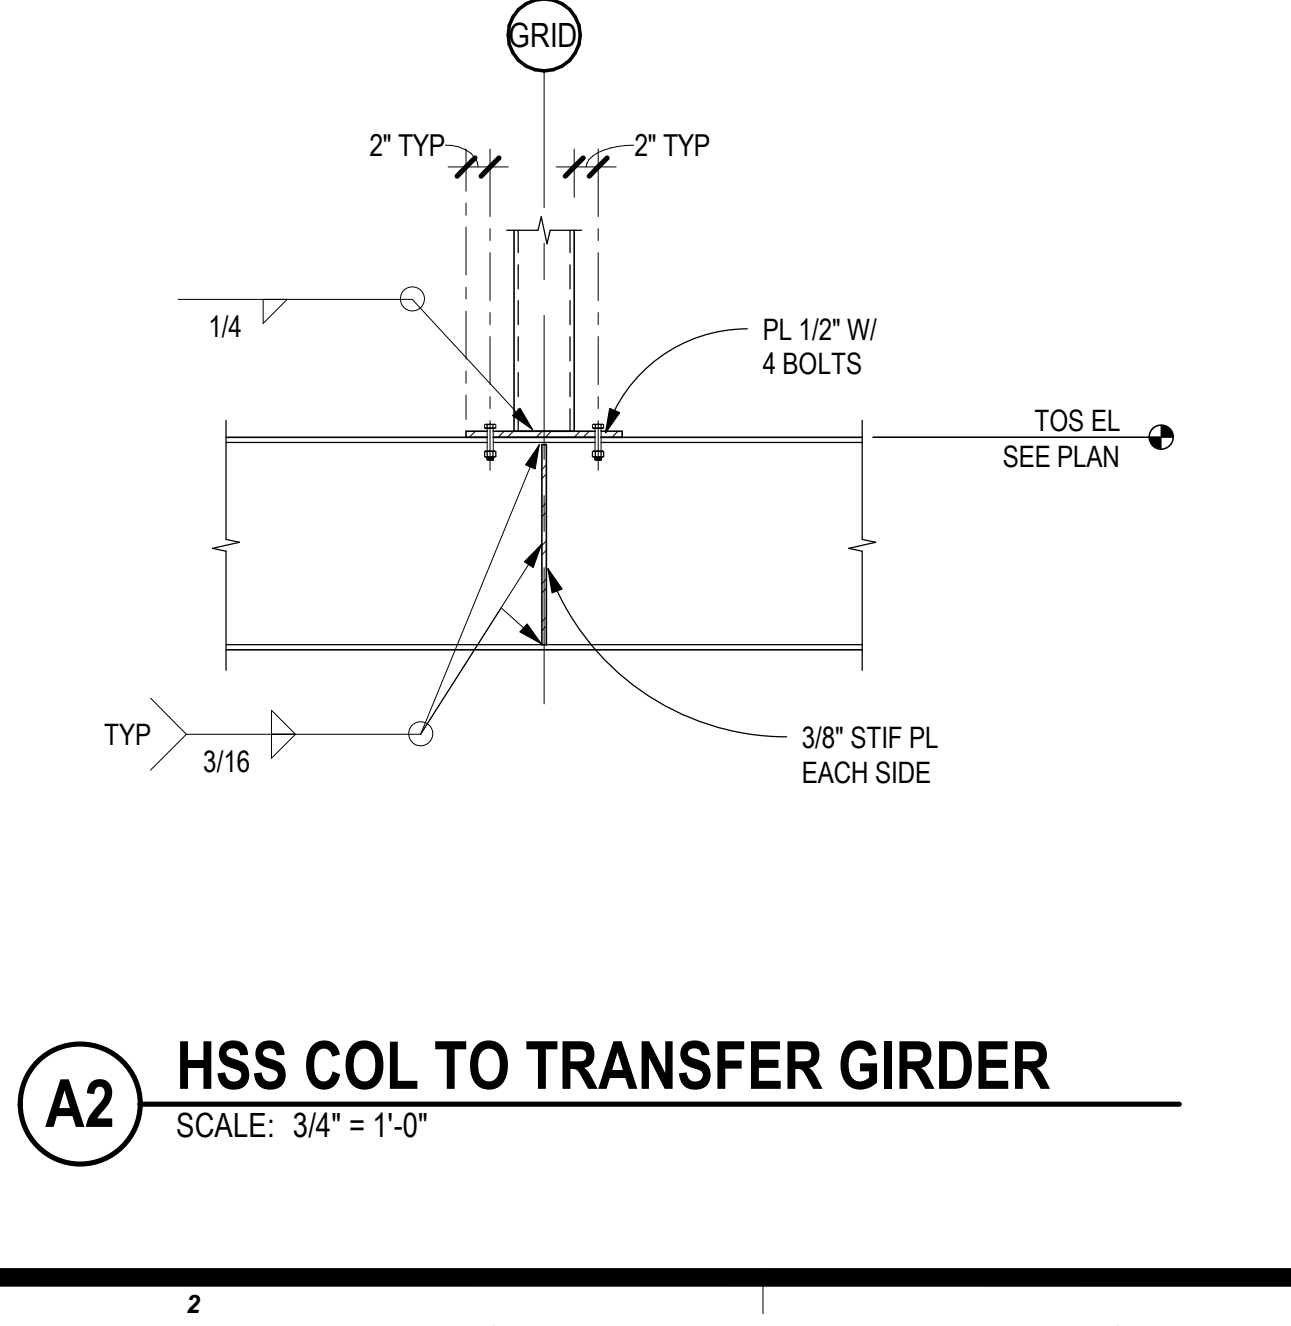


A2 HSS COL TO TRANSFER GIRDER
SCALE: 3/4" = 1'-0"

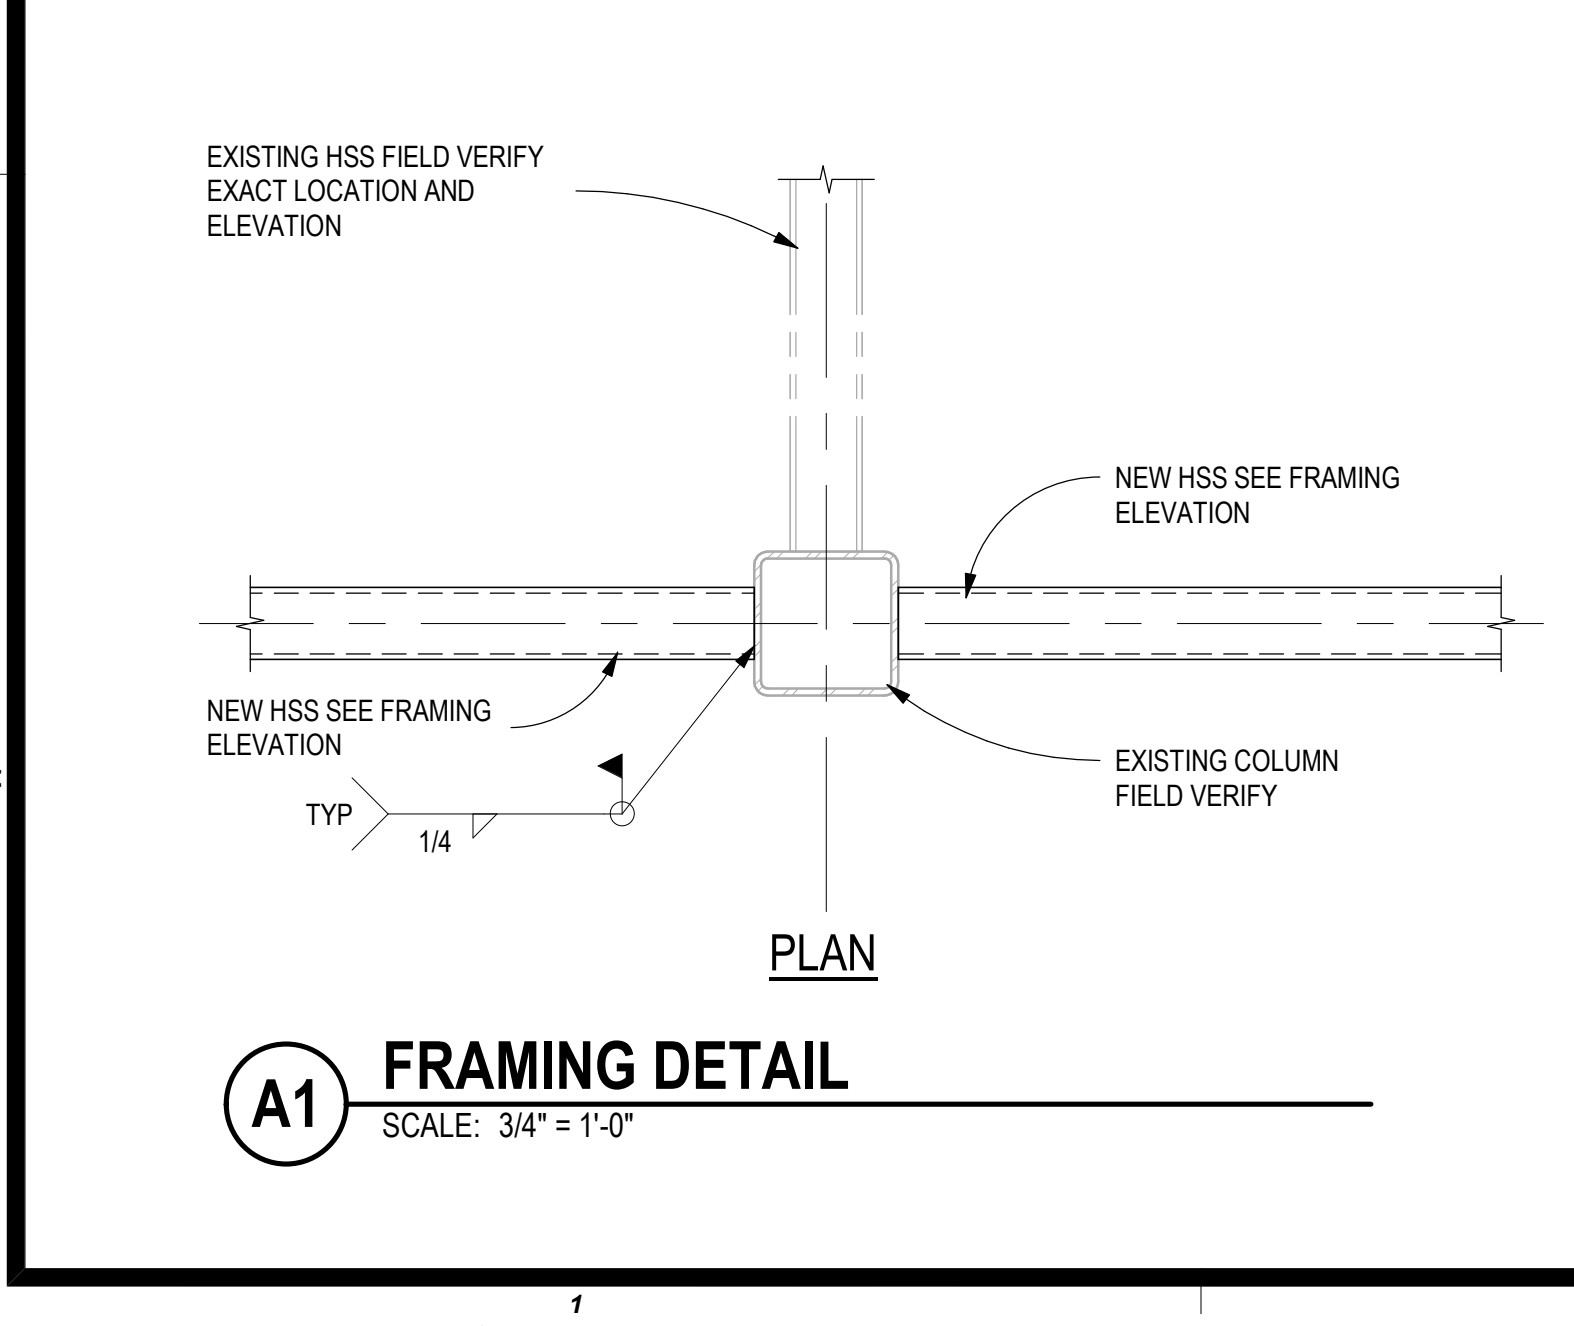


A1 FRAMING DETAIL
SCALE: 3/4" = 1'-0"

NOTE: CONTRACTOR TO CONTACT STRUCTURAL ENGINEER IF ANY EXISTING PIERS ARE DISCOVERED AND IF THEY ARE LOCATED LESS THAN 2 PIER DIAMETERS OF A NEW PIER.

NOTE: PIER EMBEDMENT LENGTHS ARE MINIMUM LENGTHS. ACTUAL LENGTHS REQUIRED TO BE VERIFIED DURING PLACEMENT BY A QUALIFIED REPRESENTATIVE OF THE GEOTECHNICAL ENGINEER TO VERIFY COMPETENT AND/OR UNWEATHERED SHALE EMBEDMENT.

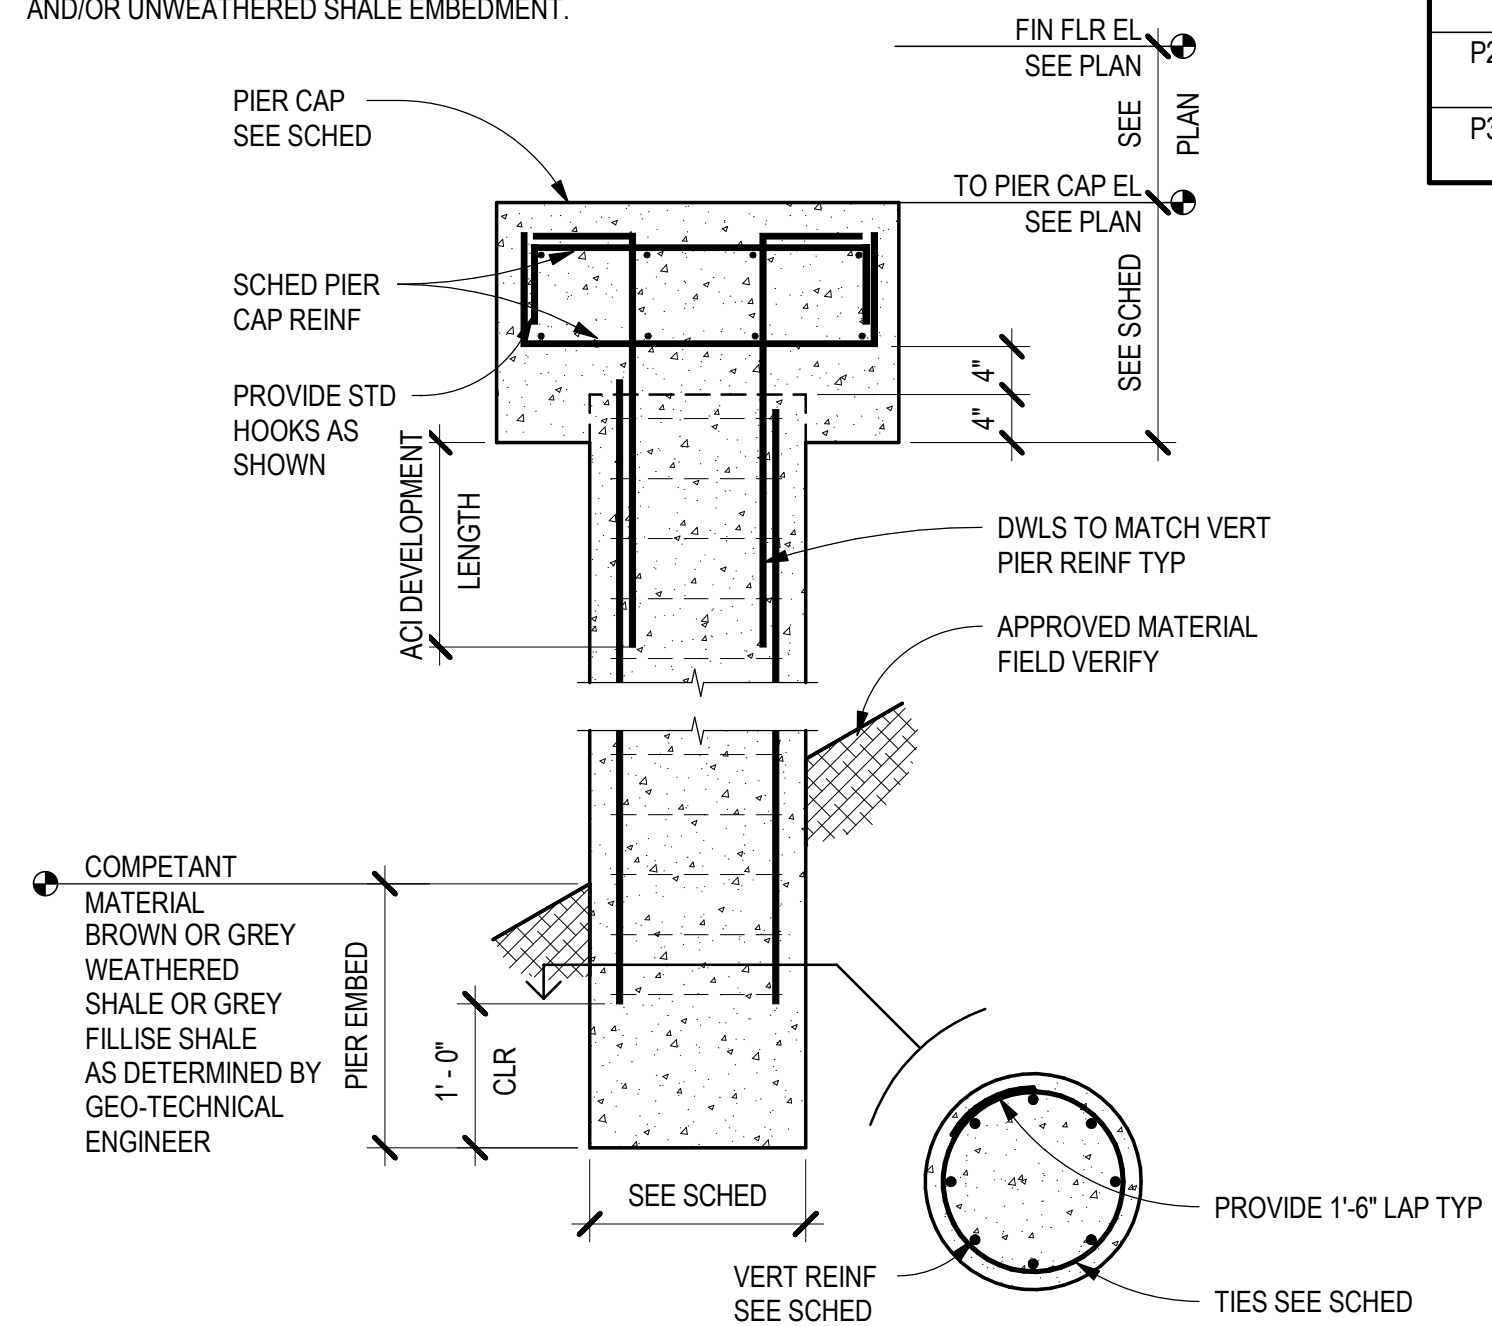


PIER CAP SCHEDULE												
MARK	PIER TYPE	PIER(S) Ø	PIER EMBED	VERTICAL REINF	HORIZ TIES	PIER CAP TYPE	SCHED 'A'	SCHED 'B'	DEPTH	CG PCAP REINF TOP EA WAY	CG PCAP REINF BOT EA WAY	REMARKS
P1	TYPE A	1-30" DIA	3'-0"	12-#7	#4 @ 12" OC	TYPE 1	5'-0"	5'-0"	2'-6"	#8 @ 12" OC EA WAY	#8 @ 12" OC EA WAY	
P2	TYPE A	1-48" DIA	3'-0"	24-#8	#4 @ 12" OC	TYPE 1	4'-6"	7'-6"	2'-6"	#8 @ 12" OC EA WAY	#8 @ 12" OC EA WAY	
P3	TYPE A	1-48" DIA	5'-0"	24-#8	#4 @ 12" OC	TYPE 1	5'-0"	6'-0"	2'-6"	#8 @ 12" OC EA WAY	#8 @ 12" OC EA WAY	

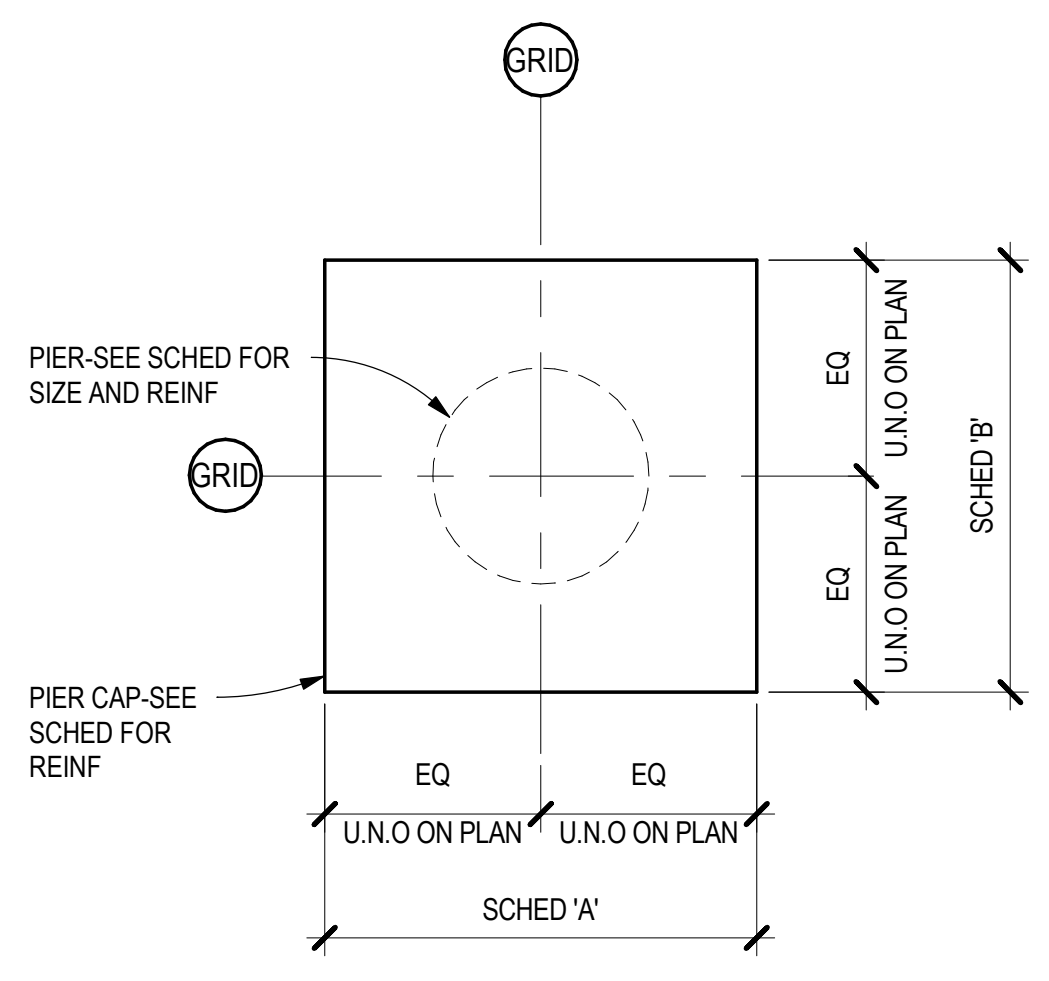

D1 PIER TYPE DETAILS AND SCHEDULE
SCALE: NTS

D2 TYPICAL PIER CAP TYPE DETAIL
SCALE: NTS

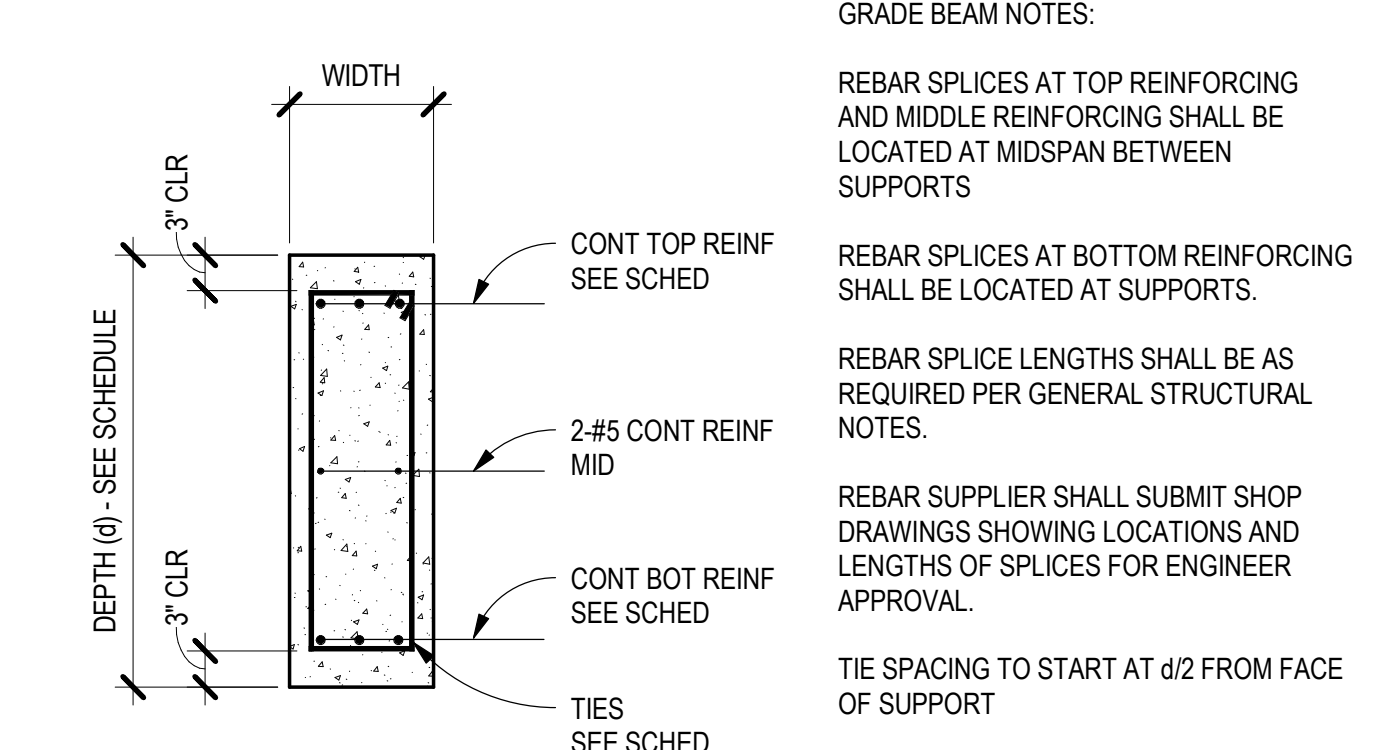

C1 GRADE BEAM DETAIL
SCALE: 3/4" = 1'-0"

MARK	COMPOSITE SLAB	SLAB			REINFORCING		METAL DECK				DECK ATTACHMENTS			TOTAL SLAB / DECK THICKNESS	COMMENTS
		THICK	MATL	STRENGTH	REINF	REINF GRADE	THICK	TYPE	GAGE	FINISH	ATTACH PERP TO RIBS	ATTACH PARALLEL TO RIBS	ATTACH SIDELAPS		
D1.5R	---	---	---	---	---	---	1 1/2"	B	18	GALV	7-5/8" DIA PUDDLE WELDS PER 36" WIDE SHEET	5/8" DIA PUDDLE WELDS @ 6" OC	#10 SCREWS @ 6" OC	1 1/2"	

MARK	SLAB			REINFORCING		BEARING STRATA	COMMENTS
	THICKNESS	MATL	CONC STRENGTH	REINFORCING	GRADE		
S5	5"	CONC		#4 @ 18" OC EA WAY		4" GRANULAR BASE COURSE OVER COMPACTED STRUCTURAL FILL	

MARK	VENEER	WALL	REINFORCING		GRADE	COMMENTS
			VERTICAL	HORIZONTAL		
W1	---	8" CONC	#4 @ 18" OC	#4 @ 12" OC	A615, GR 60	
W2	---	8" CONC	#4 @ 12" OC	#5 @ 12" OC	A615, GR 60	

MARK	SIZE		REINFORCING			GRADE	COMMENTS
	WIDTH	DEPTH	CONT TOP	CONT BOTTOM	TRANSVERSE		
GB1	1'-4"	2'-0"	4-#6	4-#6	#3 @ 10" OC		

REINFORCEMENT TYPE	REINFORCING LAP SCHEDULE				MINIMUM LENGTH (IN)	COMMENTS
	#6 AND SMALLER (#db)	#7 AND LARGER (#db)	#7 AND LARGER (#db)	#7 AND LARGER (#db)		
CONTINUOUS WALL FOOTINGS AND STEM WALLS	30	30	30	30	30	18
RETAINING WALLS AND BASEMENT WALL VERTICAL REINFORCING	57	50	45	72	62	12
RETAINING WALLS AND BASEMENT WALL HORIZONTAL REINFORCING	57	50	45	72	62	12
CONCRETE COLUMNS NOT SUPPORTING LATERAL FORCES	30	30	30	30	30	12
CONCRETE COLUMNS SUPPORTING LATERAL FORCES	57	50	45	72	62	12
TOP FLEXURAL REINFORCEMENT, INCLUDING BEAMS, GRADE BEAMS, AND COMBINED COLUMN FOOTING AT BRACED FRAME AND MOMENT FRAMES	57	50	45	72	62	12
BOTTOM FLEXURAL REINFORCEMENT, INCLUDING BEAMS, GRADE BEAMS, AND COMBINED COLUMN FOOTING AT BRACED FRAME AND MOMENT FRAMES	57	50	45	55	62	12
SLABS-ON-GRADE	30	30	30	30	30	12
MINIMUM EMBEDMENT OF STANDARD HOOKS INTO CONCRETE BASE	16	14	12	16	14	6
ALL REBAR LAPS IN CMU				72	72	12



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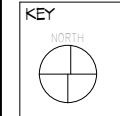
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EXTERIOR FACADE RENOVATION



No.	Description	Date

PROGRESS SET

H11018.01
 J. ANDERSON
 C. ROMERO
 01/16/2019
 Scale: As Indicated
 S-601

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120 Hayslope Avenue
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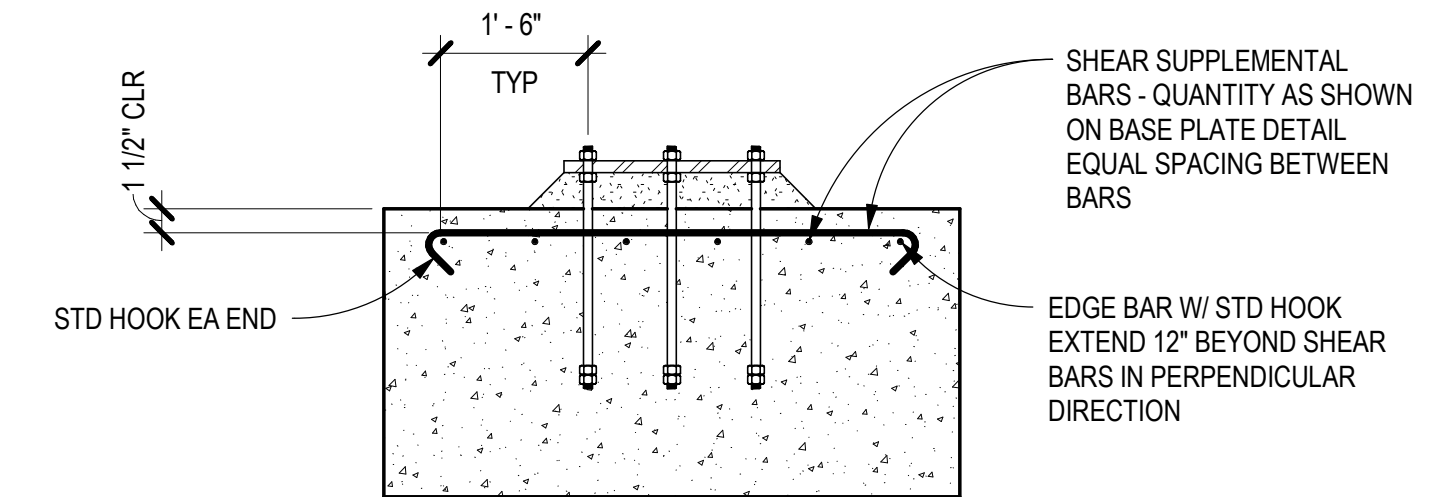
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505-344-4000

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918-234-7549


LOW VOLTAGE / THEME LIGHTING
M/E Engineers
60 Lakewood Boulevard
Suite 330
Buffalo, NY 14202

Cherokee Hard Rock Hotel & Casino



NOTE: ONLY SUPPLEMENTAL BARS ARE SHOWN FOR CLARITY

D5 SUPPLEMENTAL SHEAR BAR DETAIL
SCALE: 3/4" = 1'-0"


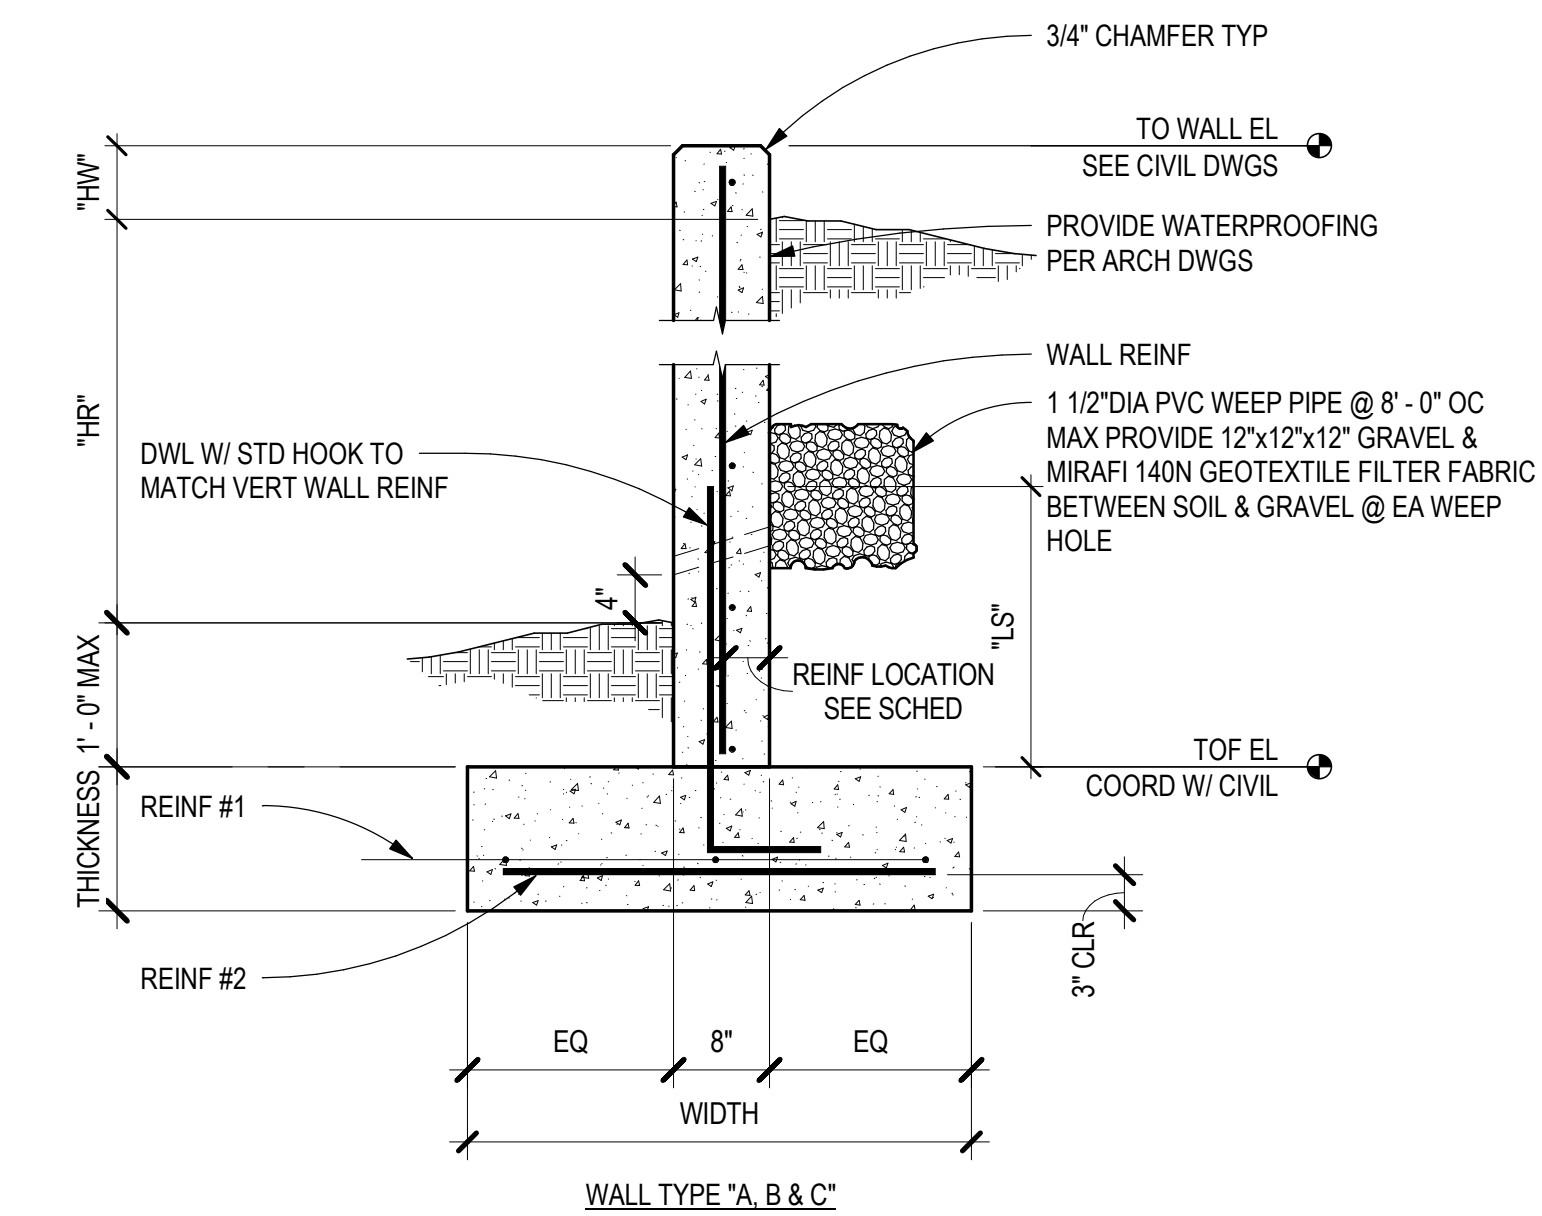


CONCRETE SITE RETAINING WALL SCHEDULE										
WALL TYPE	WALL HEIGHT ABOVE GRADE "HW"	HEIGHT RETAINED "HR"	FOOTING SIZE		FOOTING REINFORCING		WALL REINFORCING		REINF LOCATION	SPLICE LENGTH "LS"
			WIDTH	THICKNESS	NUMBER - SIZE	SIZE - SPACING	VERT SIZE - SPACING	HORIZ SIZE - SPACING		
A	0'-0"-0'-6"	0'-0"-4'-0"	2'-6"	1'-0"	3 - #5 CONT	#4 @ 48" OC	#4 @ 18" OC	#4 @ 12" OC	4"	24"
B	0'-0"-3'-6"	0'-0"-5'-0"	3'-6"	1'-0"	3 - #5 CONT	#4 @ 48" OC	#4 @ 14" OC	#4 @ 12" OC	4"	24"
C	0'-0"-0'-6"	4'-1"-7'-0"	5'-0"	1'-0"	5 - #5 CONT T&B	#5 @ 24" OC T&B	#5 @ 10" OC	#4 @ 12" OC	4"	36"

NOTE:
COORDINATE EXACT LOCATION AND EXTENT OF WALL WITH ARCHITECTURAL AND CIVIL DWGS.
PROVIDE CONCRETE WALL VERTICAL CONTROL JOINTS AT (2) TIMES THE WALL HEIGHT AND AT ALL STEPS IN TOP OF WALL. SEE DETAIL C2/S7.11 FOR CONTROL JOINT INFORMATION.

C3 TYPICAL CONCRETE SITE RETAINING WALL SCHEDULE AND DETAIL
SCALE: NTS

BASE PLATE SCHEDULE				
MARK	TYPE	SIZE	F1554 ANCHOR BOLTS	TYPE
BP1	A	PL 3/4"x13"x1'-1"	4 - 3/4" DIA x 9"	1
BP2	A	PL 3/4"x14"x1'-2"	4 - 3/4" DIA x 9"	1
BP3	A	PL 3/4"x22"x1'-10"	4 - 3/4" DIA x 9"	1

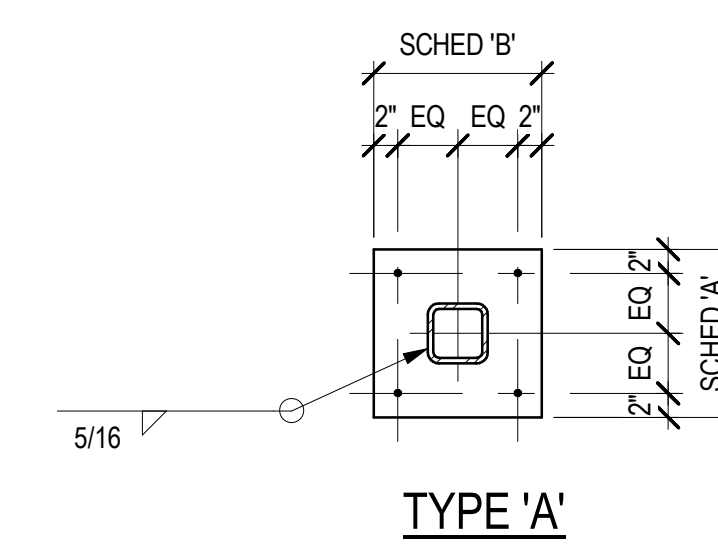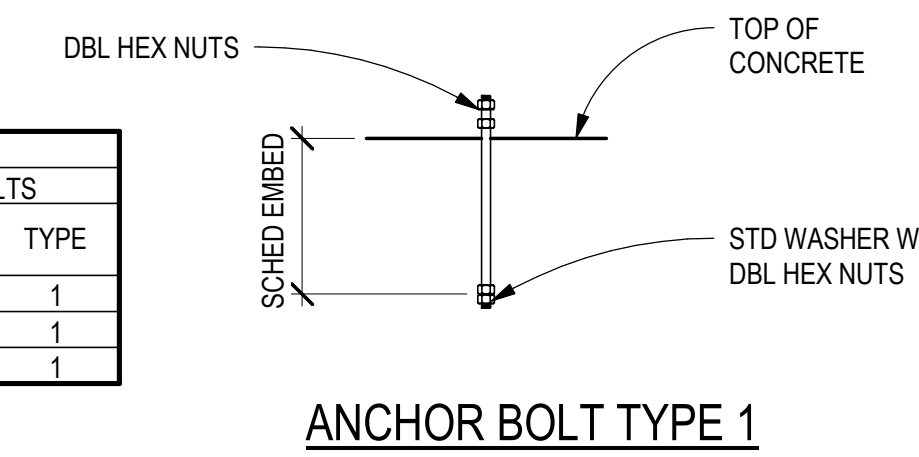

A4 BASE PLATE TYPES - SCHEDULE AND DETAILS
SCALE: NTS

EXTERIOR FACADE RENOVATION





No.	Description	Date

SCHEDULES
PROGRESS SET


PROJECT: H11018.01
DRAWN: J. ANDERSON
CHECKED: C. ROMERO
DATE: 01/16/2019
23578
OKLAHOMA PROFESSIONAL ENGINEER
MORIS B. ROMERO

S-602
Scale: As Indicated

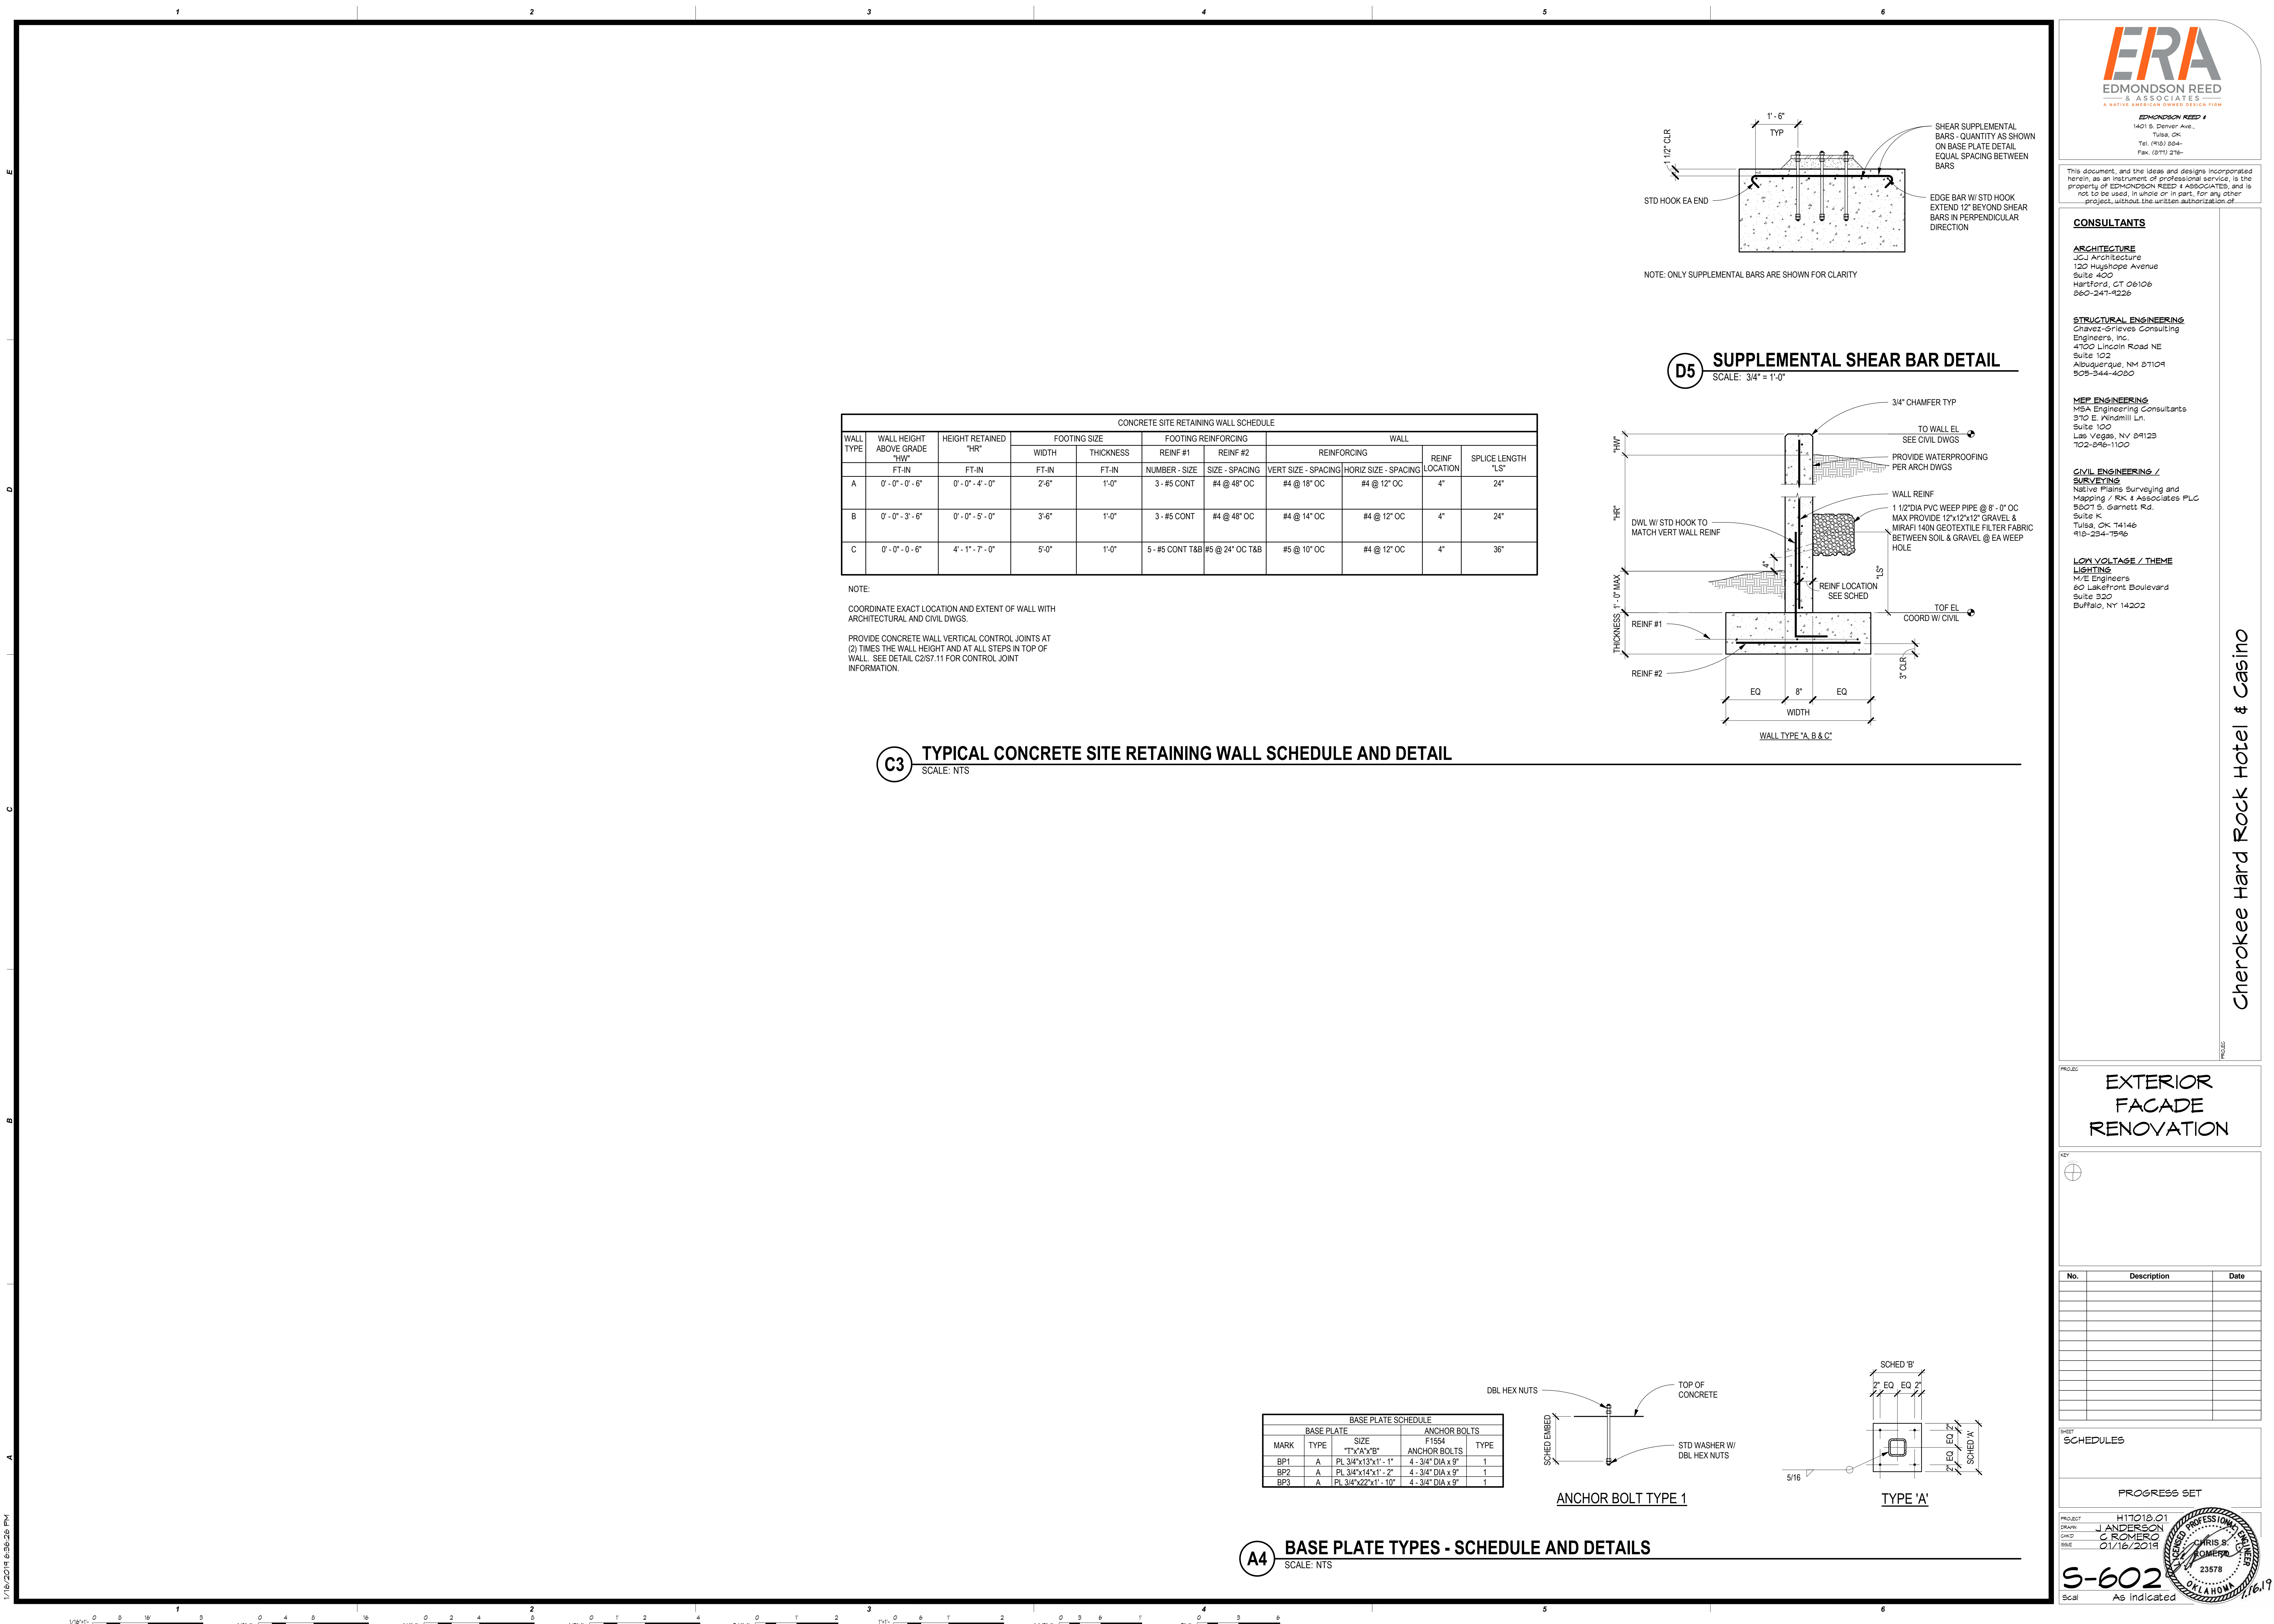


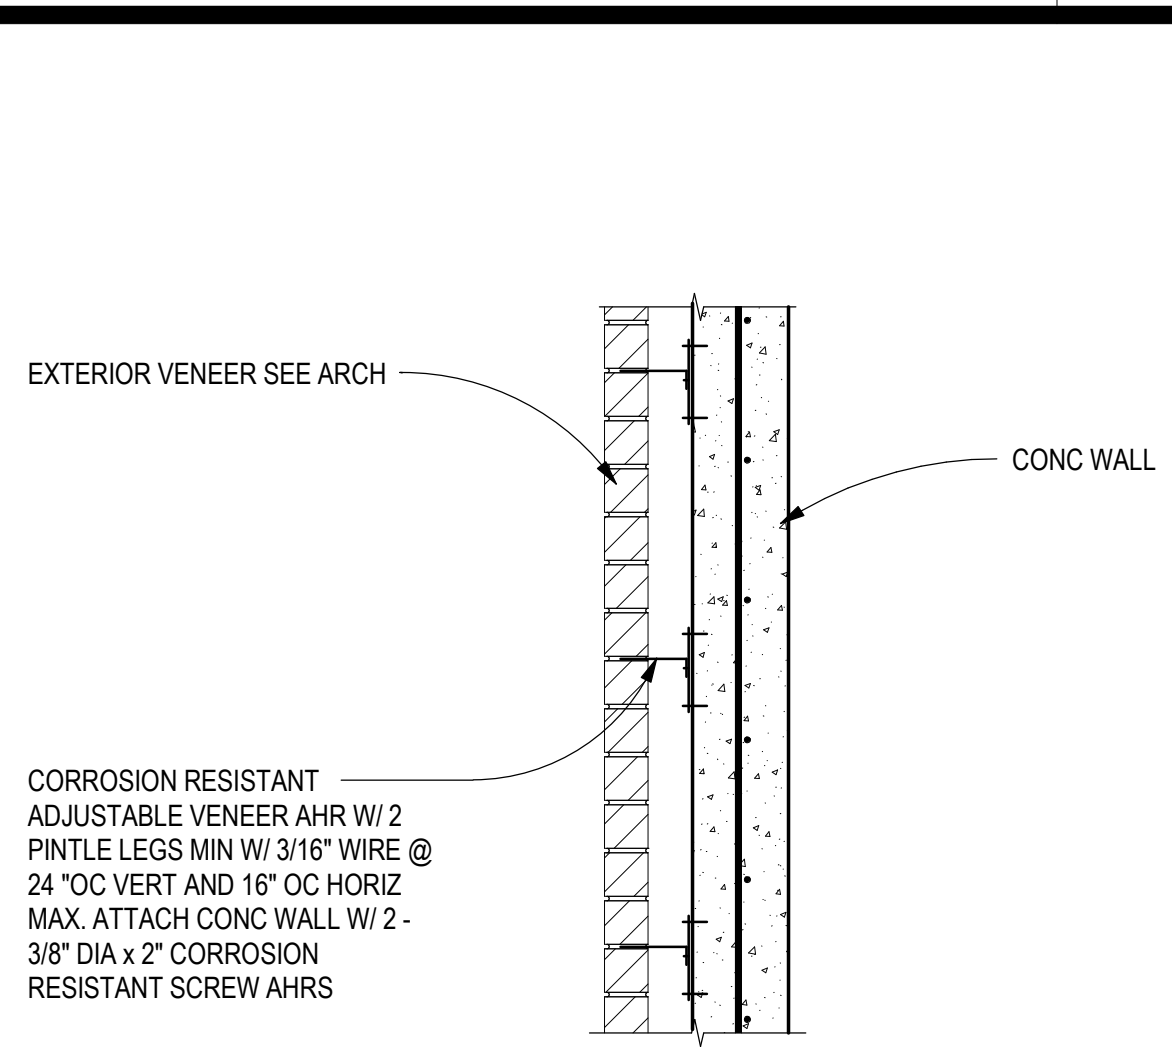


D1 TYPICAL VENEER TO CONC WALL
SCALE: NTS

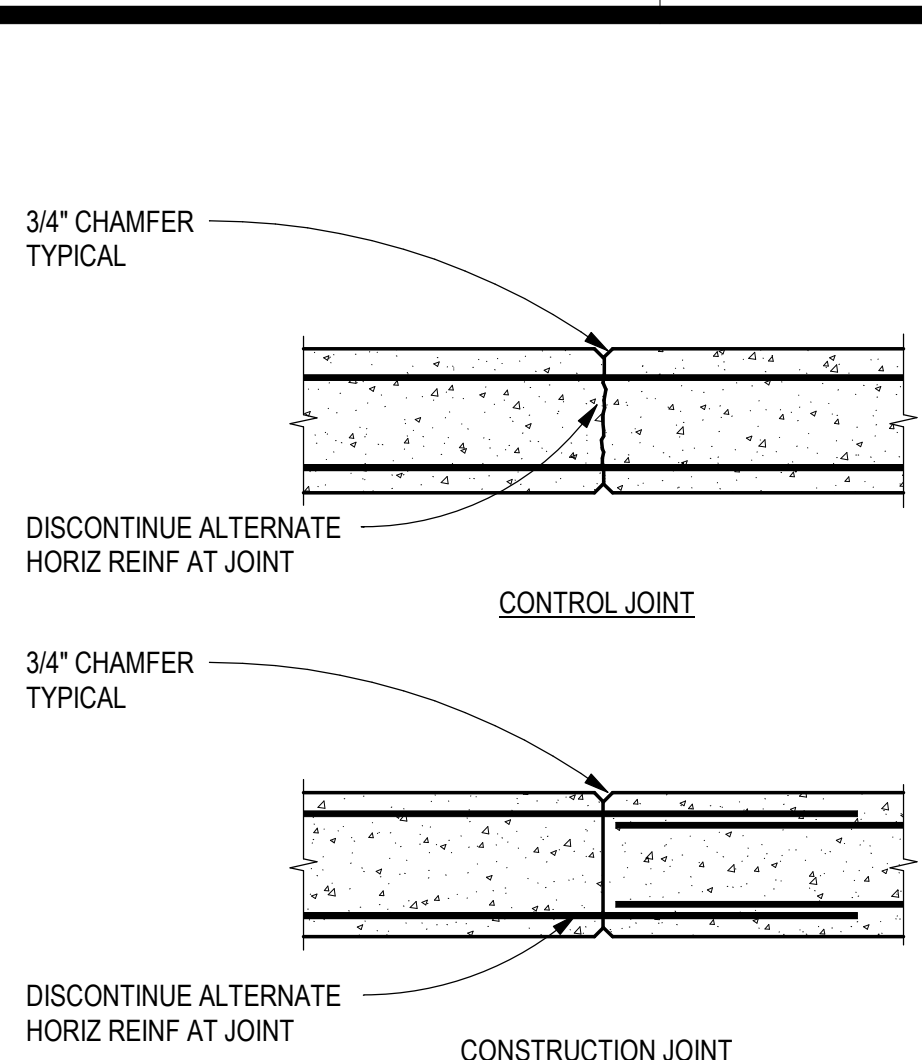


D2 TYPICAL WALL JOINT DETAIL
SCALE: NTS

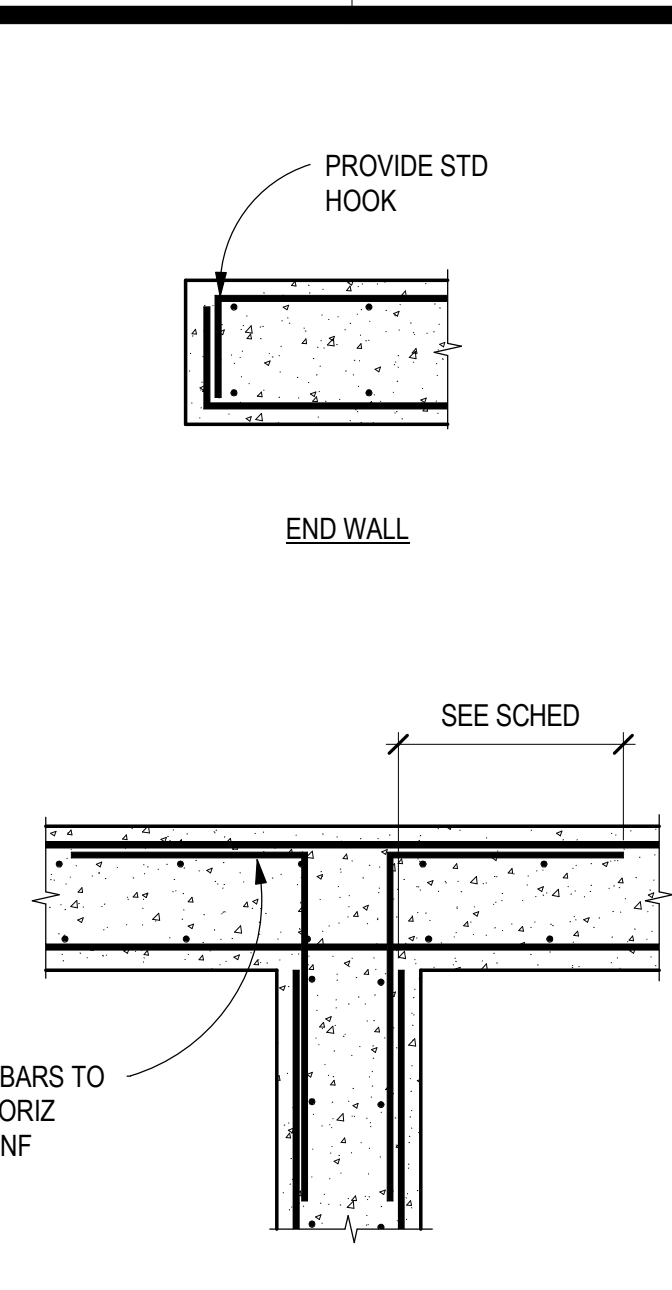


D4 TYPICAL OPNG IN CONC WALL DETAIL
SCALE: NTS

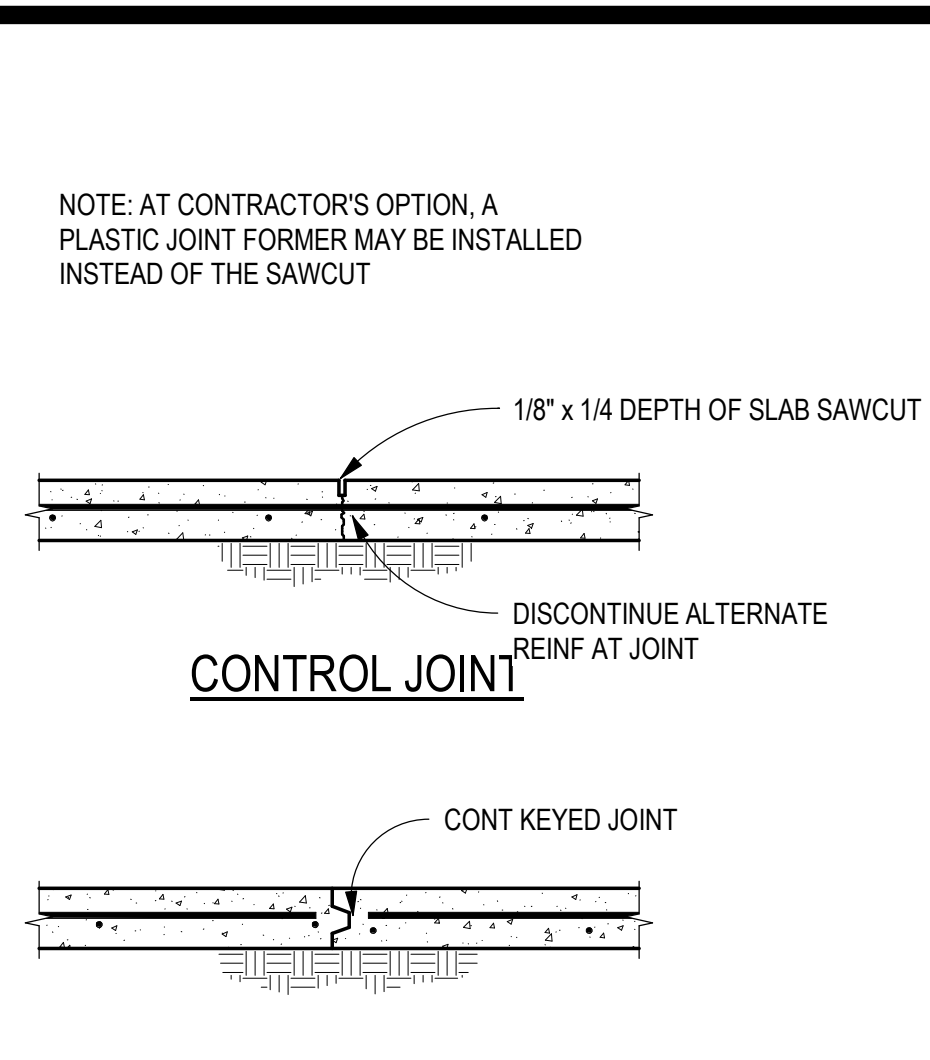


D5 TYPICAL SLAB JOINT
SCALE: NTS

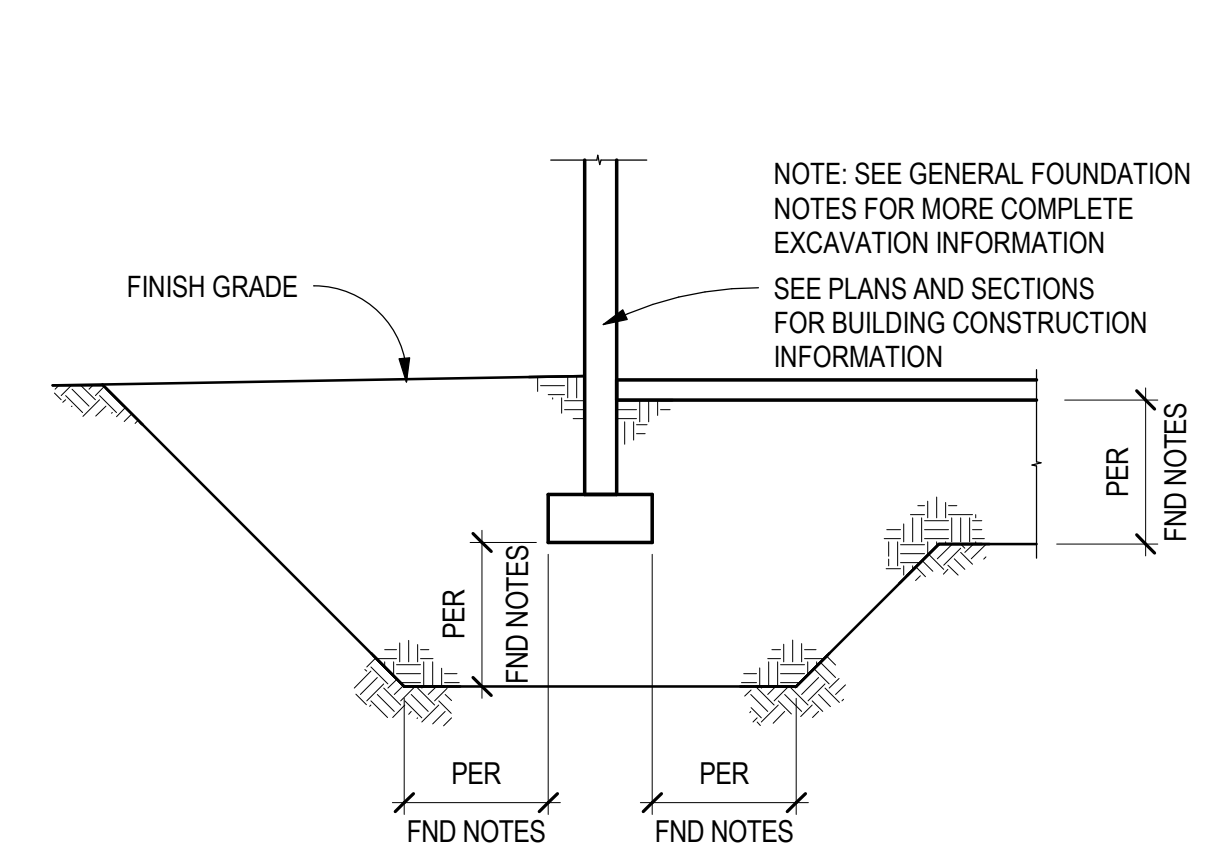


C1 TYPICAL FND EXCAVATION DETAIL
SCALE: NTS

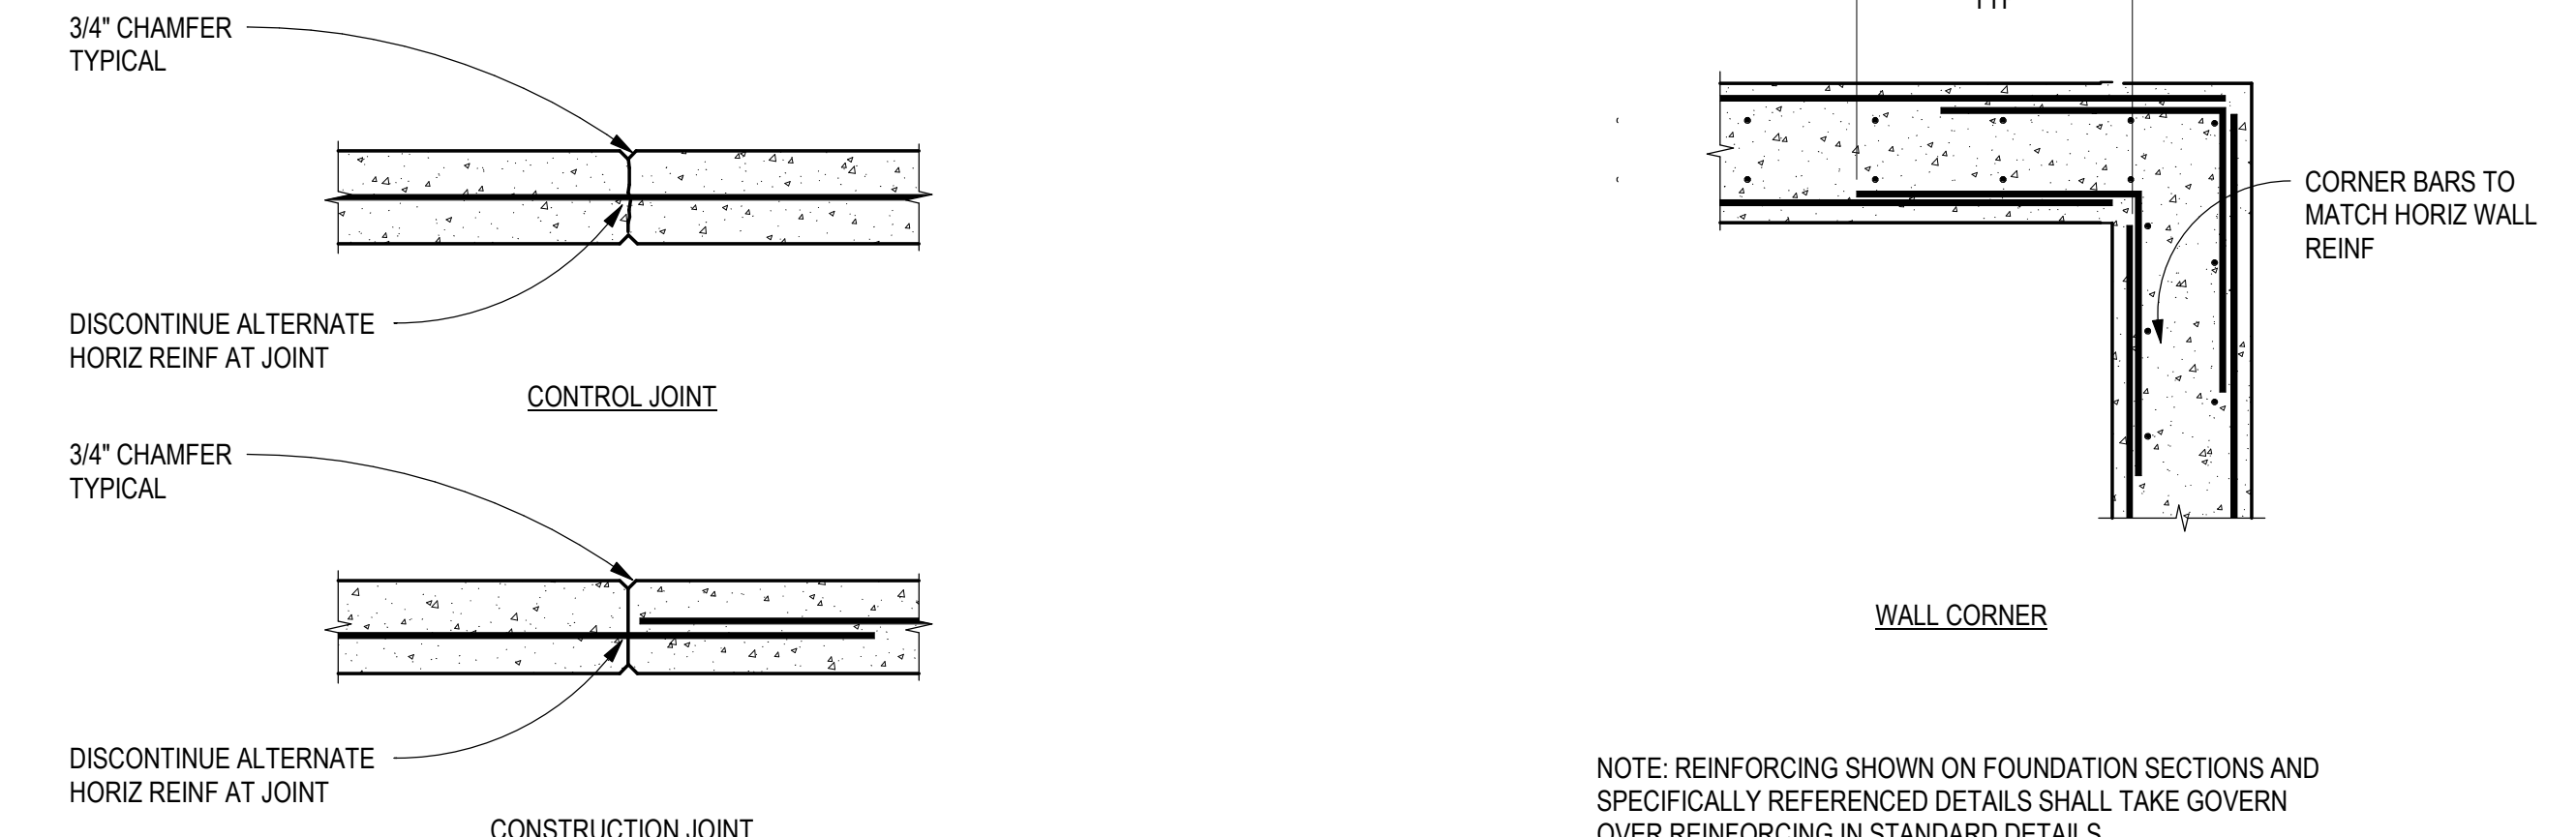


C2 TYPICAL WALL JOINT DETAIL
SCALE: NTS

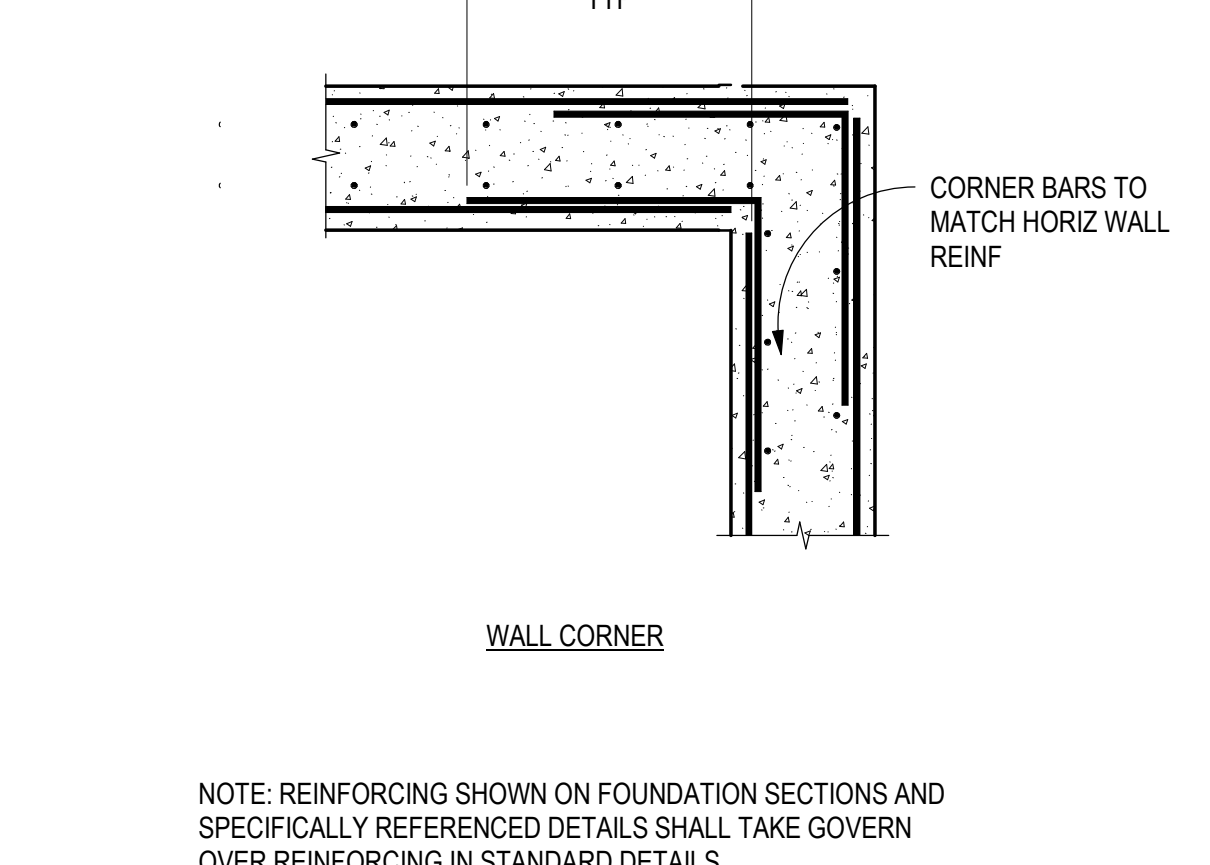


C3 TYPICAL DOUBLE MAT WALL REINF
SCALE: NTS

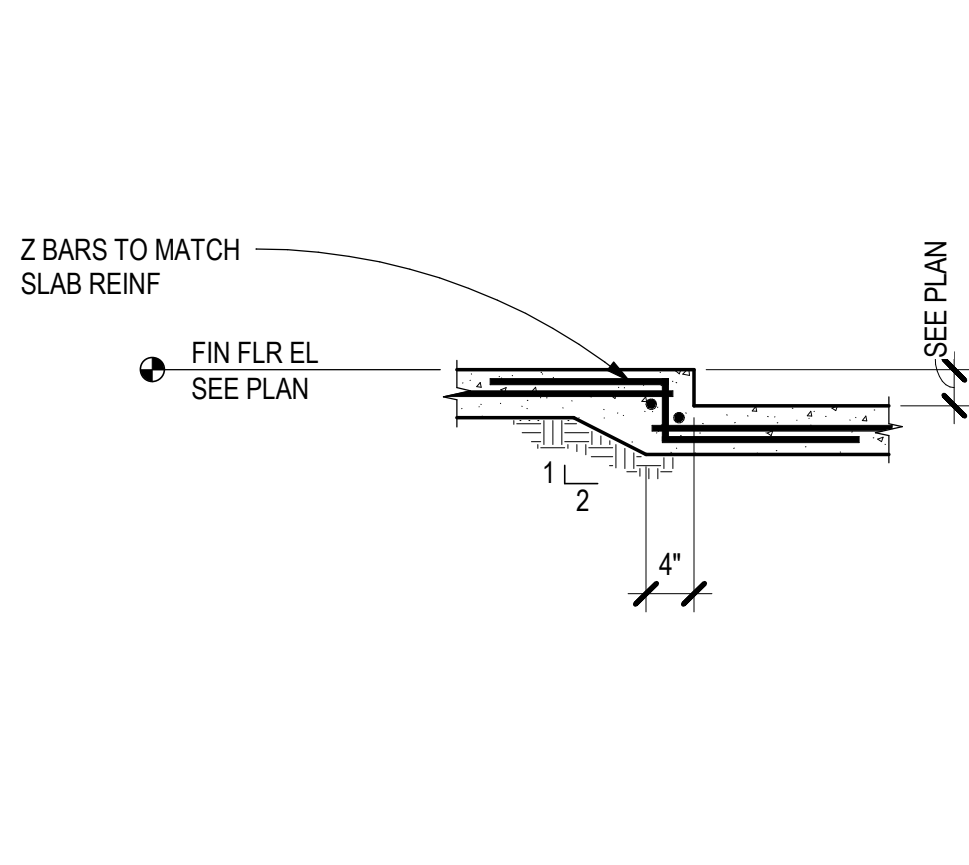


C4 TYPICAL DEPRESSED SLAB
SCALE: 3/4" = 1'-0"

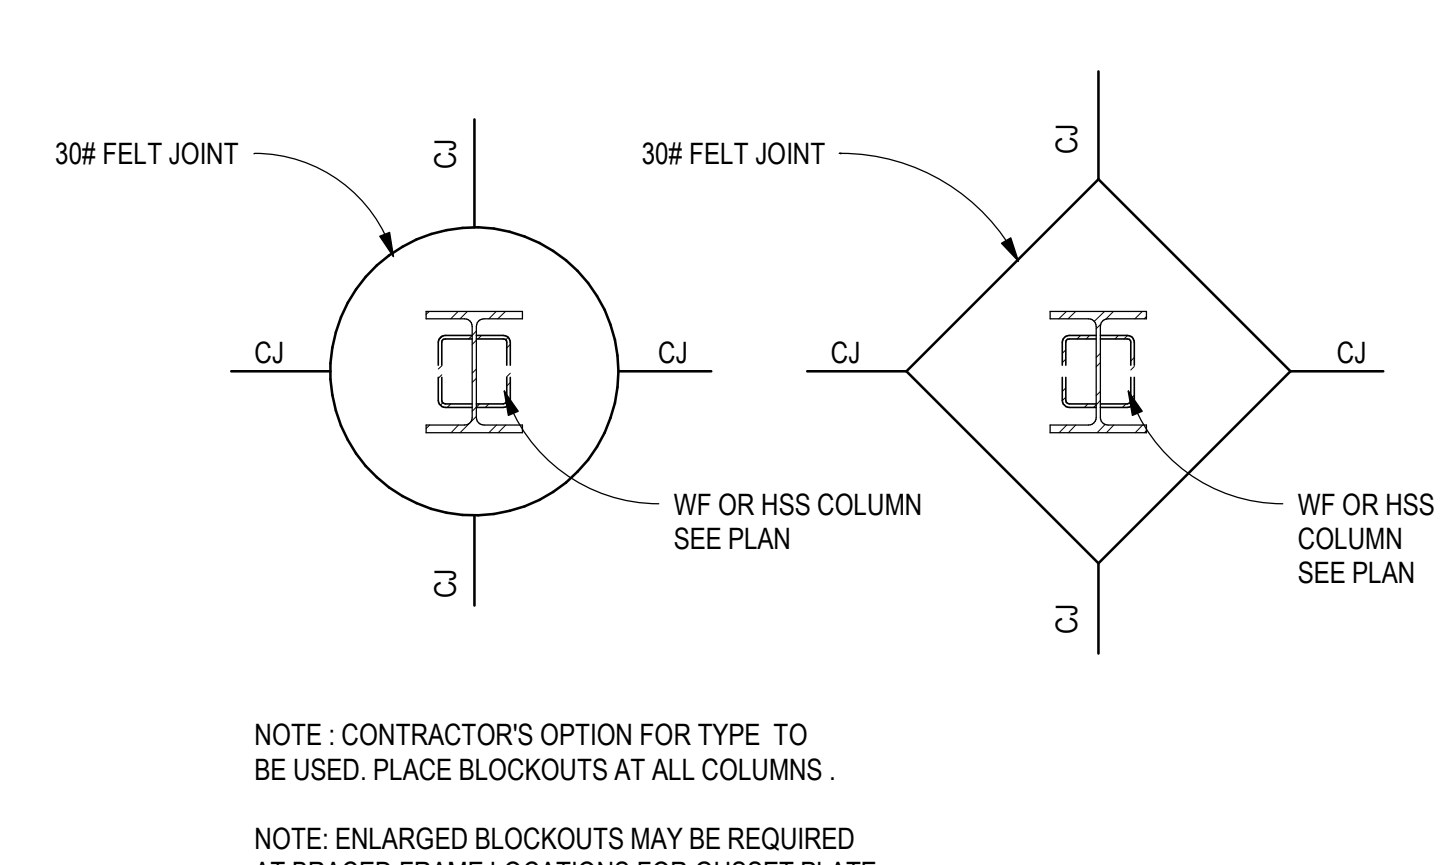


C5 TYPICAL COLUMN BLOCKOUT
SCALE: NTS

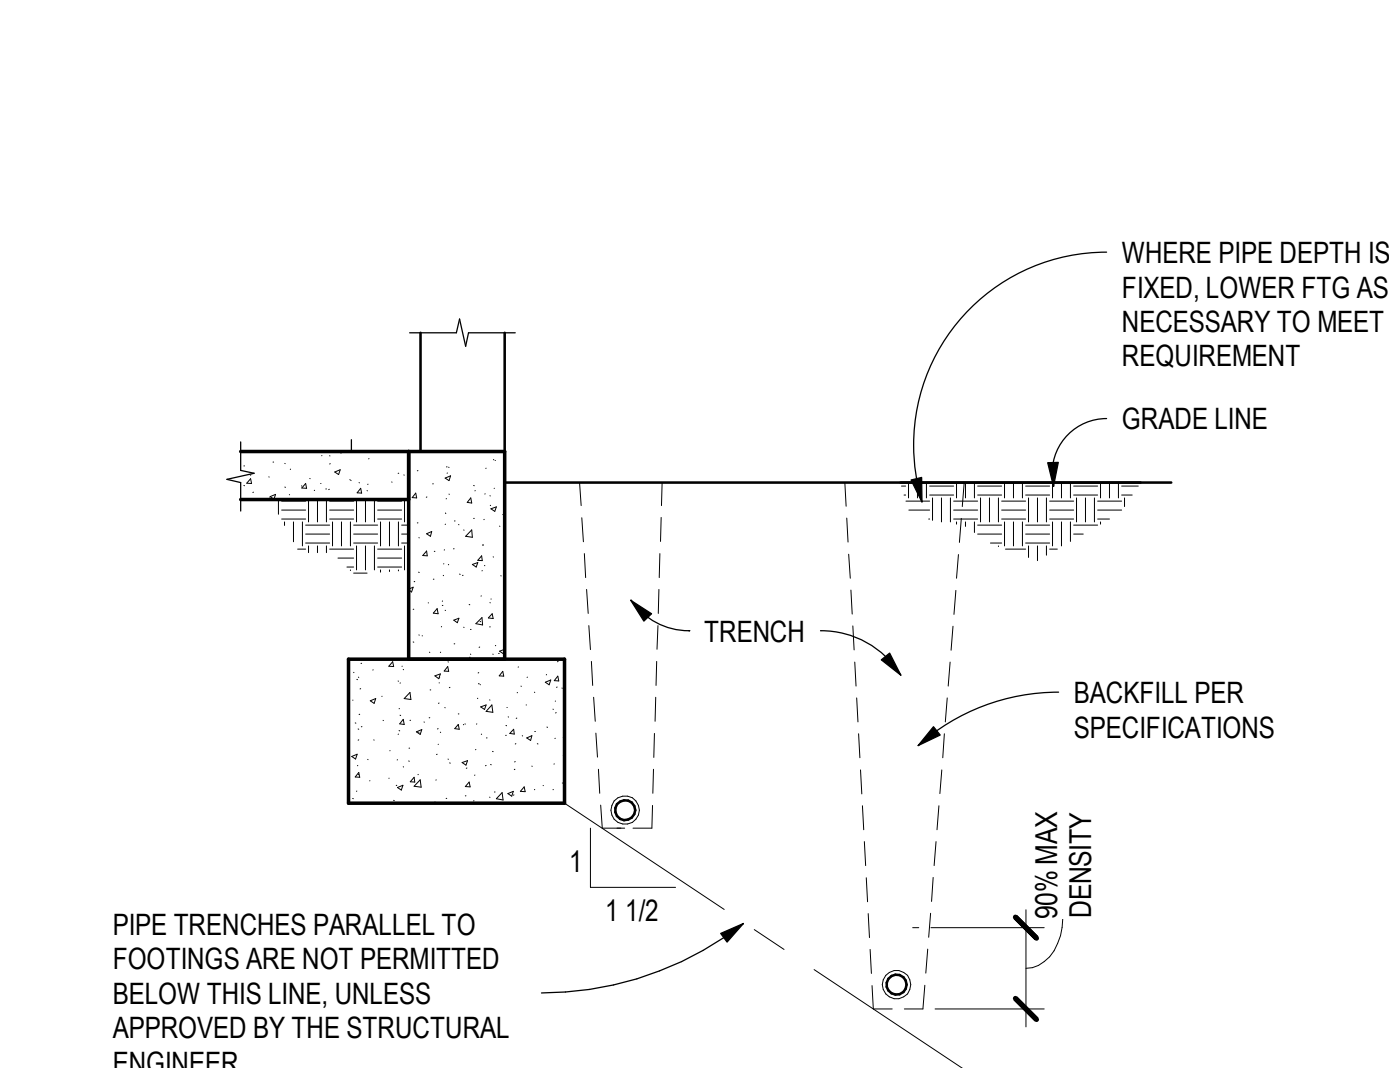


B2 CONTROL JOINT INTERSECTION
SCALE: 3/4" = 1'-0"

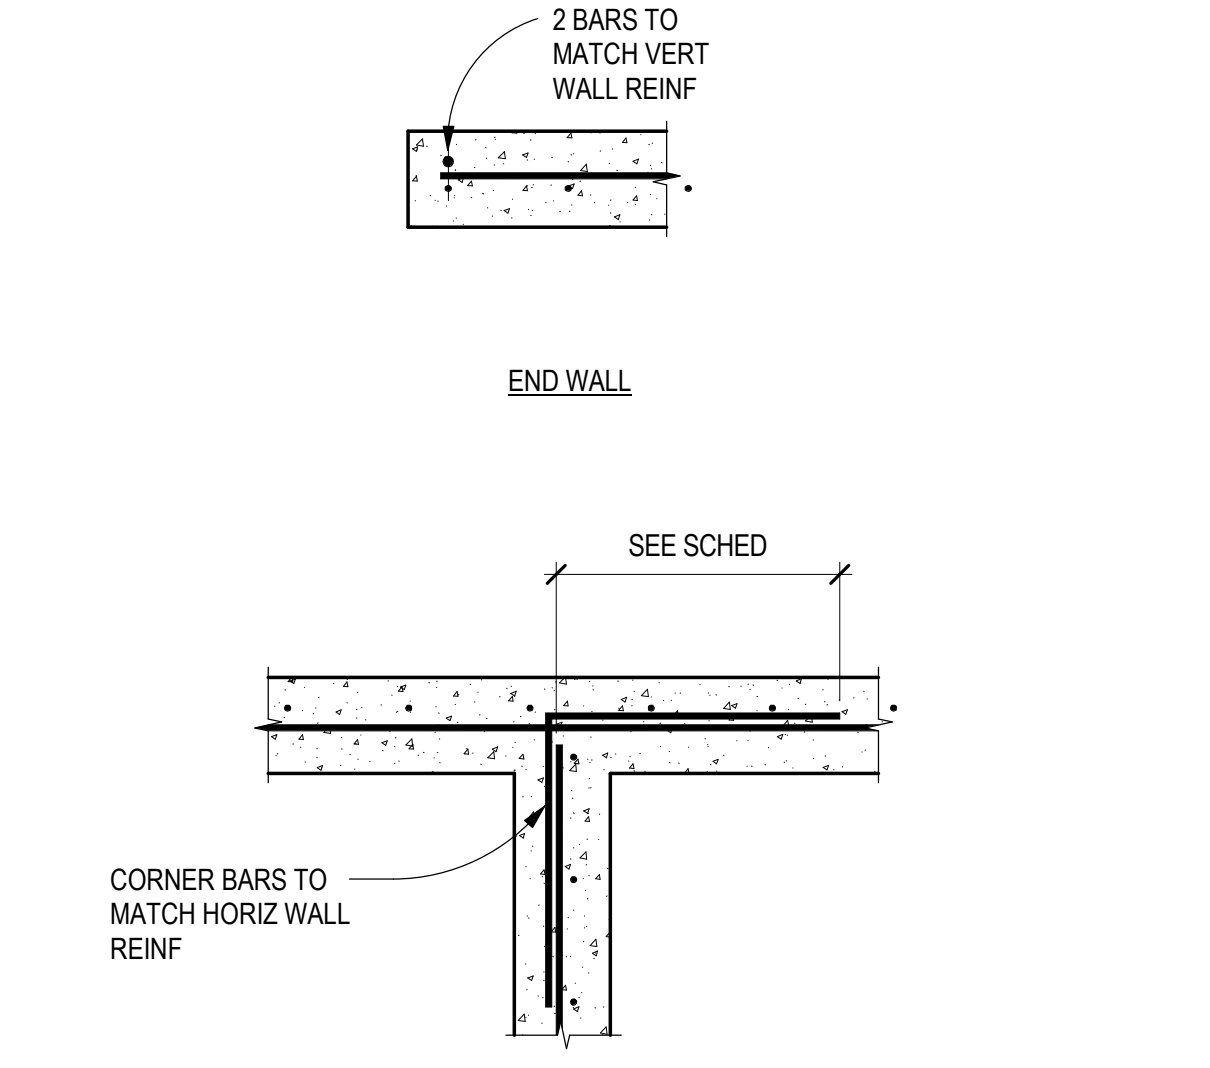


B4 TYPICAL TRENCH SECTION
SCALE: NTS

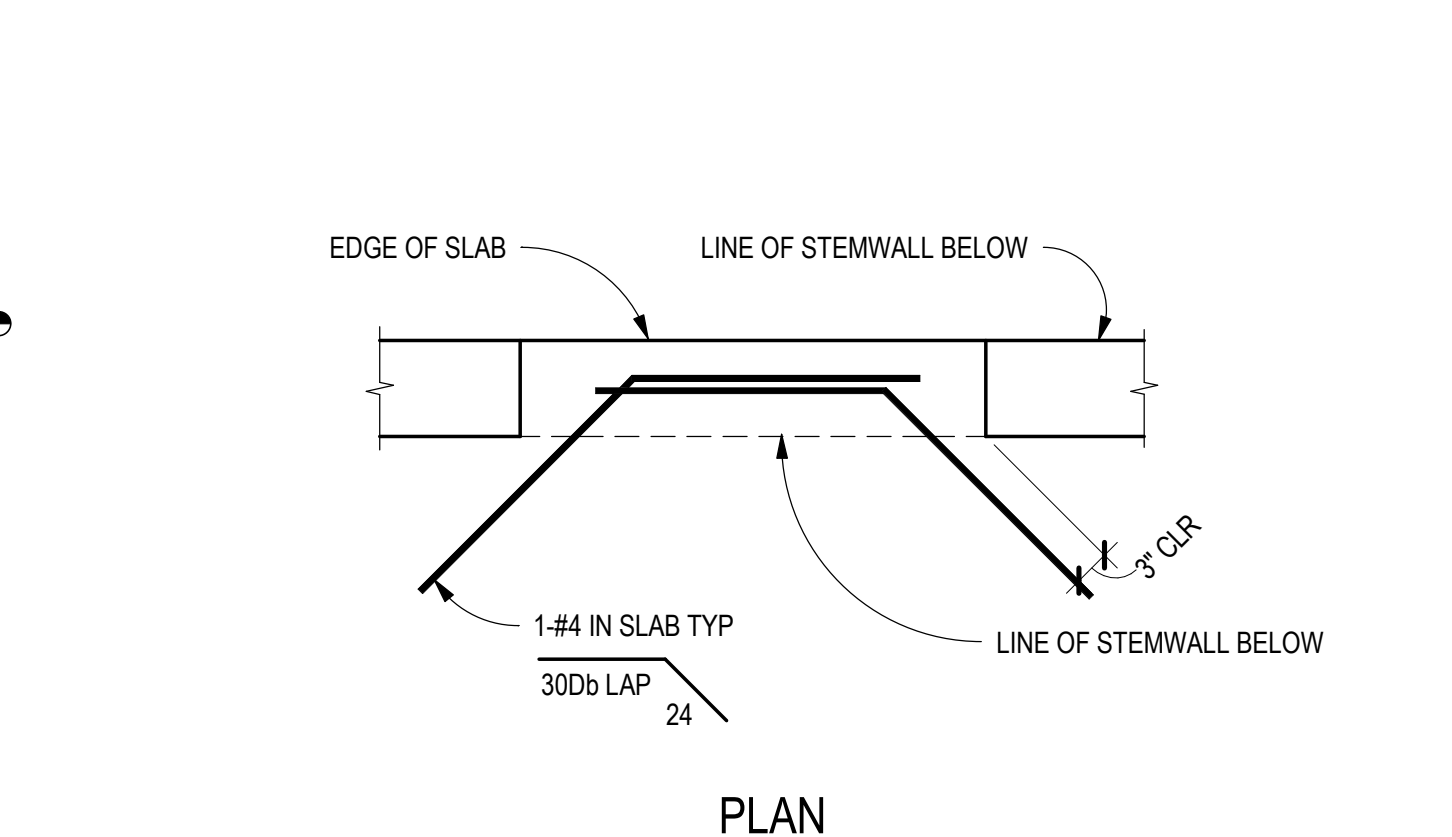


B5 TYPICAL SLAB REINF AT OPNG
SCALE: NTS

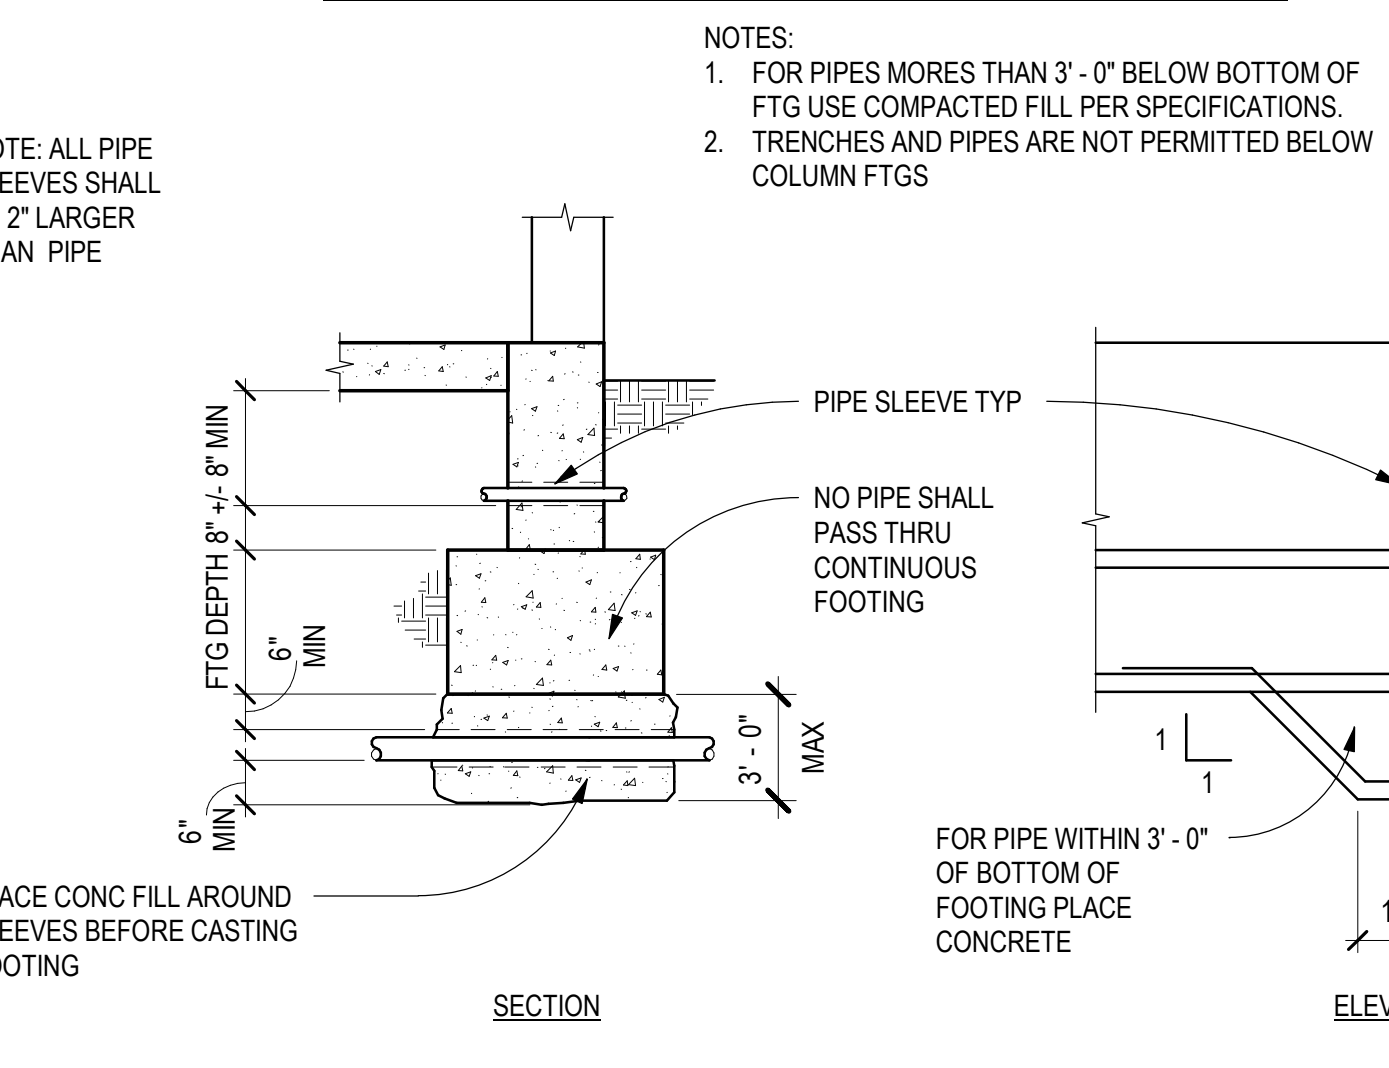


A1 TYPICAL PIPE PENETRATION AND TRENCH DETAILS
SCALE: NTS

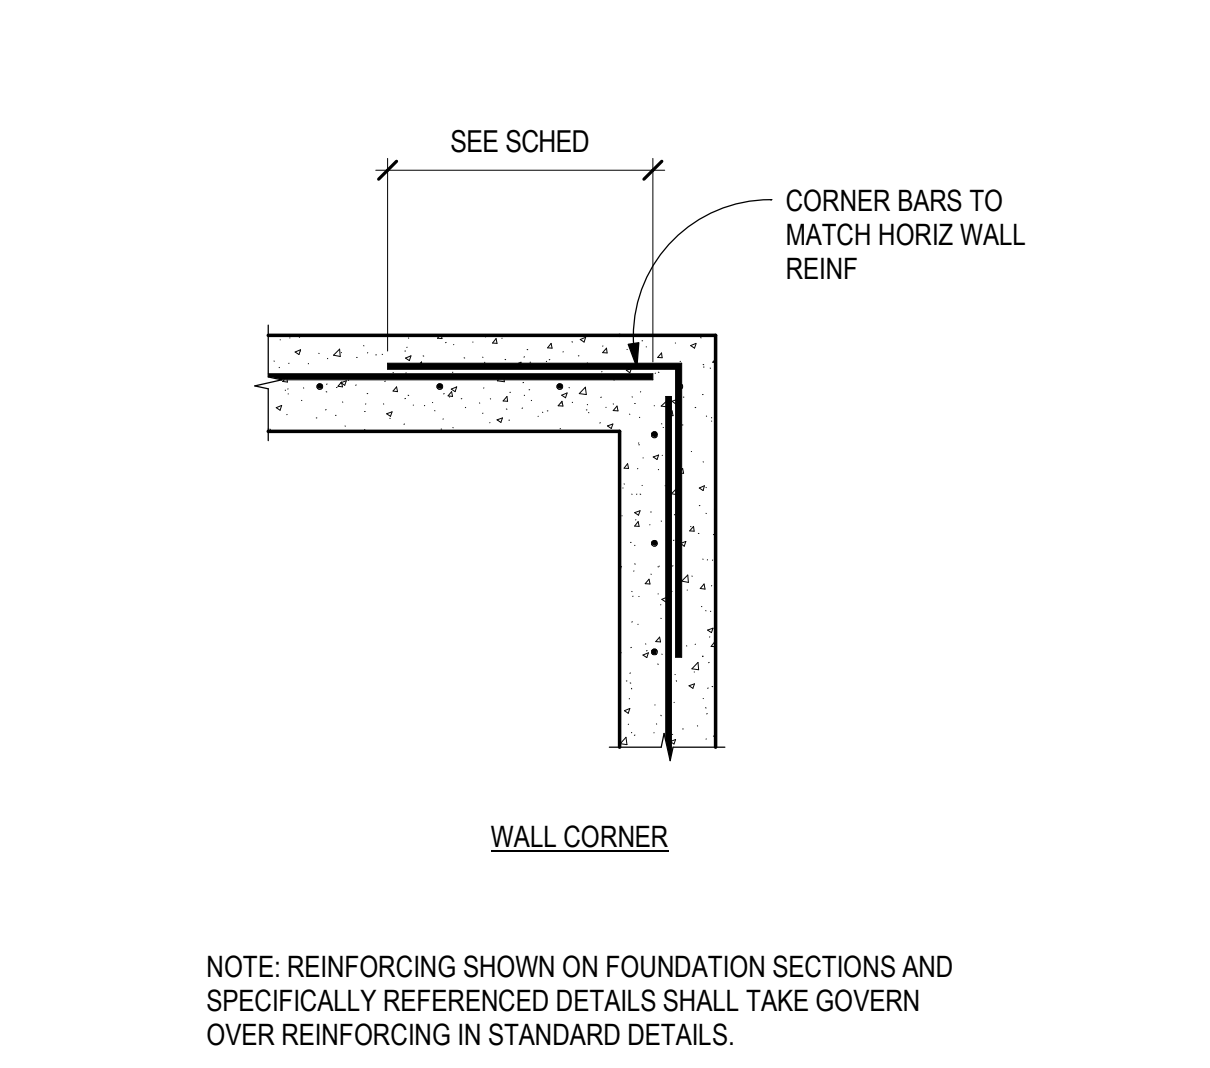

A3 TYPICAL SINGLE MAT WALL REINF
SCALE: NTS

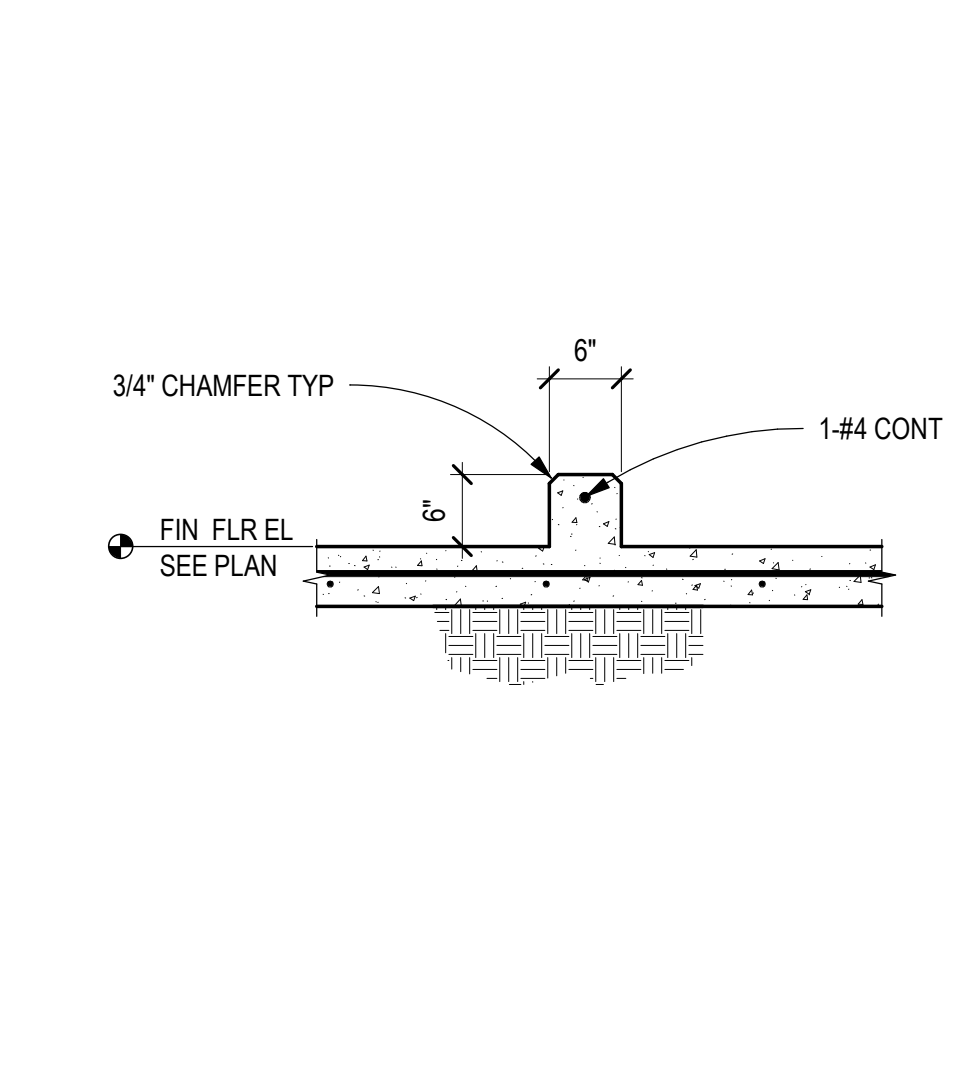

A4 TYPICAL CURB SECTION
SCALE: NTS

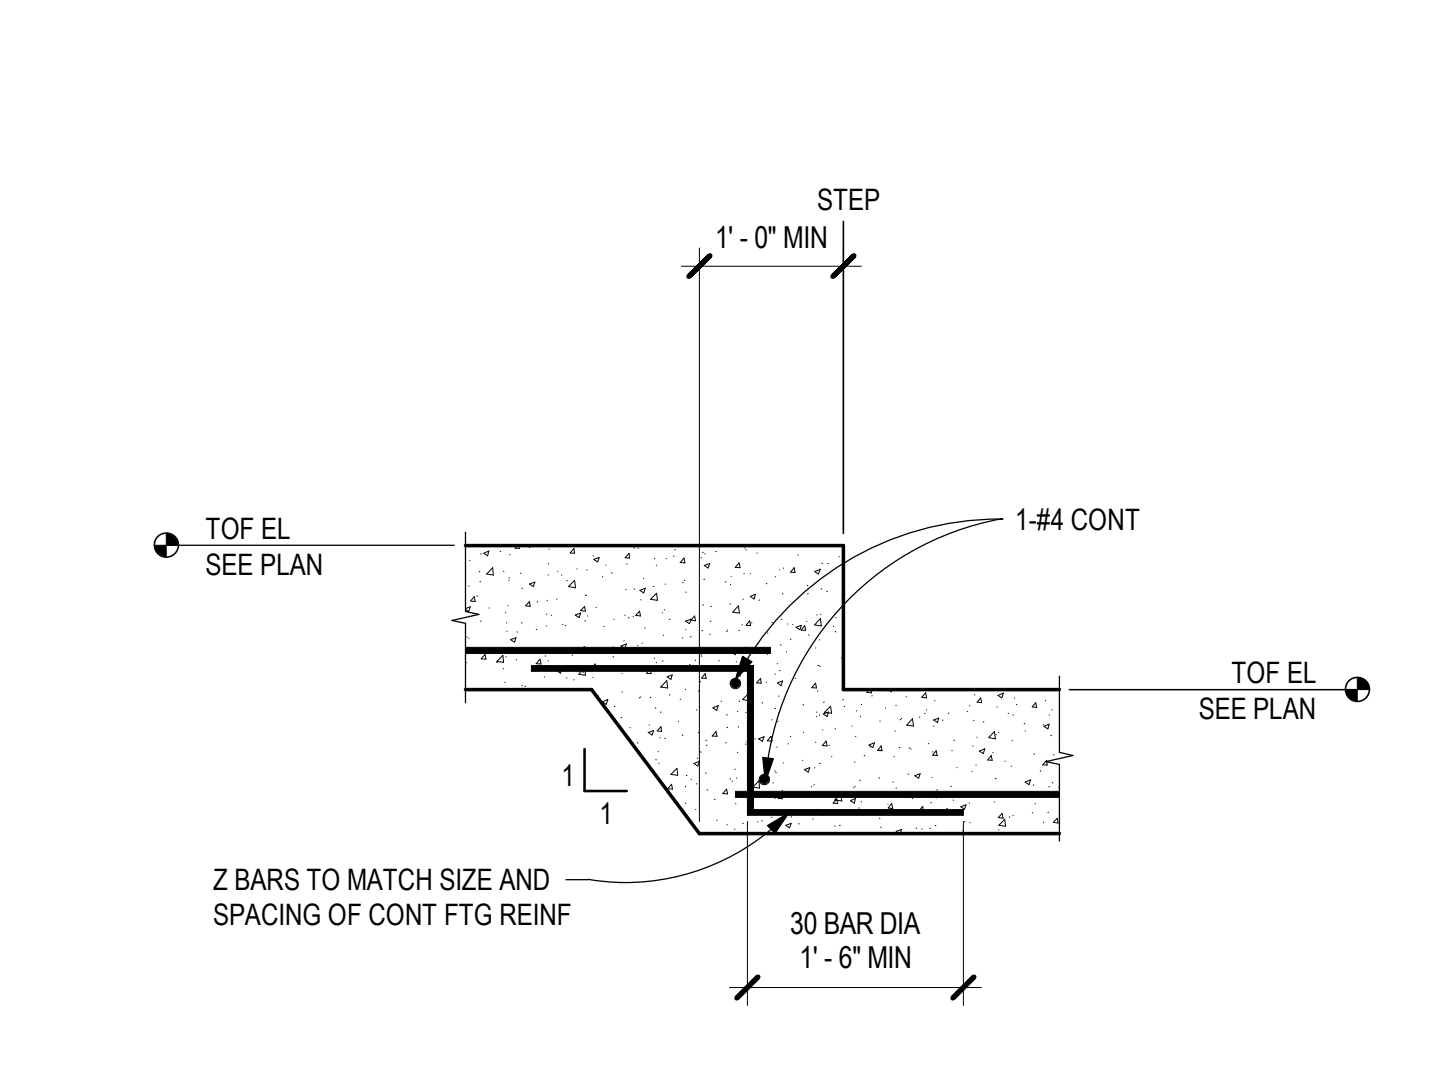


A5 TYPICAL STEPPED FOOTING DETAIL
SCALE: NTS

No.	Description	Date


TYPICAL CONCRETE DETAILS

PROGRESS SET


PROJECT: H11019.01
DRAWN: J. ANDERSON
CHECKED: C. ROMERO
DATE: 01/16/2019

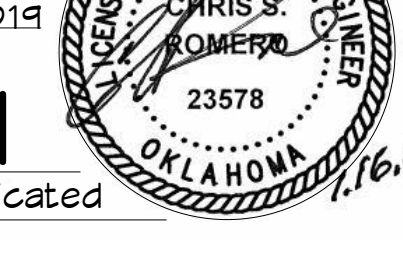


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Scale: As indicated

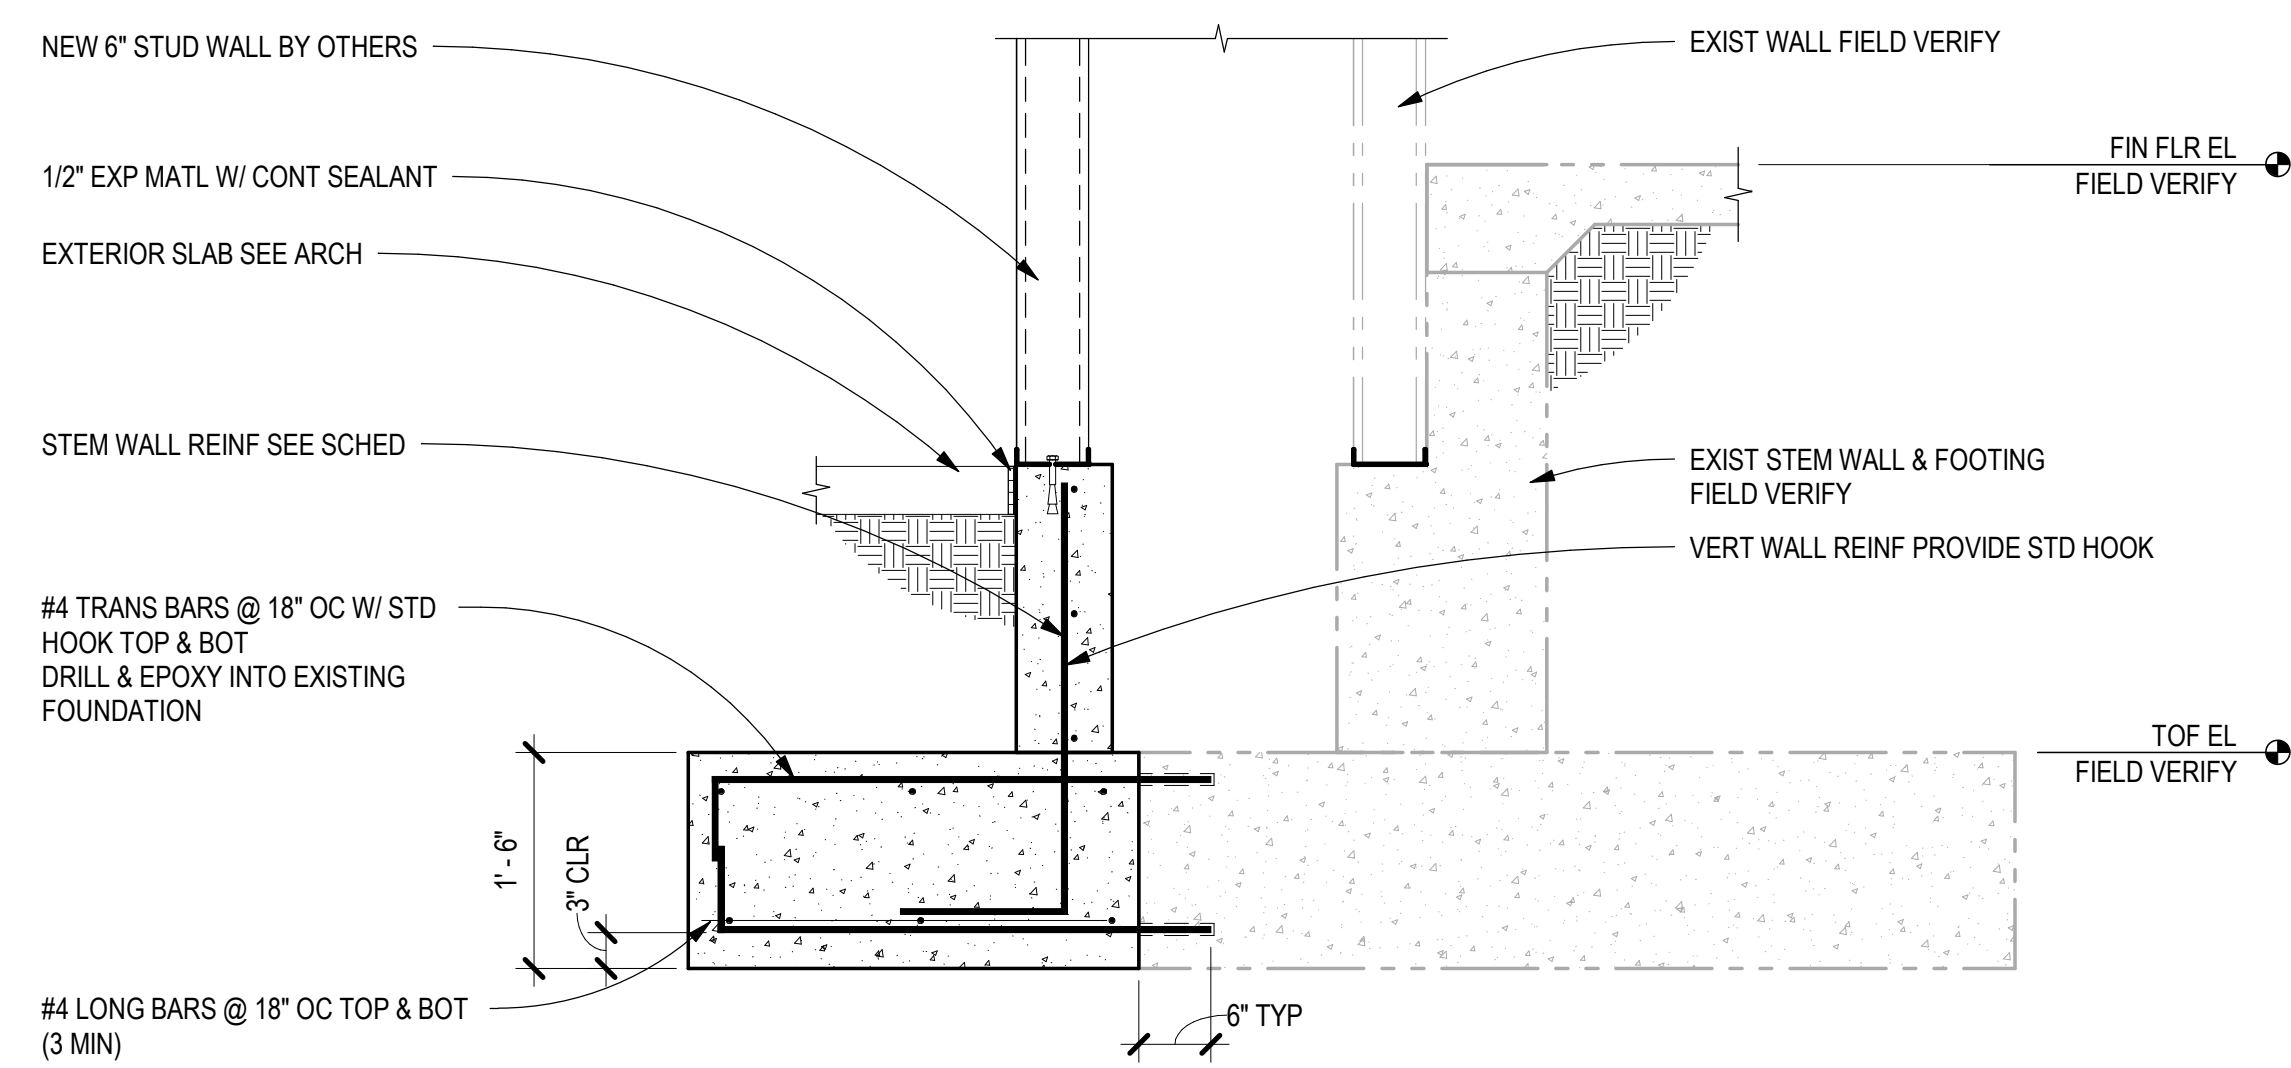


D1 FOUNDATIONS SECTION
SCALE: 3/4" = 1'-0"

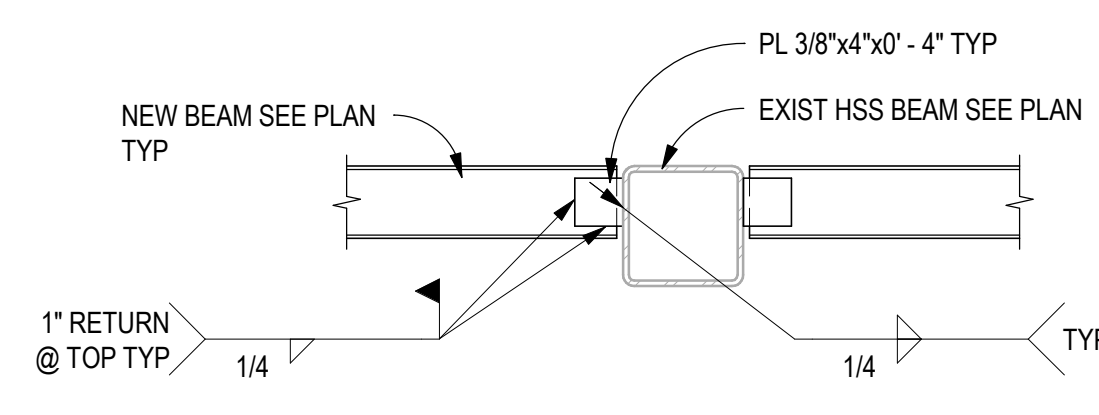


D3 FRAMING DETAIL
SCALE: 3/4" = 1'-0"

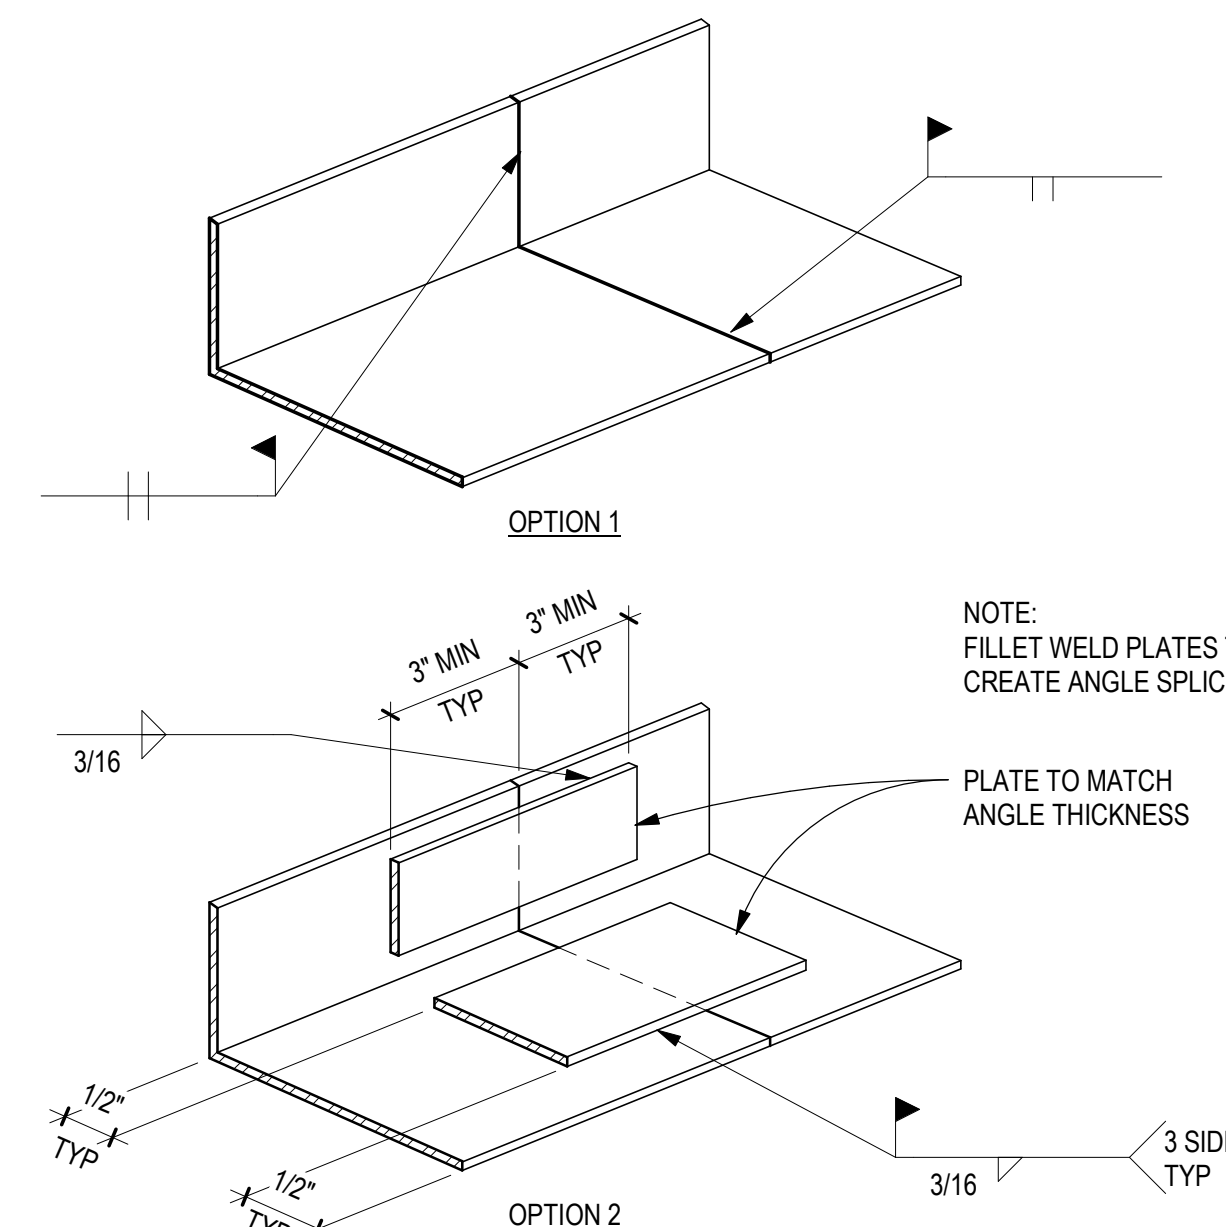


D4 TYPICAL PERIMETER ANGLE SPLICE
SCALE: NTS

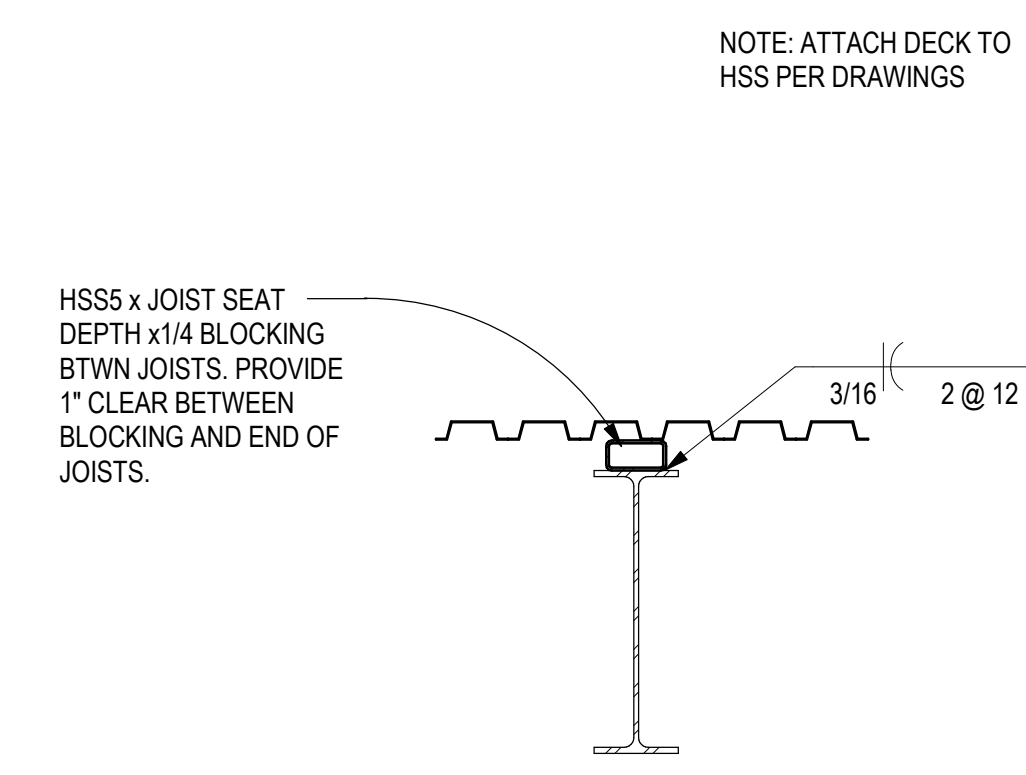


D5 TYPICAL HSS BLOCKING DETAIL
SCALE: 3/4" = 1'-0"

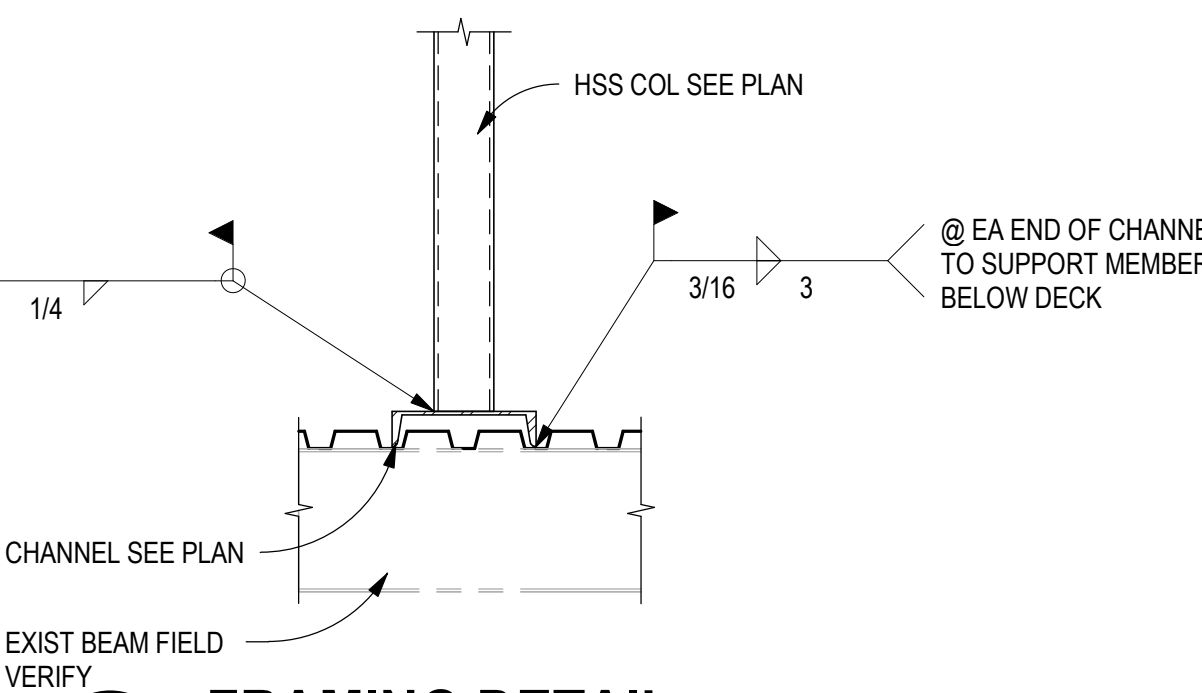


C3 FRAMING DETAIL
SCALE: 3/4" = 1'-0"

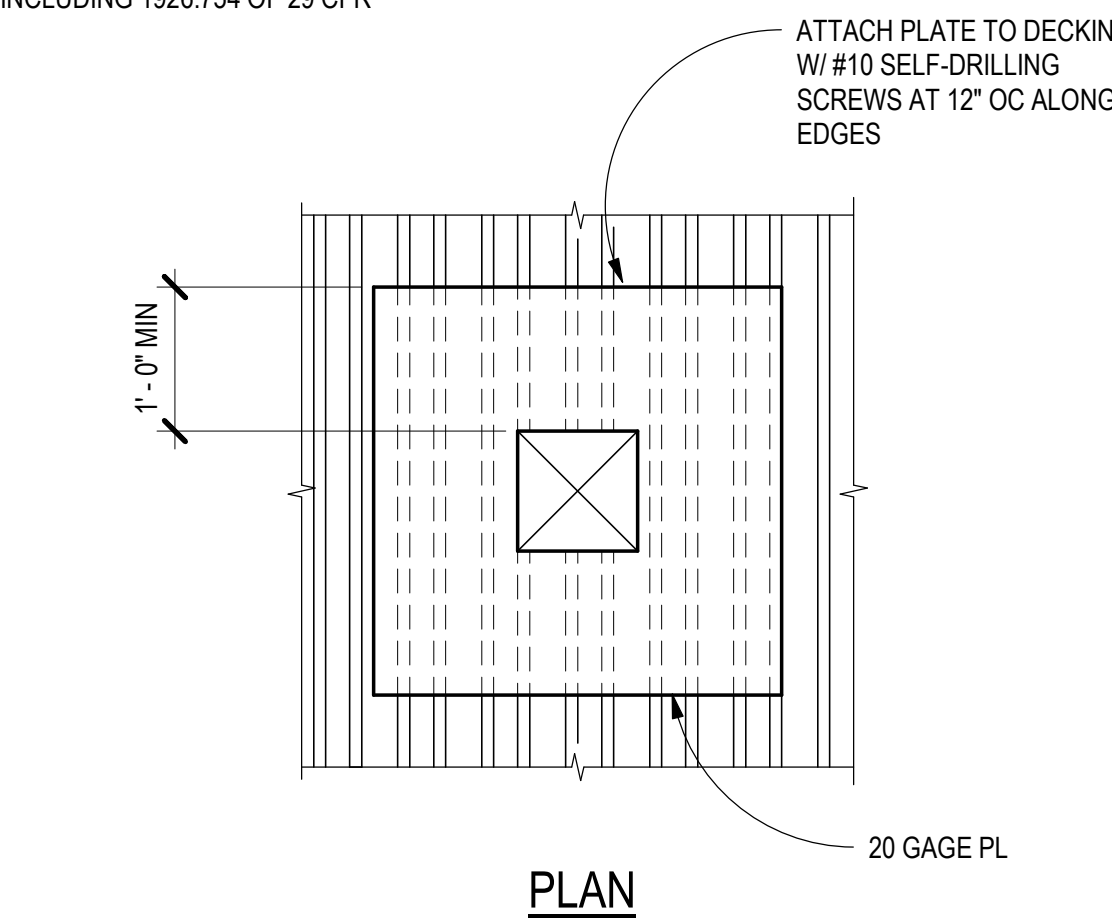


C4 TYPICAL ROOF OPENING 0\"/>

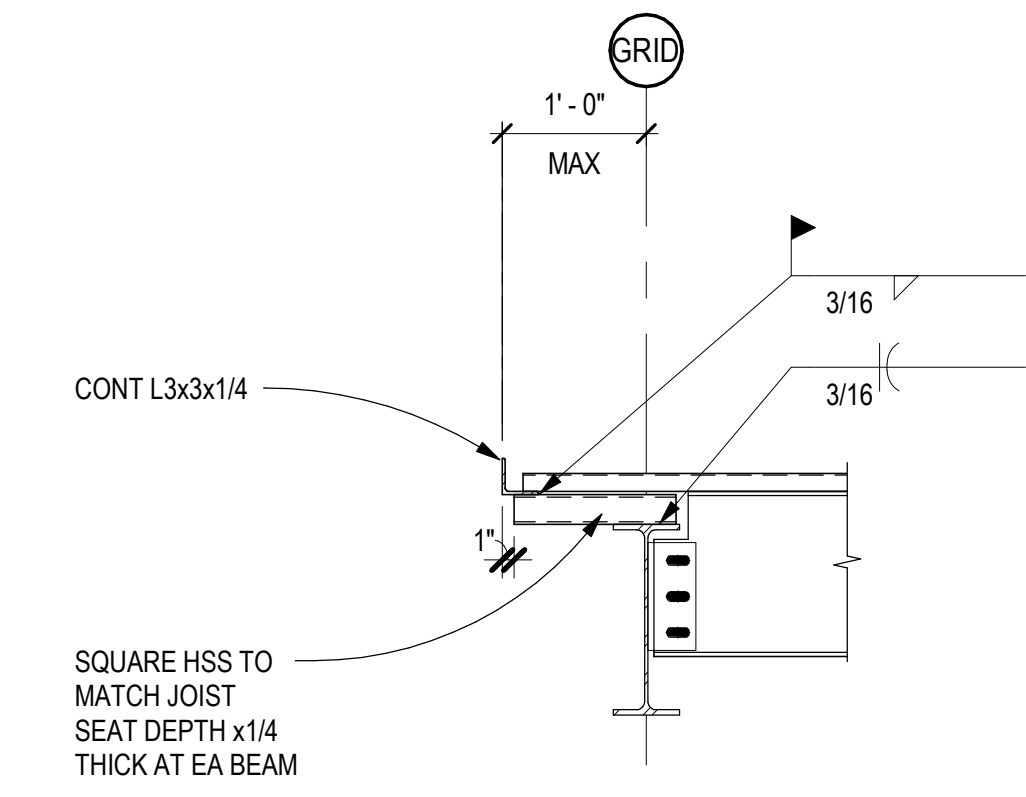


C5 TYPICAL DECK EDGE AT BEAM
SCALE: 3/4" = 1'-0"

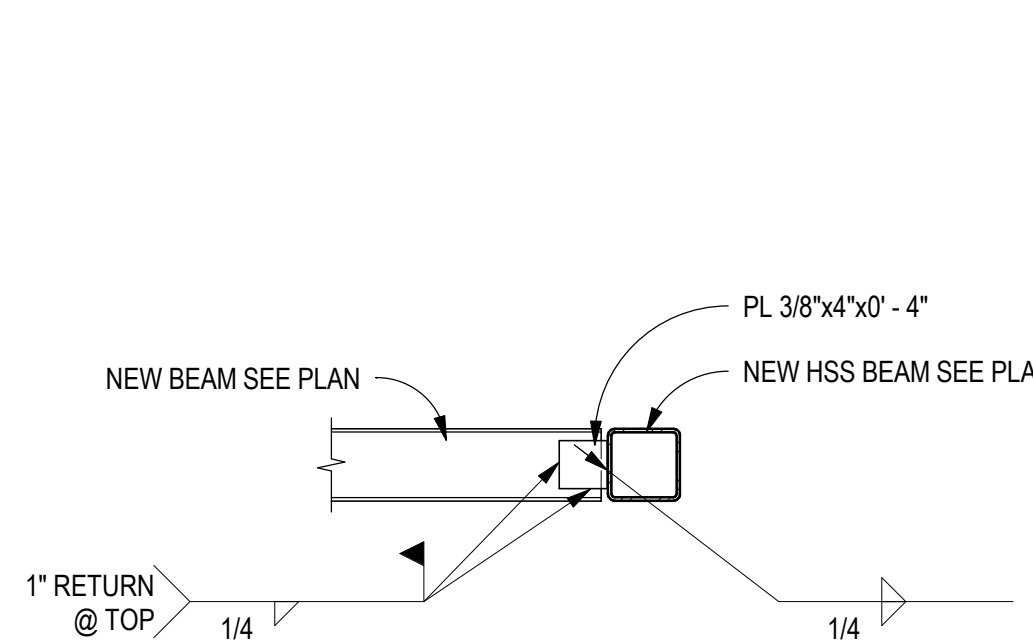


B2 FRAMING DETAIL
SCALE: 3/4" = 1'-0"

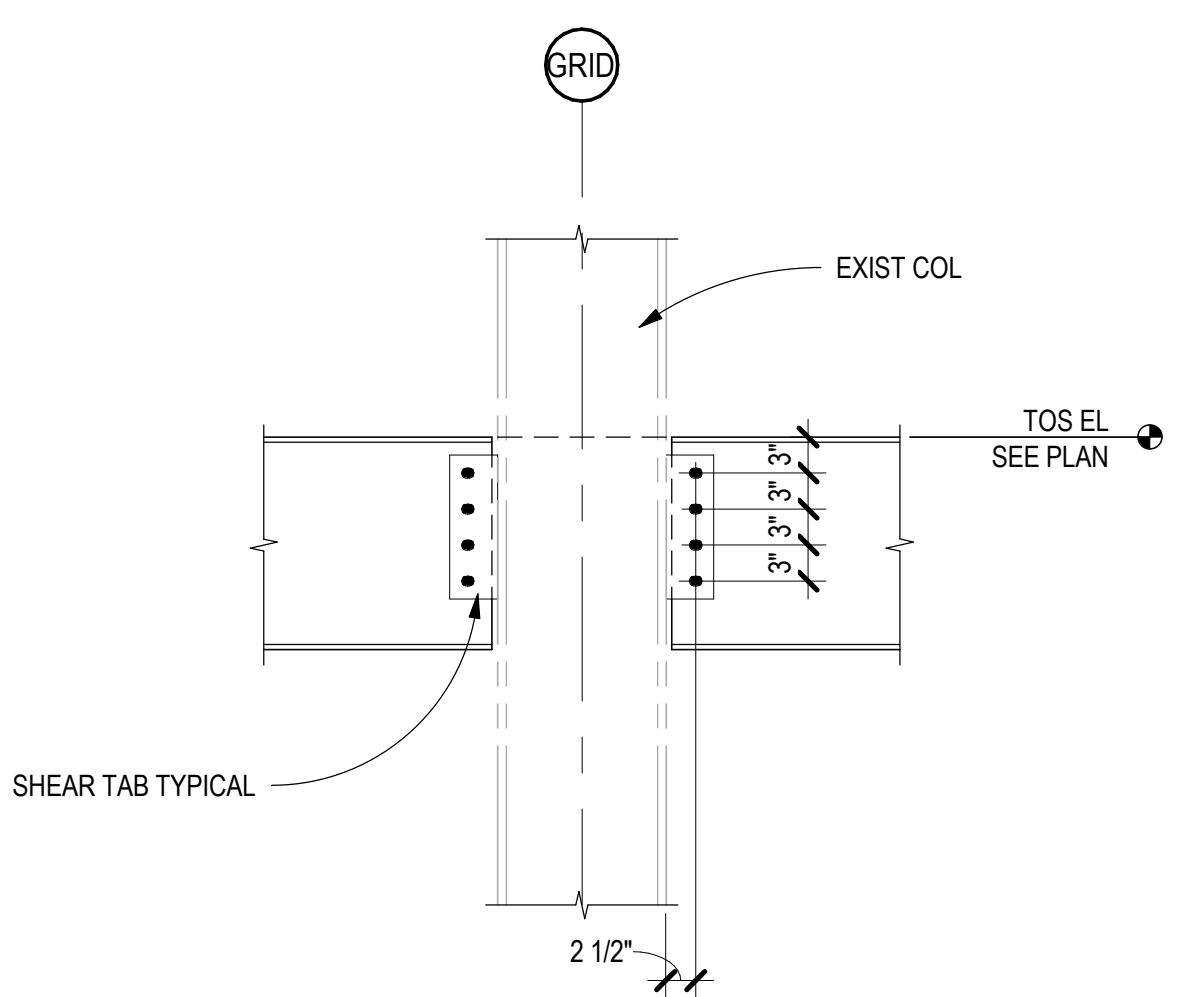


B3 BEAM TO EXIST COLUMN FLANGE CONN
SCALE: 3/4" = 1'-0"

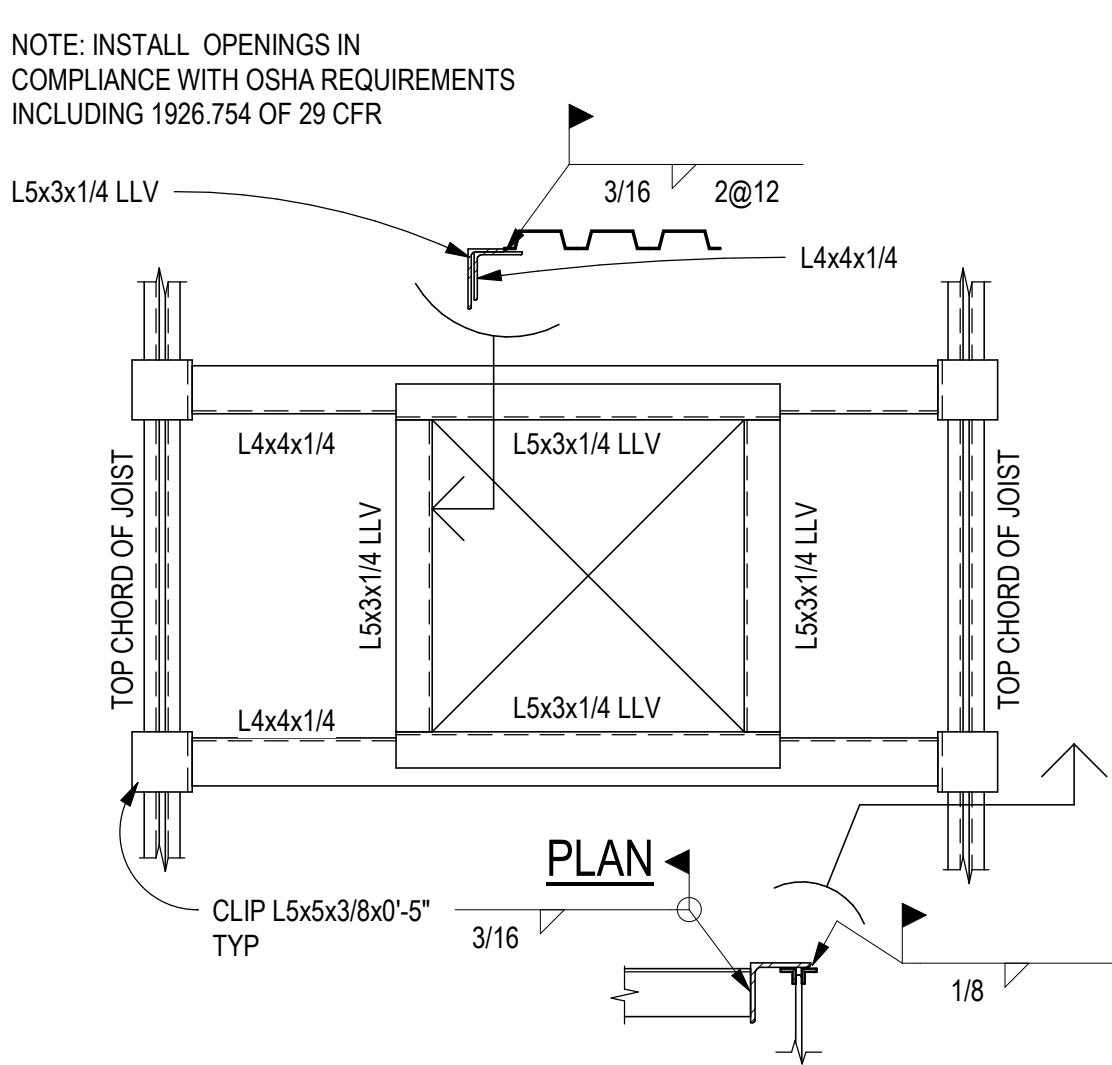


B4 TYPICAL ROOF OPENING > 12\"/>

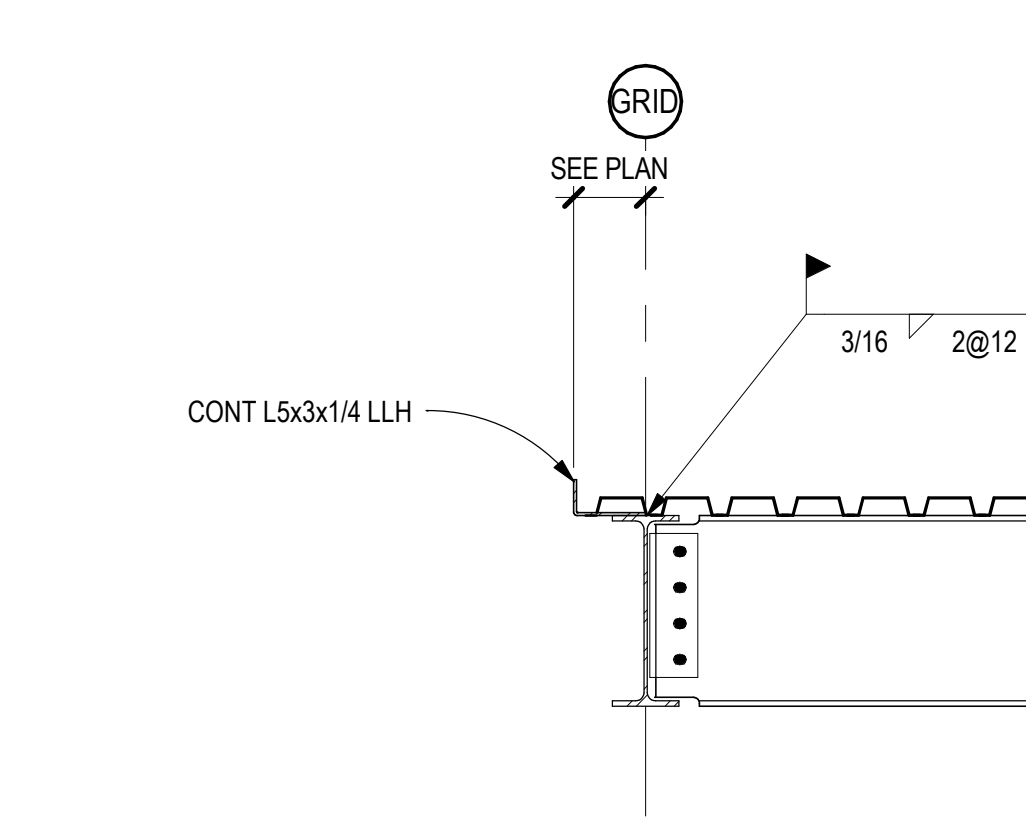


B5 TYPICAL ROOF BRG DECK EDGE
SCALE: 3/4" = 1'-0"

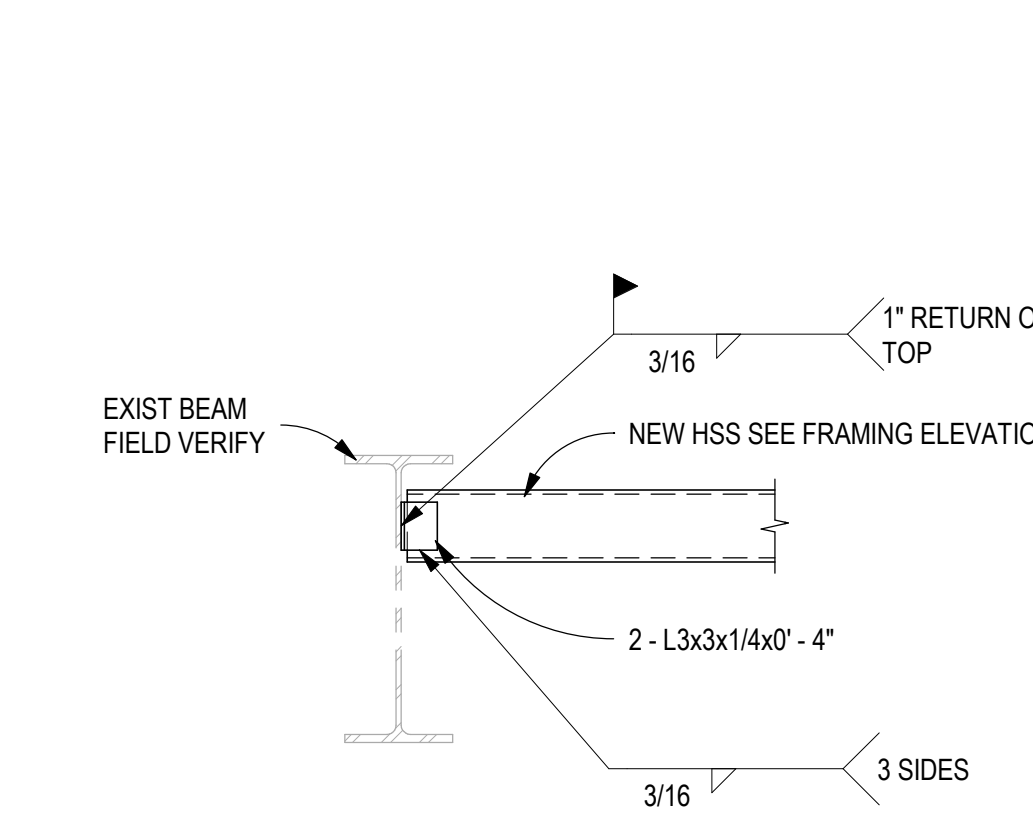


A2 FRAMING DETAIL
SCALE: 3/4" = 1'-0"

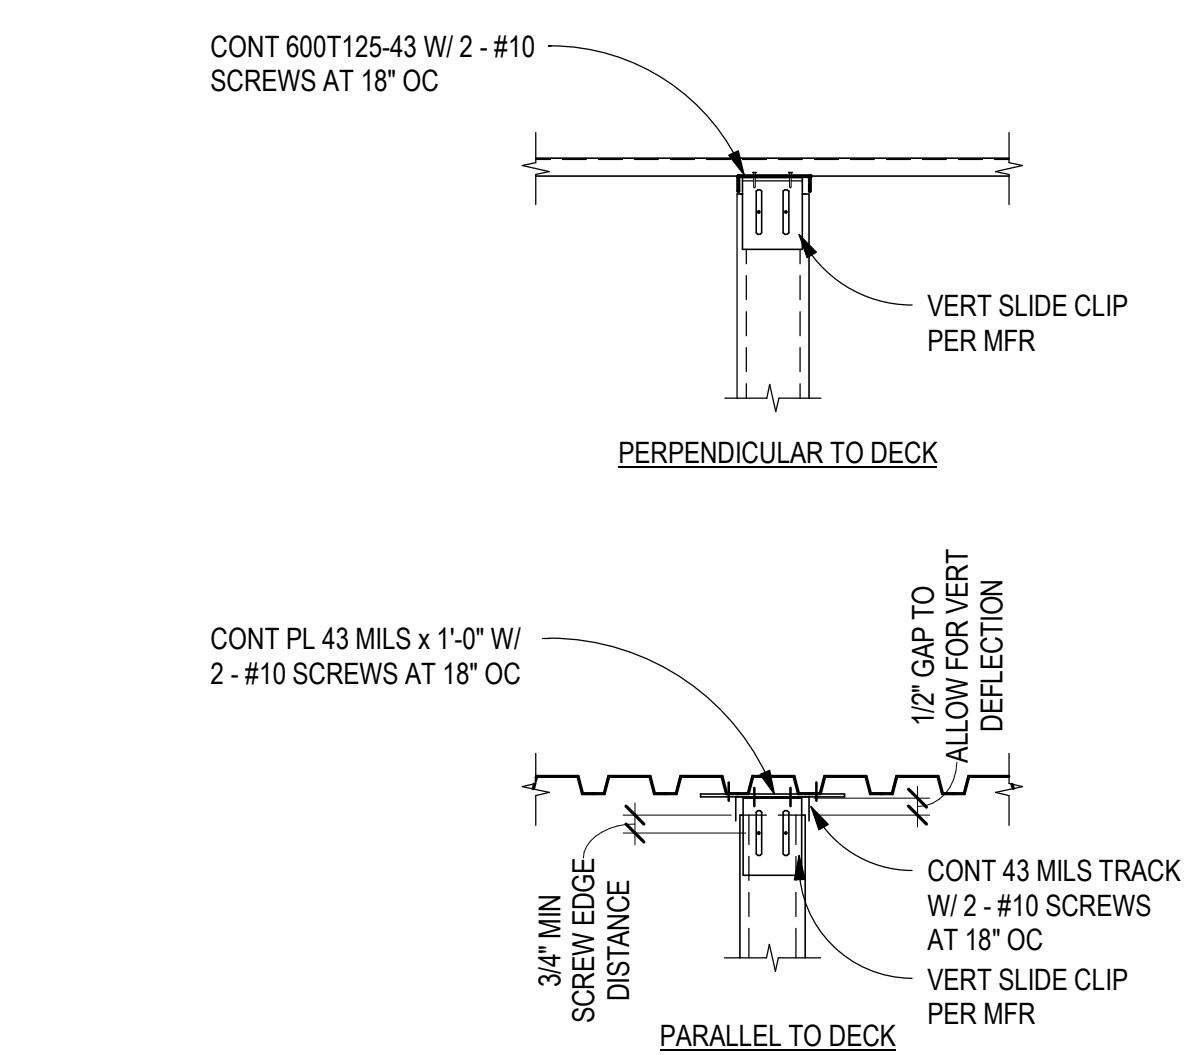

A3 TYPICAL SLIP TRACK ASSEMBLY
SCALE: 3/4" = 1'-0"

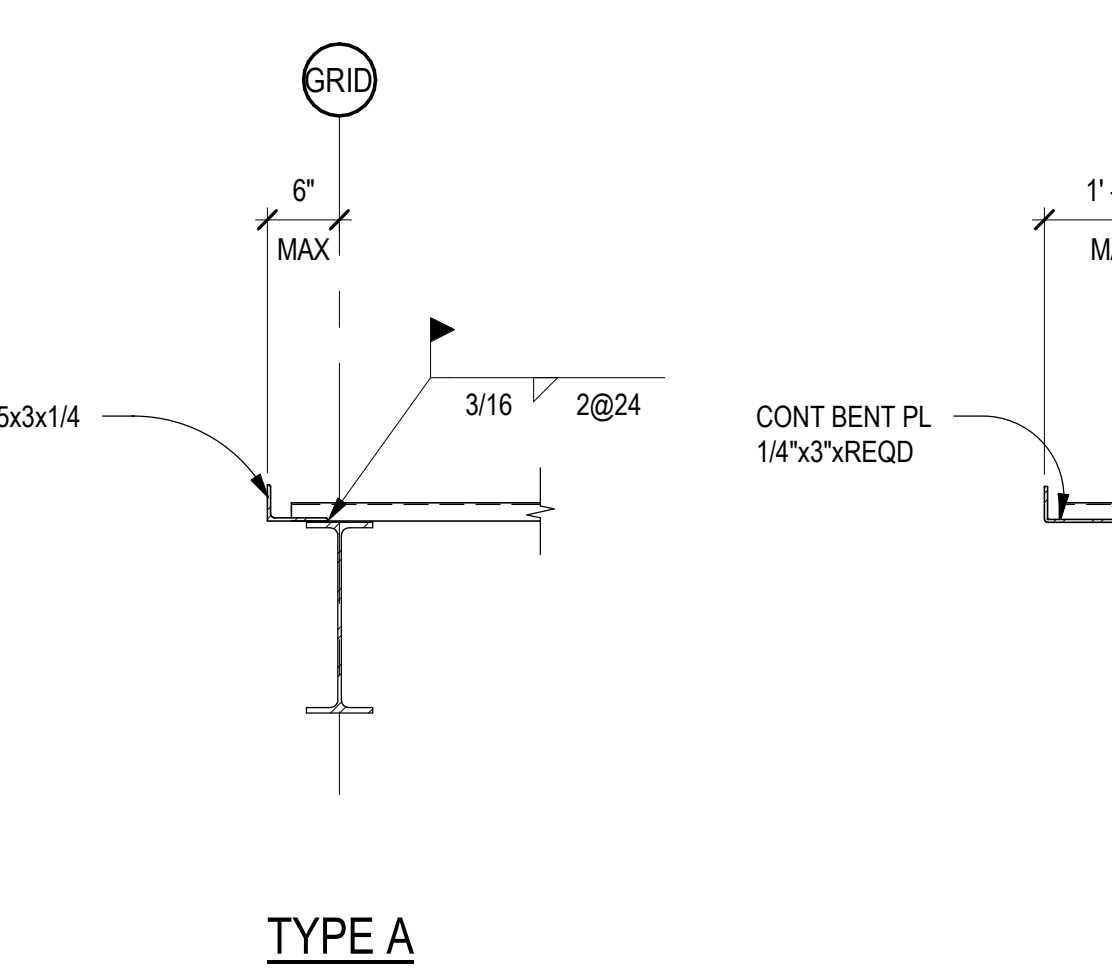

A4 TYPICAL DECK EDGE AT NON-BEARING
SCALE: 3/4" = 1'-0"

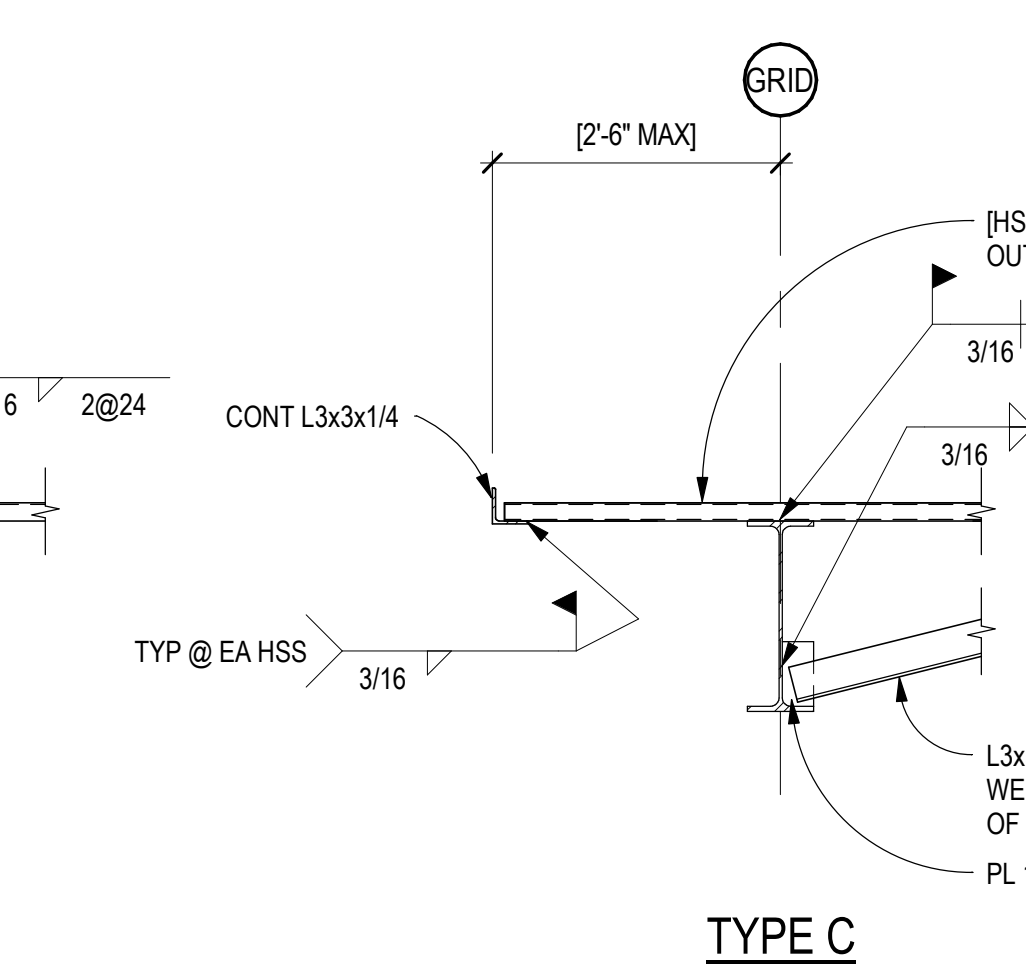

A5 TYPICAL STEEL DETAILS
SCALE: 3/4" = 1'-0"

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EXTERIOR FACADE RENOVATION

No.	Description	Date

No.	Description	Date

TYPICAL STEEL DETAILS
PROGRESS SET

PROJECT: H11018.01
DRAWN: J. ANDERSON
CHECKED: C. ROMERO
DATE: 01/16/2019
SCALE: 3/4" = 1'-0"
S-741
Scale: 3/4" = 1'-0"

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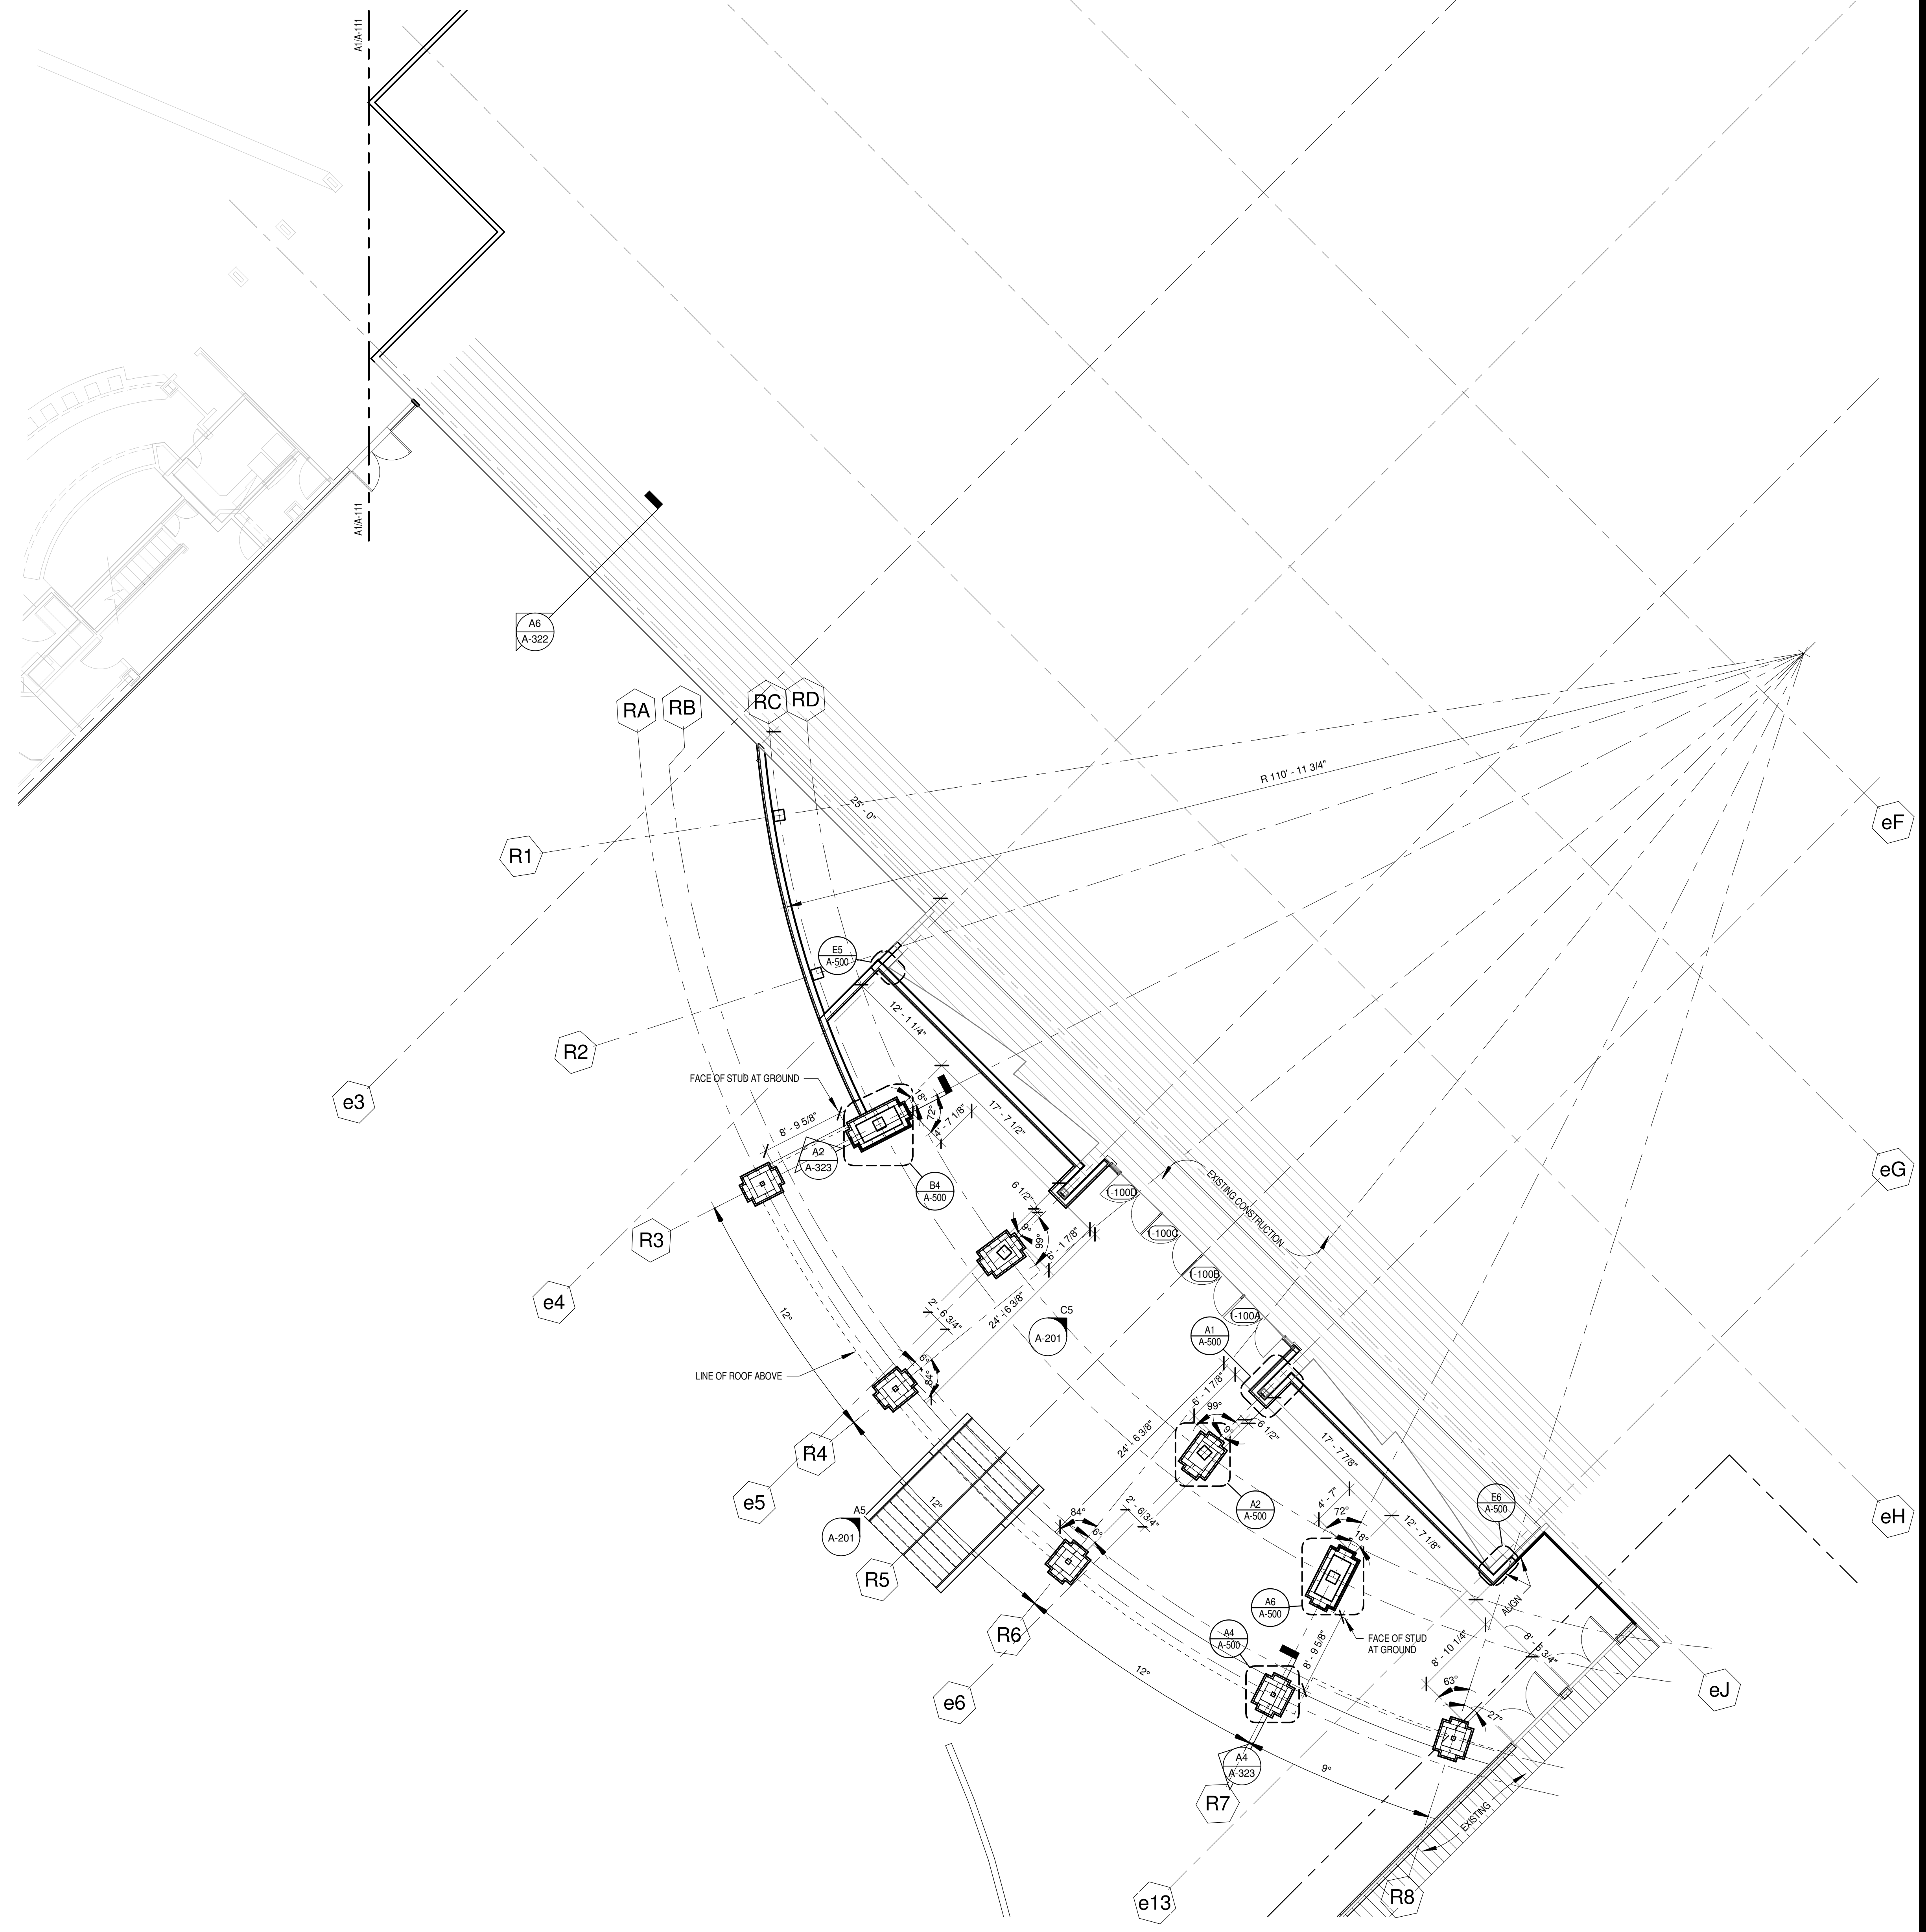
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Buffalo, NY 14202
716-845-5092



A1 FLOOR PLAN
SCALE: 1/8" = 1'-0"

Cherokee Hard Rock Hotel & Casino

EXTERIOR FACADE RENOVATION


KEY PLAN

No.	Description	Date

SHEET TITLE
FIRST FLOOR CASINO 3


CONSTRUCTION SET

PROJECT NO: H17018
DRAWN BY: EB
CHECKED BY: DH
ISSUE DATE: 12/21/2018

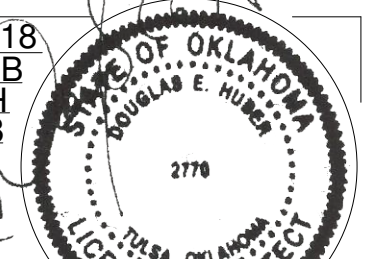

A-110
Scale 1/8" = 1'-0"

A B C D E

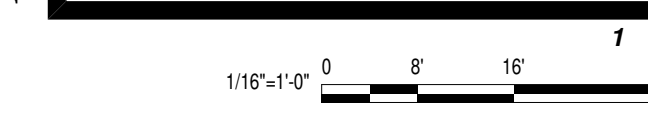

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Cherokee Hard Rock Hotel & Casino

PROJECT

EXTERIOR FACADE RENOVATION

KEY PLAN
⊕


No.	Description	Date

SHEET TITLE
FIRST FLOOR CASINO 2

CONSTRUCTION SET

PROJECT NO: H17018
DRAWN BY: SB
CHECKED BY: DH
ISSUE DATE: 12/21/2018

A-111
Scale 1/8" = 1'-0"

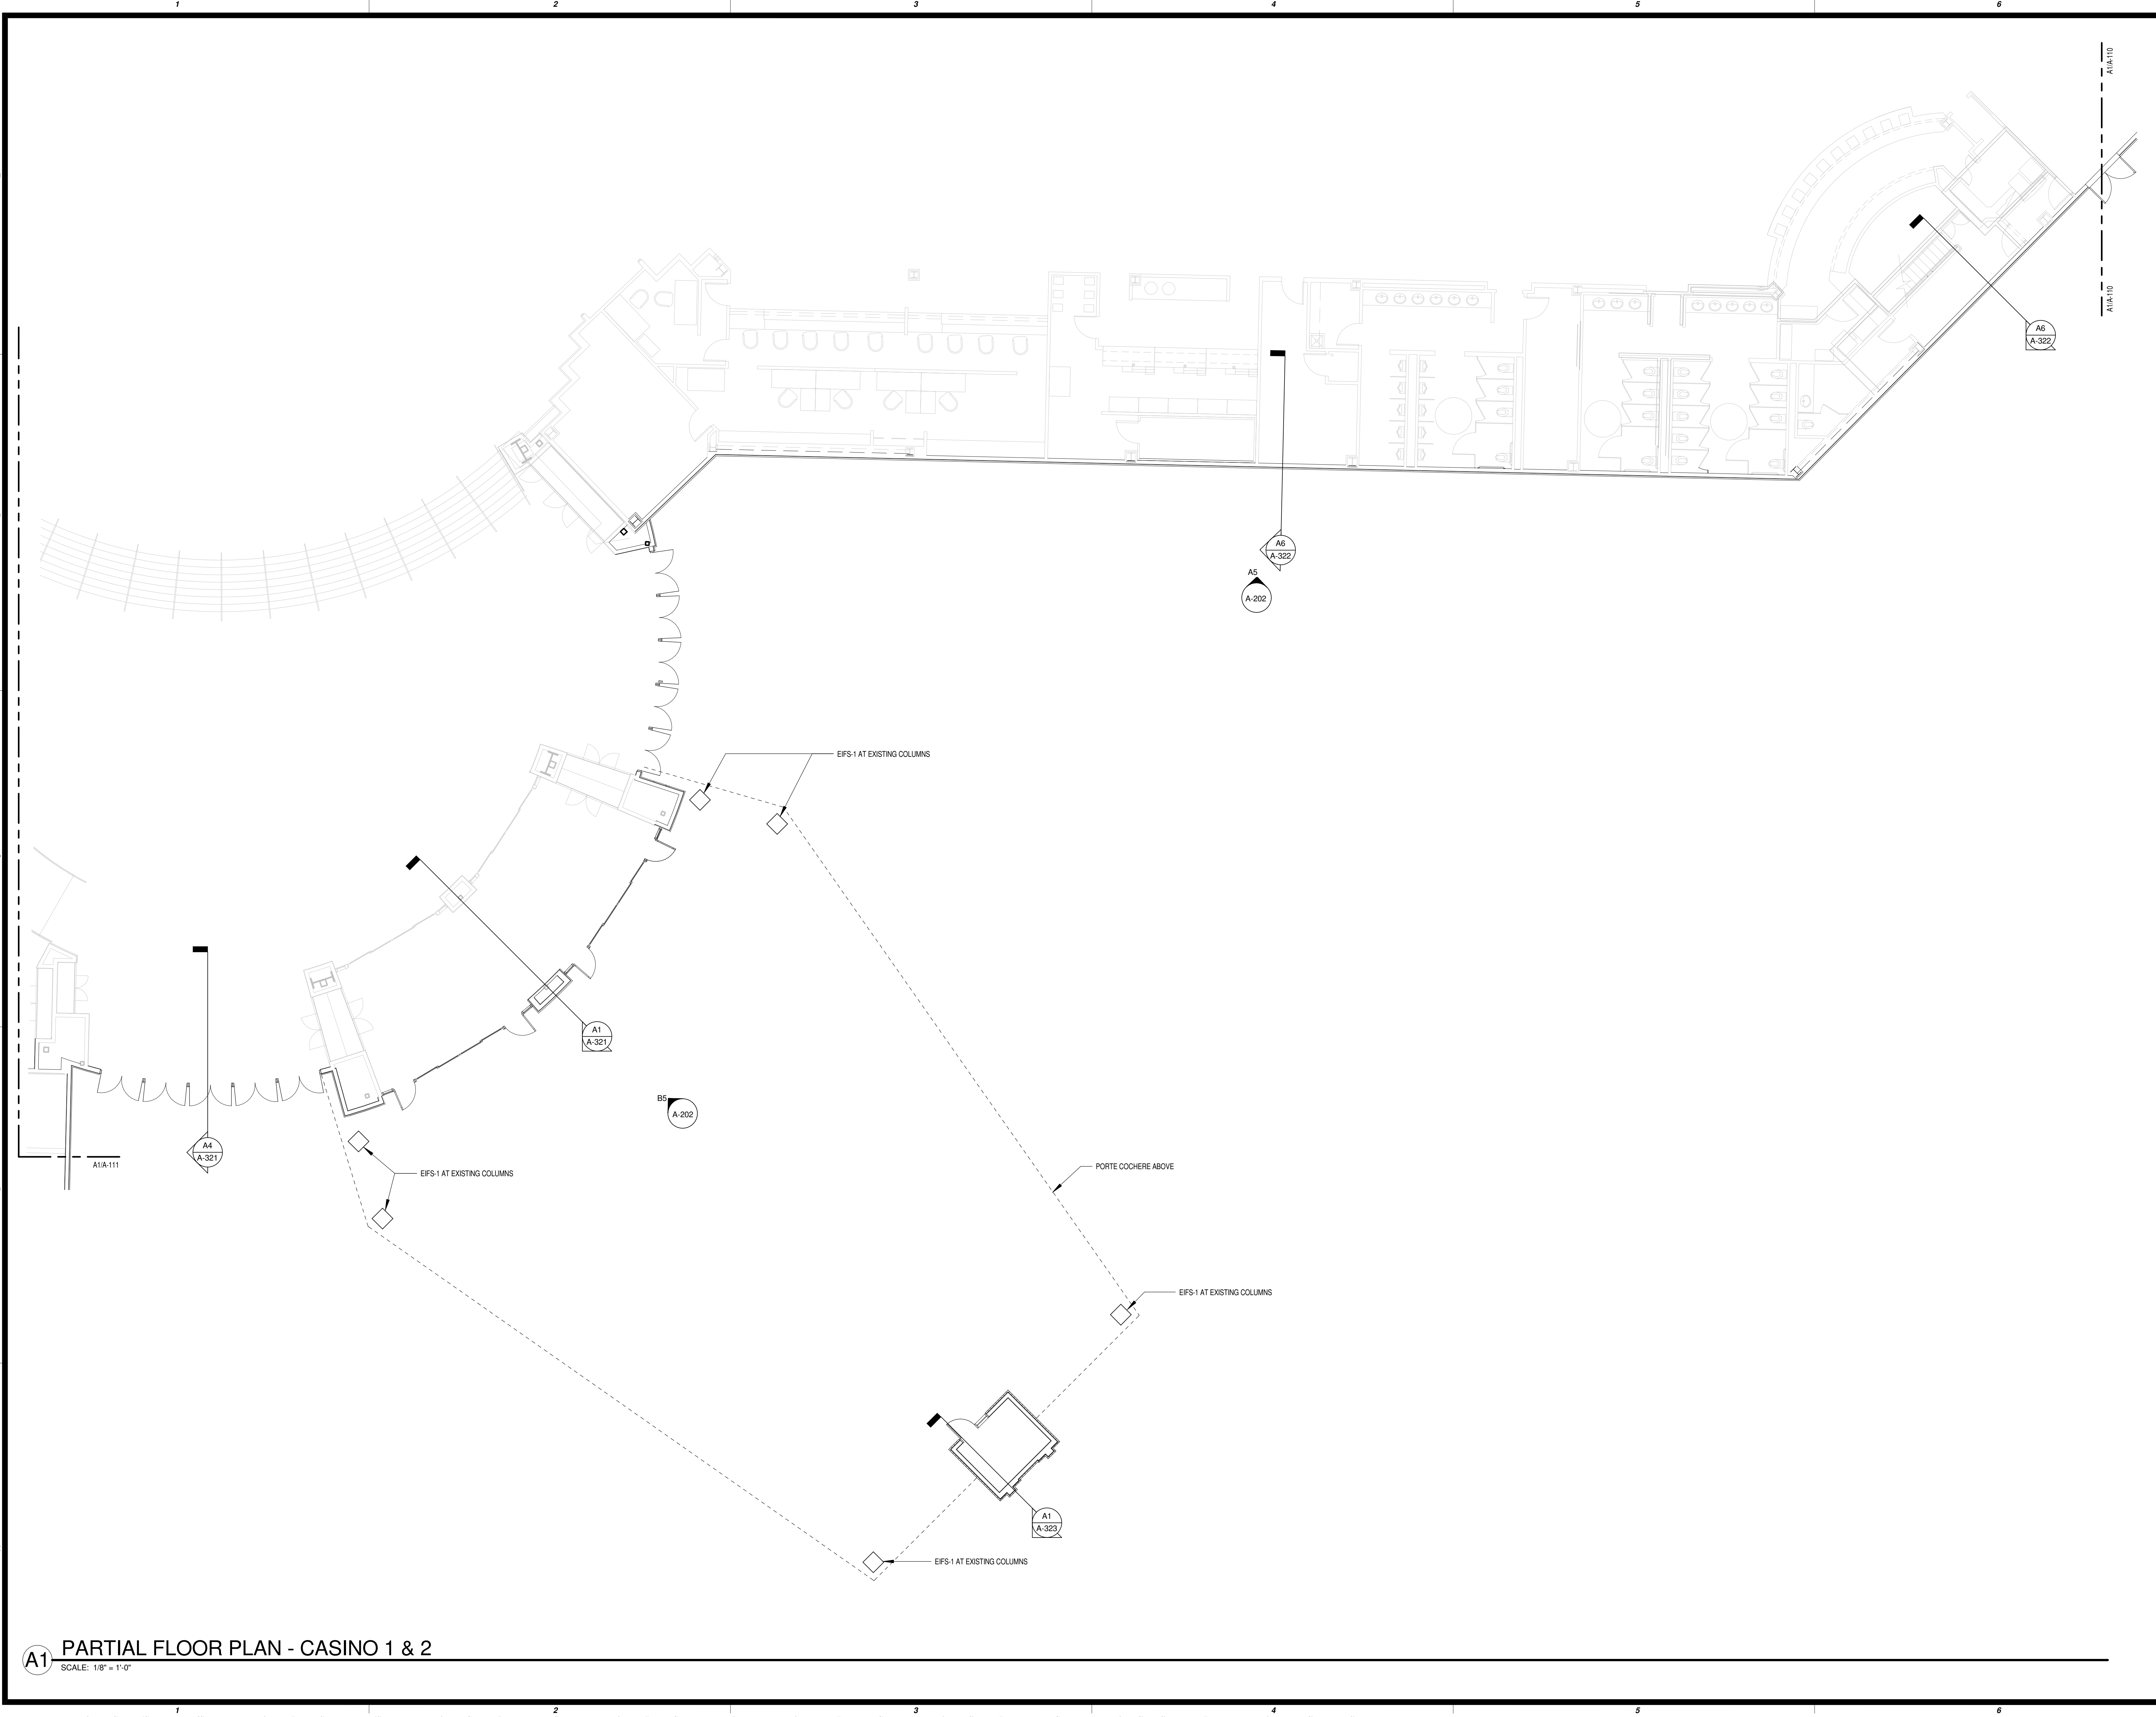

A1 PARTIAL FLOOR PLAN - CASINO 1 & 2
SCALE: 1/8" = 1'-0"



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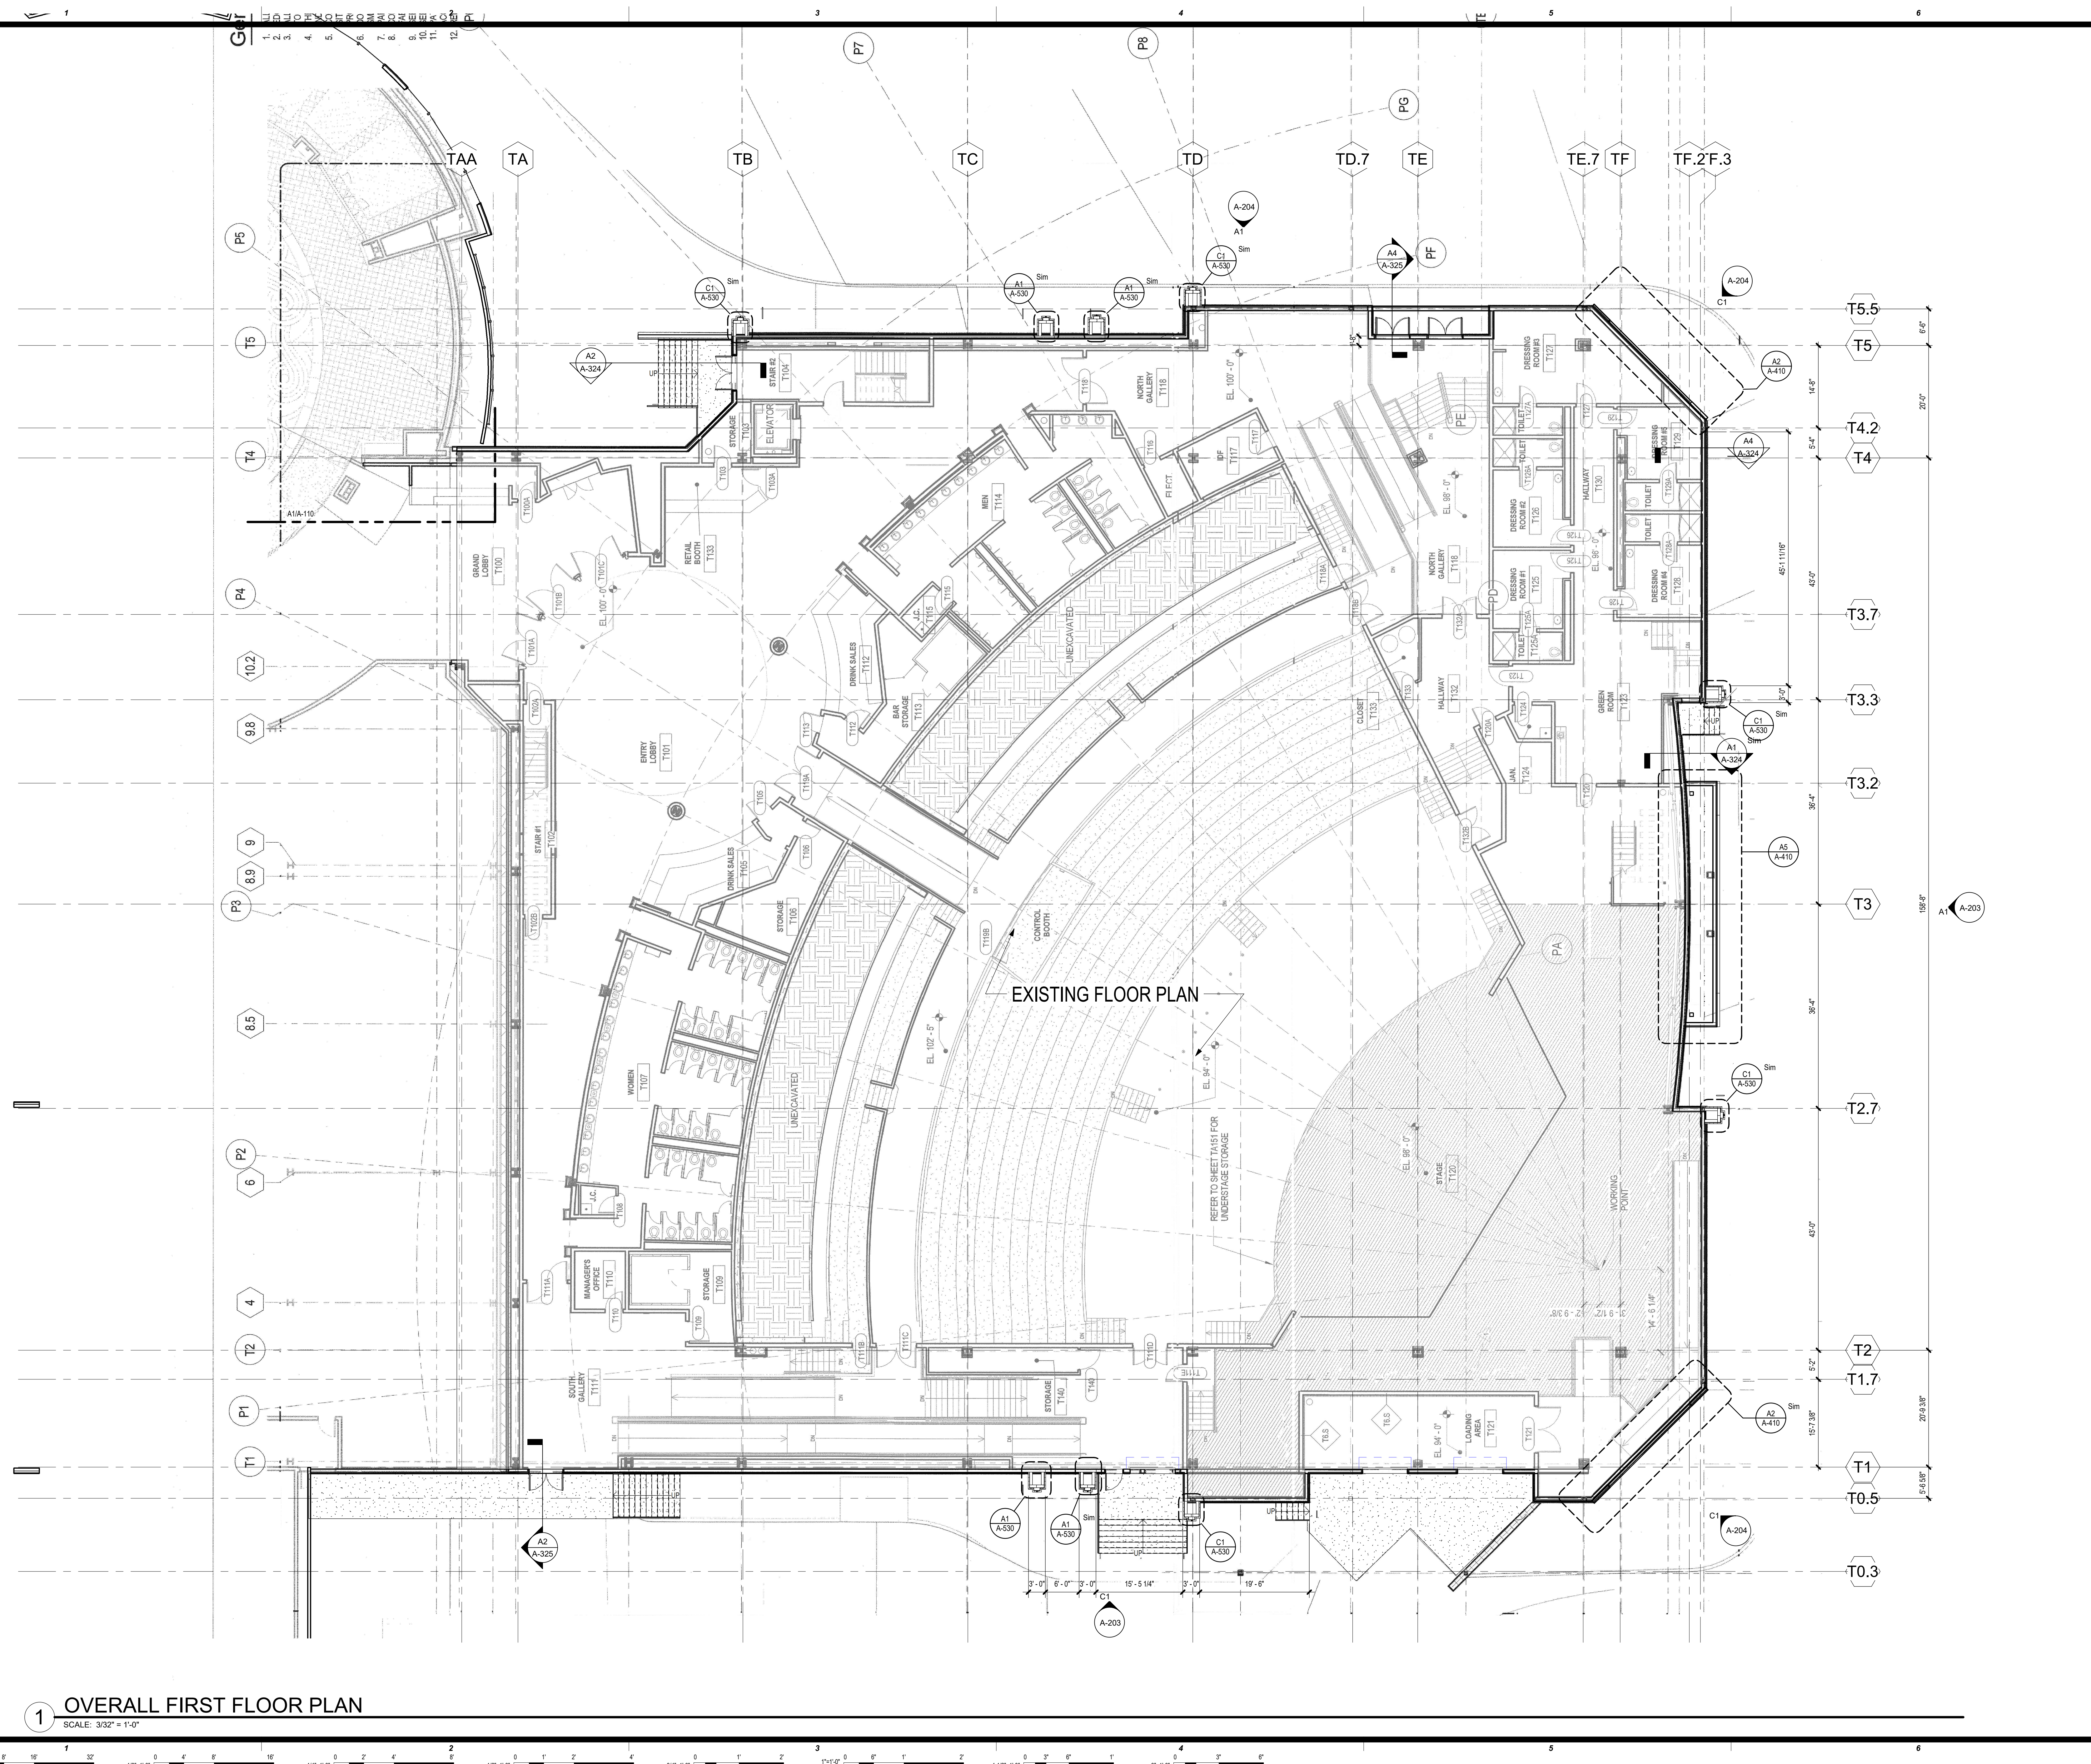
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716-845-5092




EXTERIOR FACADE RENOVATION

KEY PLAN
⊕

No.	Description	Date

CONSTRUCTION SET

PROJECT NO: H17018.01
DRAWN BY: AMD
CHECKED BY: GEF
ISSUE DATE: 12/21/2018

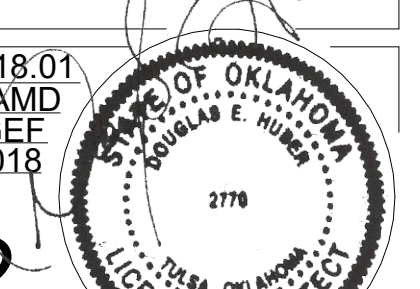

A-112
Scale: 3/32" = 1'-0"
12/21/2018

1 OVERALL FIRST FLOOR PLAN
SCALE: 3/32" = 1'-0"

12/21/2018 2:56:03 PM

A B C D E





EDMONDSON REED & ASSOCIATES
A NATIVE AMERICAN OWNED DESIGN FIRM

EDMONDSON REED & ASSOCIATES
1401 S. Danner Ave., Suite B
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Tel: (918) 894-6003
Fax: (877) 276-1242

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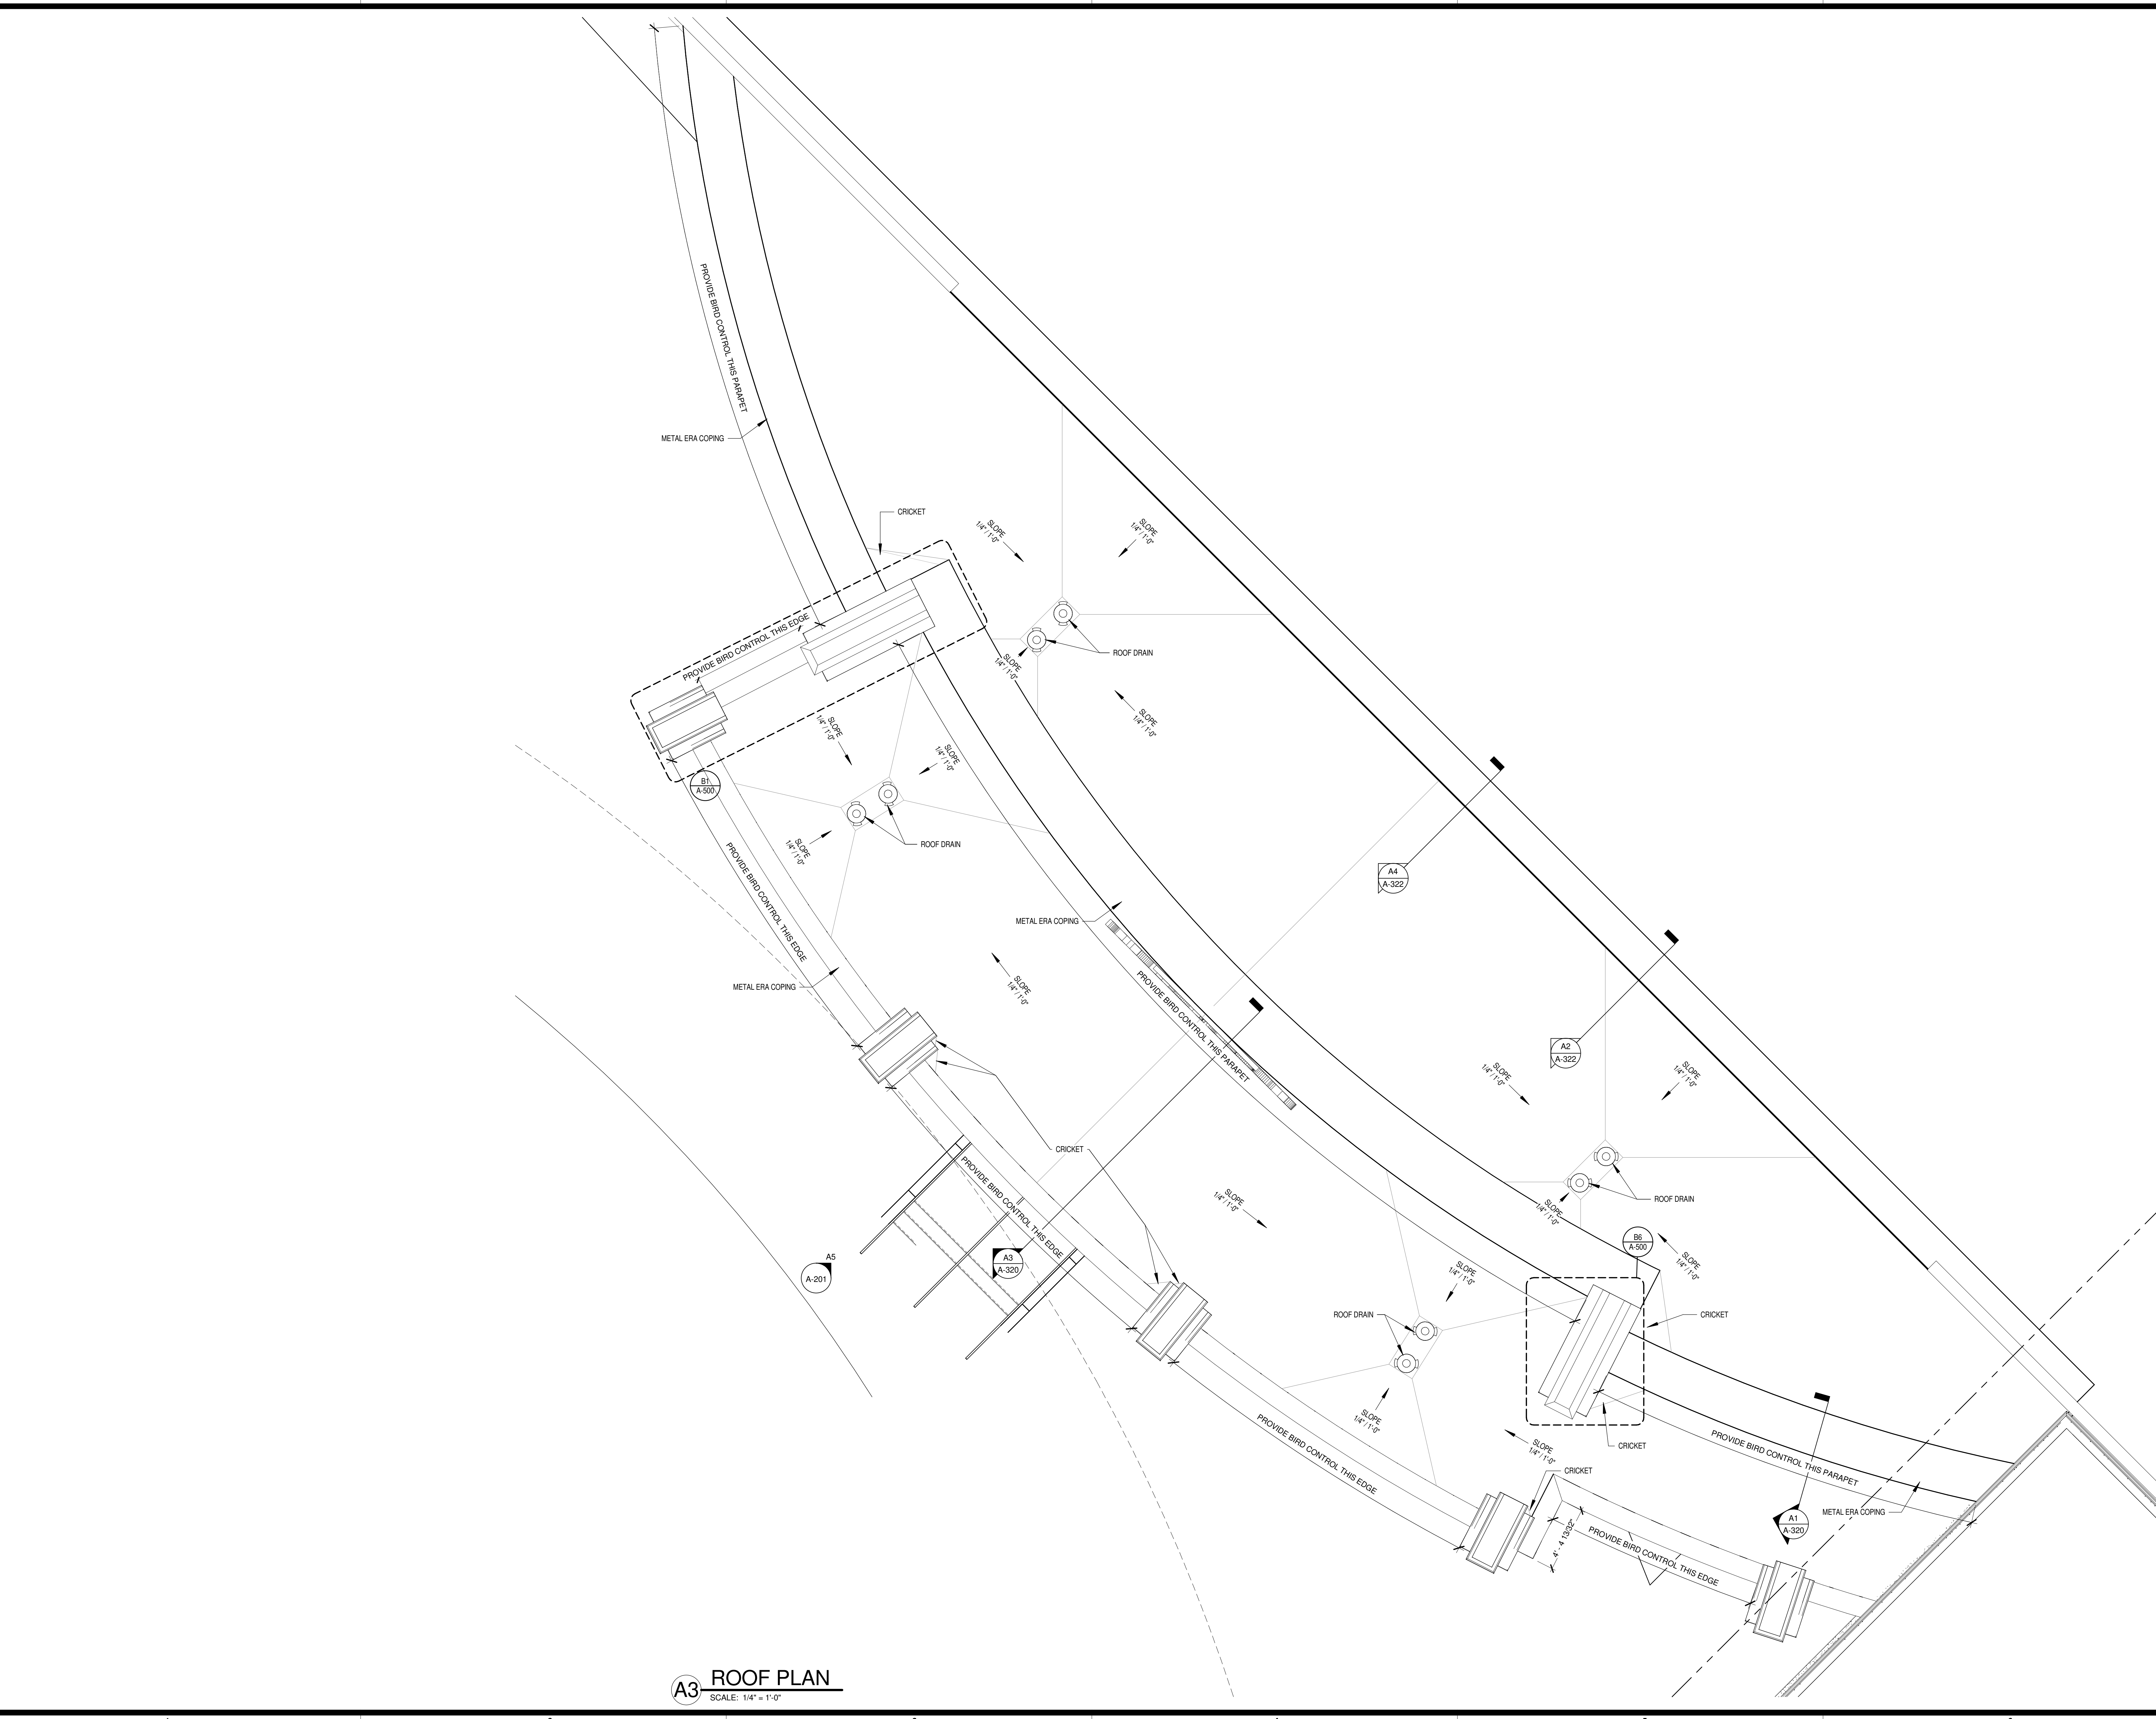
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Cherokee Hard Rock Hotel & Casino



A3 ROOF PLAN
SCALE: 1/4" = 1'-0"

EXTERIOR FACADE RENOVATION




No.	Description	Date

KEY PLAN
ROOF PLAN


CONSTRUCTION SET

PROJECT NO: H17018
DRAWN BY: SB
CHK'D BY: DH
ISSUE DATE: 12/21/2018

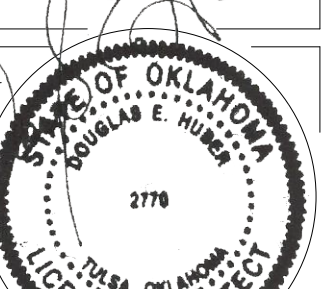

A-130
Scale: 1/4" = 1'-0"
12/21/2018

12/21/2018 3:55:57 PM

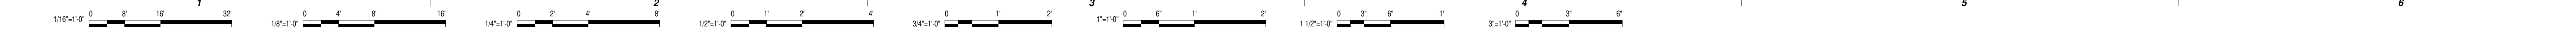

EIFS LEGEND		
NUMBER	NAME	TEXTURE
EIFS-1	DRYKIT 454A - STONE GRAY 30% DARKER	SAND FINE
EIFS-2	SW 9165 - GOSSAMER VEIL	SMOOTH
EIFS-3	SW 8143 - BASKET BEIGE	SMOOTH
EIFS-4	SW 7675 - SEALSKIN	SAND FINE



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EDMONDSON REED & ASSOCIATES
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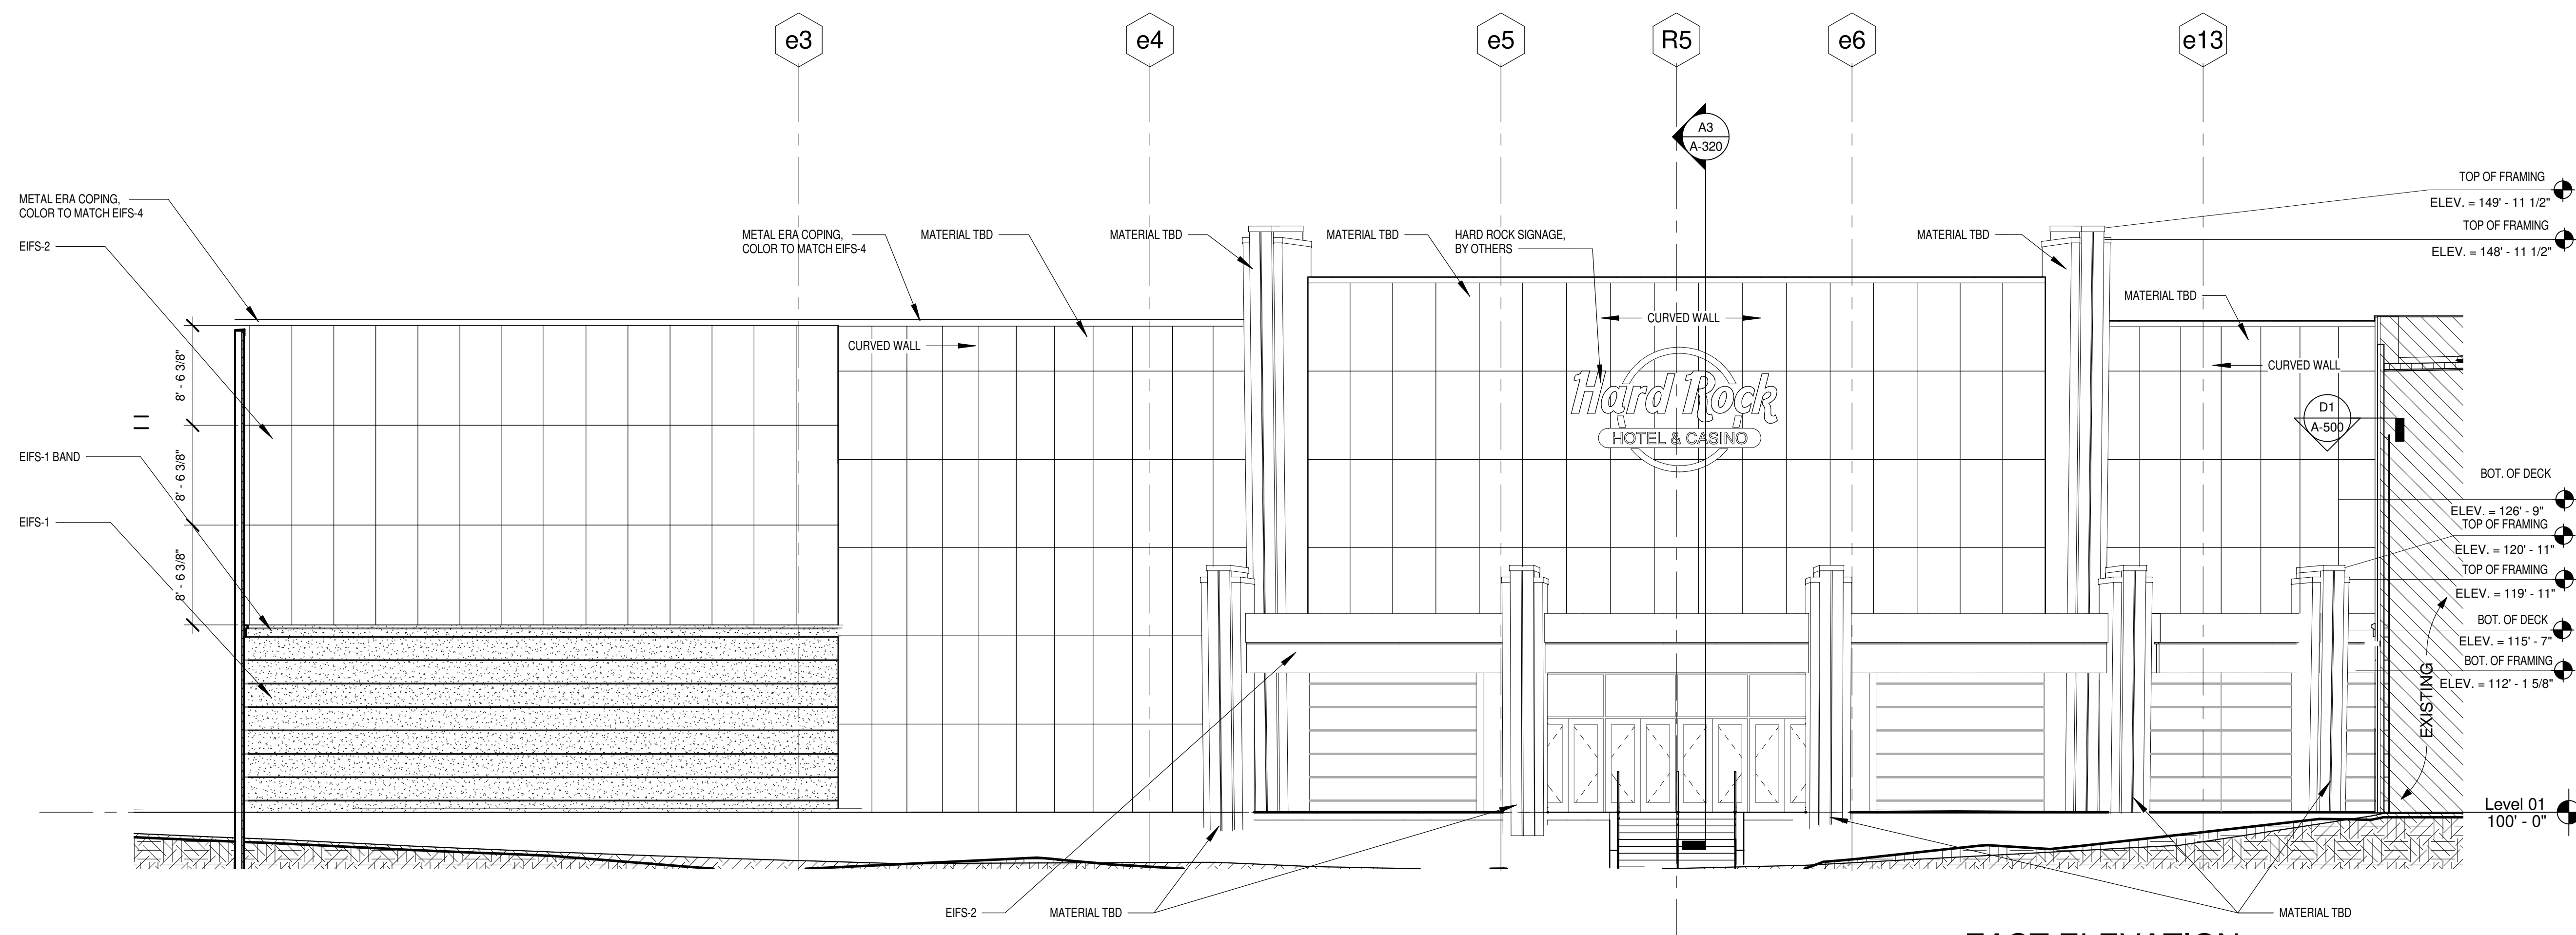
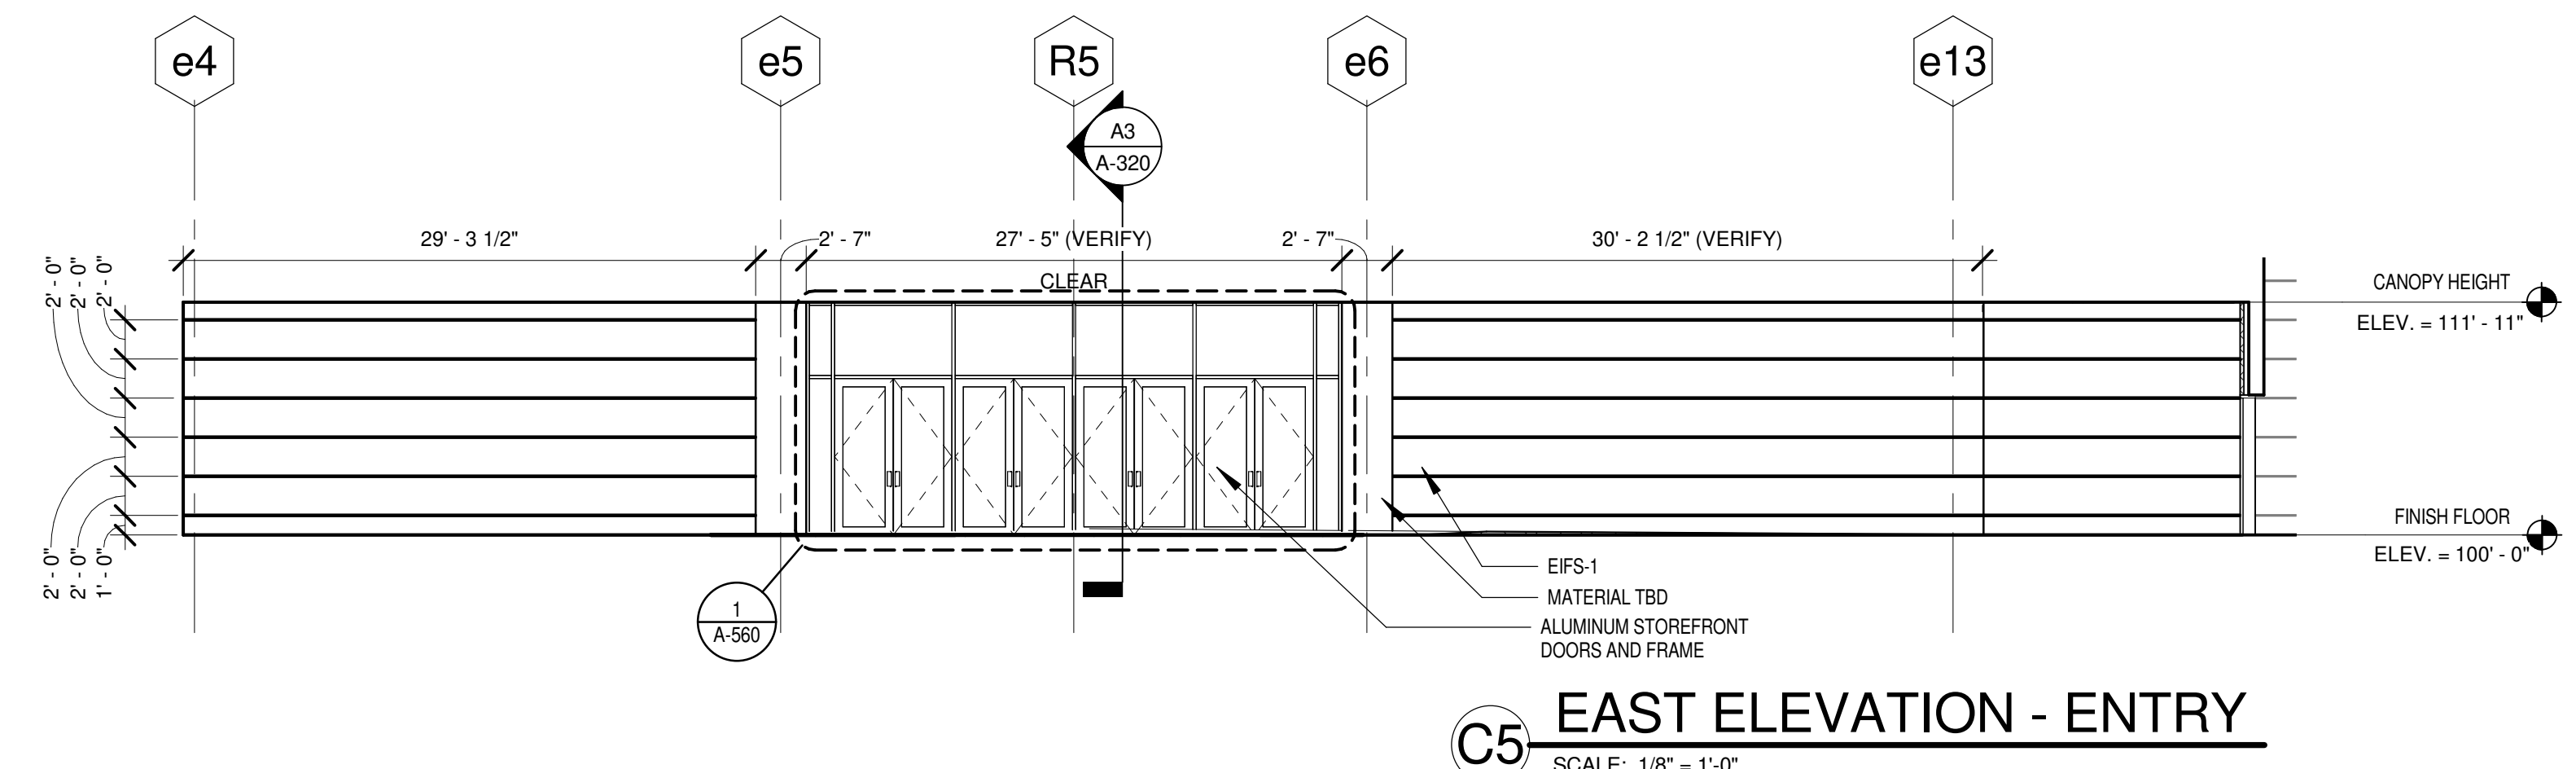
MSA Engineering Consultants
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EXTERIOR FACADE RENOVATION

KEY PLAN

No.	Description	Date

EXTERIOR ELEVATIONS

CONSTRUCTION SET

PROJECT NO: H17018
DRAWN BY: BJB
CHECKED BY: DH
ISSUE DATE: 12/21/2018

A-201
Scale: As indicated

EIFS LEGEND		
NUMBER	NAME	TEXTURE
EIFS-1	DRYKIT 454A - STONE GRAY 30% DARKER	SAND FINE
EIFS-2	SW 9165 - GOSSAMER VEIL	SMOOTH
EIFS-3	SW 8143 - BASKET BEIGE	SMOOTH
EIFS-4	SW 7675 - SEALSKIN	SAND FINE

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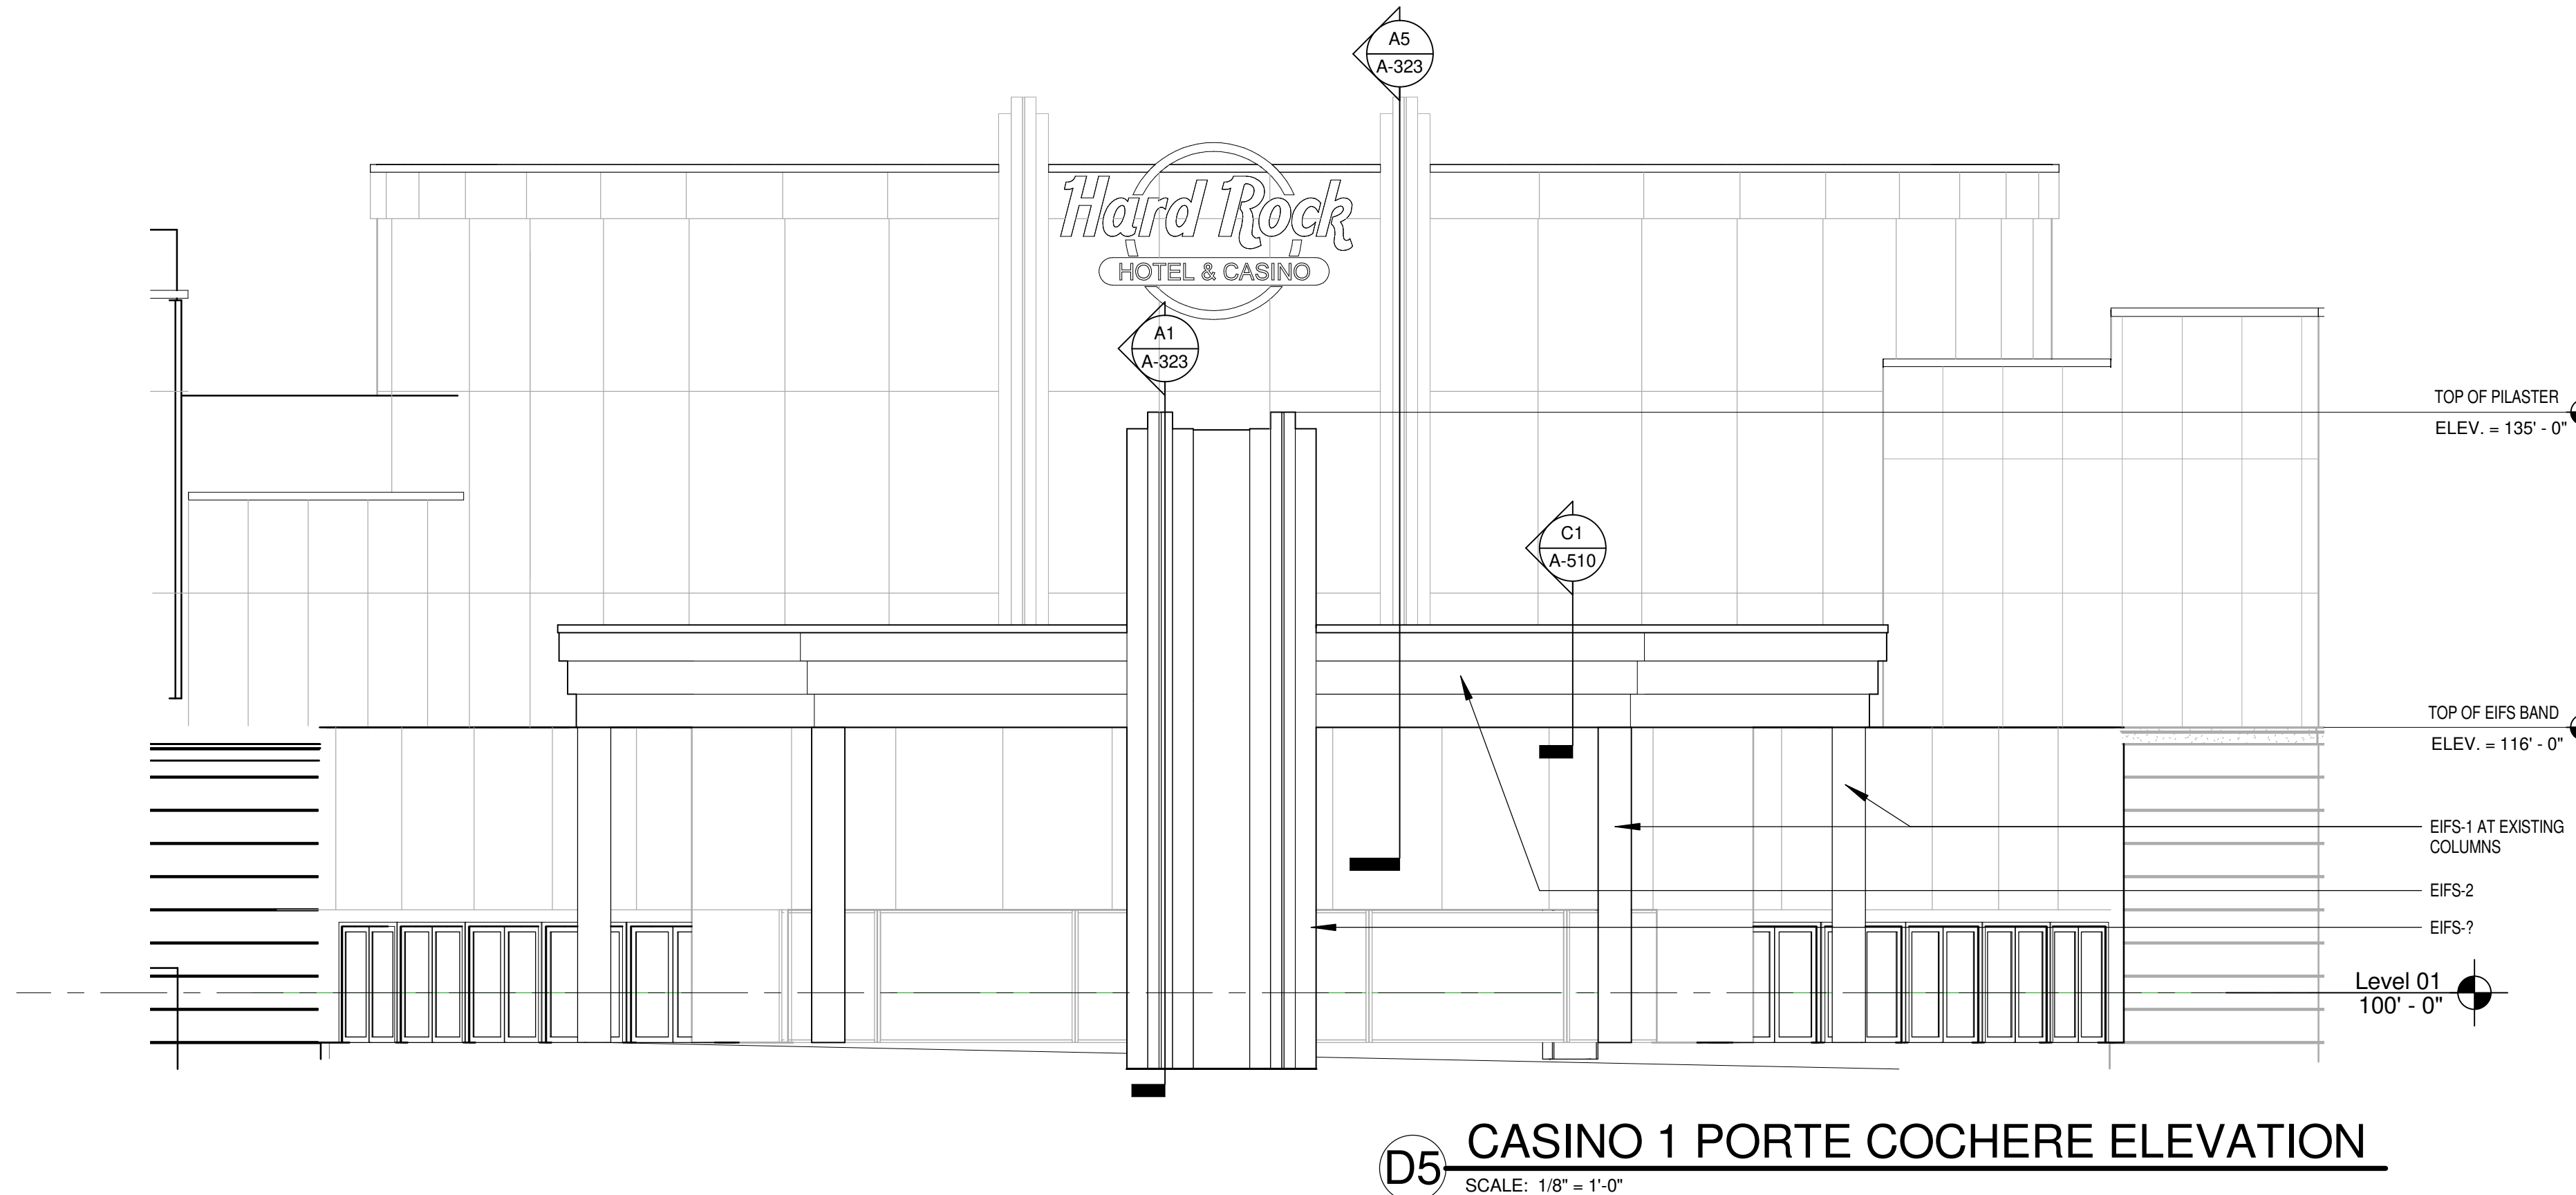
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505-344-4080


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702-896-1100

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Tulsa, OK 74146
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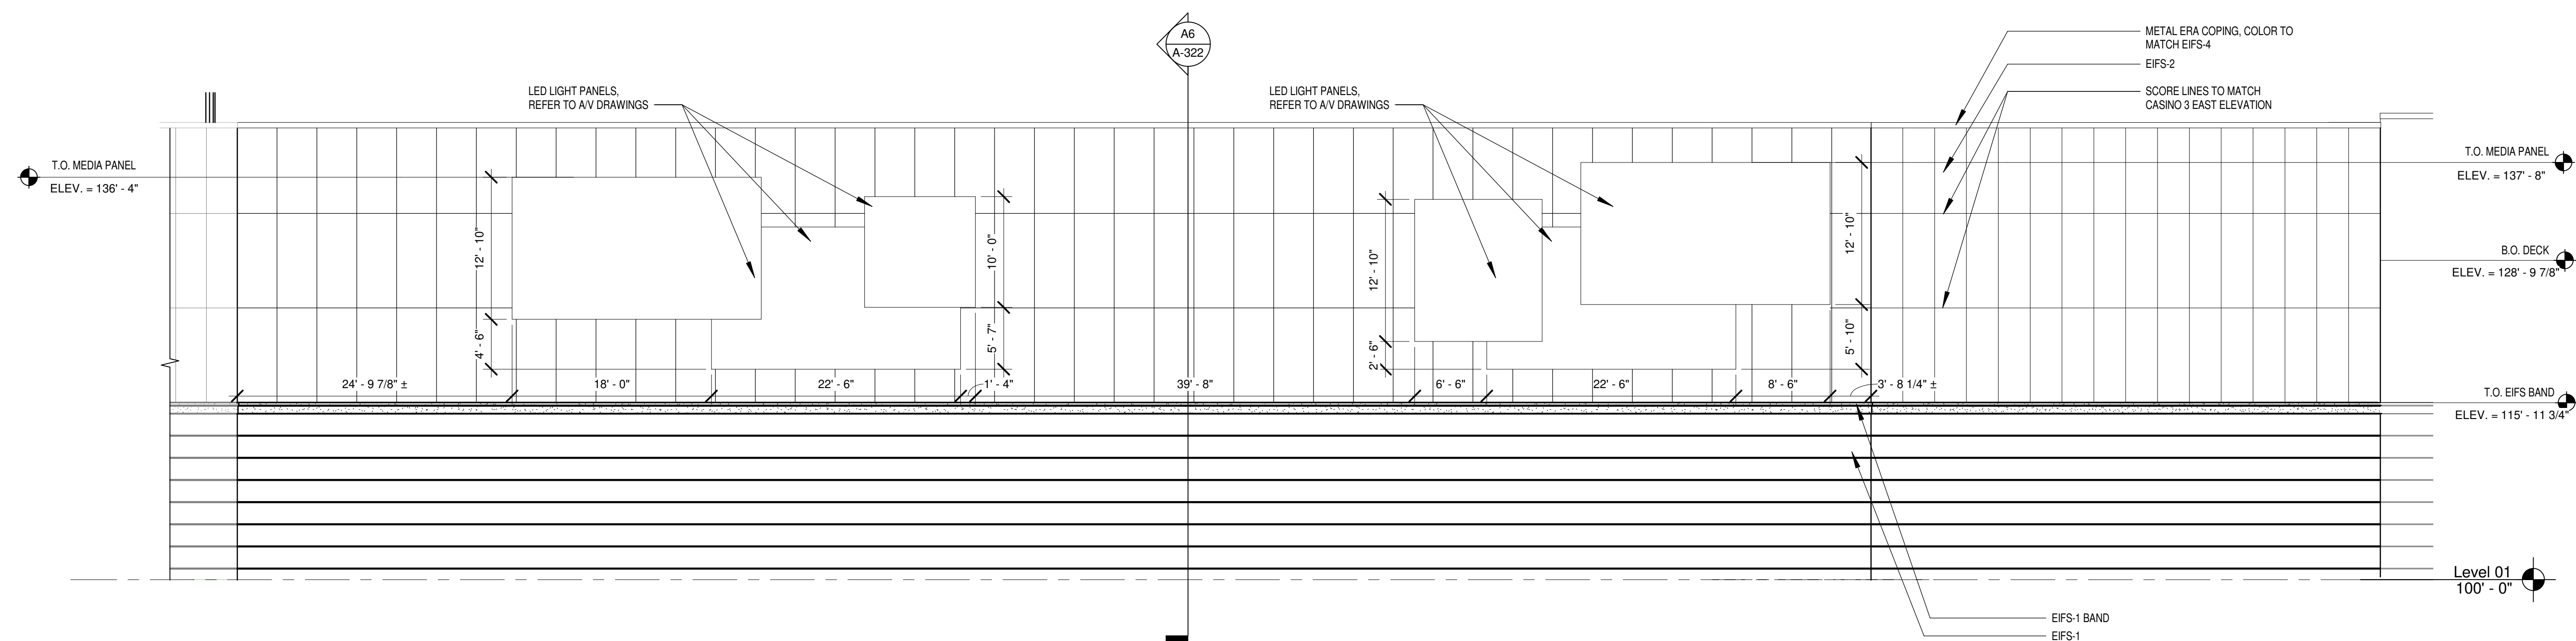
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716-845-5092



D5 CASINO 1 PORTE COCHERE ELEVATION
SCALE: 1/8" = 1'-0"

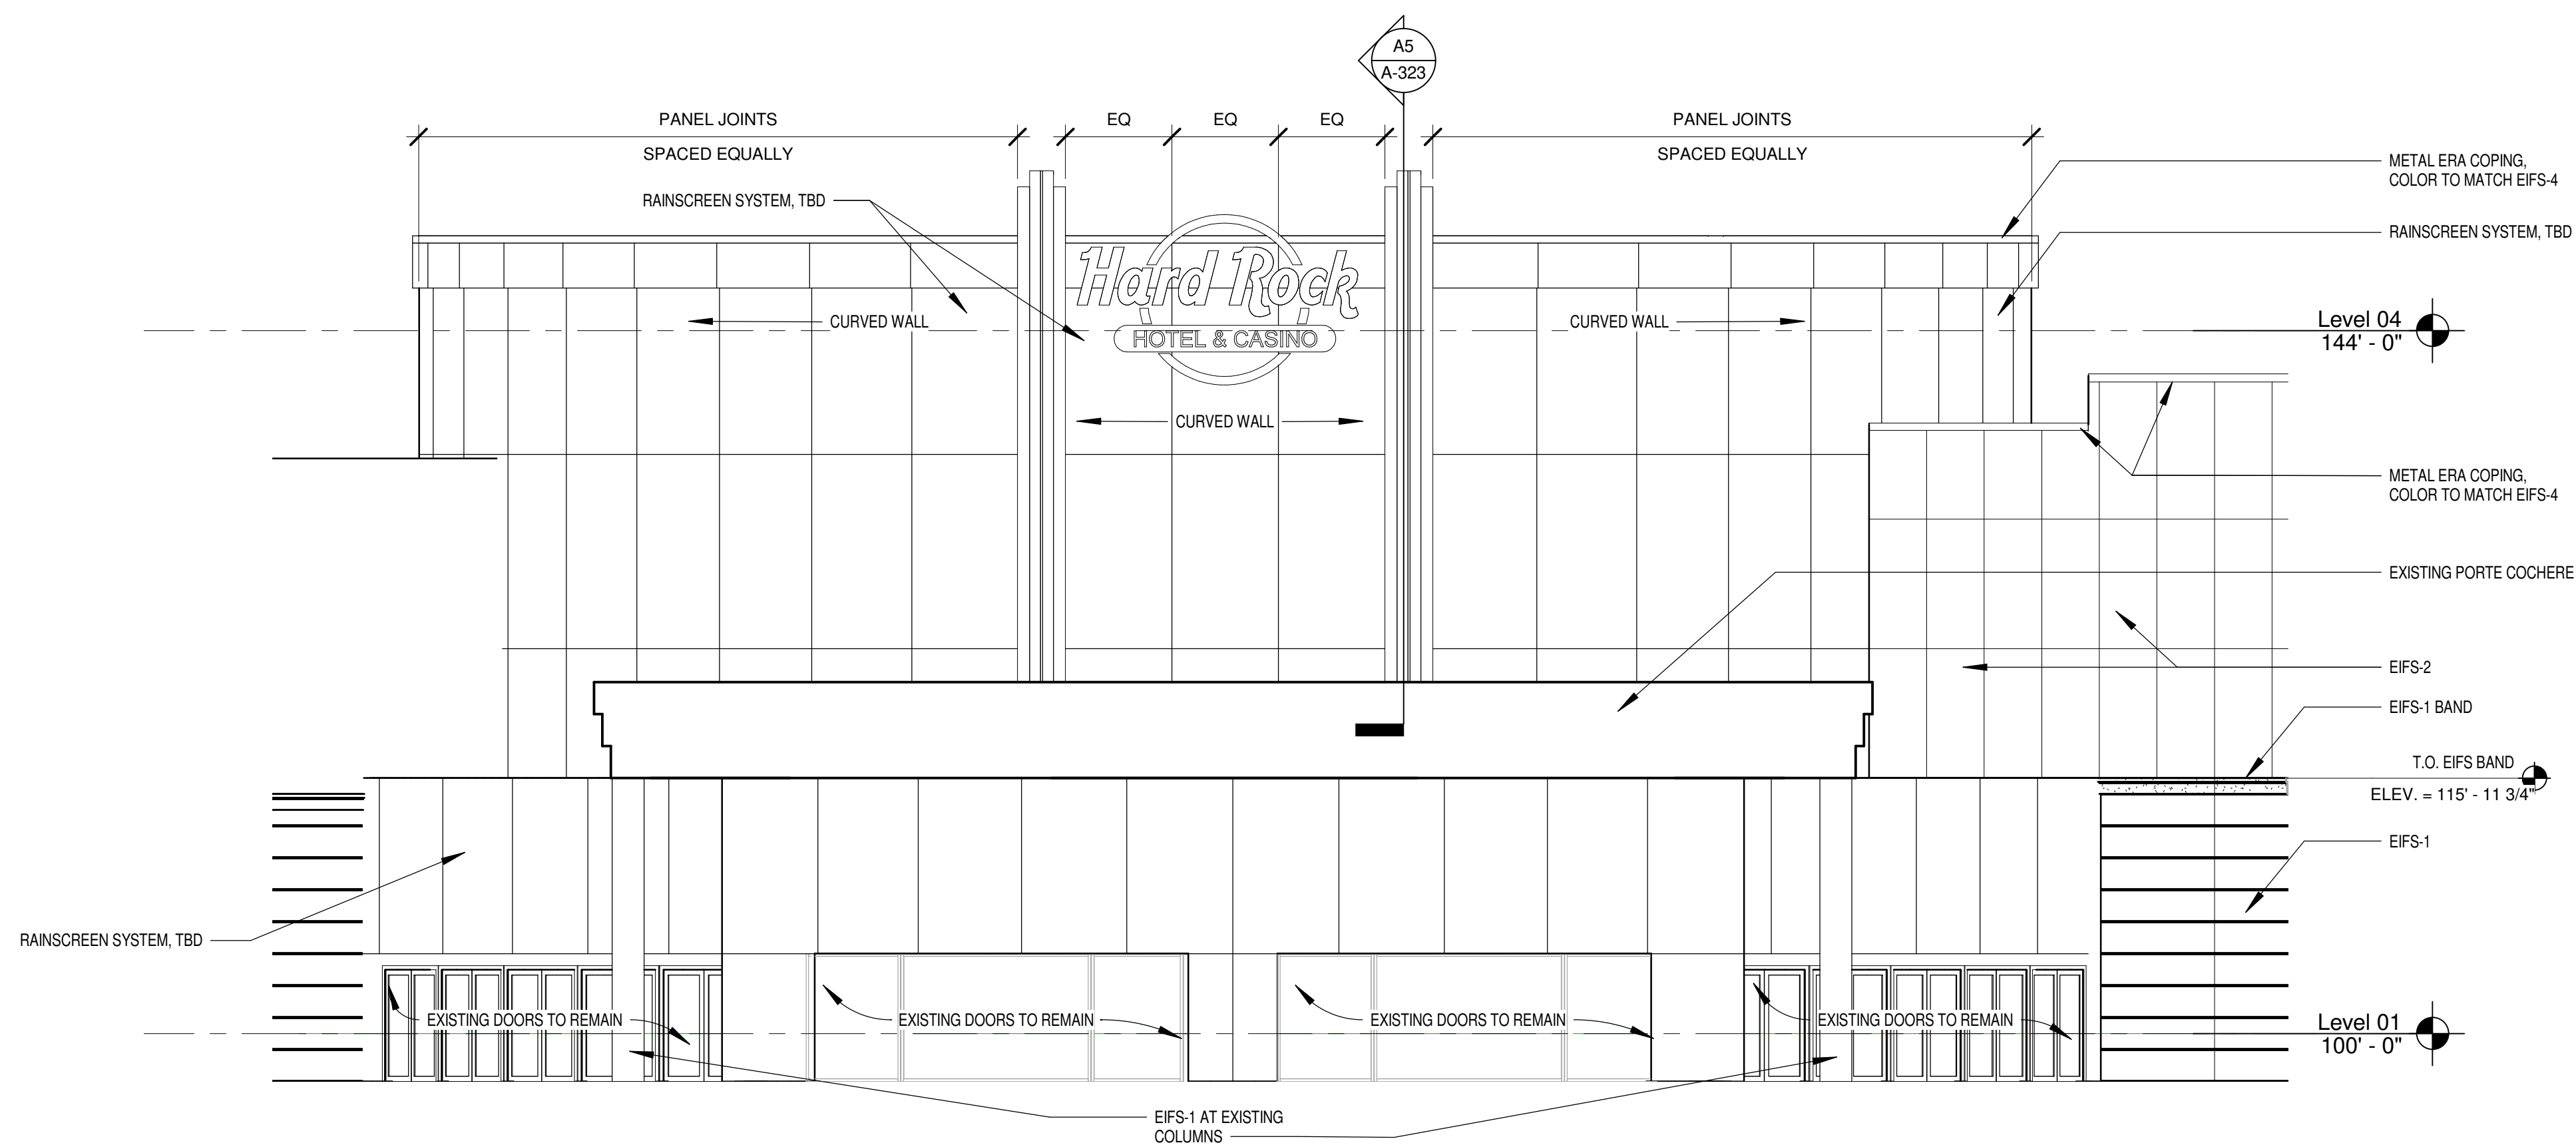

B5 CASINO 1 ROTUNDA ELEVATION
SCALE: 1/8" = 1'-0"



A5 CASINO 2 EAST ELEVATION
SCALE: 1/8" = 1'-0"

EXTERIOR FACADE RENOVATION

KEY PLAN




No.	Description	Date

EXTERIOR ELEVATIONS

CONSTRUCTION SET

PROJECT NO: H17018
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ISSUE DATE: 12/21/2018

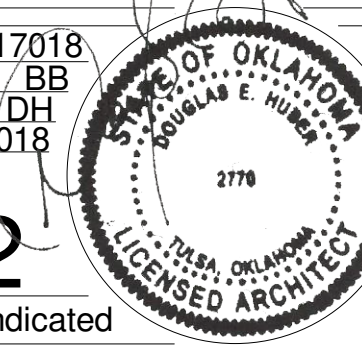

A-202
Scale As indicated

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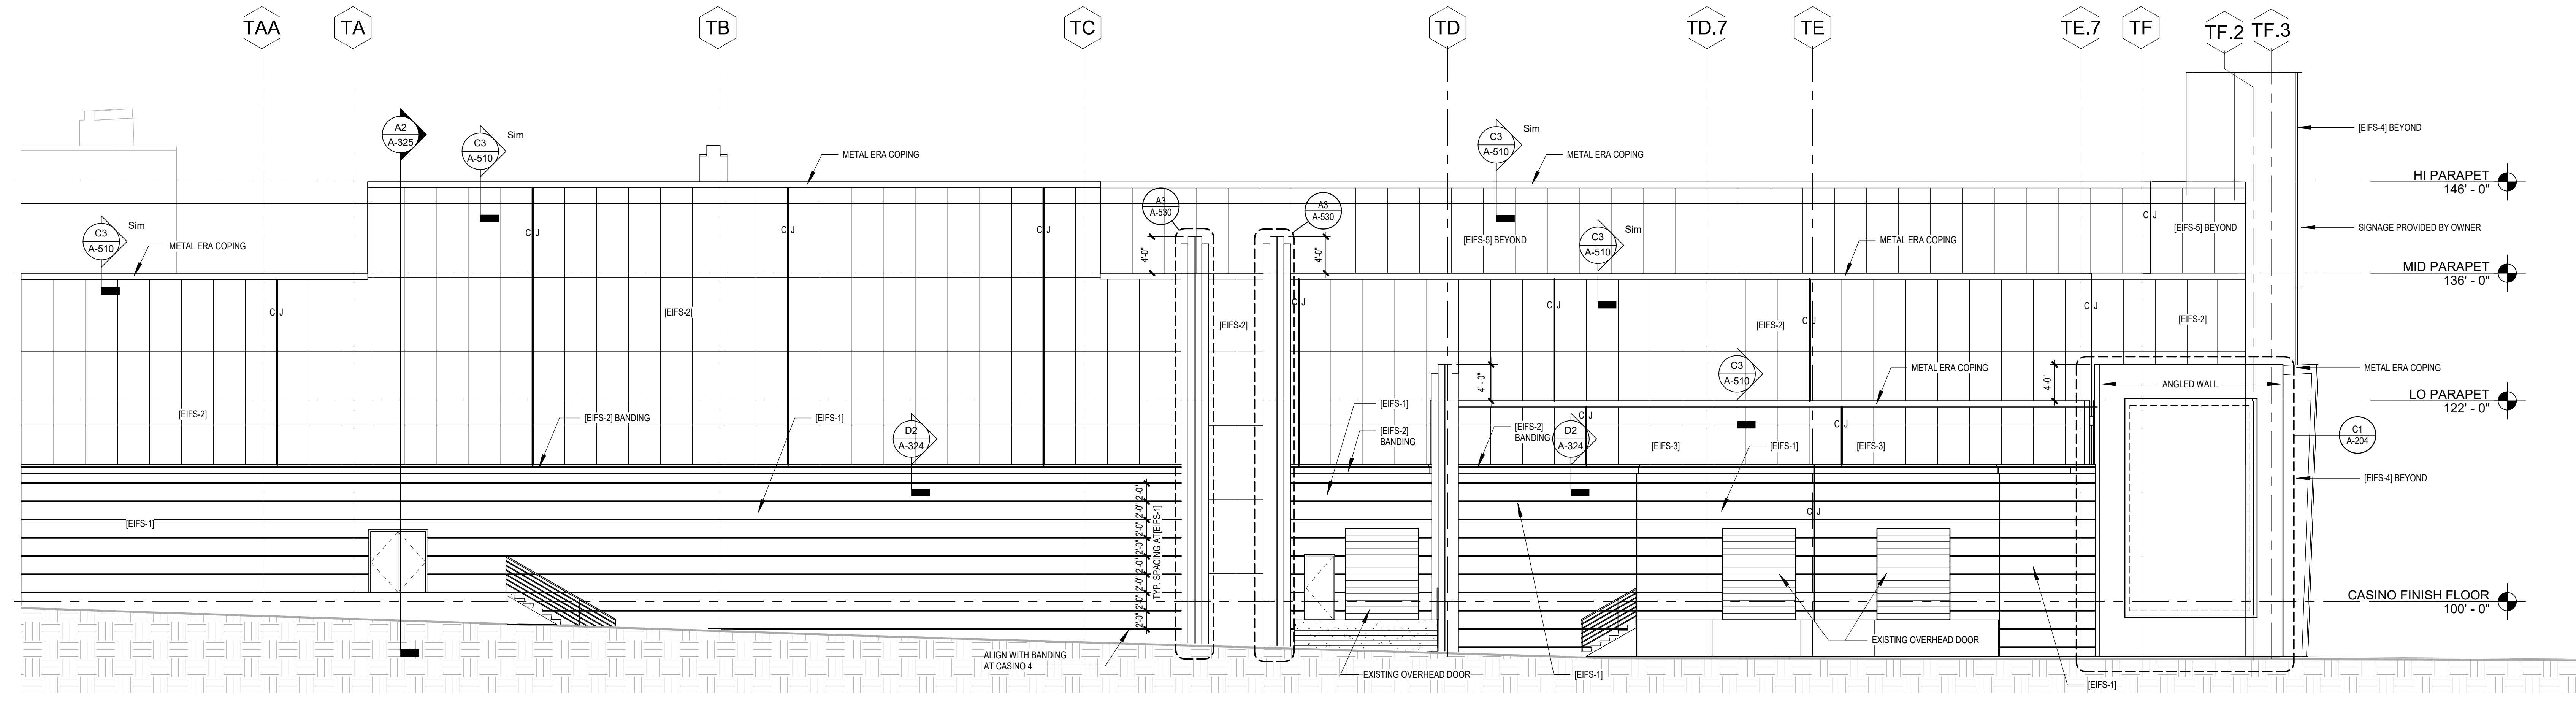
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Chavez-Greaves Consulting Engineers, Inc.
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Albuquerque, NM 87109
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MSA Engineering Consultants
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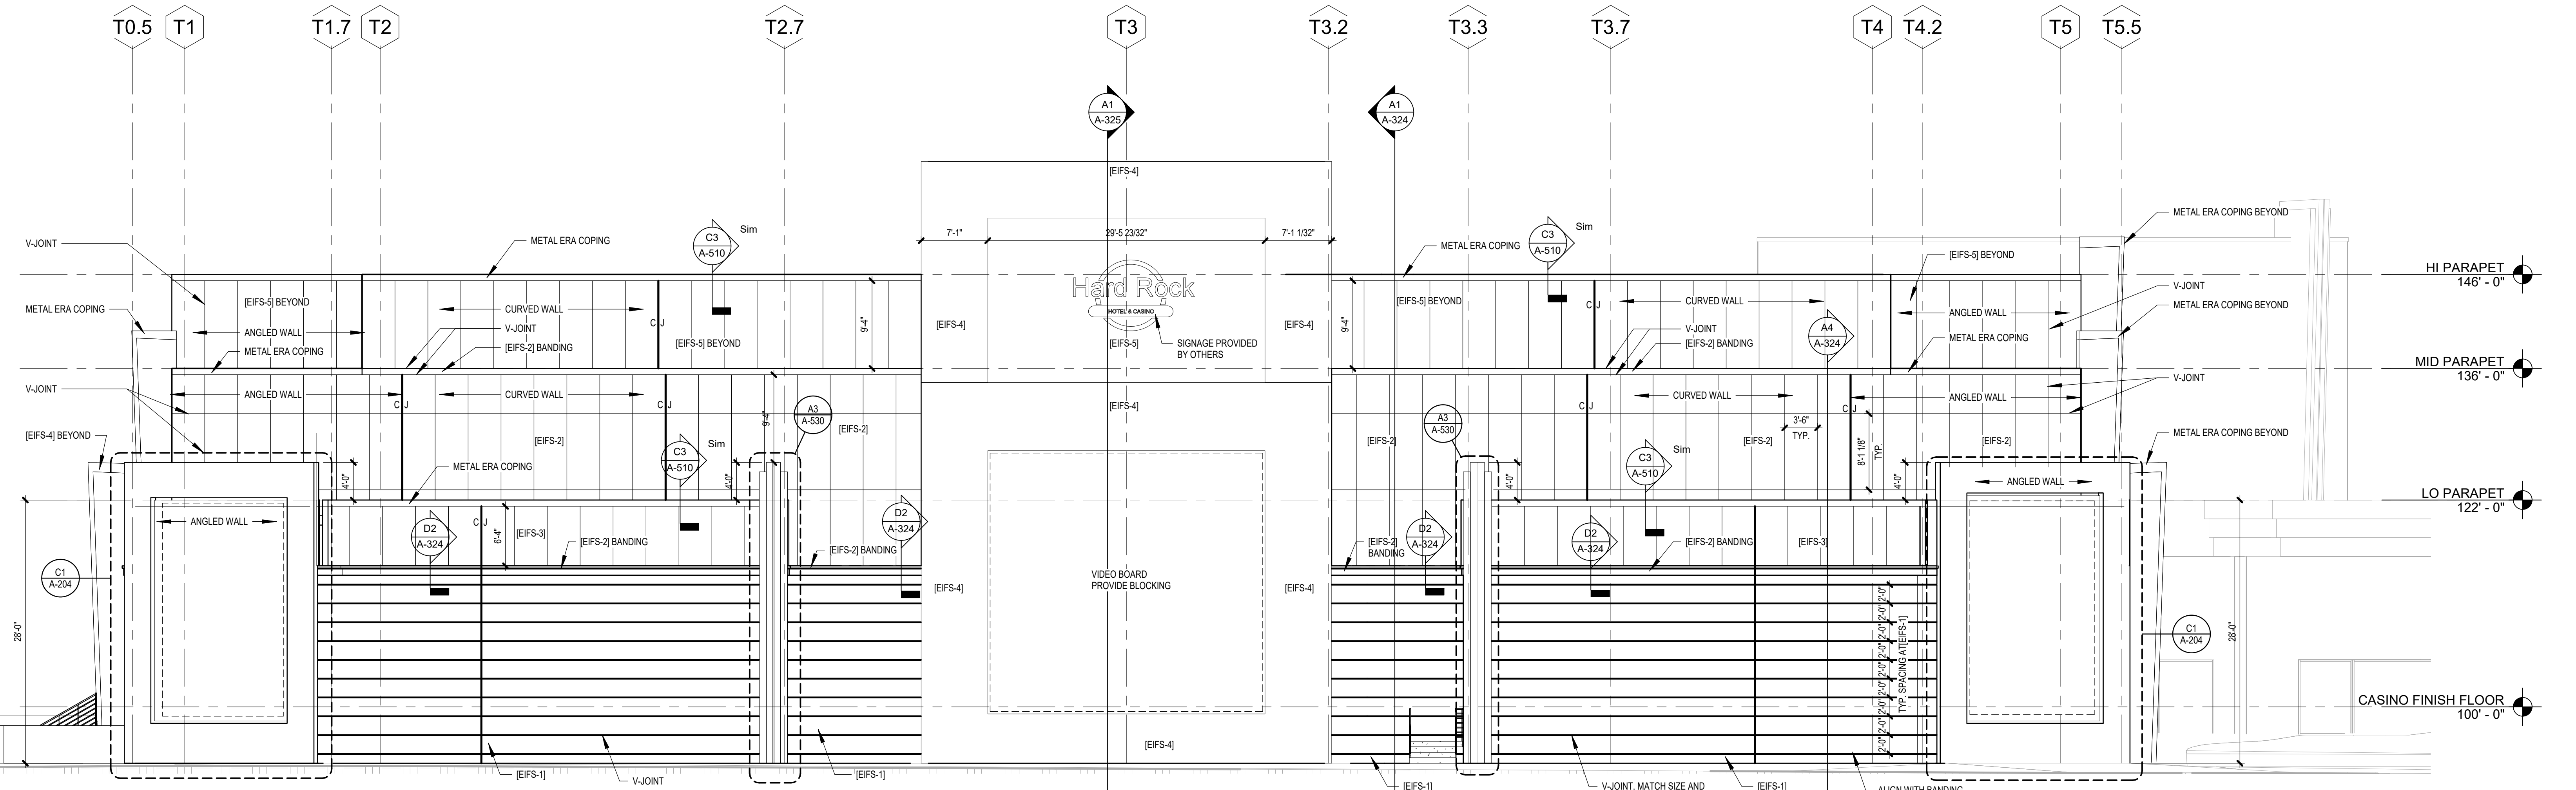
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EIFS LEGEND		
NUMBER	NAME	TEXTURE
EIFS-1	DRYWIT 454A - STONE GRAY 30% DARKER	SAND FINE
EIFS-2	SW 9165 - GOSSAMER VEL	SMOOTH
EIFS-3	SW 6143 - BASKET BEIGE	SMOOTH
EIFS-4	SW 7075 - SEAL 300N	SAND FINE
EIFS-5	SW 6537 - LUXE BLUE	SMOOTH



C1 SOUTH ELEVATION
1/8" = 1'-0"



A1 EAST ELEVATION
1/8" = 1'-0"

EXTERIOR FACADE RENOVATION

KEY PLAN




No.	Description	Date

SHEET TITLE: EXTERIOR ELEVATIONS

PROGRESS SET

PROJECT NO: H17018.01
DRAWN BY: AMD
CHECKED BY: GEF
ISSUE DATE: 10/26/2018

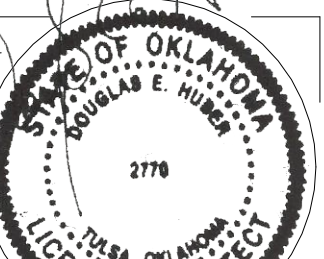

A-203

Scale: 1/8" = 1'-0"

EIFS LEGEND		
NUMBER	NAME	TEXTURE
EIFS-1	DRYVIT 454A - STONE GRAY 30% DARKER	SAND FINE
EIFS-2	SW 9165 - GOSSAMER VEL	SMOOTH
EIFS-3	SW 6143 - BASKET BEIGE	SMOOTH
EIFS-4	SW 7075 - SEAL 3009	SAND FINE
EIFS-5	SW 6537 - LUXE BLUE	SMOOTH

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Cherokee Hard Rock Hotel & Casino

EXTERIOR FACADE RENOVATION

KEY PLAN



No.	Description	Date

SHEET TITLE
EXTERIOR ELEVATIONS

PROGRESS SET


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DRAWN BY: AMD
CHECKED BY: GEF
ISSUE DATE: 10/26/2018

A-204


Scale 1/8" = 1'-0"



12/21/2018

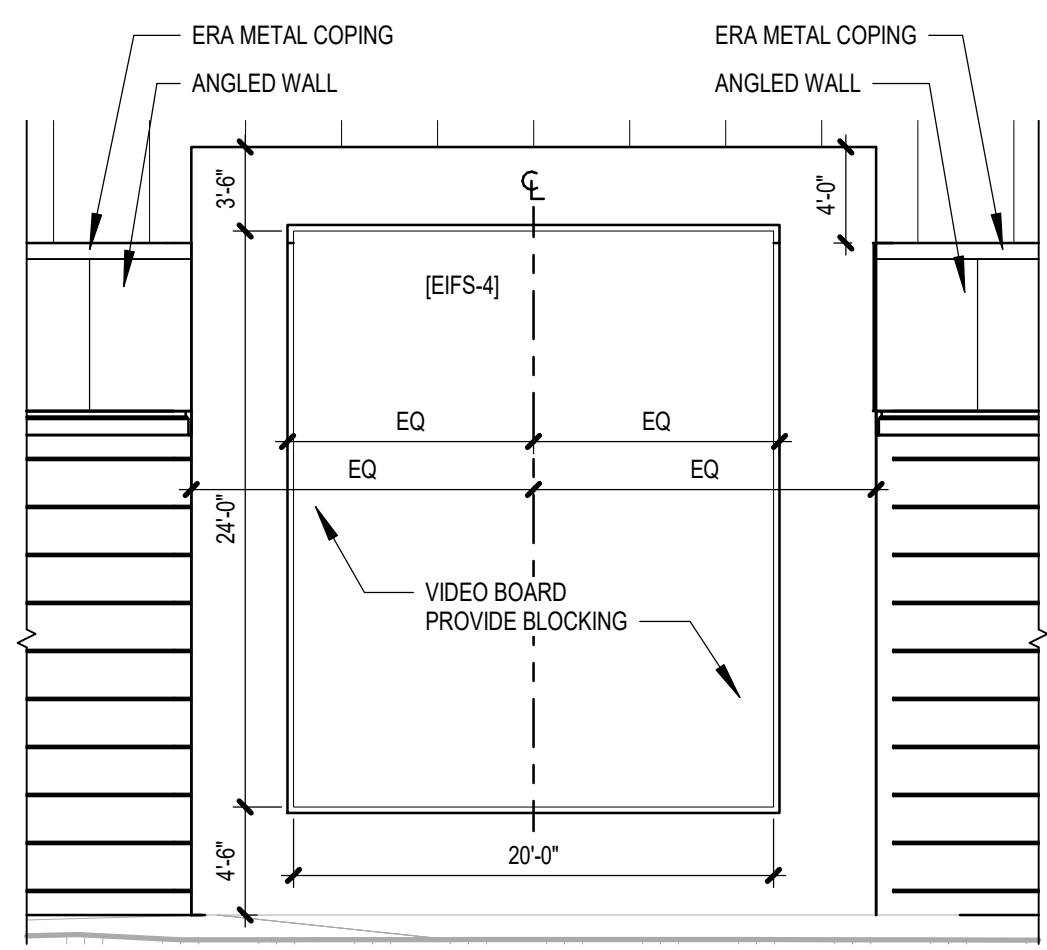

C1 NORTHEAST/SOUTHEAST ELEVATION
1/8" = 1'-0"

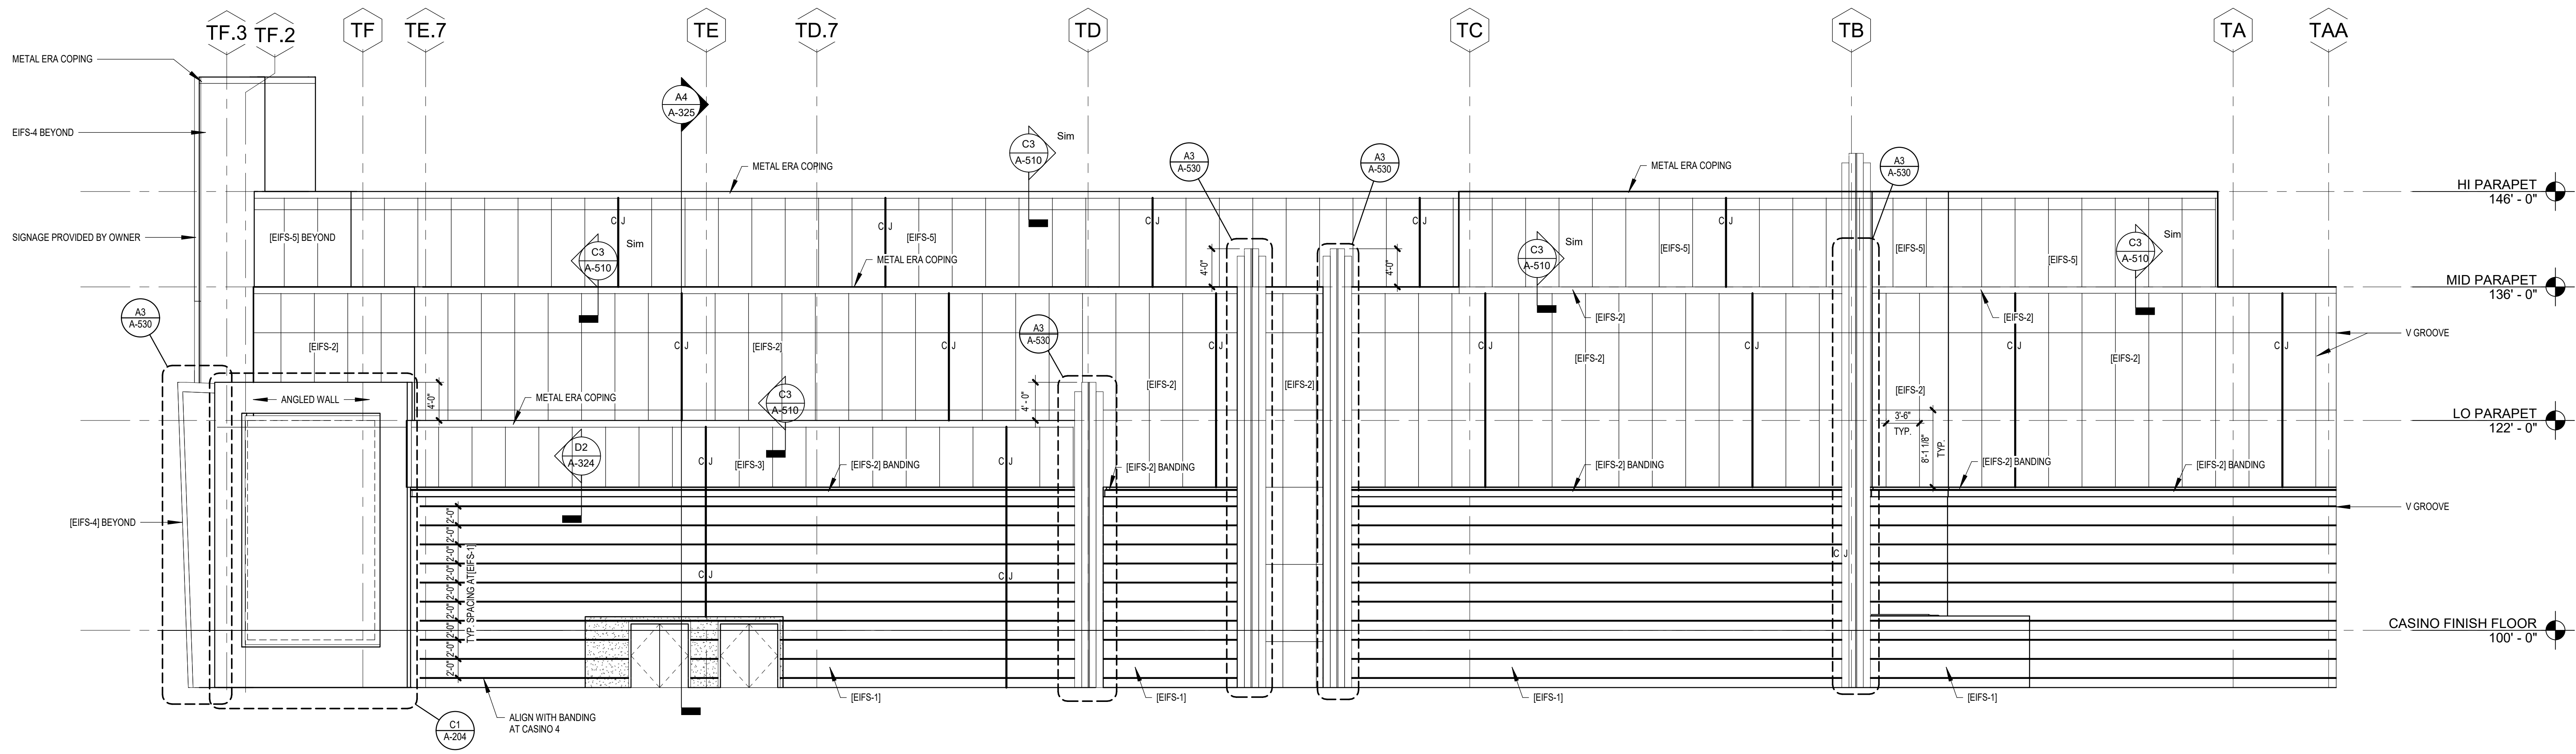

A1 NORTH ELEVATION
1/8" = 1'-0"



12/21/2018

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EXTERIOR FACADE RENOVATION

KEY PLAN




No.	Description	Date

WALL SECTIONS


CONSTRUCTION SET

PROJECT NO. H17018
DRAWN BY: BB
CHECKED BY: DH
ISSUE DATE: 12/21/2018

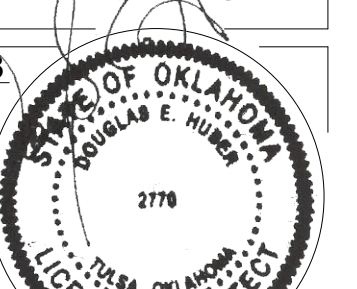

A-321

Scale: 1/2" = 1'-0"

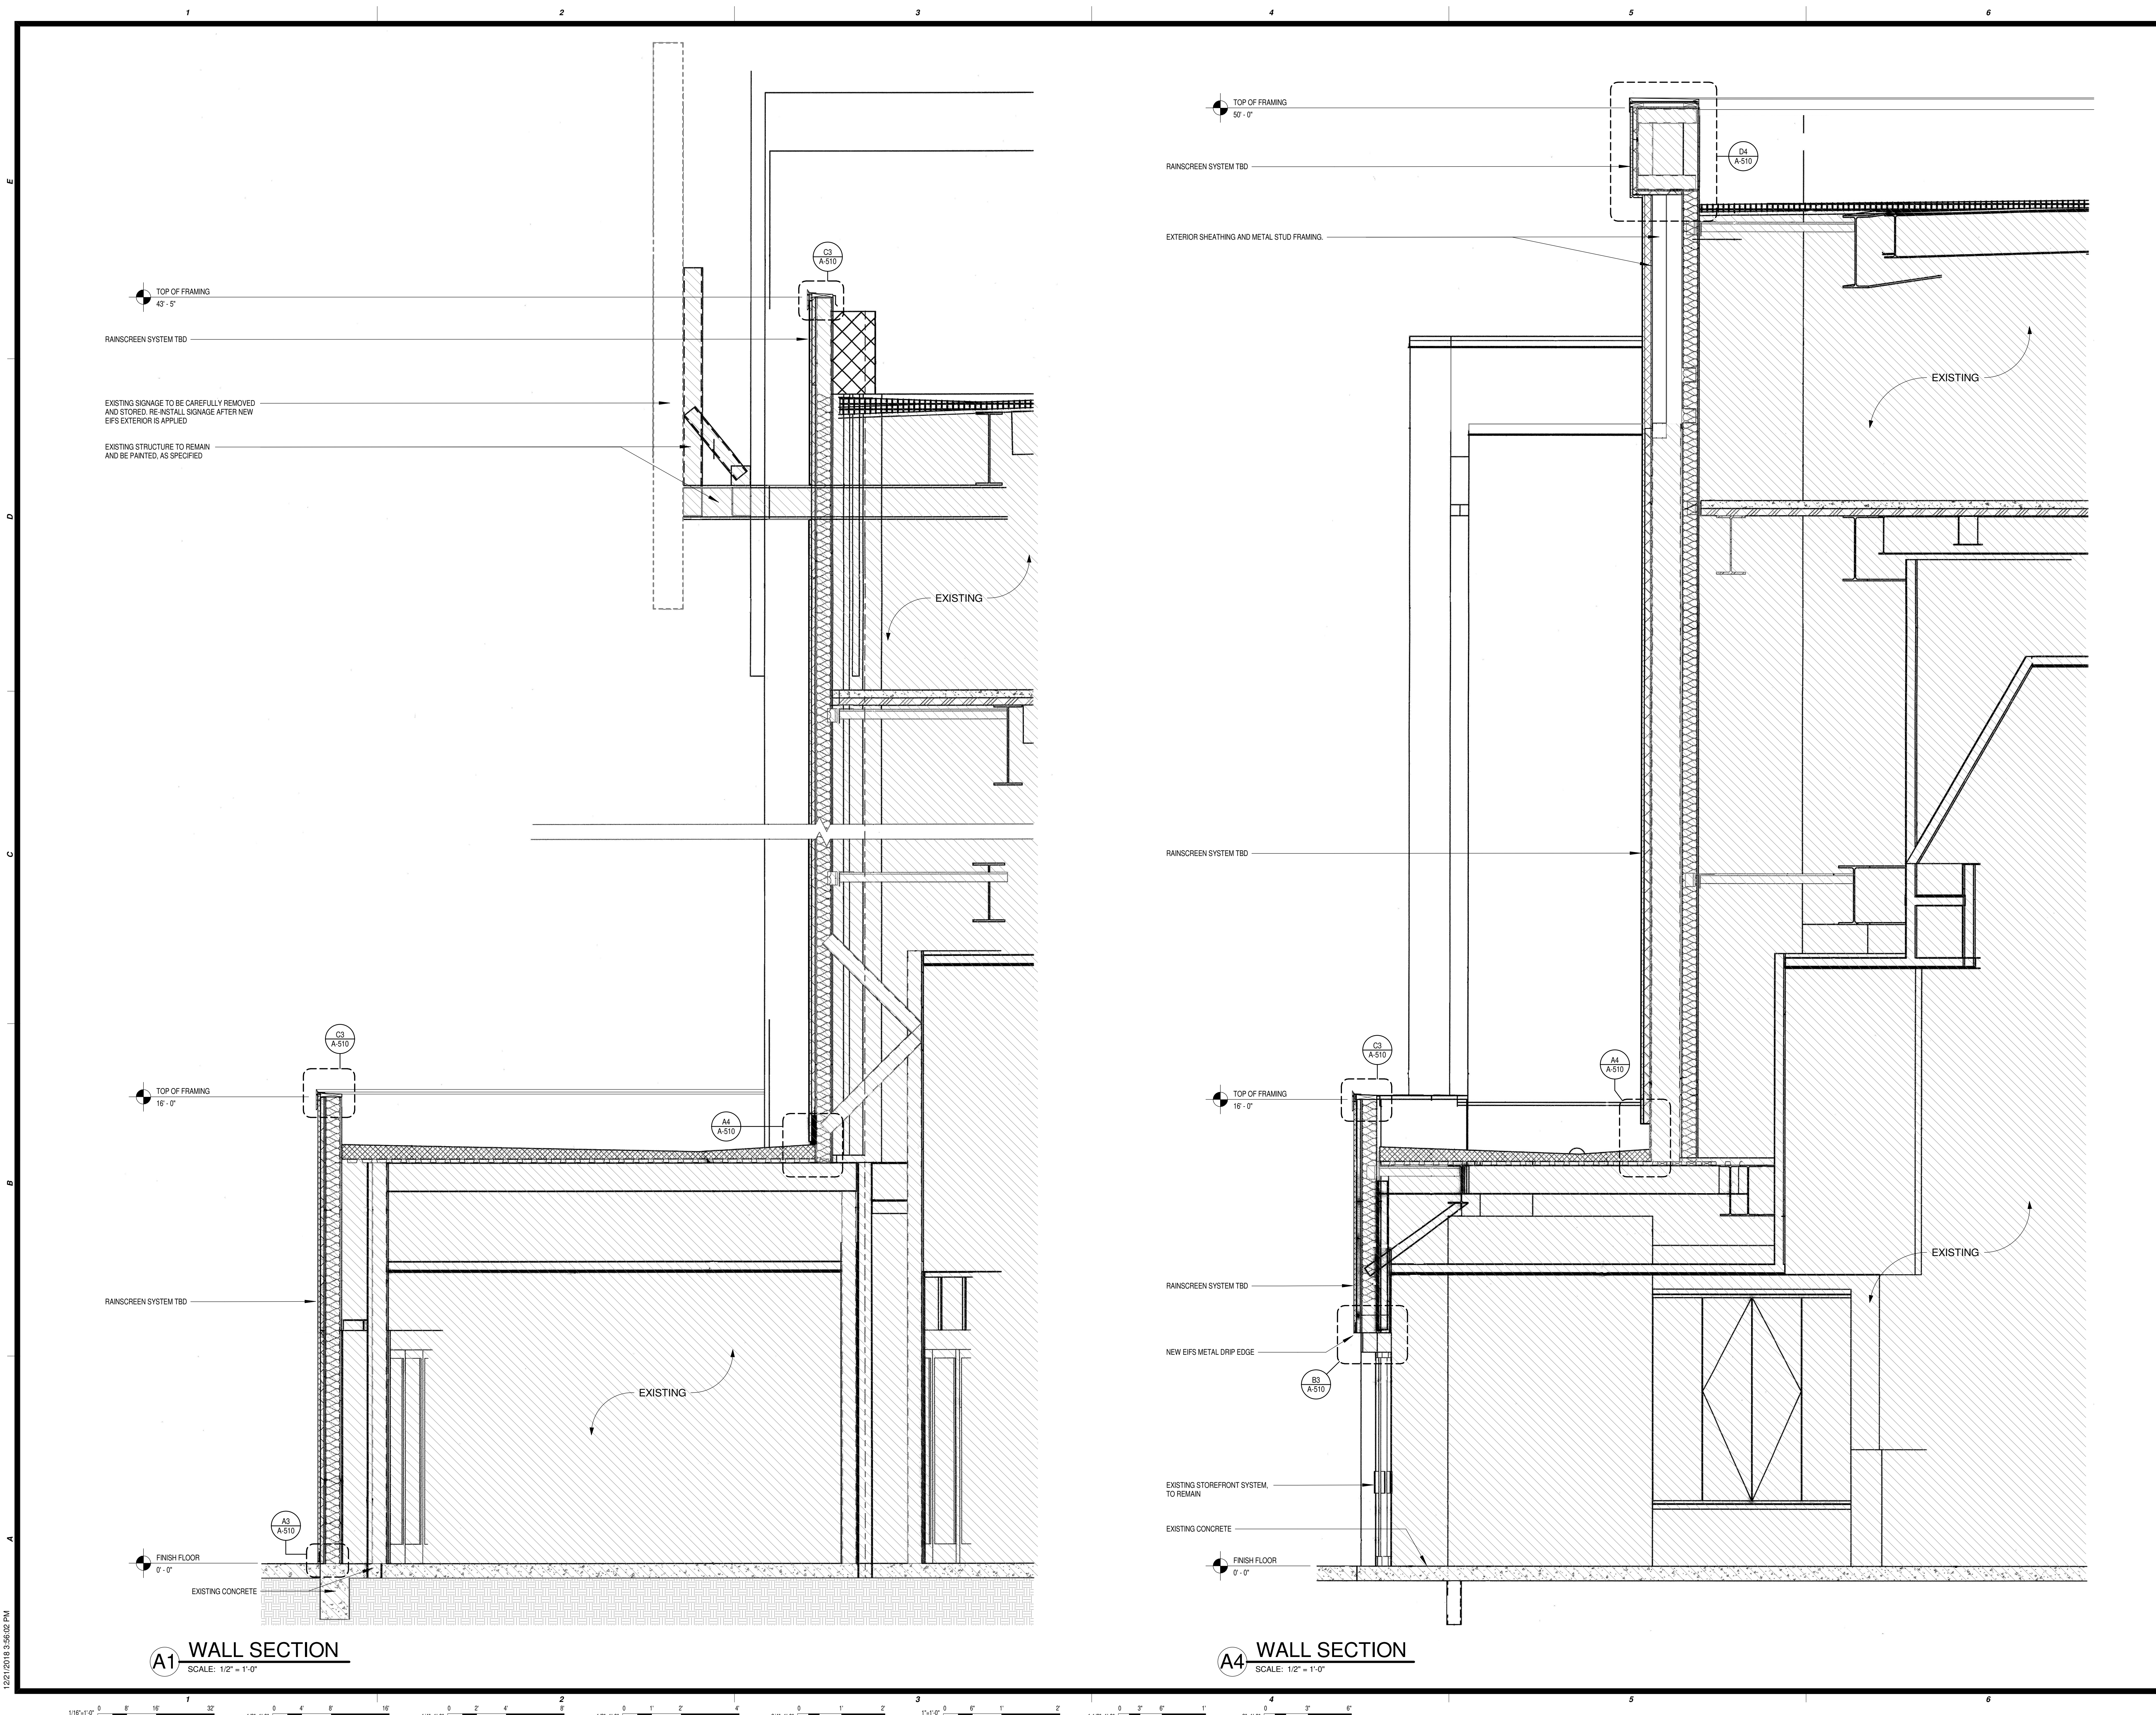

A1 WALL SECTION
SCALE: 1/2" = 1'-0"

A4 WALL SECTION
SCALE: 1/2" = 1'-0"

12/21/2018 3:56:05 PM

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Buffalo, NY 14202
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Cherokee Hard Rock Hotel & Casino

EXTERIOR FACADE RENOVATION

KEY PLAN




No.	Description	Date

WALL SECTIONS

CONSTRUCTION SET


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CHECKED BY: DH
ISSUE DATE: 12/21/2018

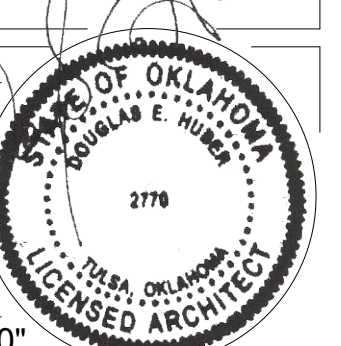

A-322

Scale 1/2" = 1'-0"

12/21/2018

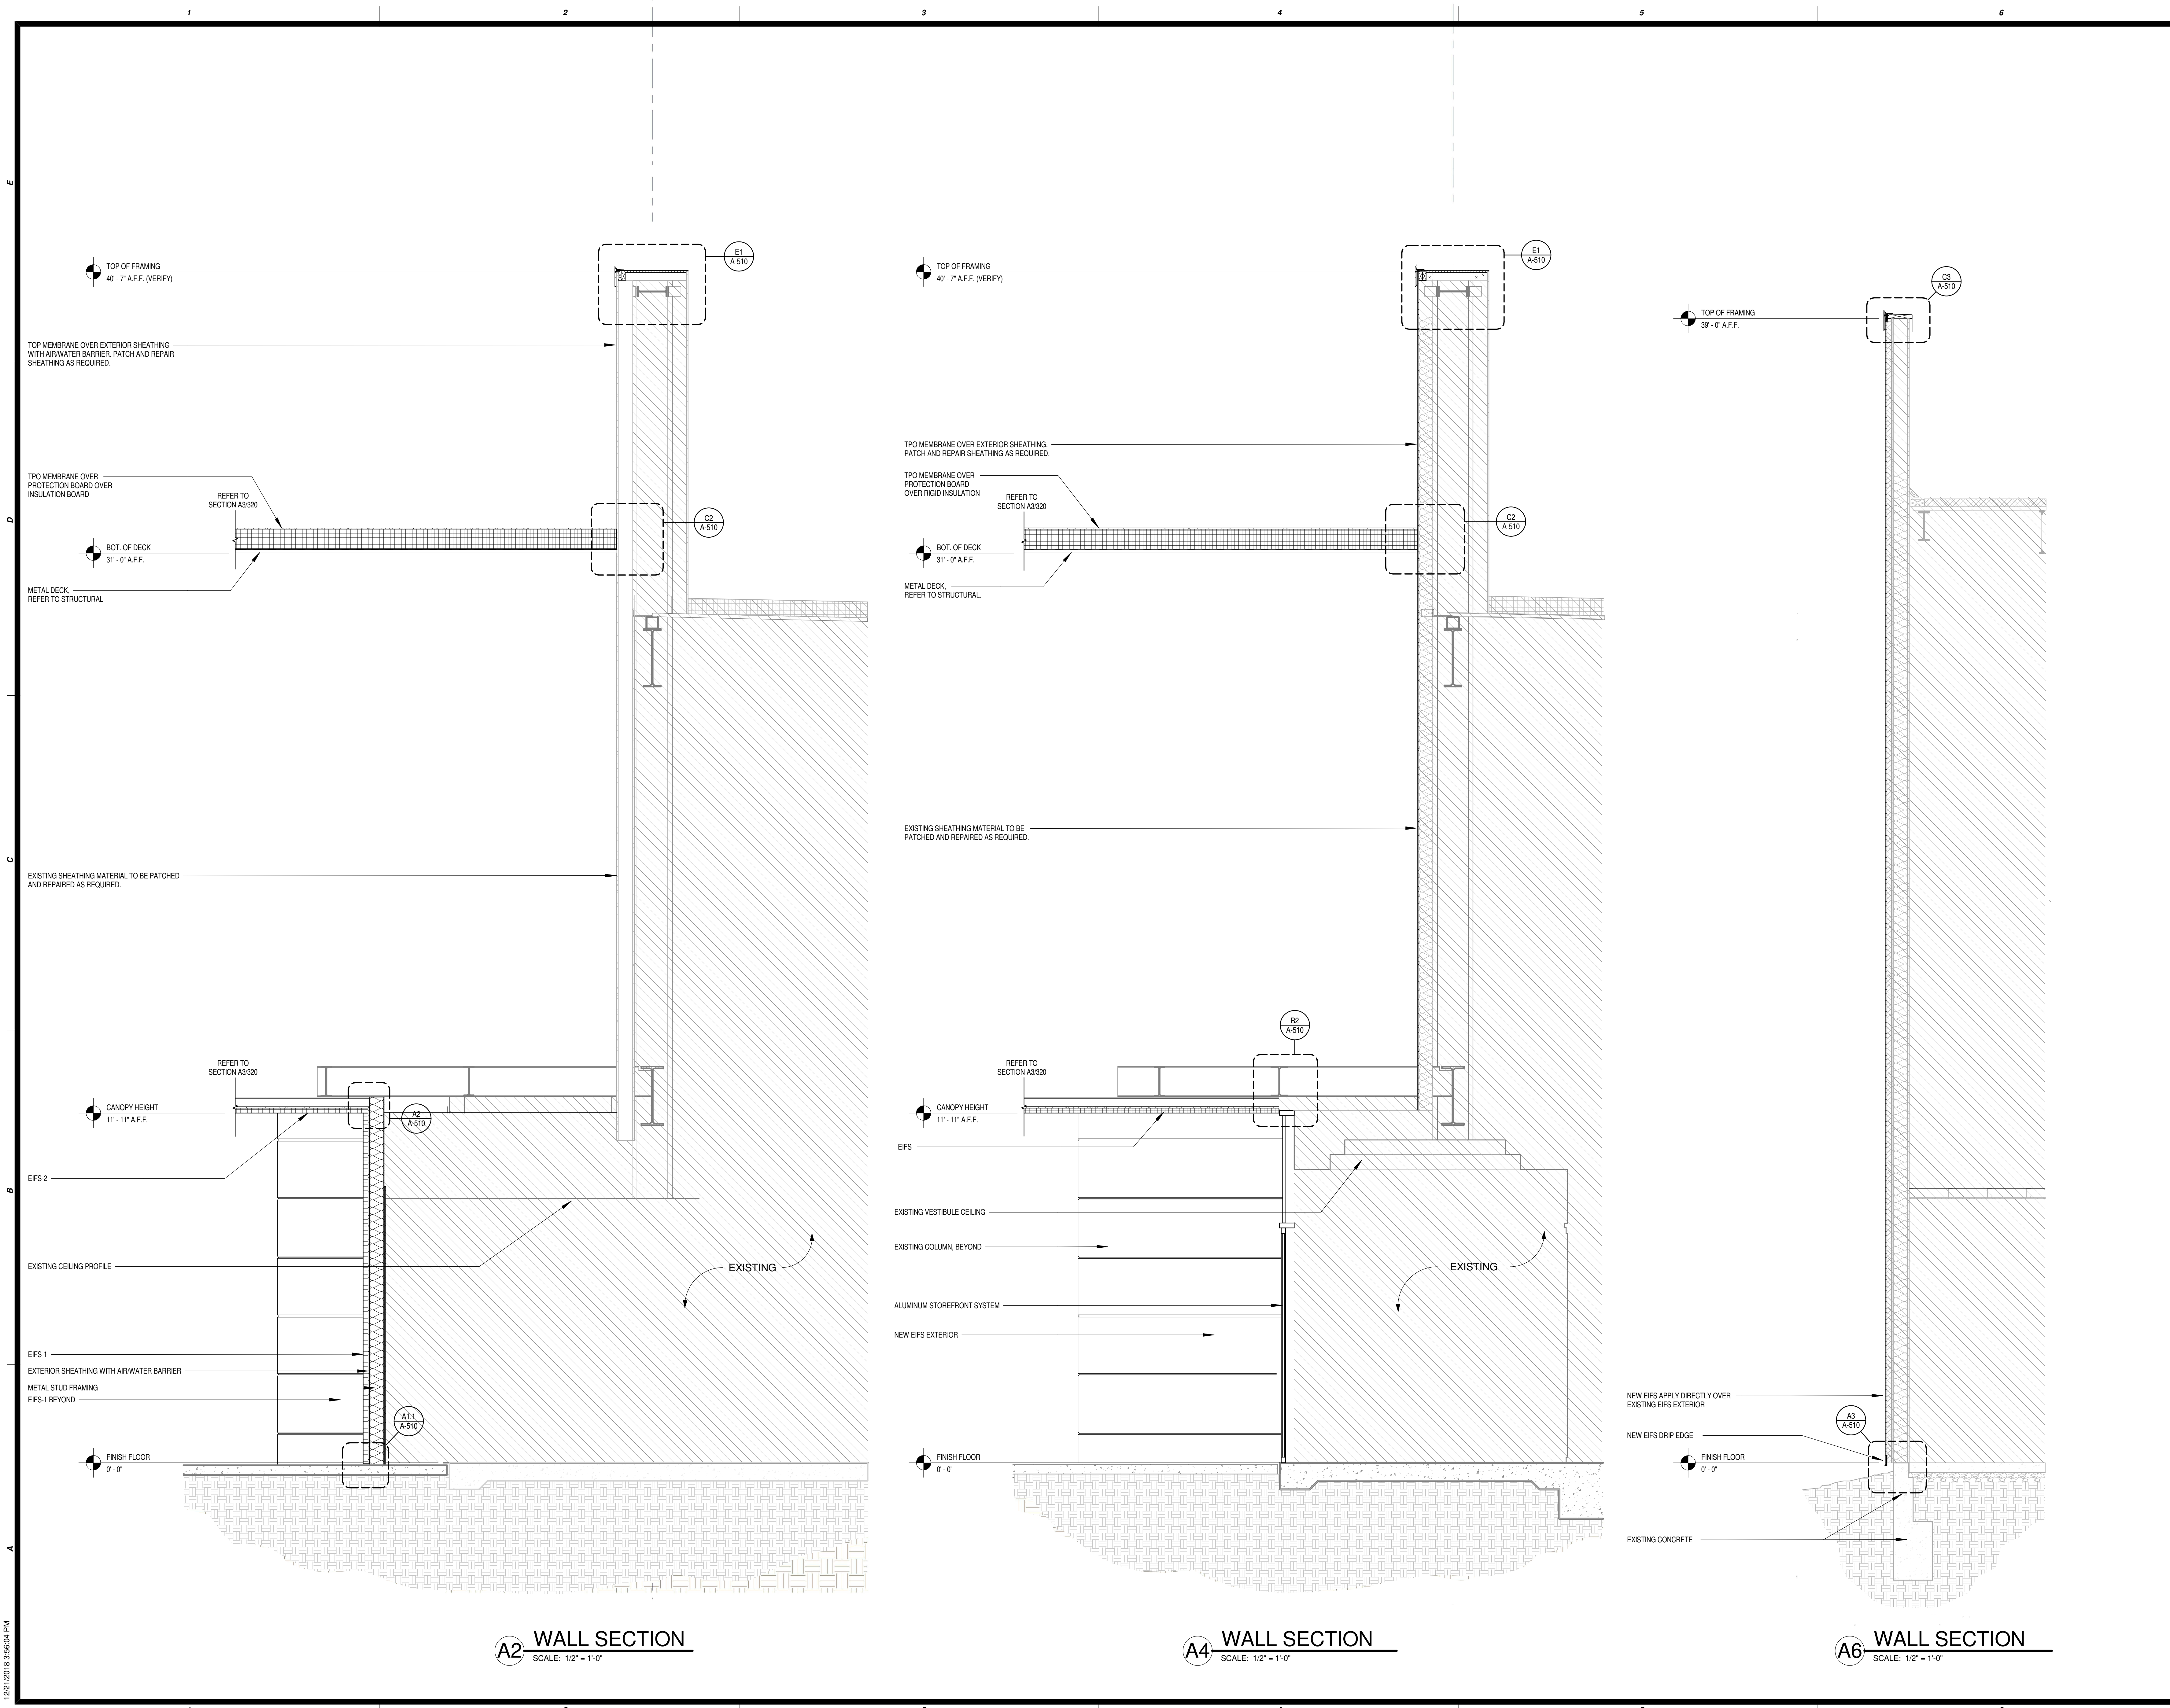

A2 WALL SECTION
SCALE: 1/2" = 1'-0"

A4 WALL SECTION
SCALE: 1/2" = 1'-0"

A6 WALL SECTION
SCALE: 1/2" = 1'-0"

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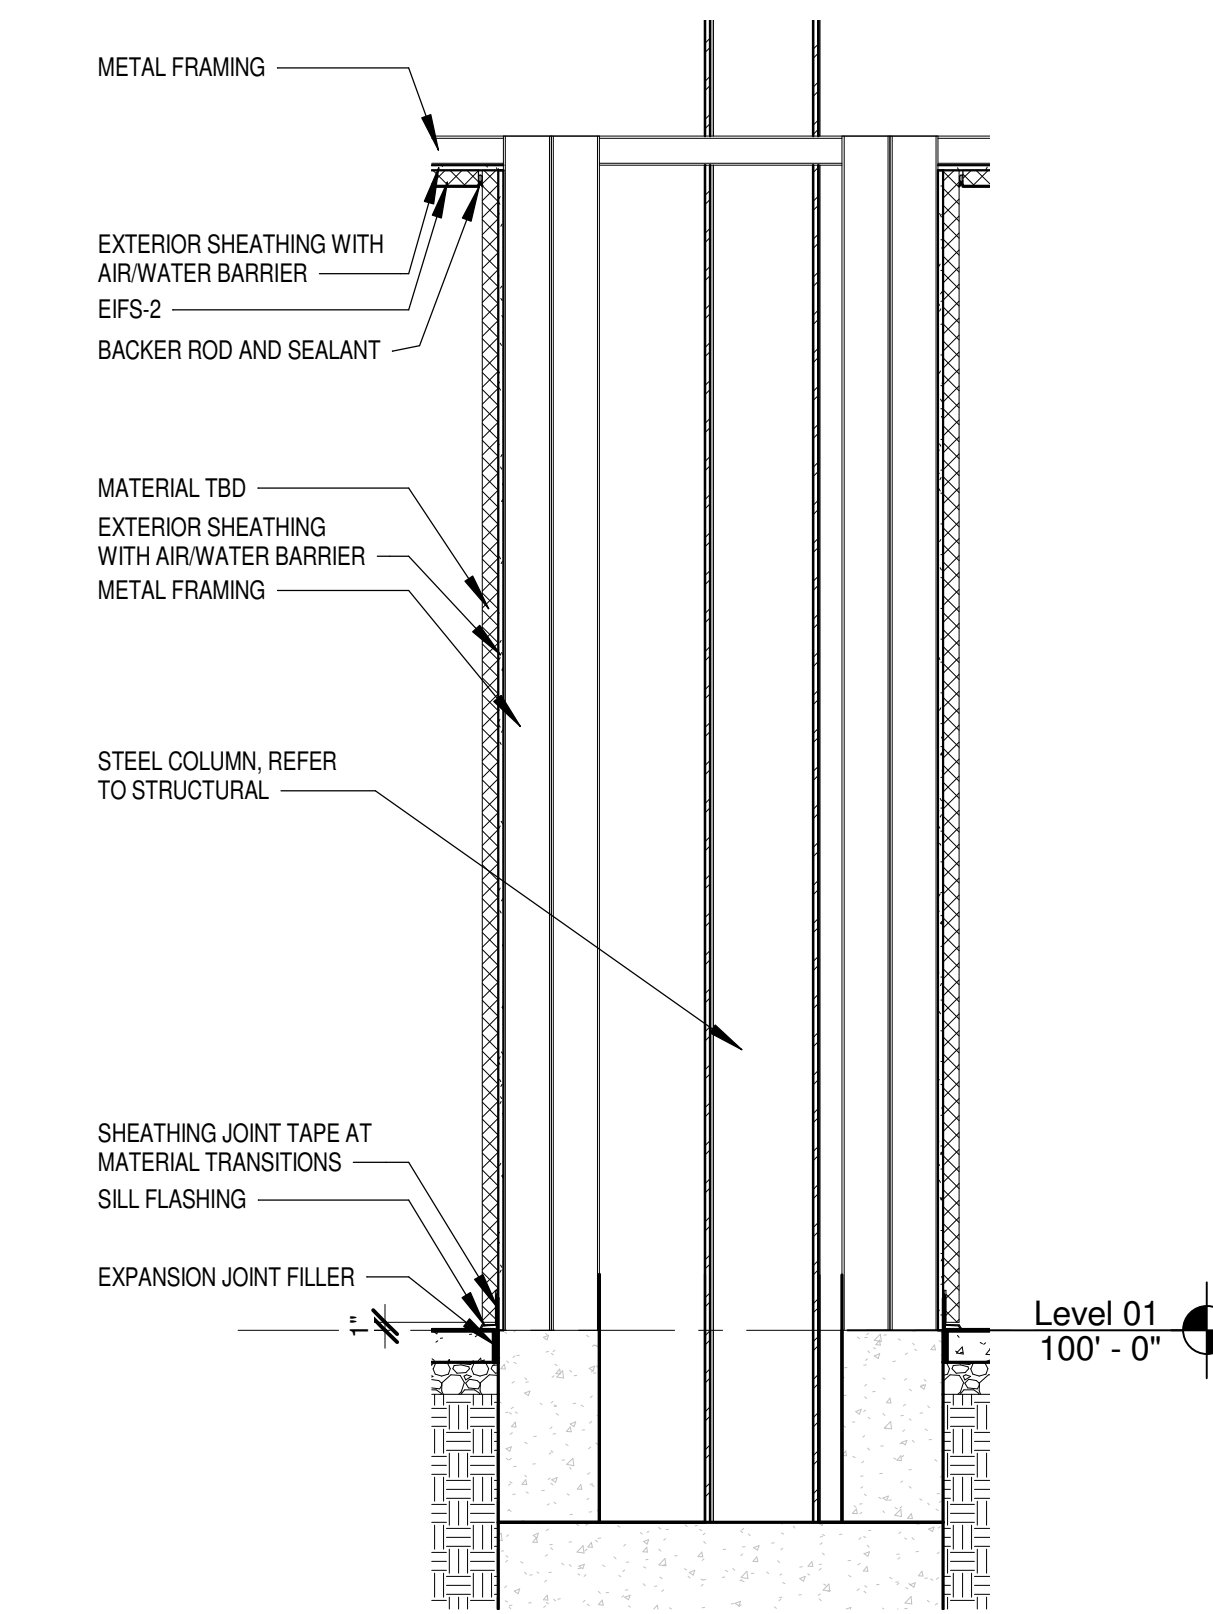
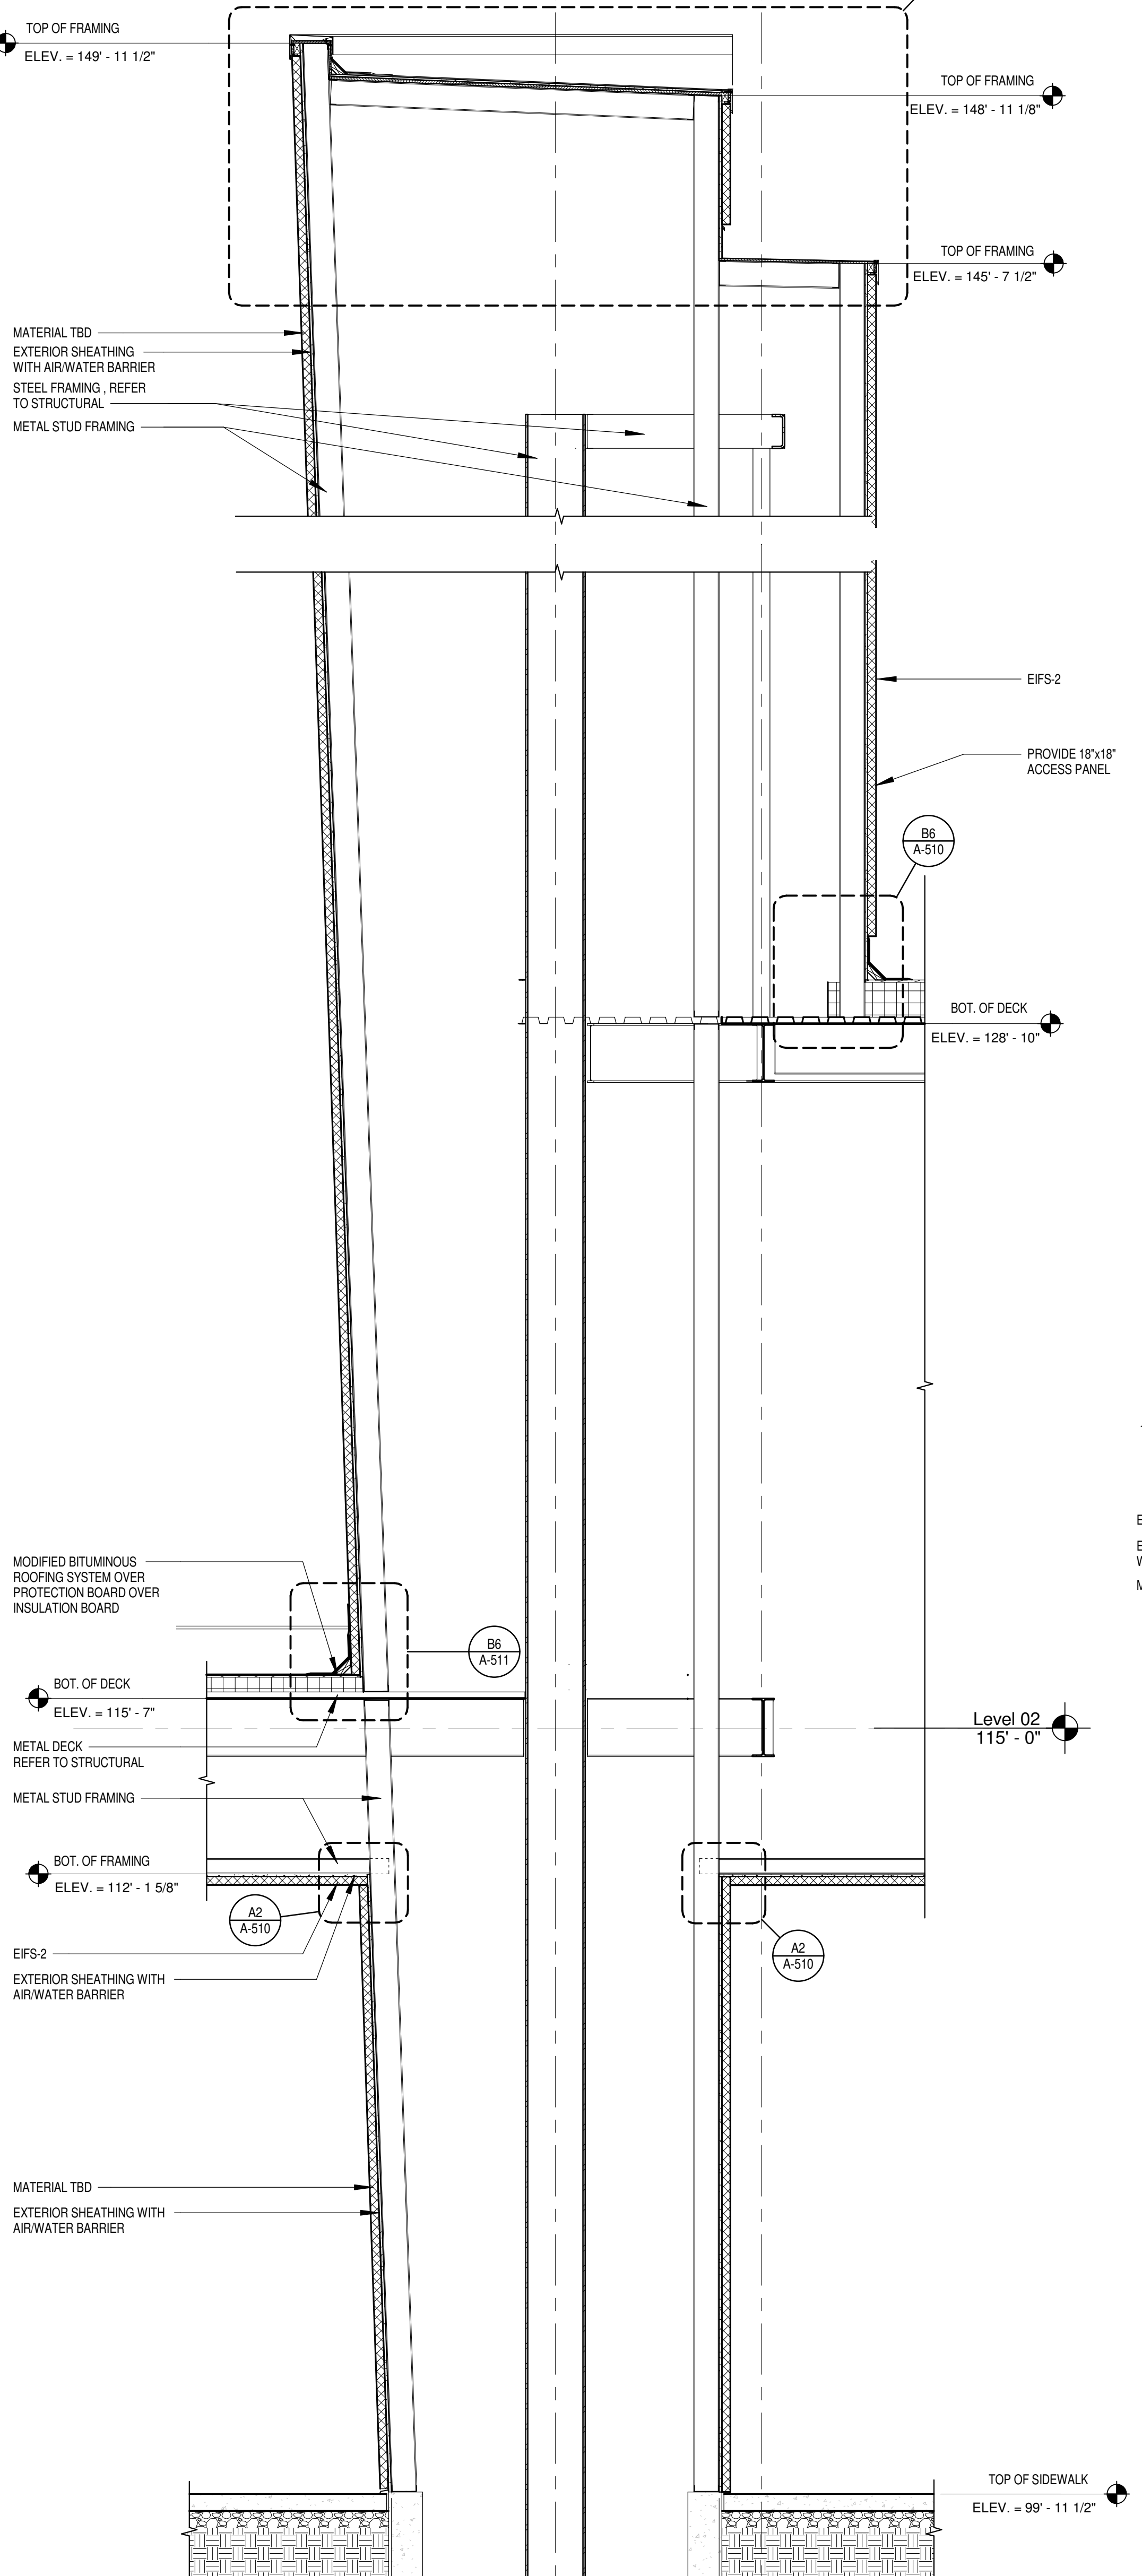
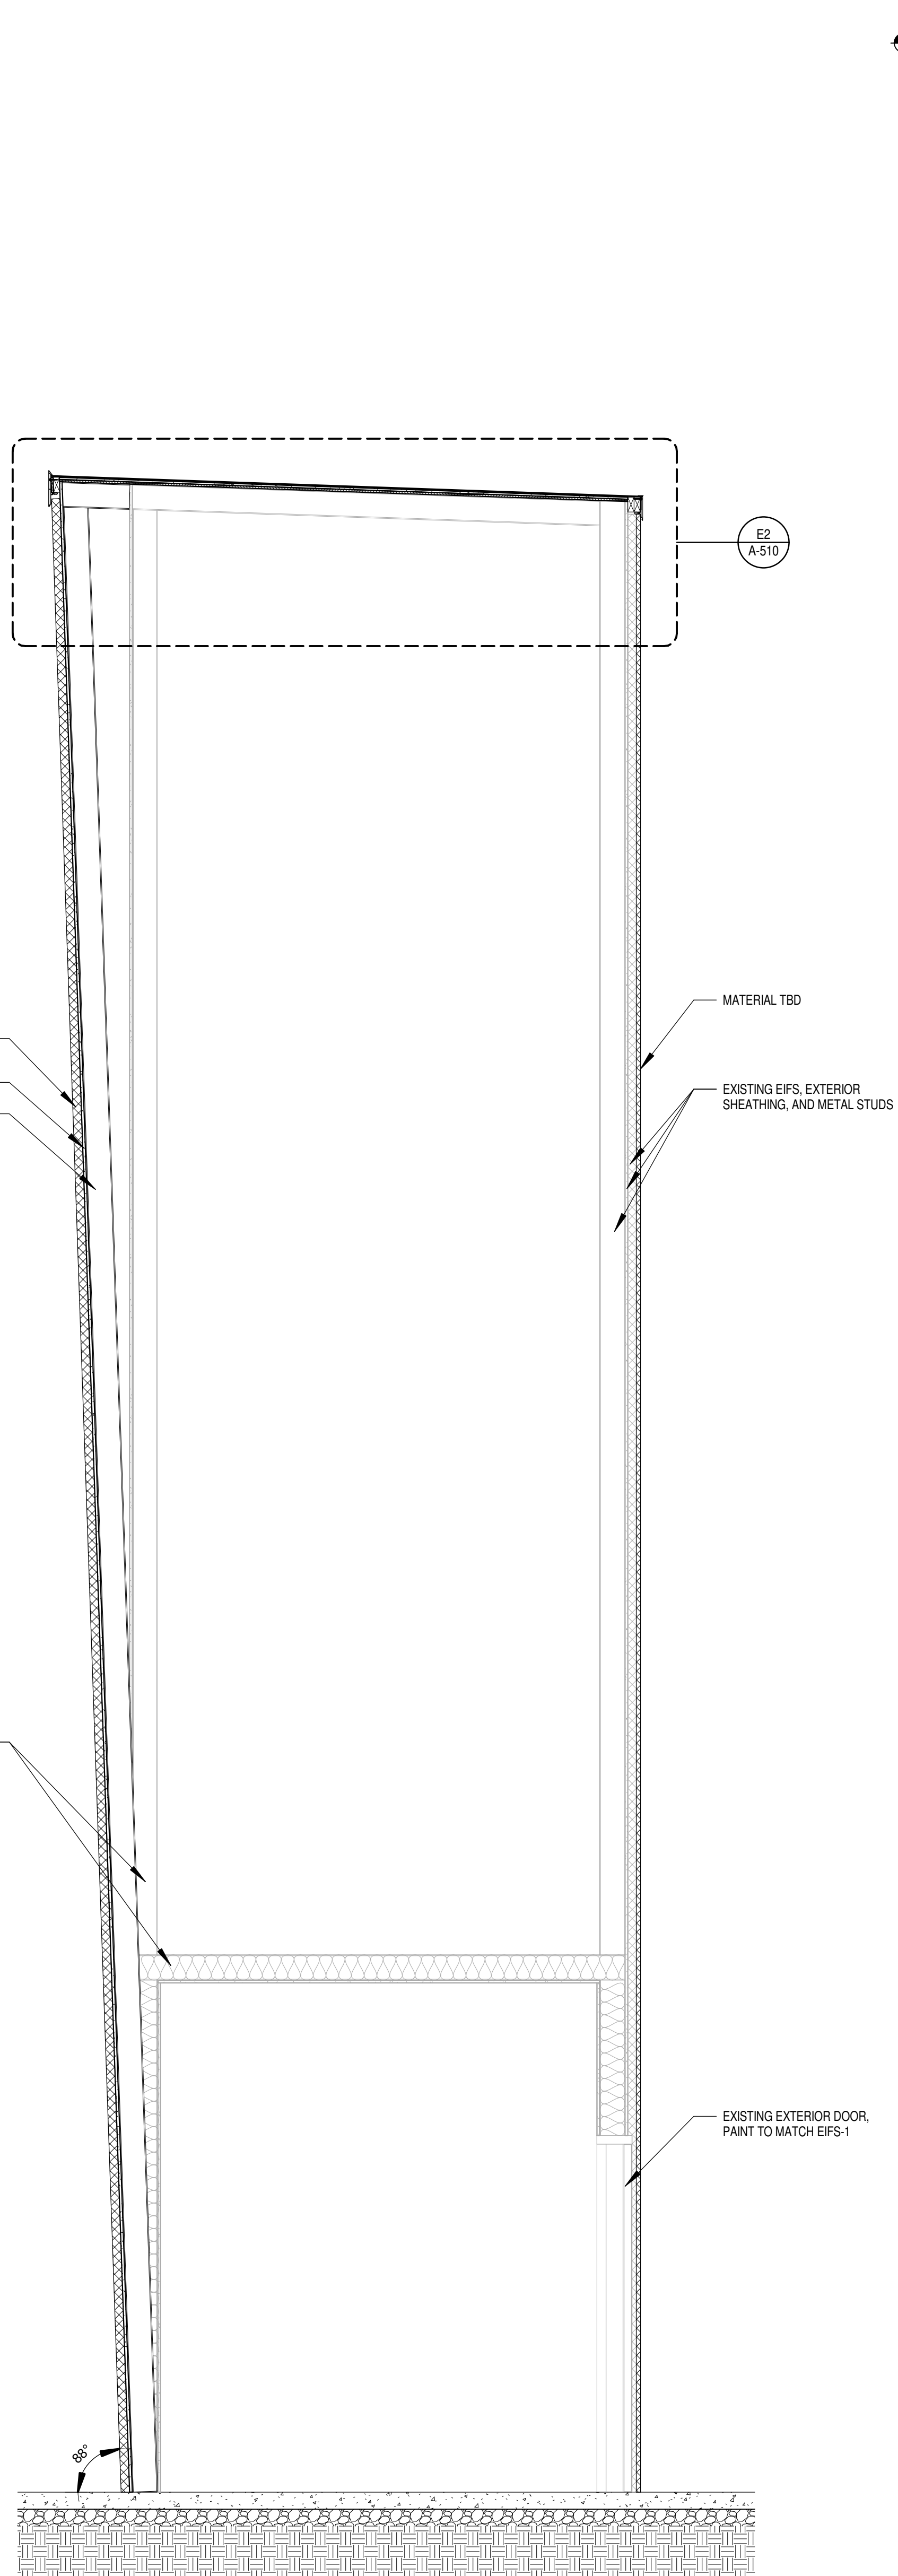
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 MSA Engineering Consultants
 370 E. Windmill Ln.
 Suite 100
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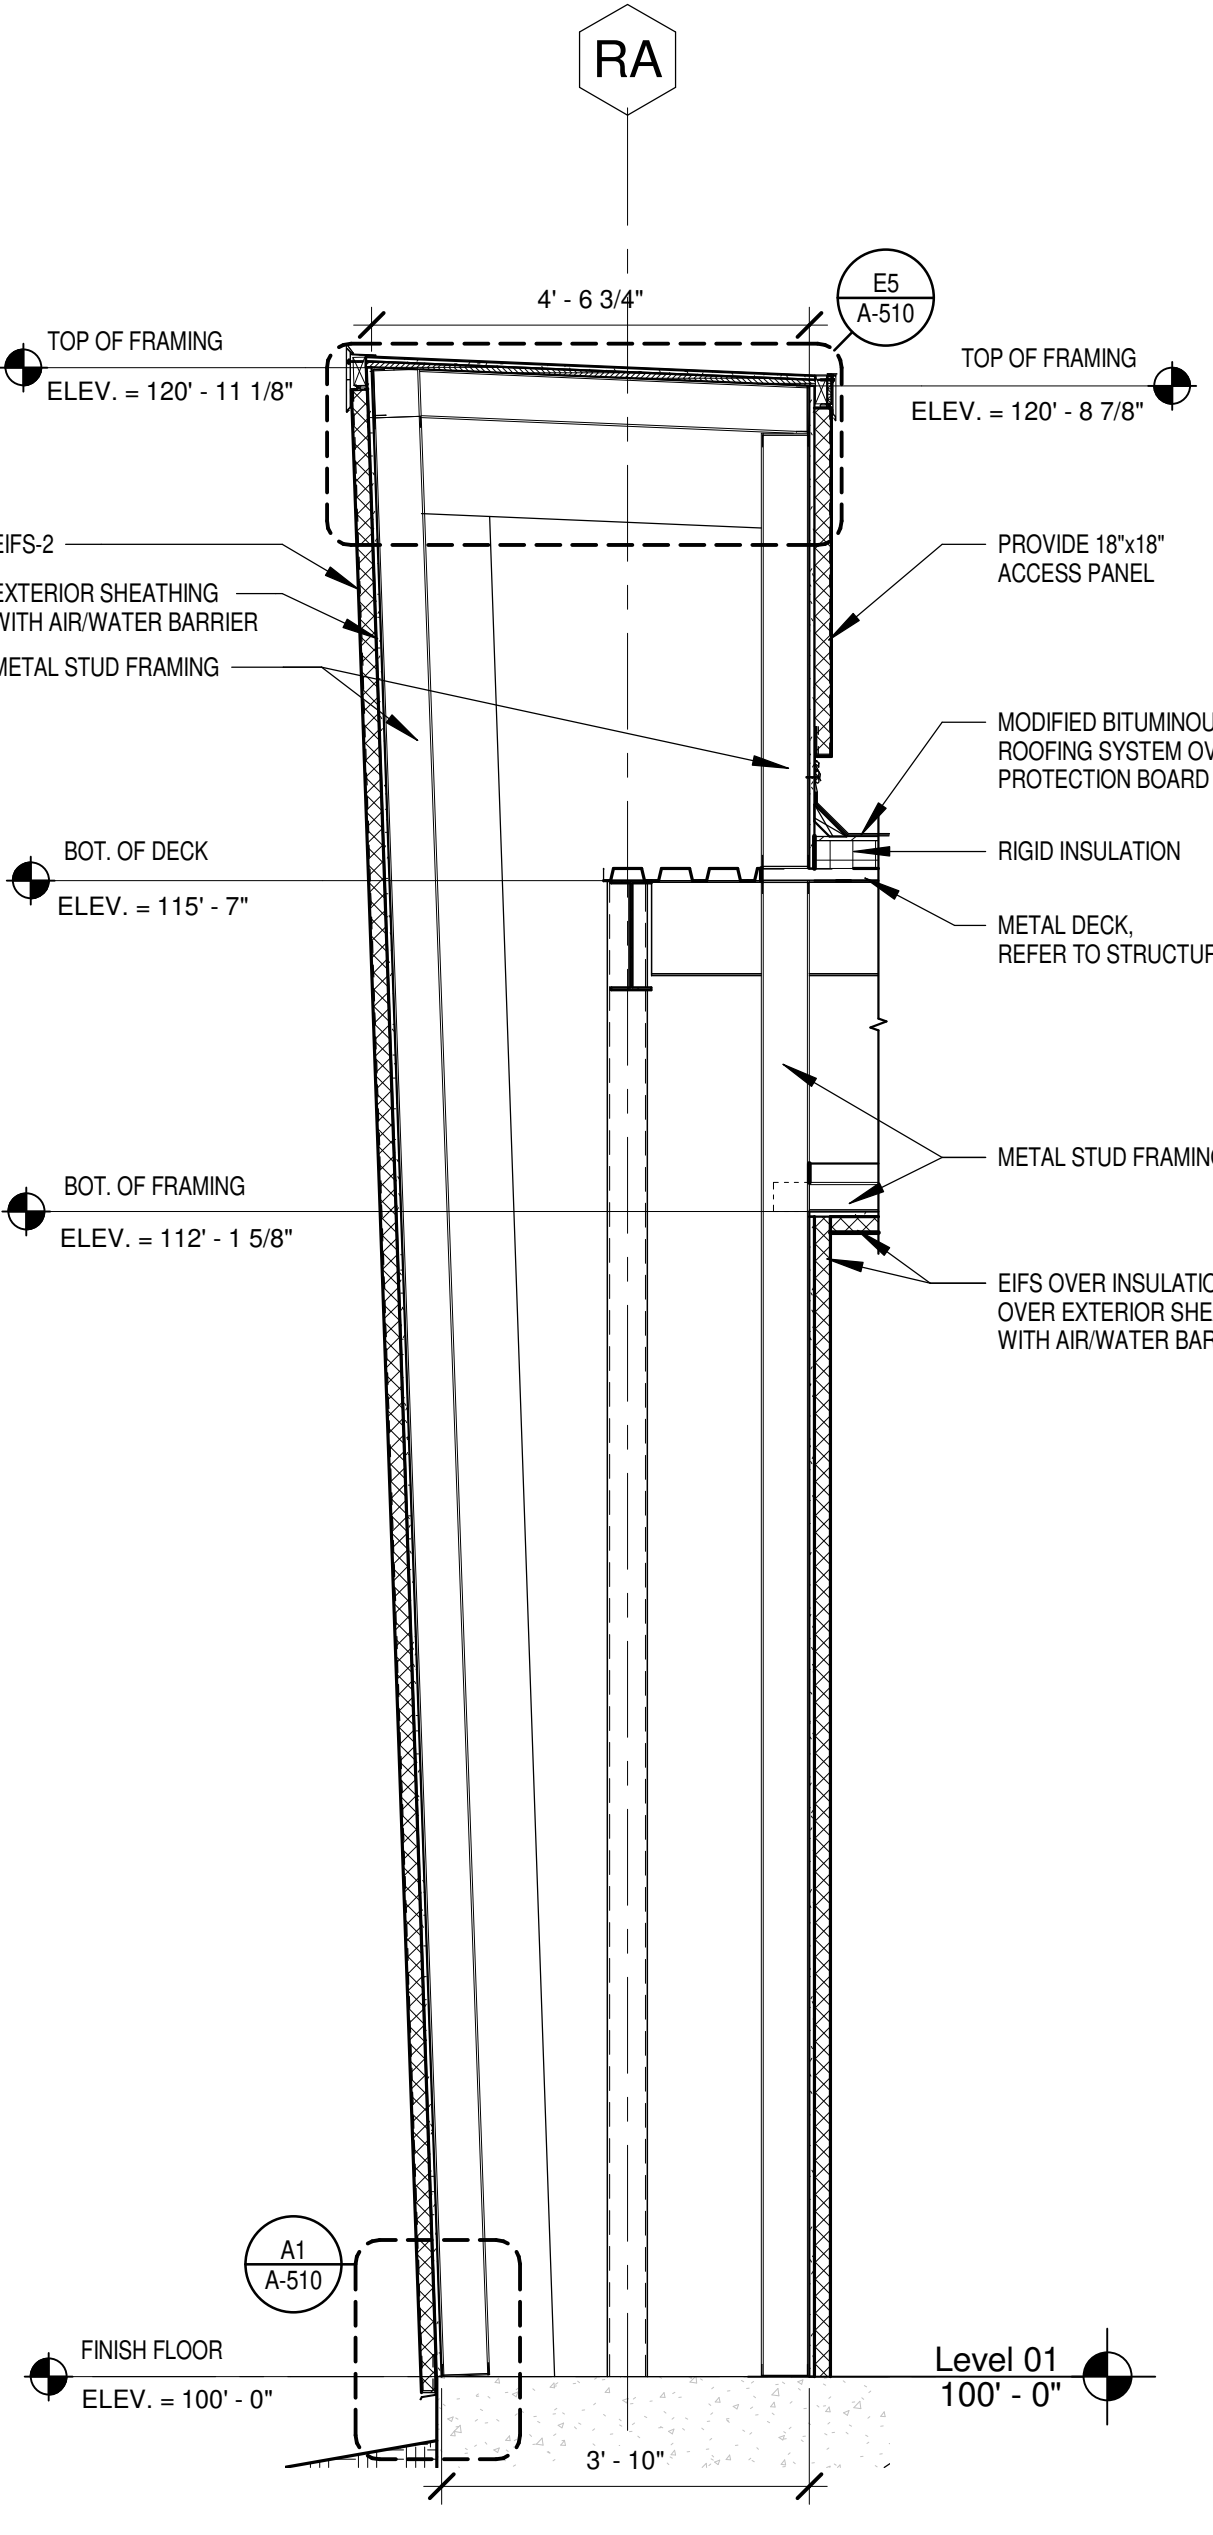
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 Suite 200
 Buffalo, NY 14202
 716-845-5092


Cherokee Hard Rock Hotel & Casino



C4 SECTION DETAIL - COLUMN
 SCALE: 1/2" = 1'-0"



A4 WALL SECTION - CASINO 3 CANOPY COLUMN
 SCALE: 1/2" = 1'-0"

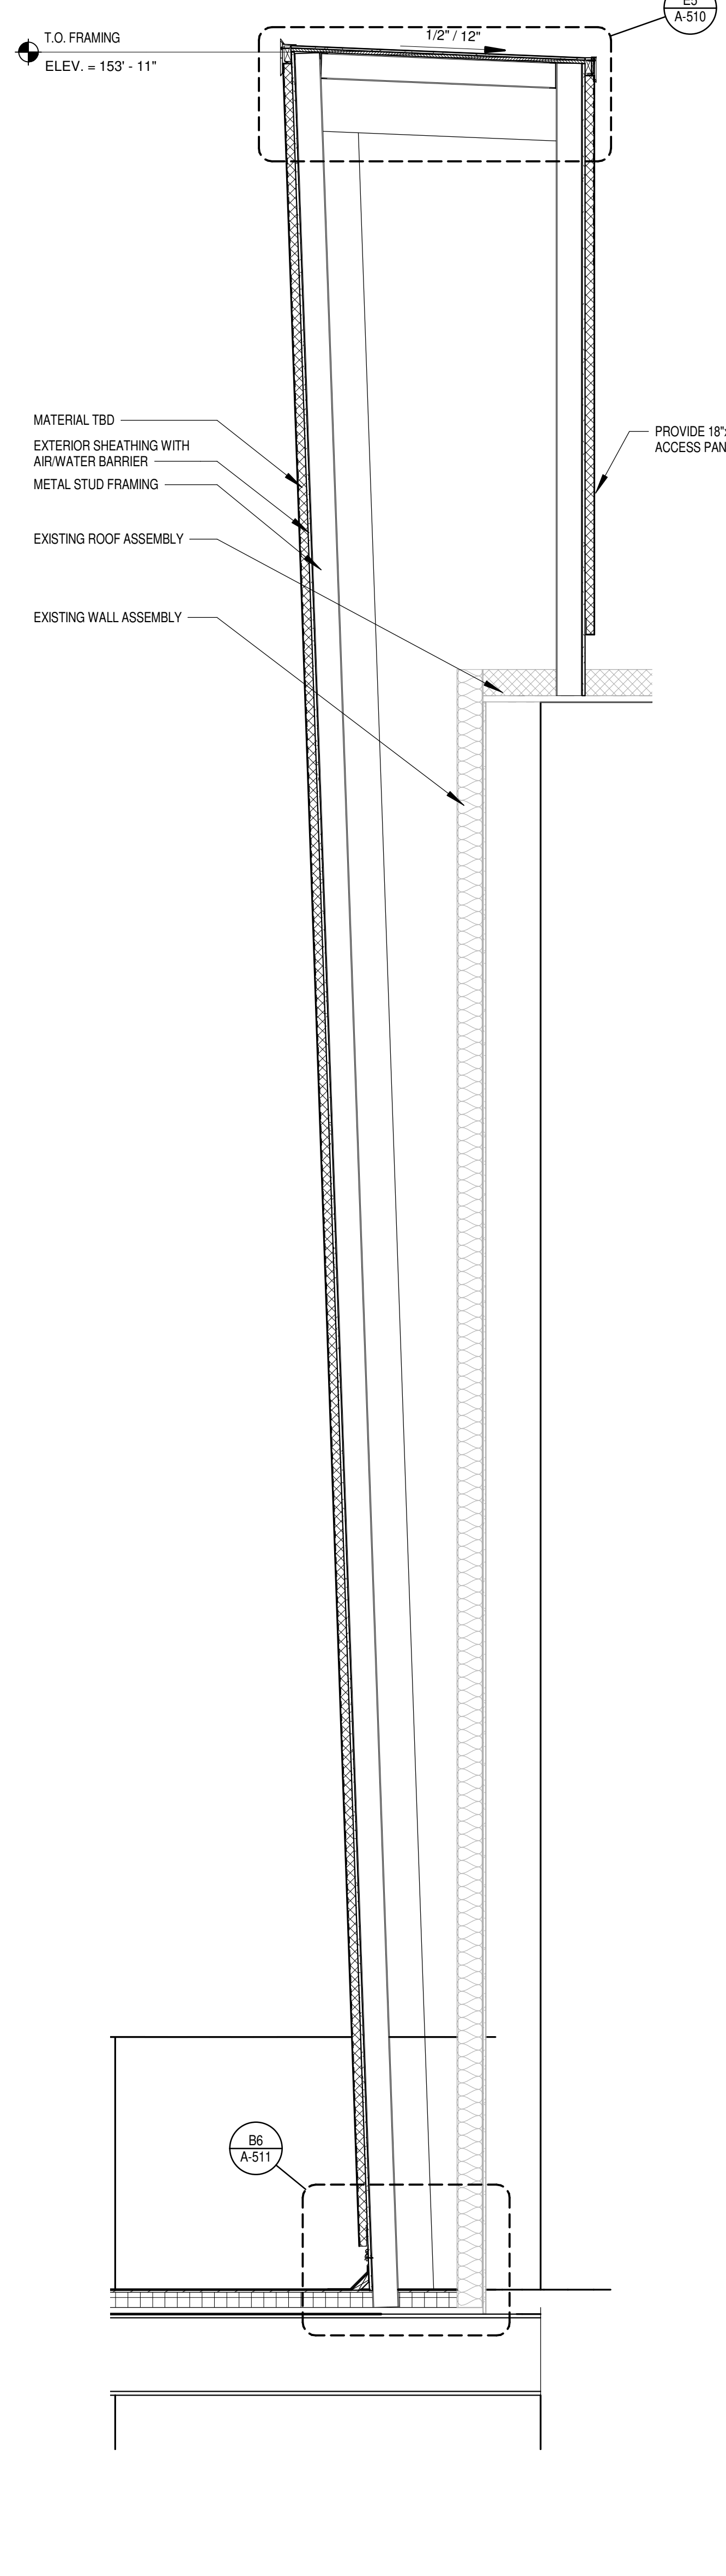

A5 WALL SECTION - CASINO 1 ROTUNDA PILASTER
 SCALE: 1/2" = 1'-0"

A1 WALL SECTION - CASINO 1 PORTE COCHERE COLUMN
 SCALE: 1/2" = 1'-0"

A2 WALL SECTION - CASINO 3 PILASTER
 SCALE: 1/2" = 1'-0"

A4 WALL SECTION - CASINO 3 CANOPY COLUMN
 SCALE: 1/2" = 1'-0"

A5 WALL SECTION - CASINO 1 ROTUNDA PILASTER
 SCALE: 1/2" = 1'-0"

12/21/2018 3:26:06 PM



EXTERIOR FACADE RENOVATION

KEY PLAN

No.	Description	Date

SHEET TITLE
WALL SECTIONS

CONSTRUCTION SET

PROJECT NO: H17018
 DRAWN BY: BJB
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 ISSUE DATE: 12/21/2018

A-323
 Scale: 1/2" = 1'-0"

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716-845-5092

Cherokee Hard Rock Hotel & Casino

EXTERIOR FACADE RENOVATION

KEY PLAN




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WALL SECTIONS


CONSTRUCTION SET

PROJECT NO: H17018
OWNER: BB
DESIGNER: DH
CHECKED BY:
ISSUE DATE: 12/21/2018

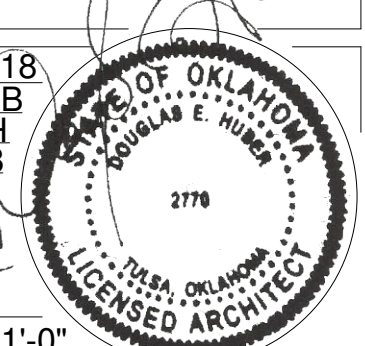

A-320
Scale 1/2" = 1'-0"

12/21/2018

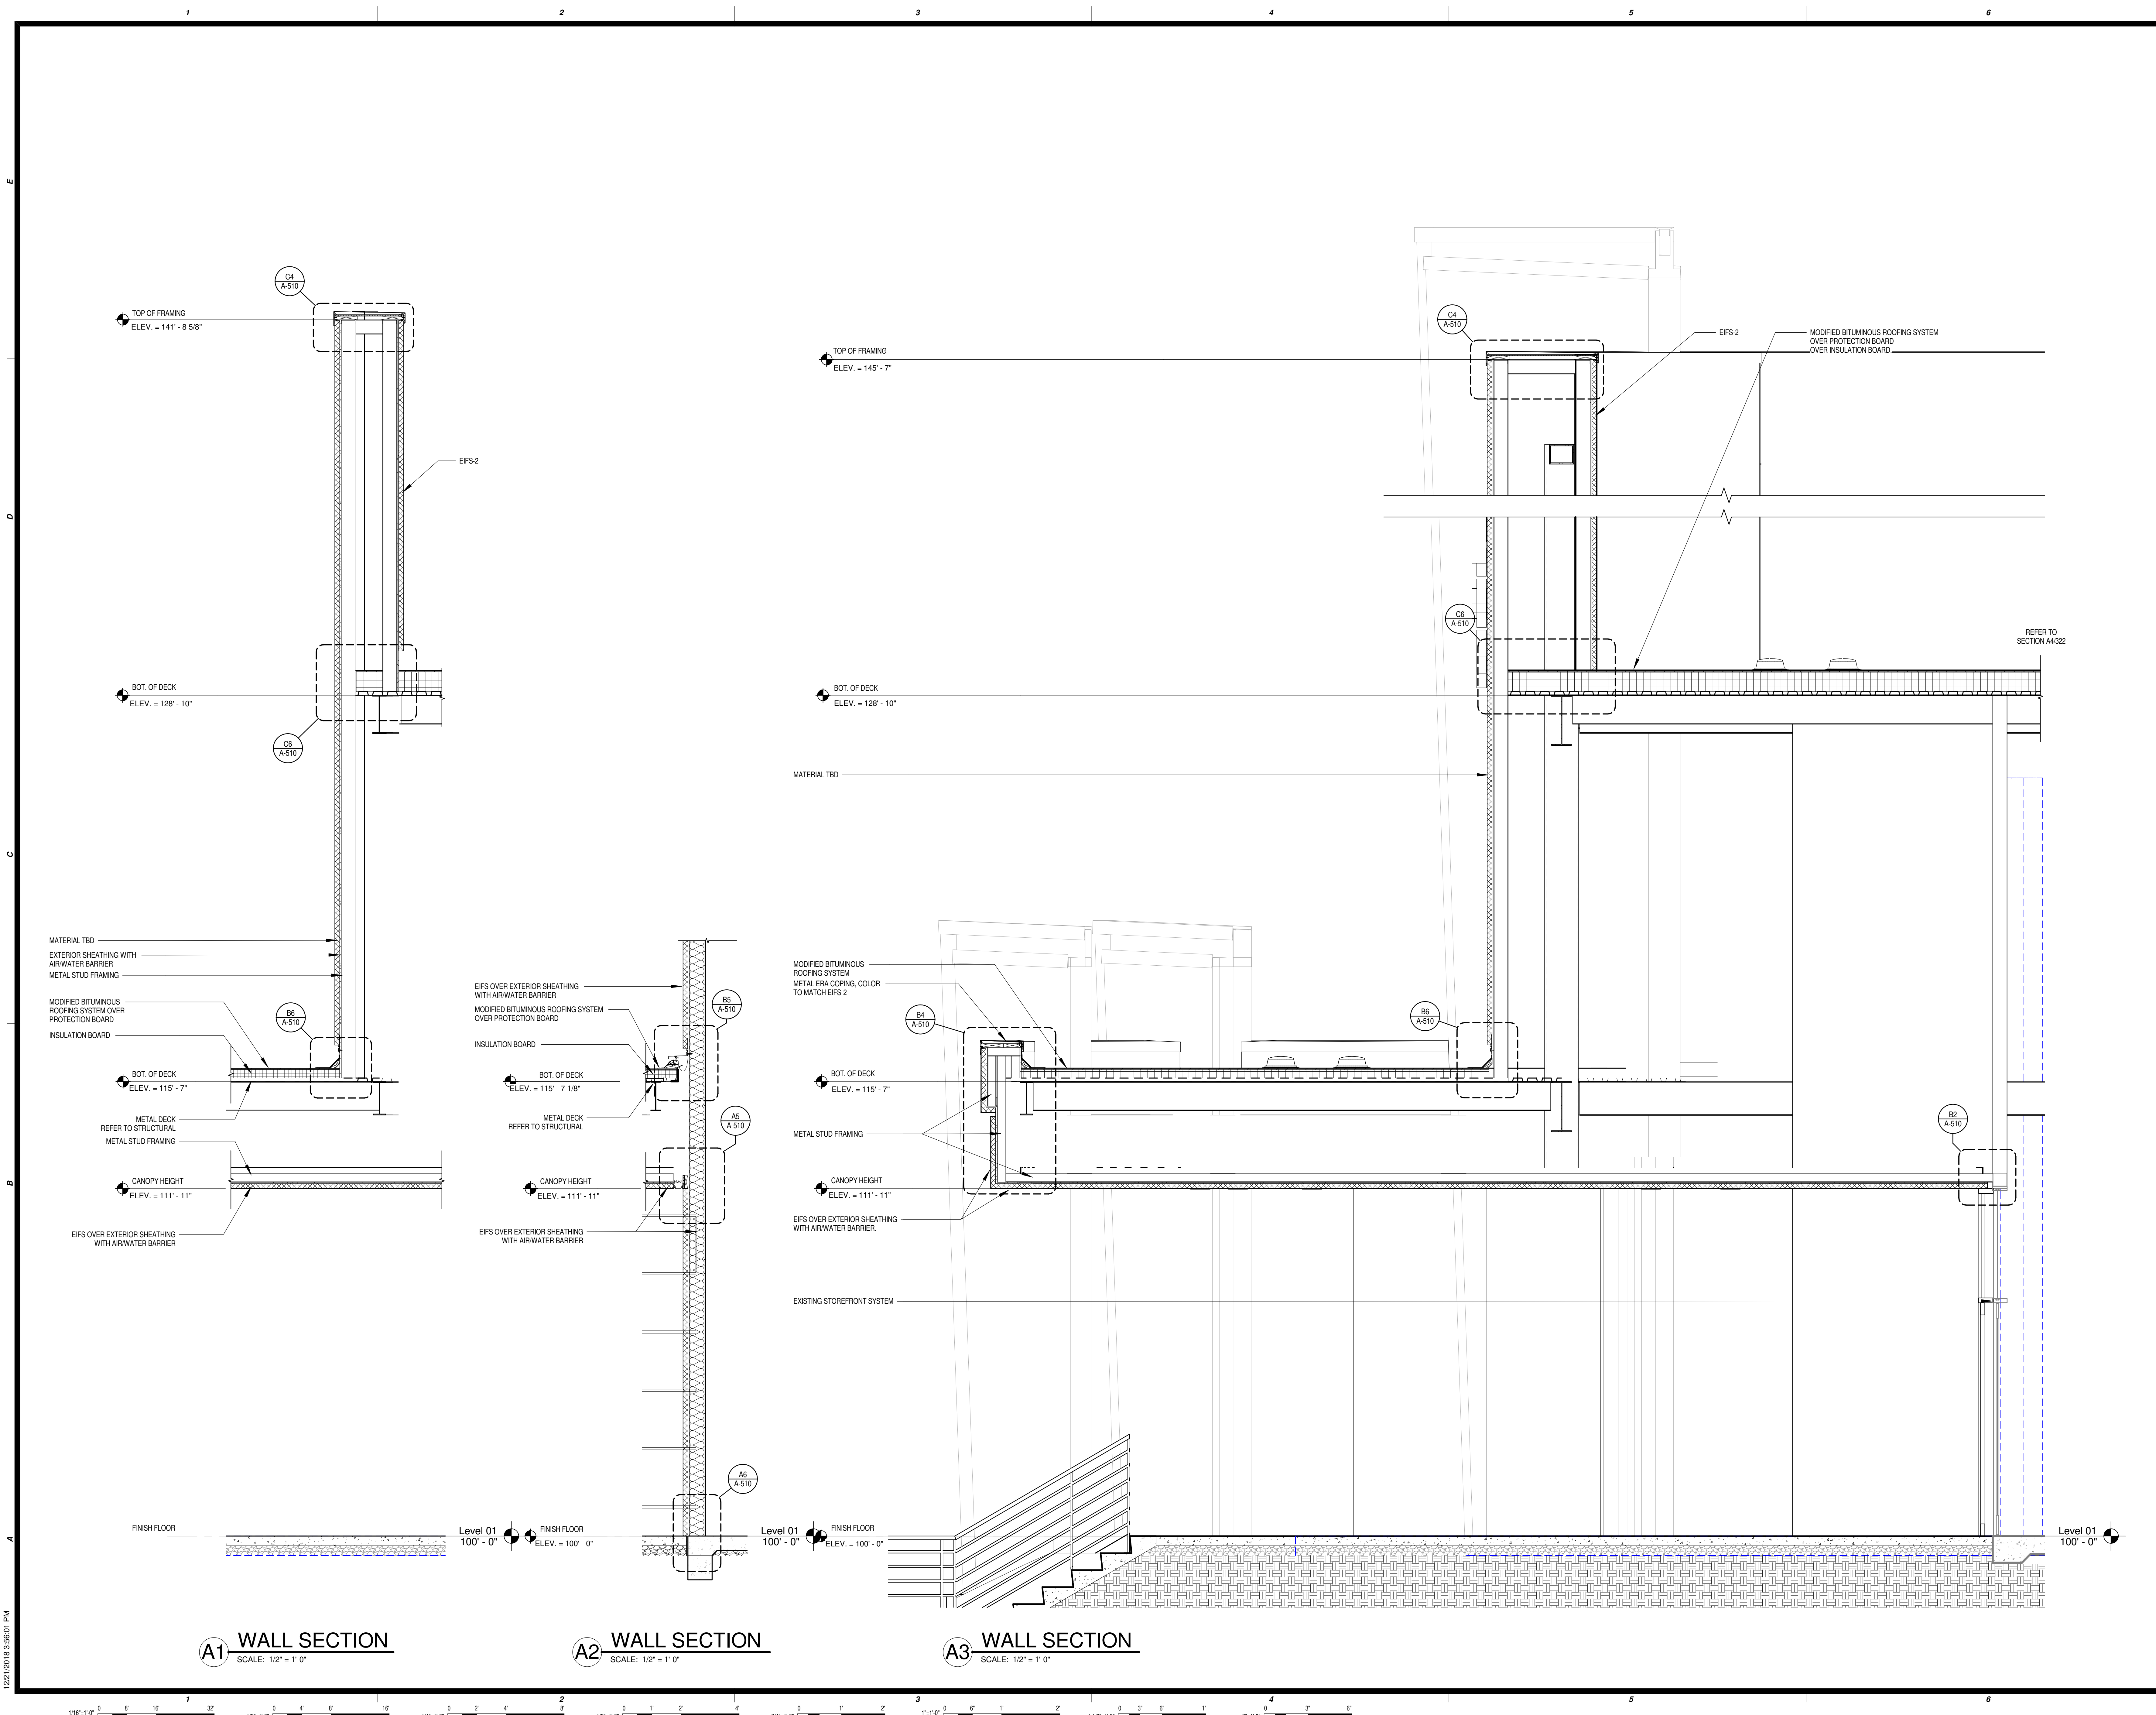

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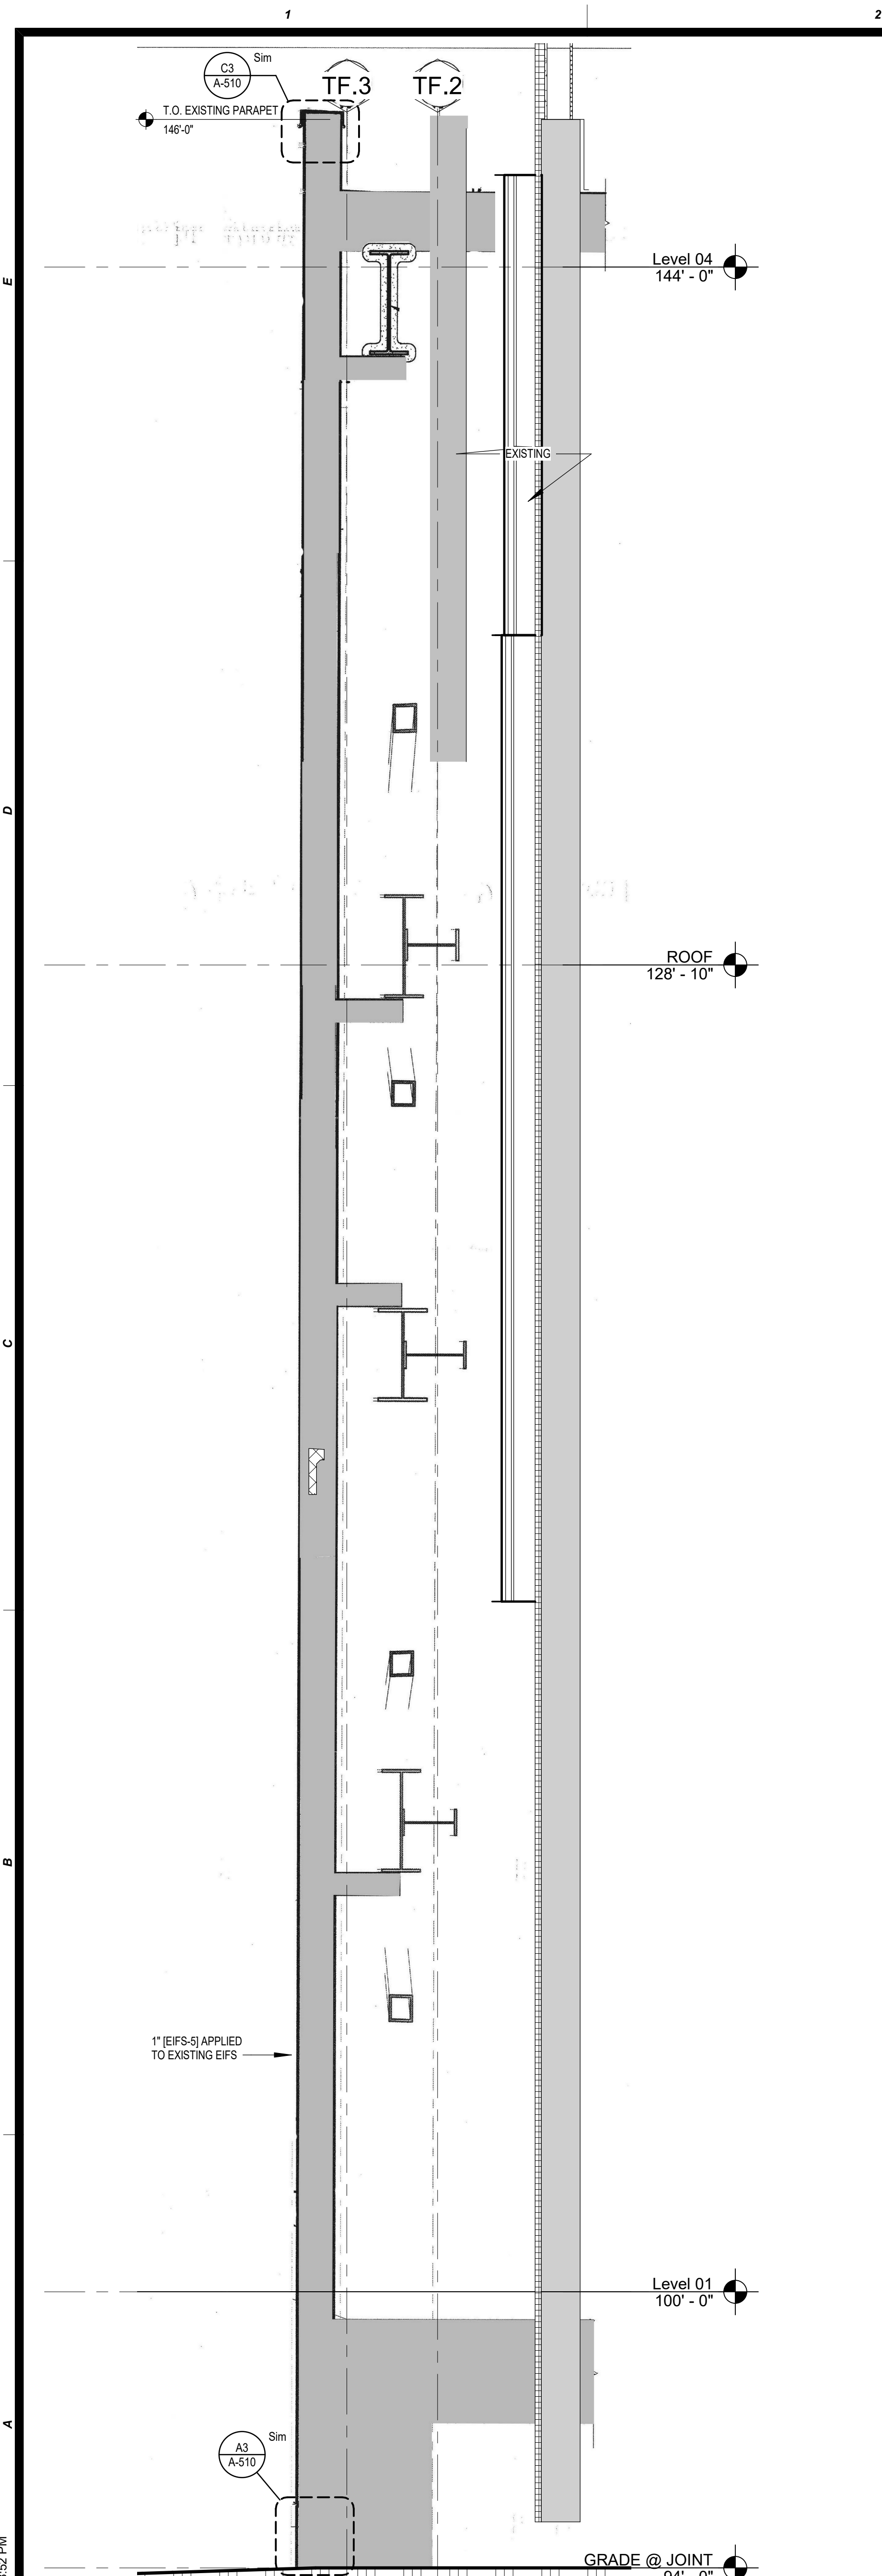
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505-344-4080

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MSA Engineering Consultants
370 E. Windmill Ln.
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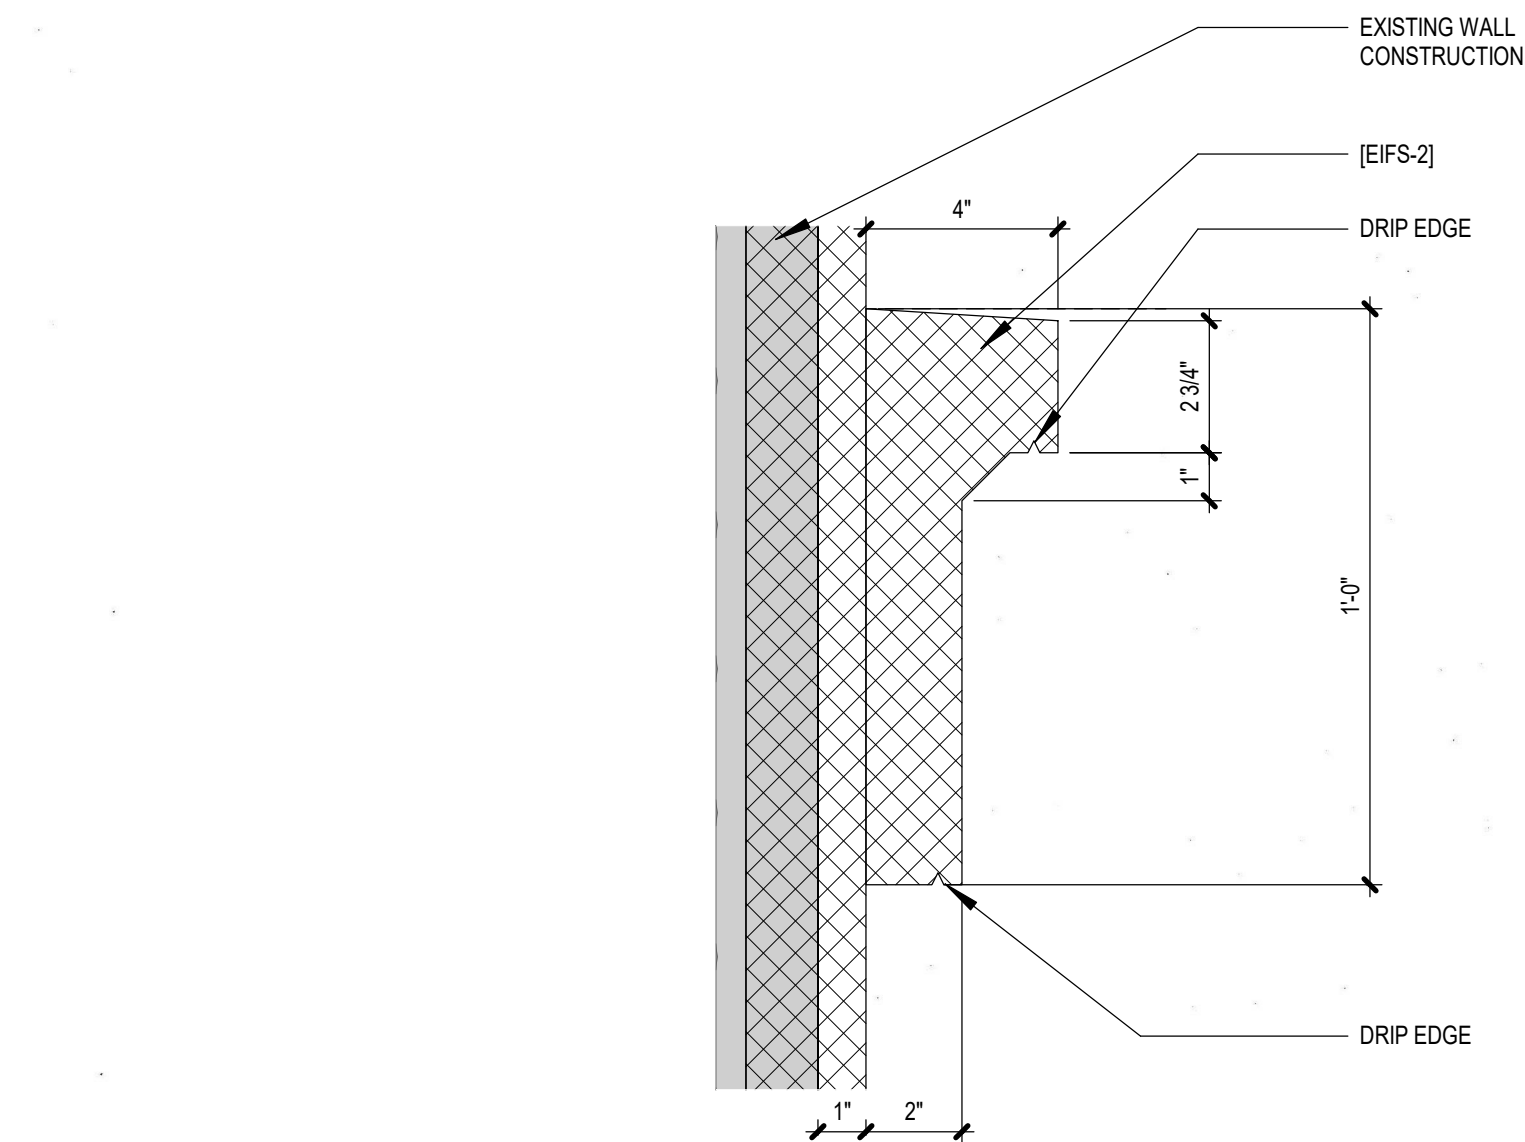
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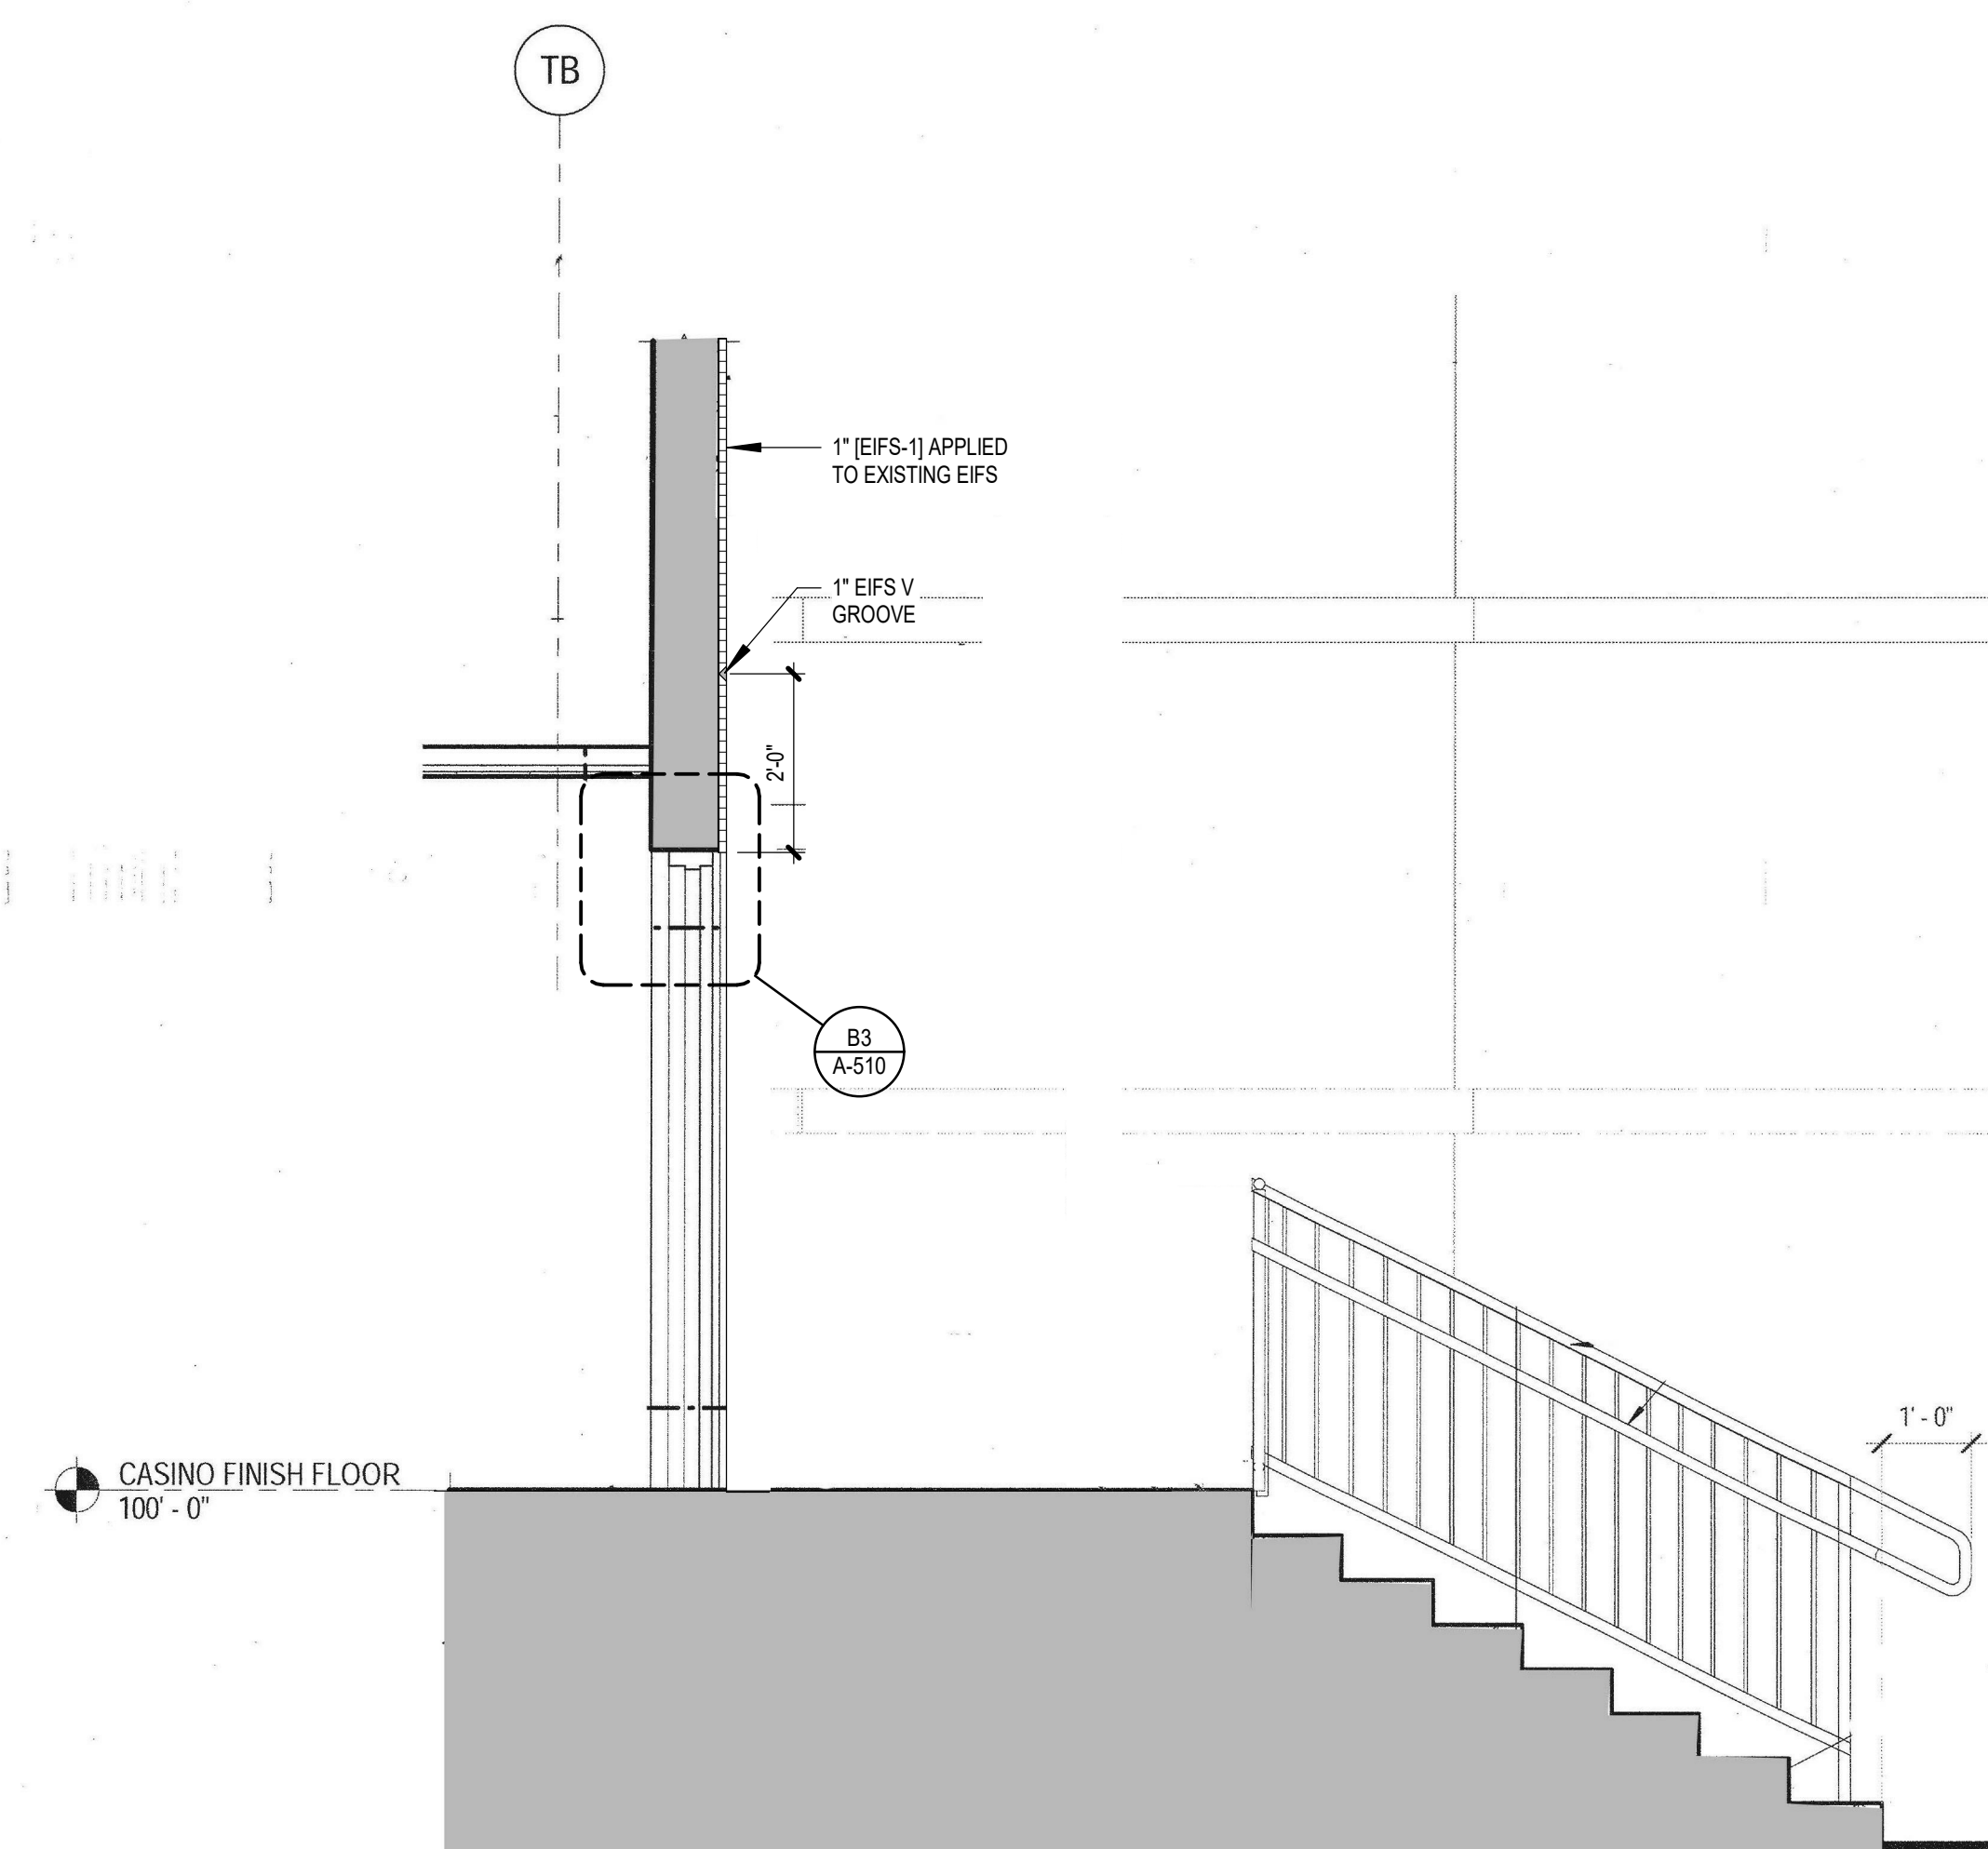
Cherokee Hard Rock Hotel & Casino




A1 EAST WALL SECTION @ BRACED FRAMING
1/2" = 1'-0"



D2 TYP. EIFS BANDING DETAIL
3" = 1'-0"



A2 Detail Handrail @ Theater Exit/Lobby Exterior
1/2" = 1'-0"

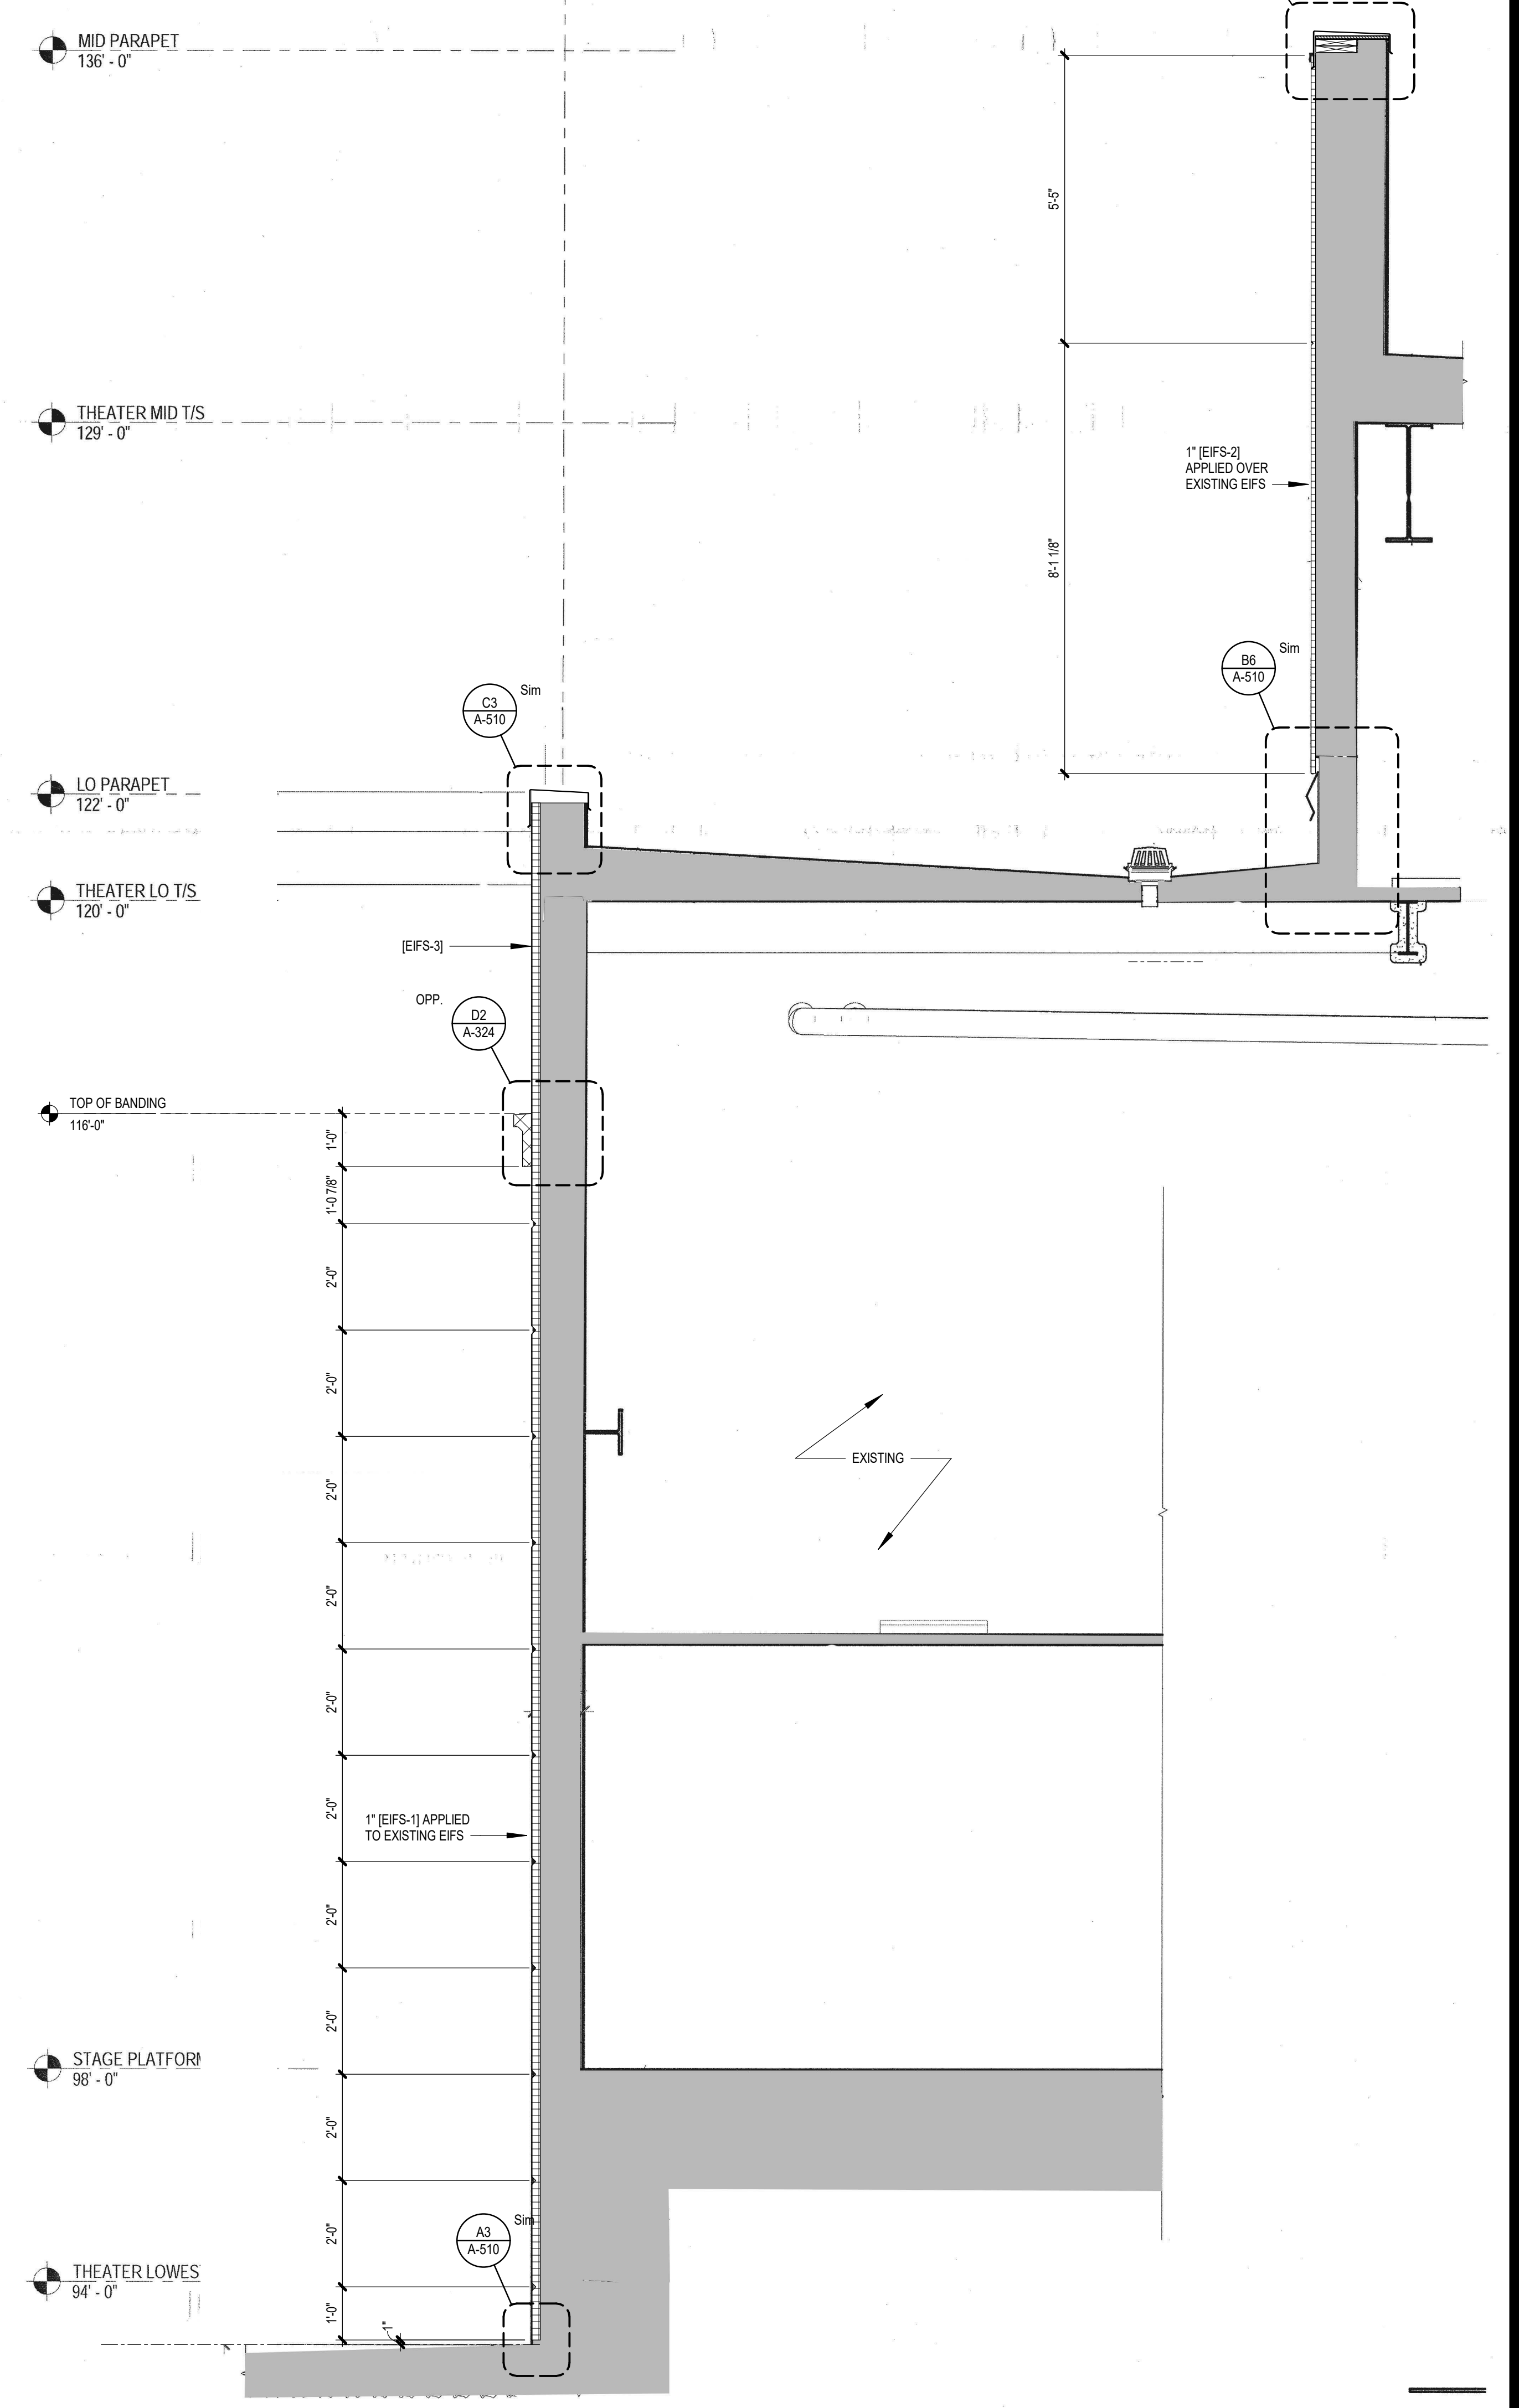


A4 Wall Section @ East Wall
1/2" = 1'-0"

12/19/2016 5:58:32 PM

EXTERIOR FACADE RENOVATION

KEY PLAN

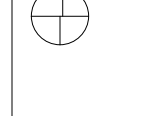

No.	Description	Date


SHEET TITLE: WALL SECTIONS

PROGRESS SET

PROJECT NO:	H17018.01
OWNER:	AMD
DRAWN BY:	GEF
ISSUE DATE:	10/26/2018

A-324

Scale: As indicated

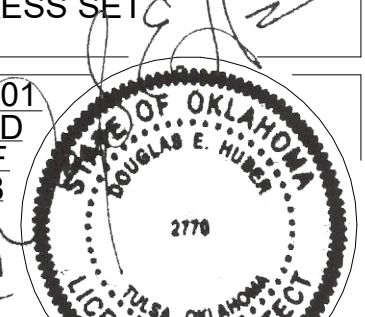



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 Fax: (917) 276-1242

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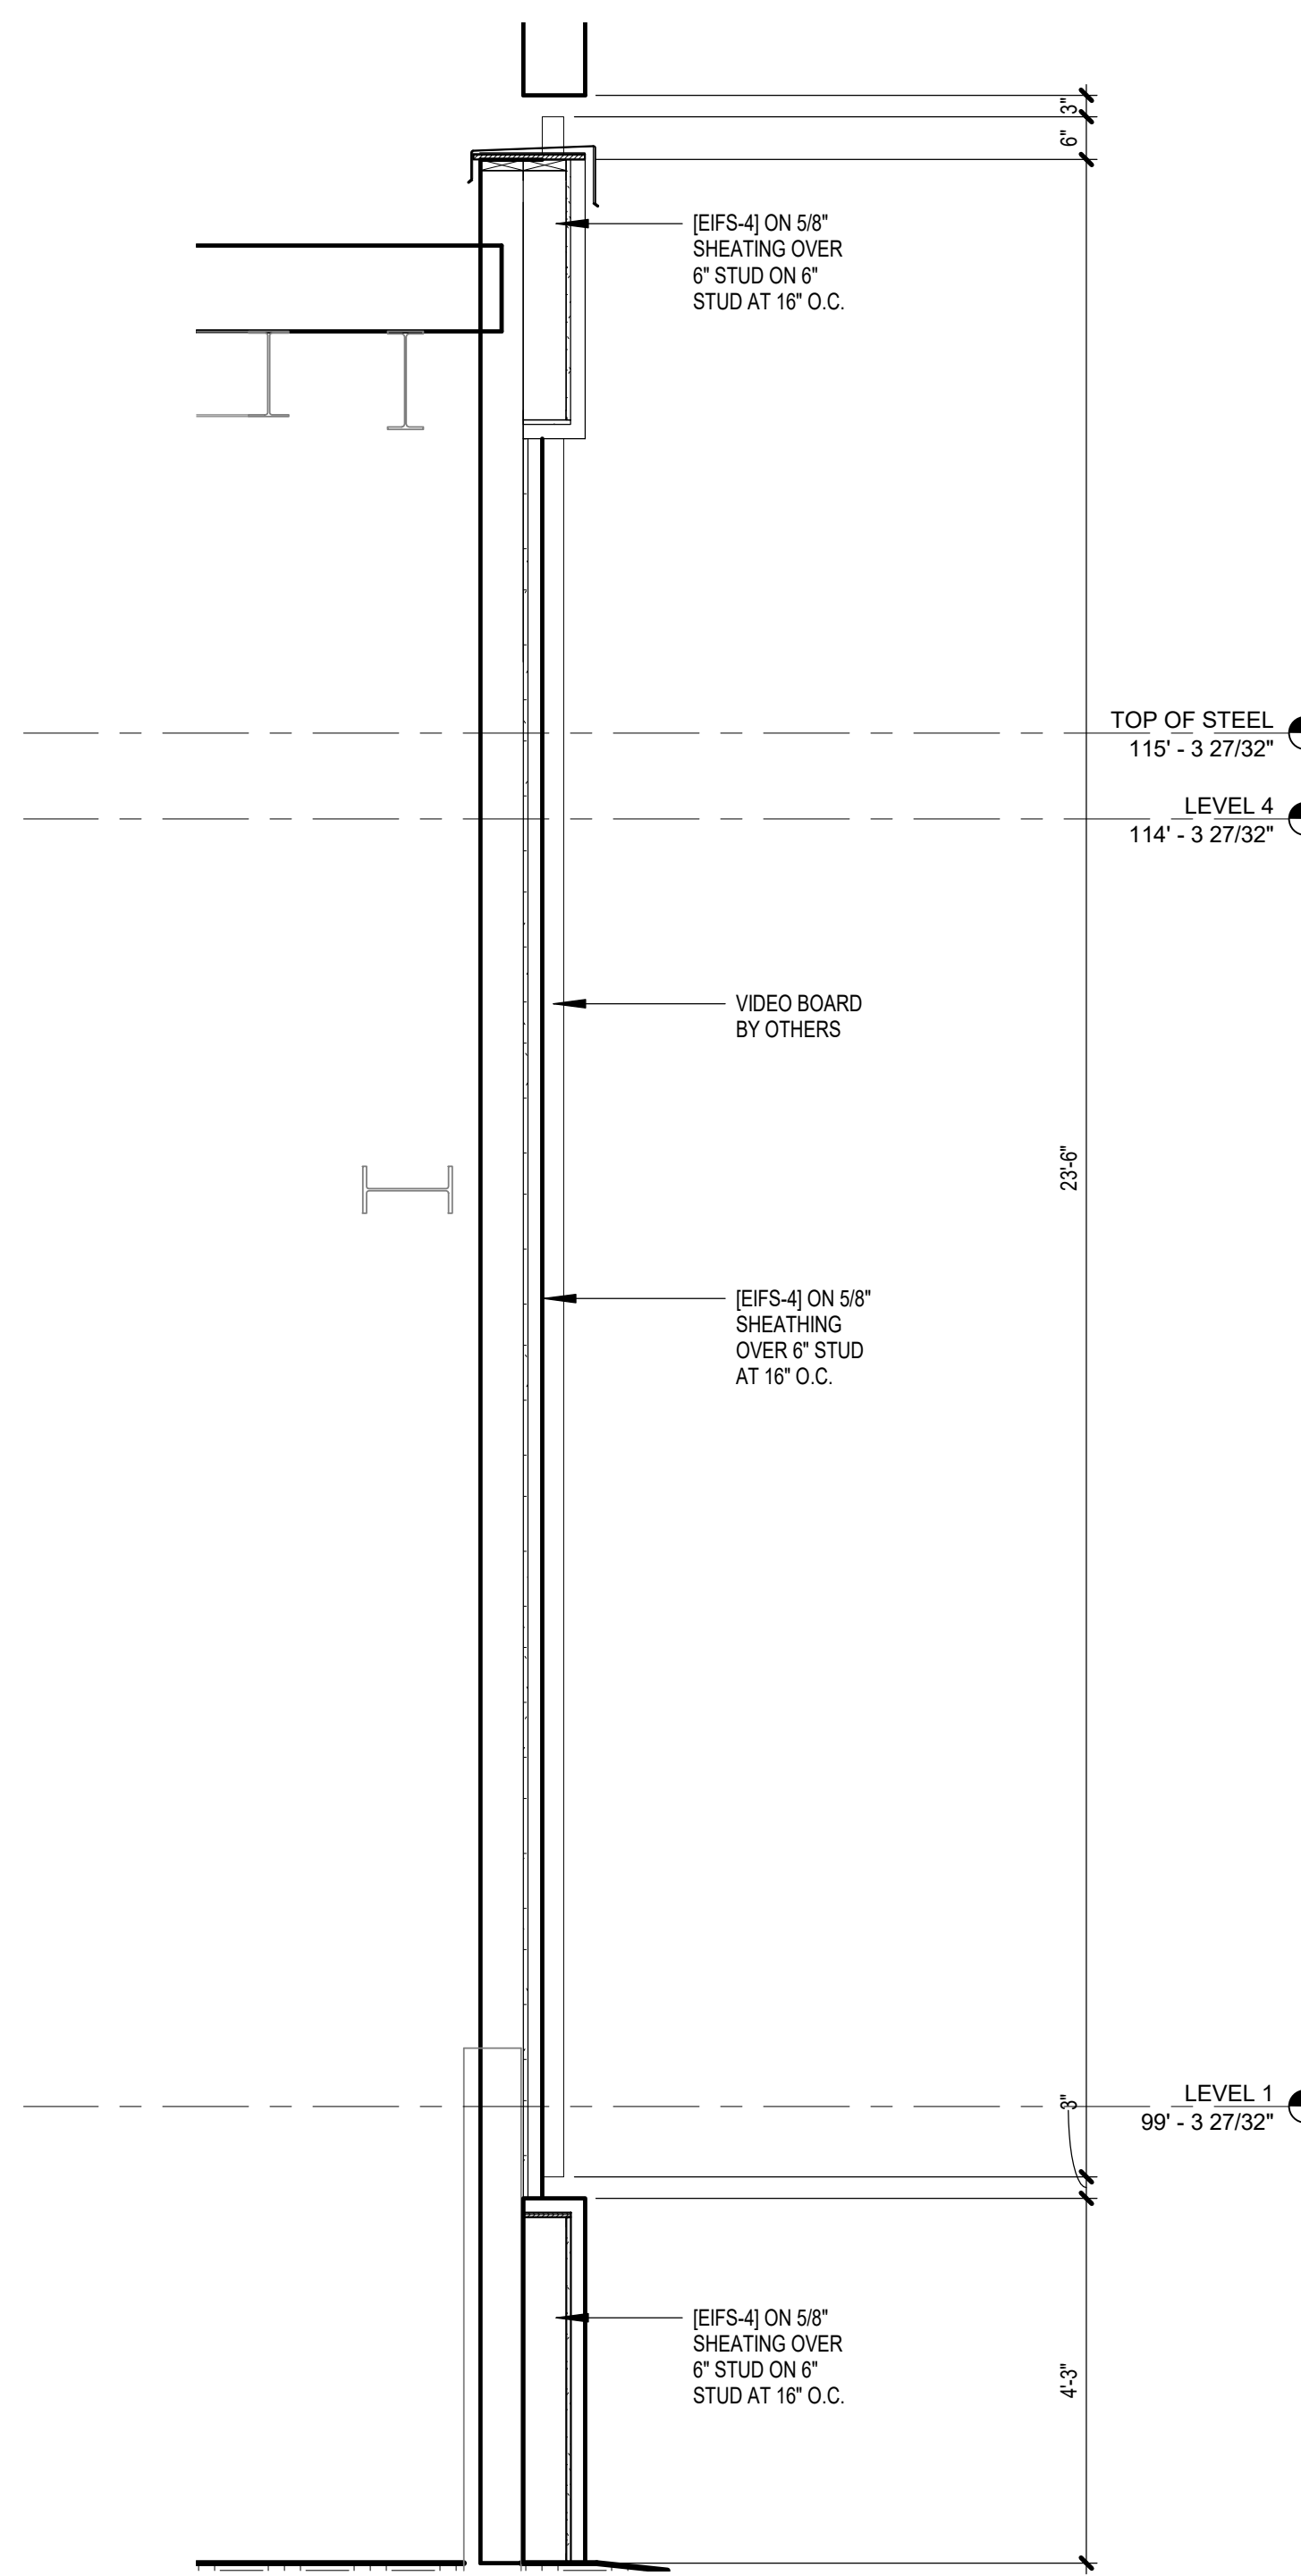
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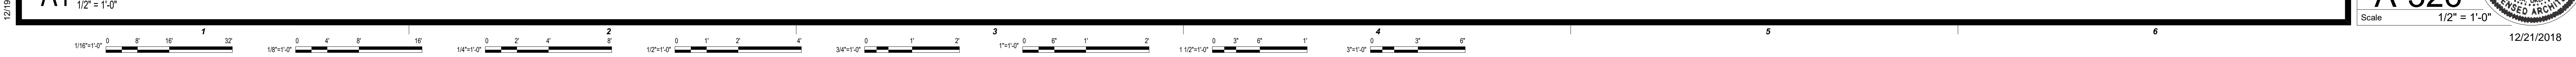
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Cherokee Hard Rock Hotel & Casino




A1 ANGLED FACADE WALL SECTION



EXTERIOR FACADE RENOVATION

KEY PLAN

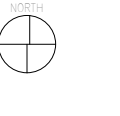


No.	Description	Date

WALL SECTIONS

PROGRESS SET

PROJECT NO: H17018.01
 DRAWN BY: Author
 CHECK BY: Checker
 ISSUE DATE: 10/26/2018

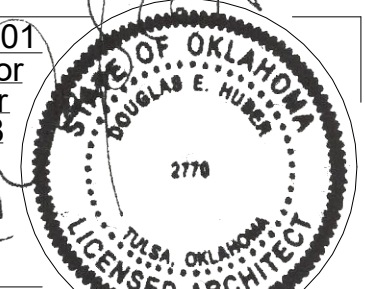

A-326

Scale 1/2" = 1'-0"

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370 E. Windmill Ln
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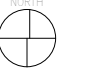
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60 Lakelront Boulevard
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Buffalo, NY 14202
716-845-5092

Cherokee Hard Rock Hotel & Casino

EXTERIOR FACADE RENOVATION

KEY PLAN




No.	Description	Date


SHEET TITLE
ENLARGED FLOOR PLANS

PROGRESS SET


PROJECT NO: H17018.01
DRAWN BY: Author
CHECKED BY: Checker
ISSUE DATE: 10/26/2018

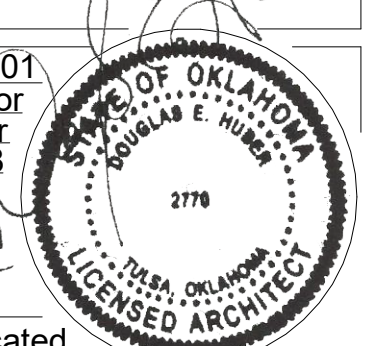

A-410
Scale As indicated

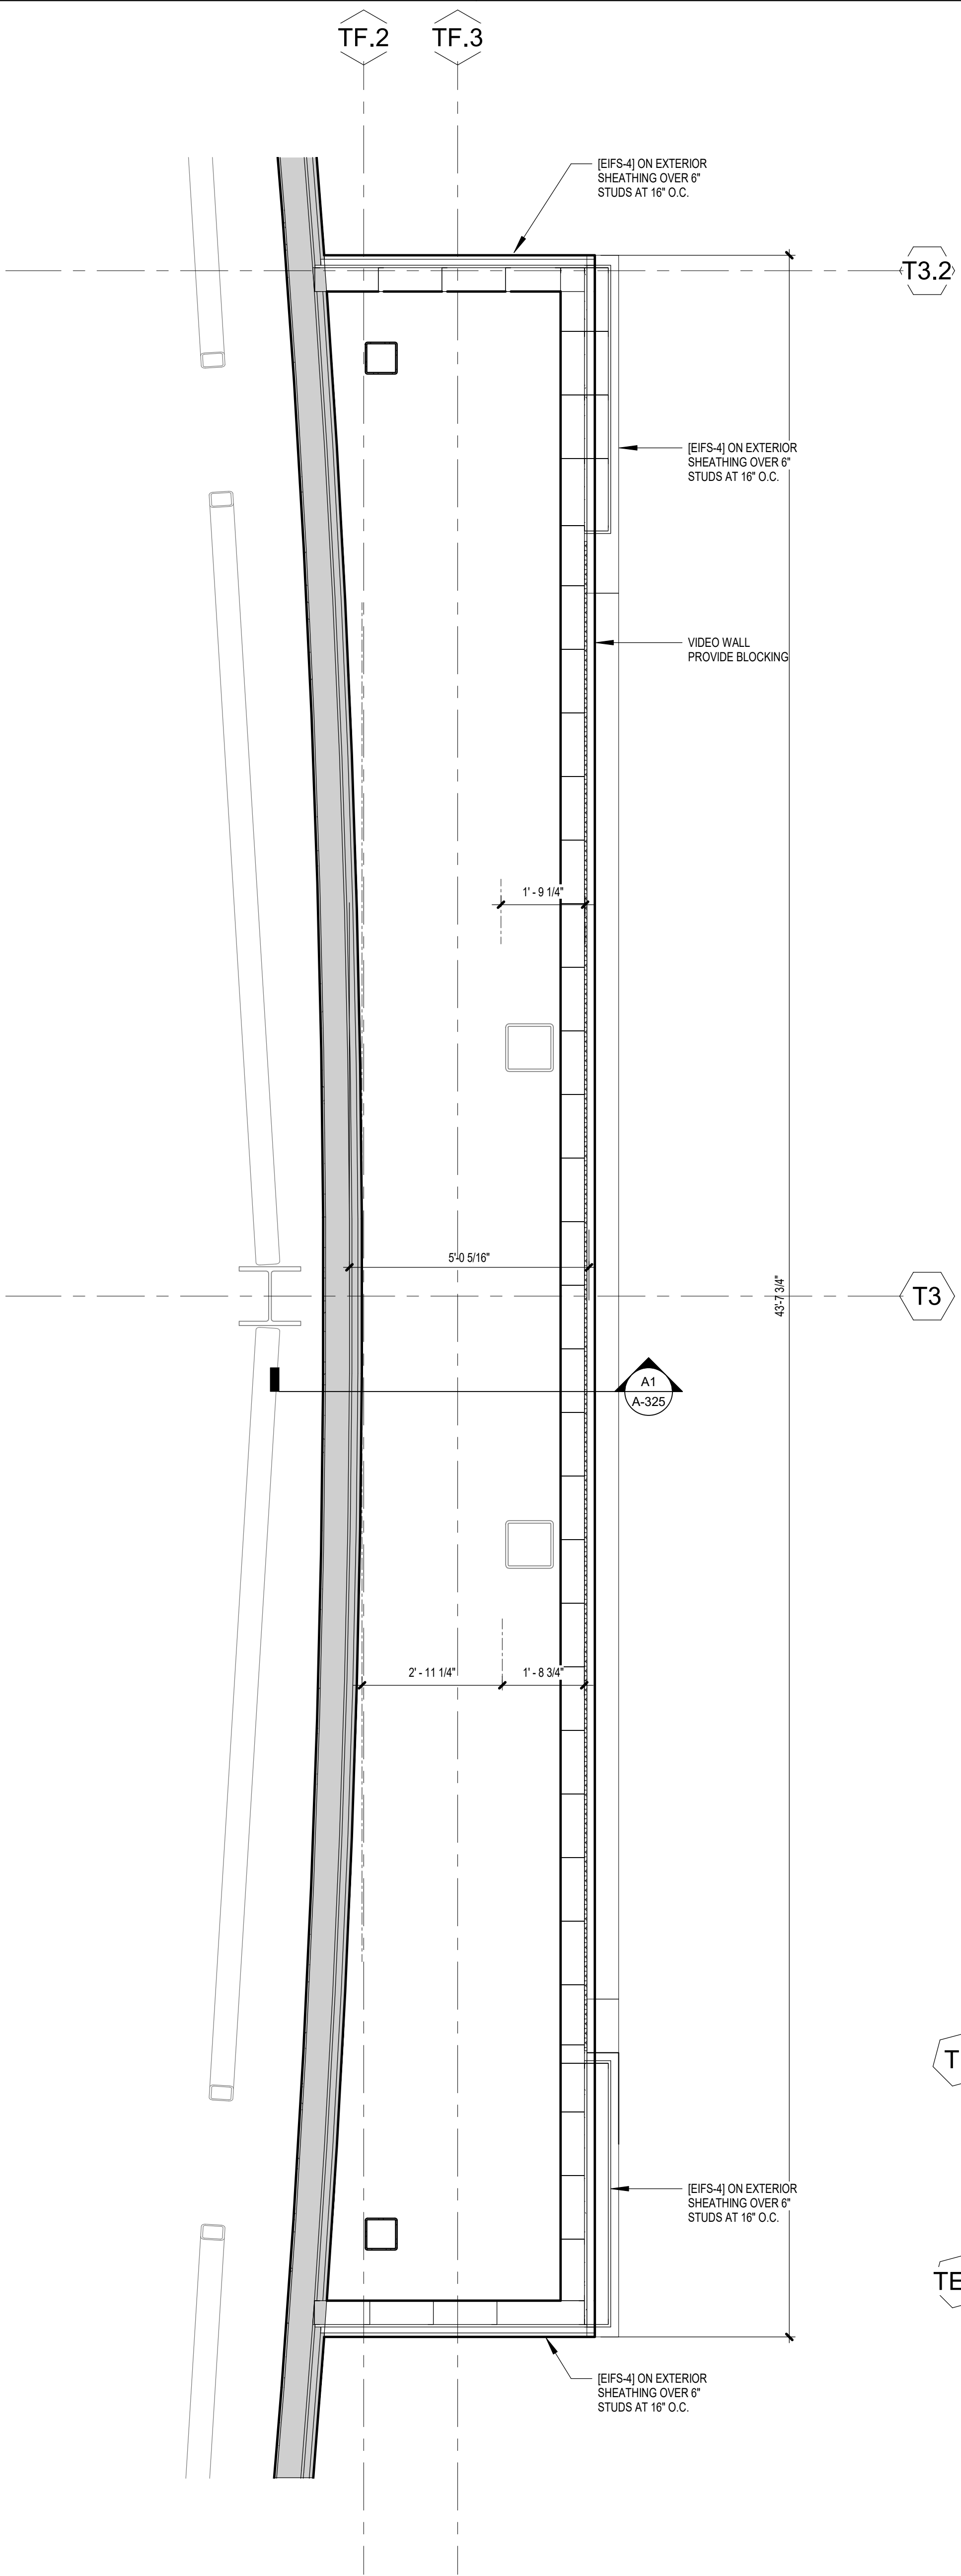

A1 ENLARGED FRONT FACADE
1/2" = 1'-0"

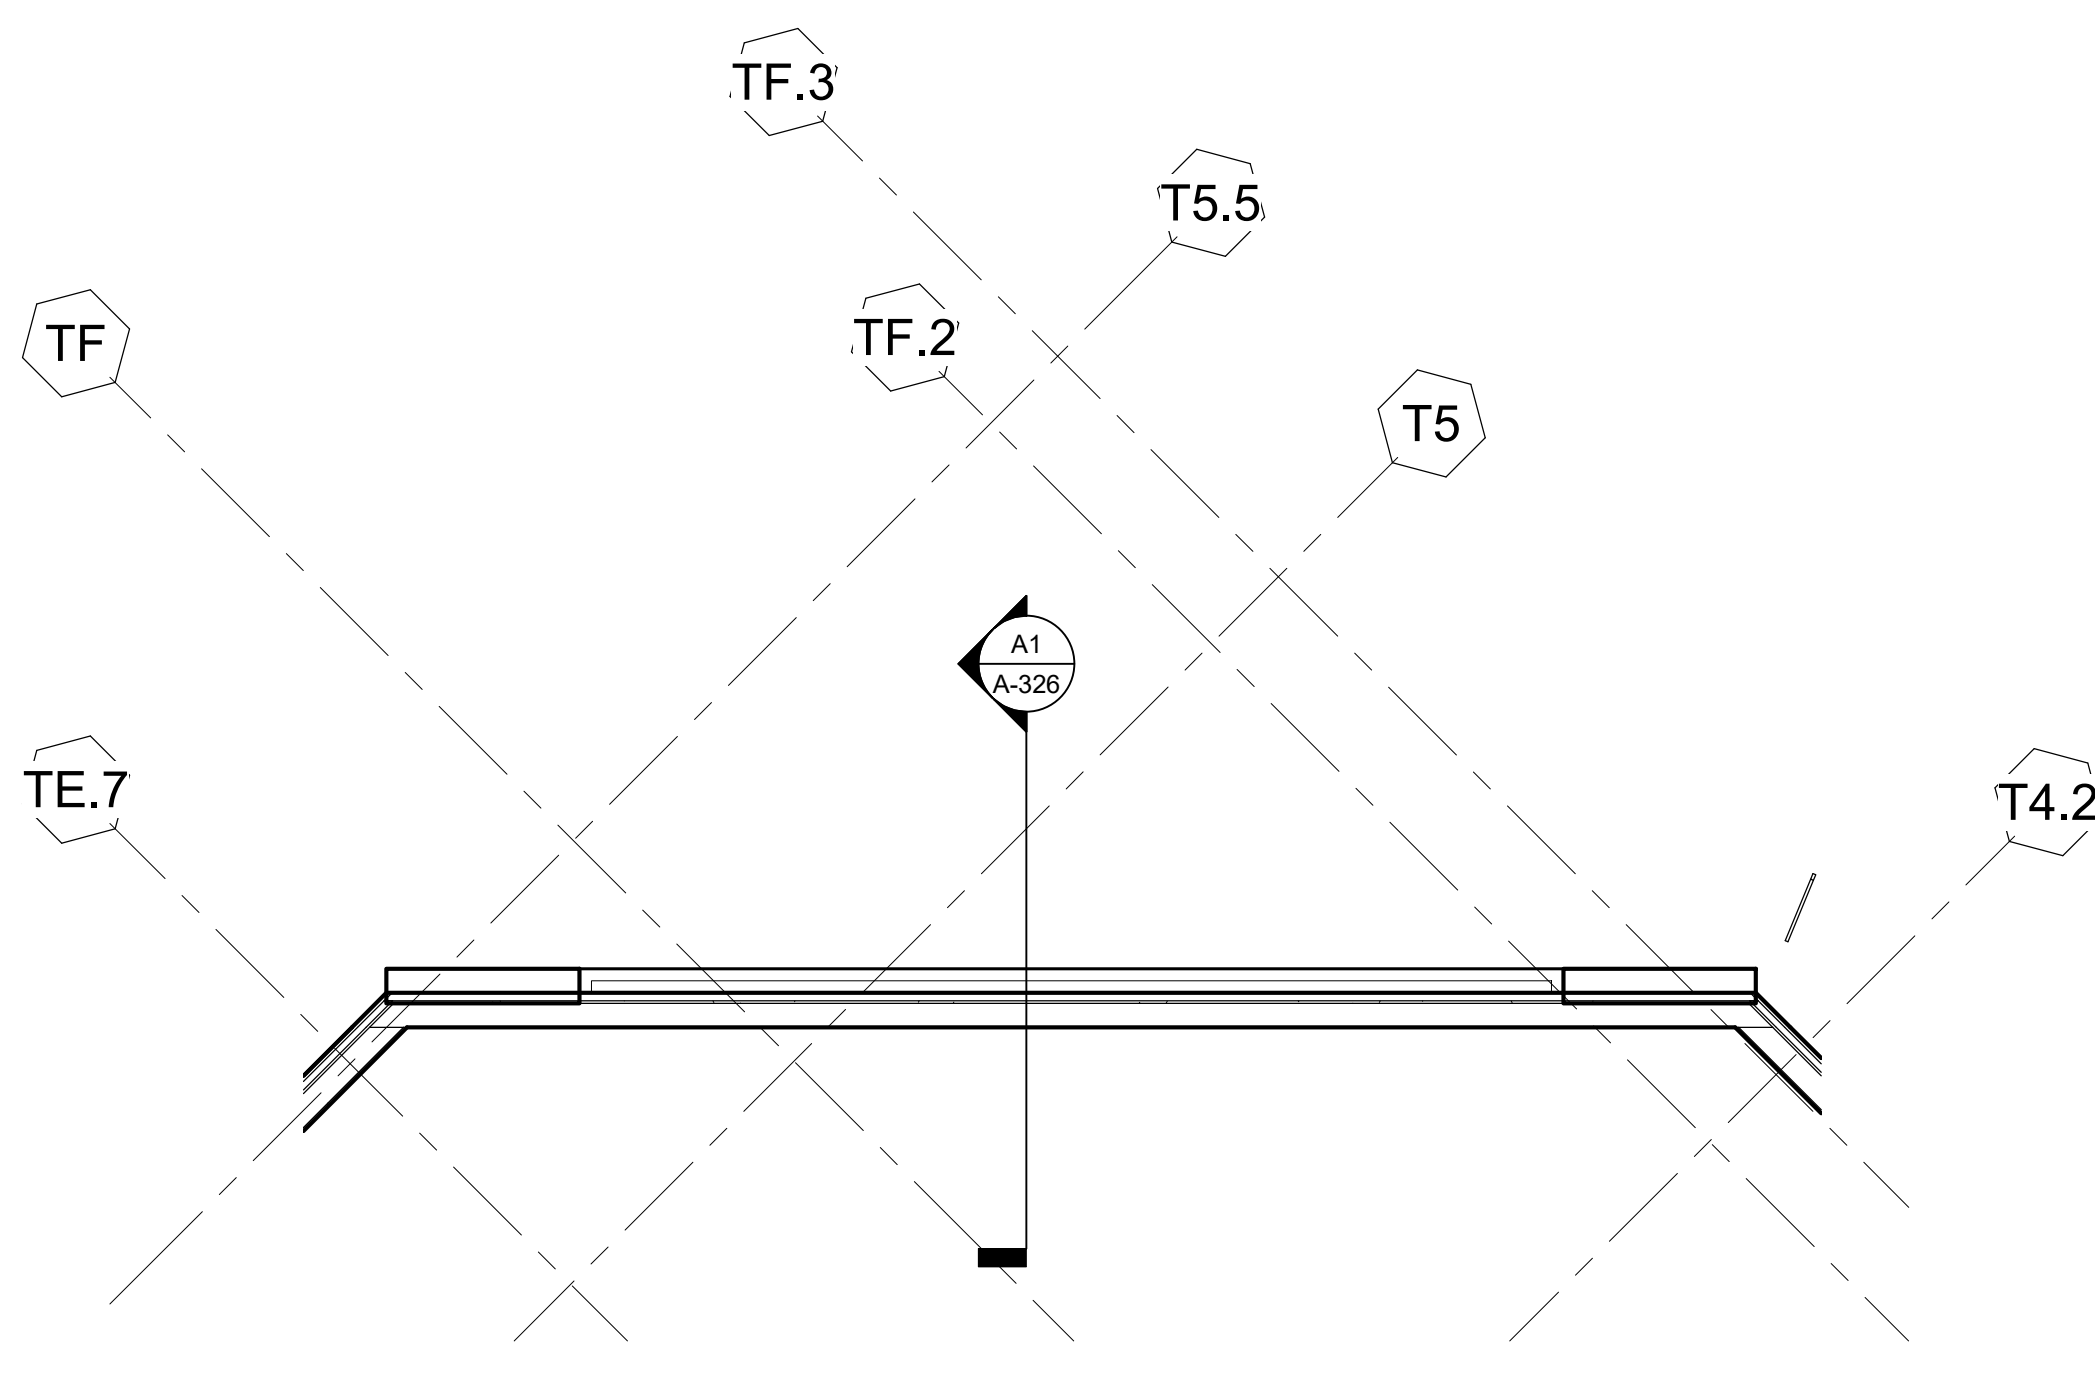

A2 PLAN DETAIL AT ANGLED FACADE
1/4" = 1'-0"

12/19/2018 5:59:41 PM



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716-845-5092

Cherokee Hard Rock Hotel & Casino

EXTERIOR FACADE RENOVATION

KEY PLAN


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CONSTRUCTION SET


PROJECT NO: H17018
DRAWN BY: BJB
CHECKED BY: DH
ISSUE DATE: 12/21/2018

Scale As indicated

A-500
Scale As indicated

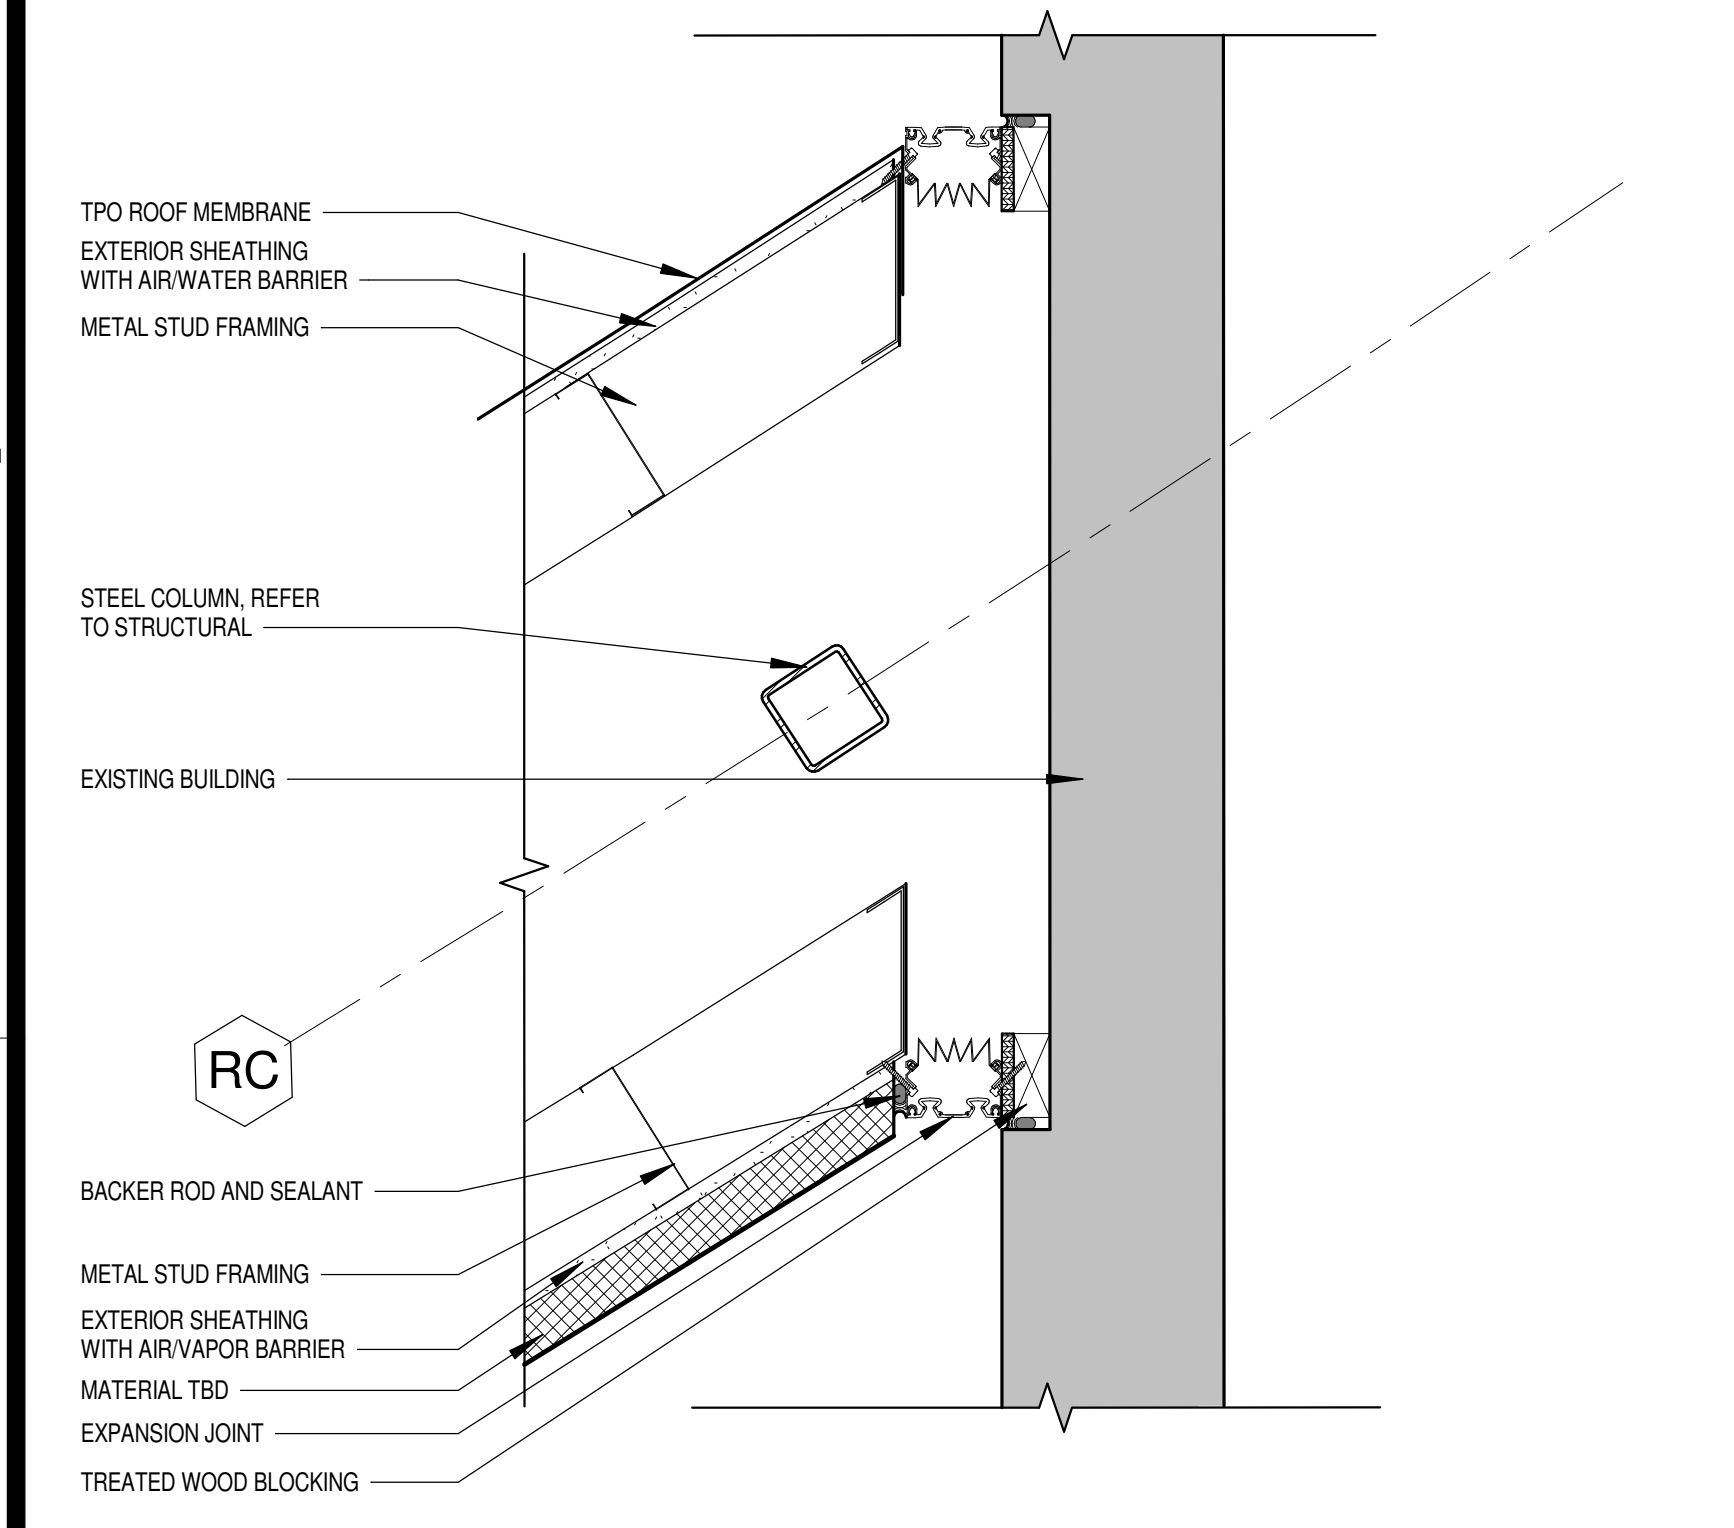


D1 PLAN DETAIL - EXPANSION JOINT
SCALE: 1 1/2" = 1'-0"

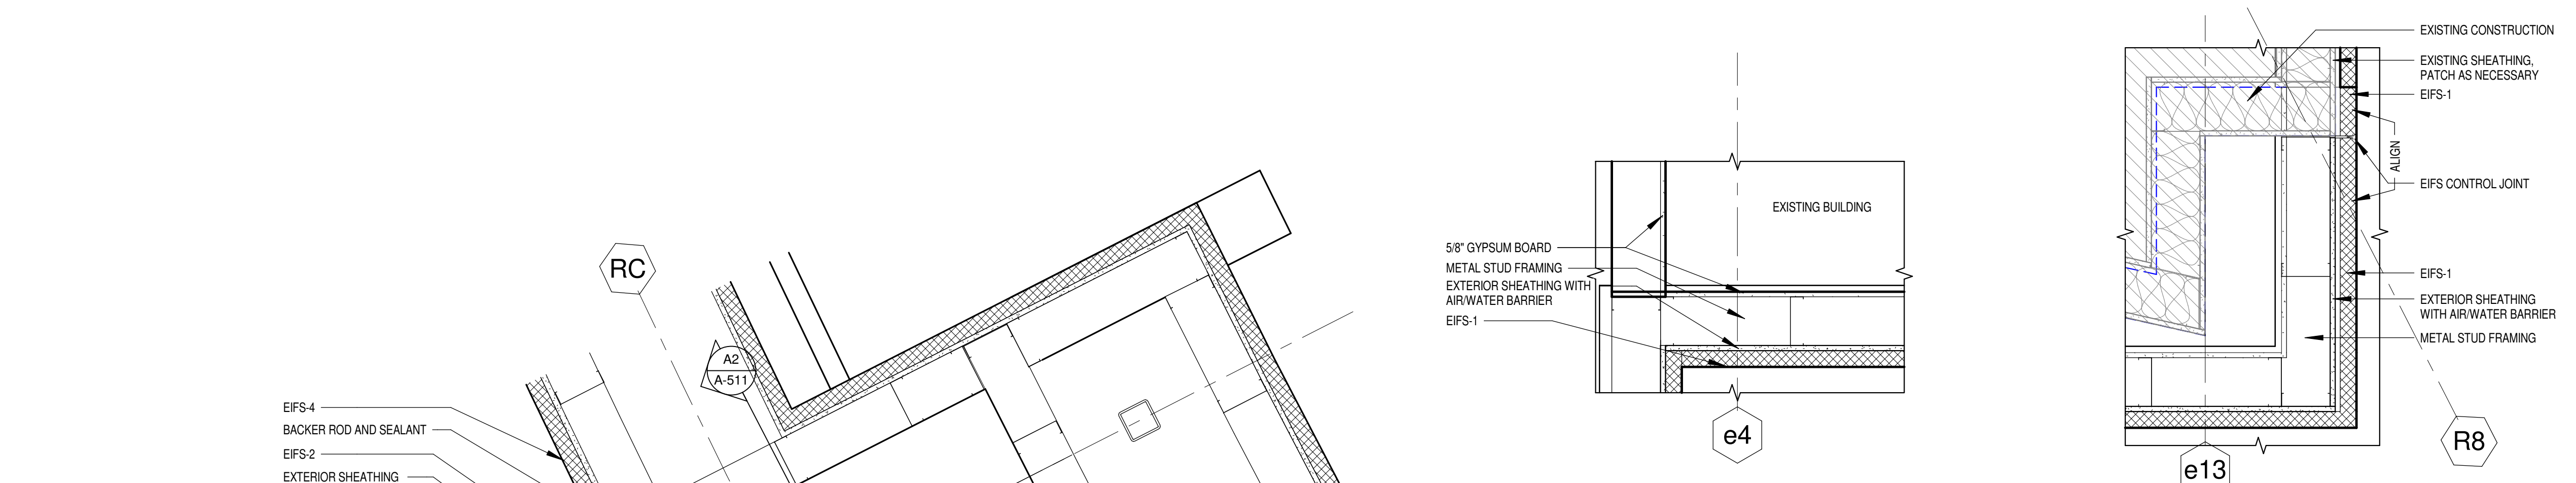


E5 PLAN DETAIL
SCALE: 1" = 1'-0"

E6 PLAN DETAIL
SCALE: 1" = 1'-0"

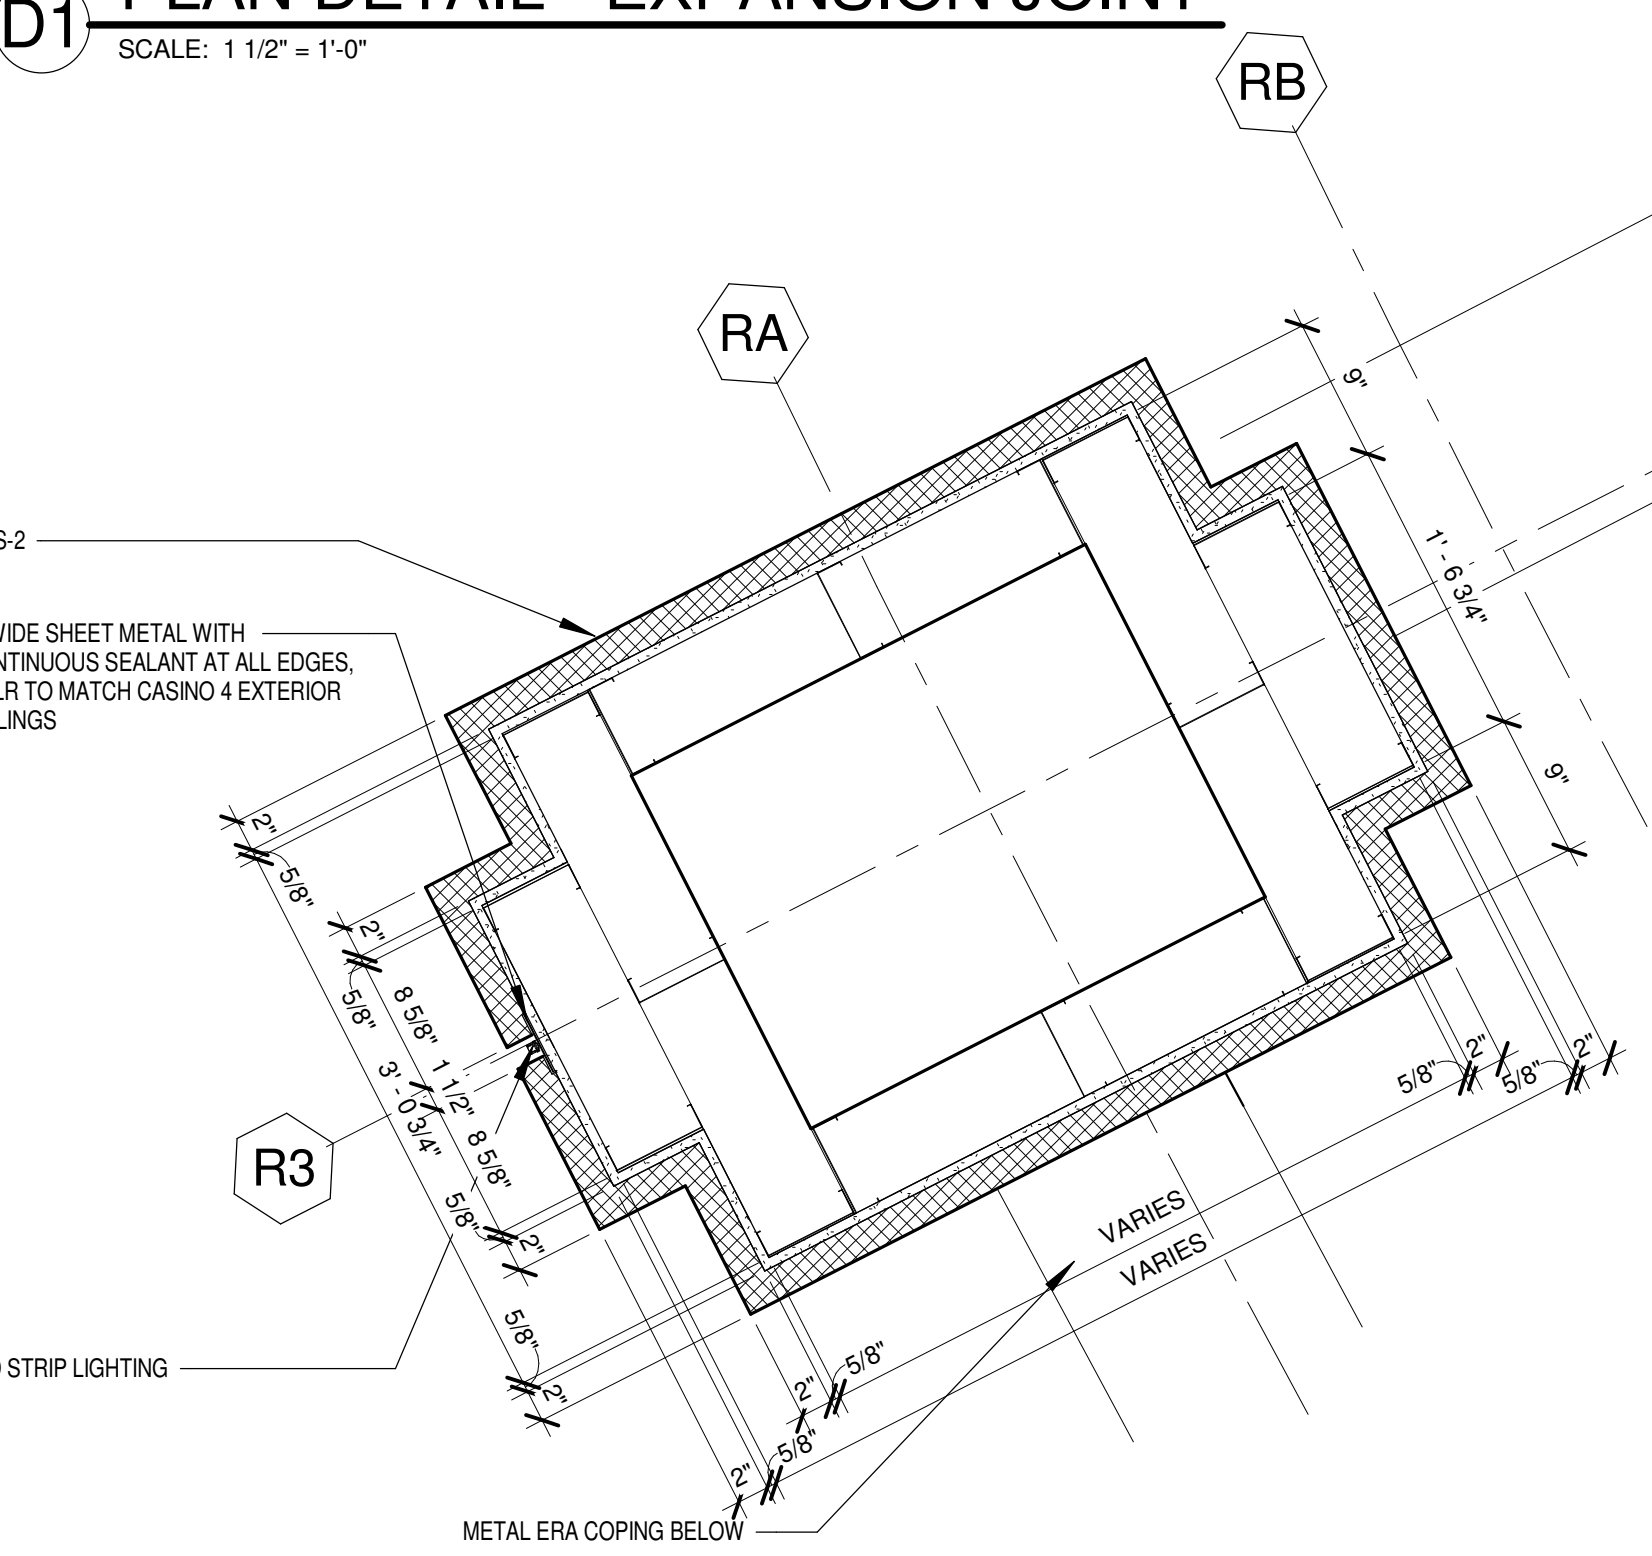


B1 PILASTER PLAN DETAIL - ABOVE ROOF
SCALE: 1" = 1'-0"

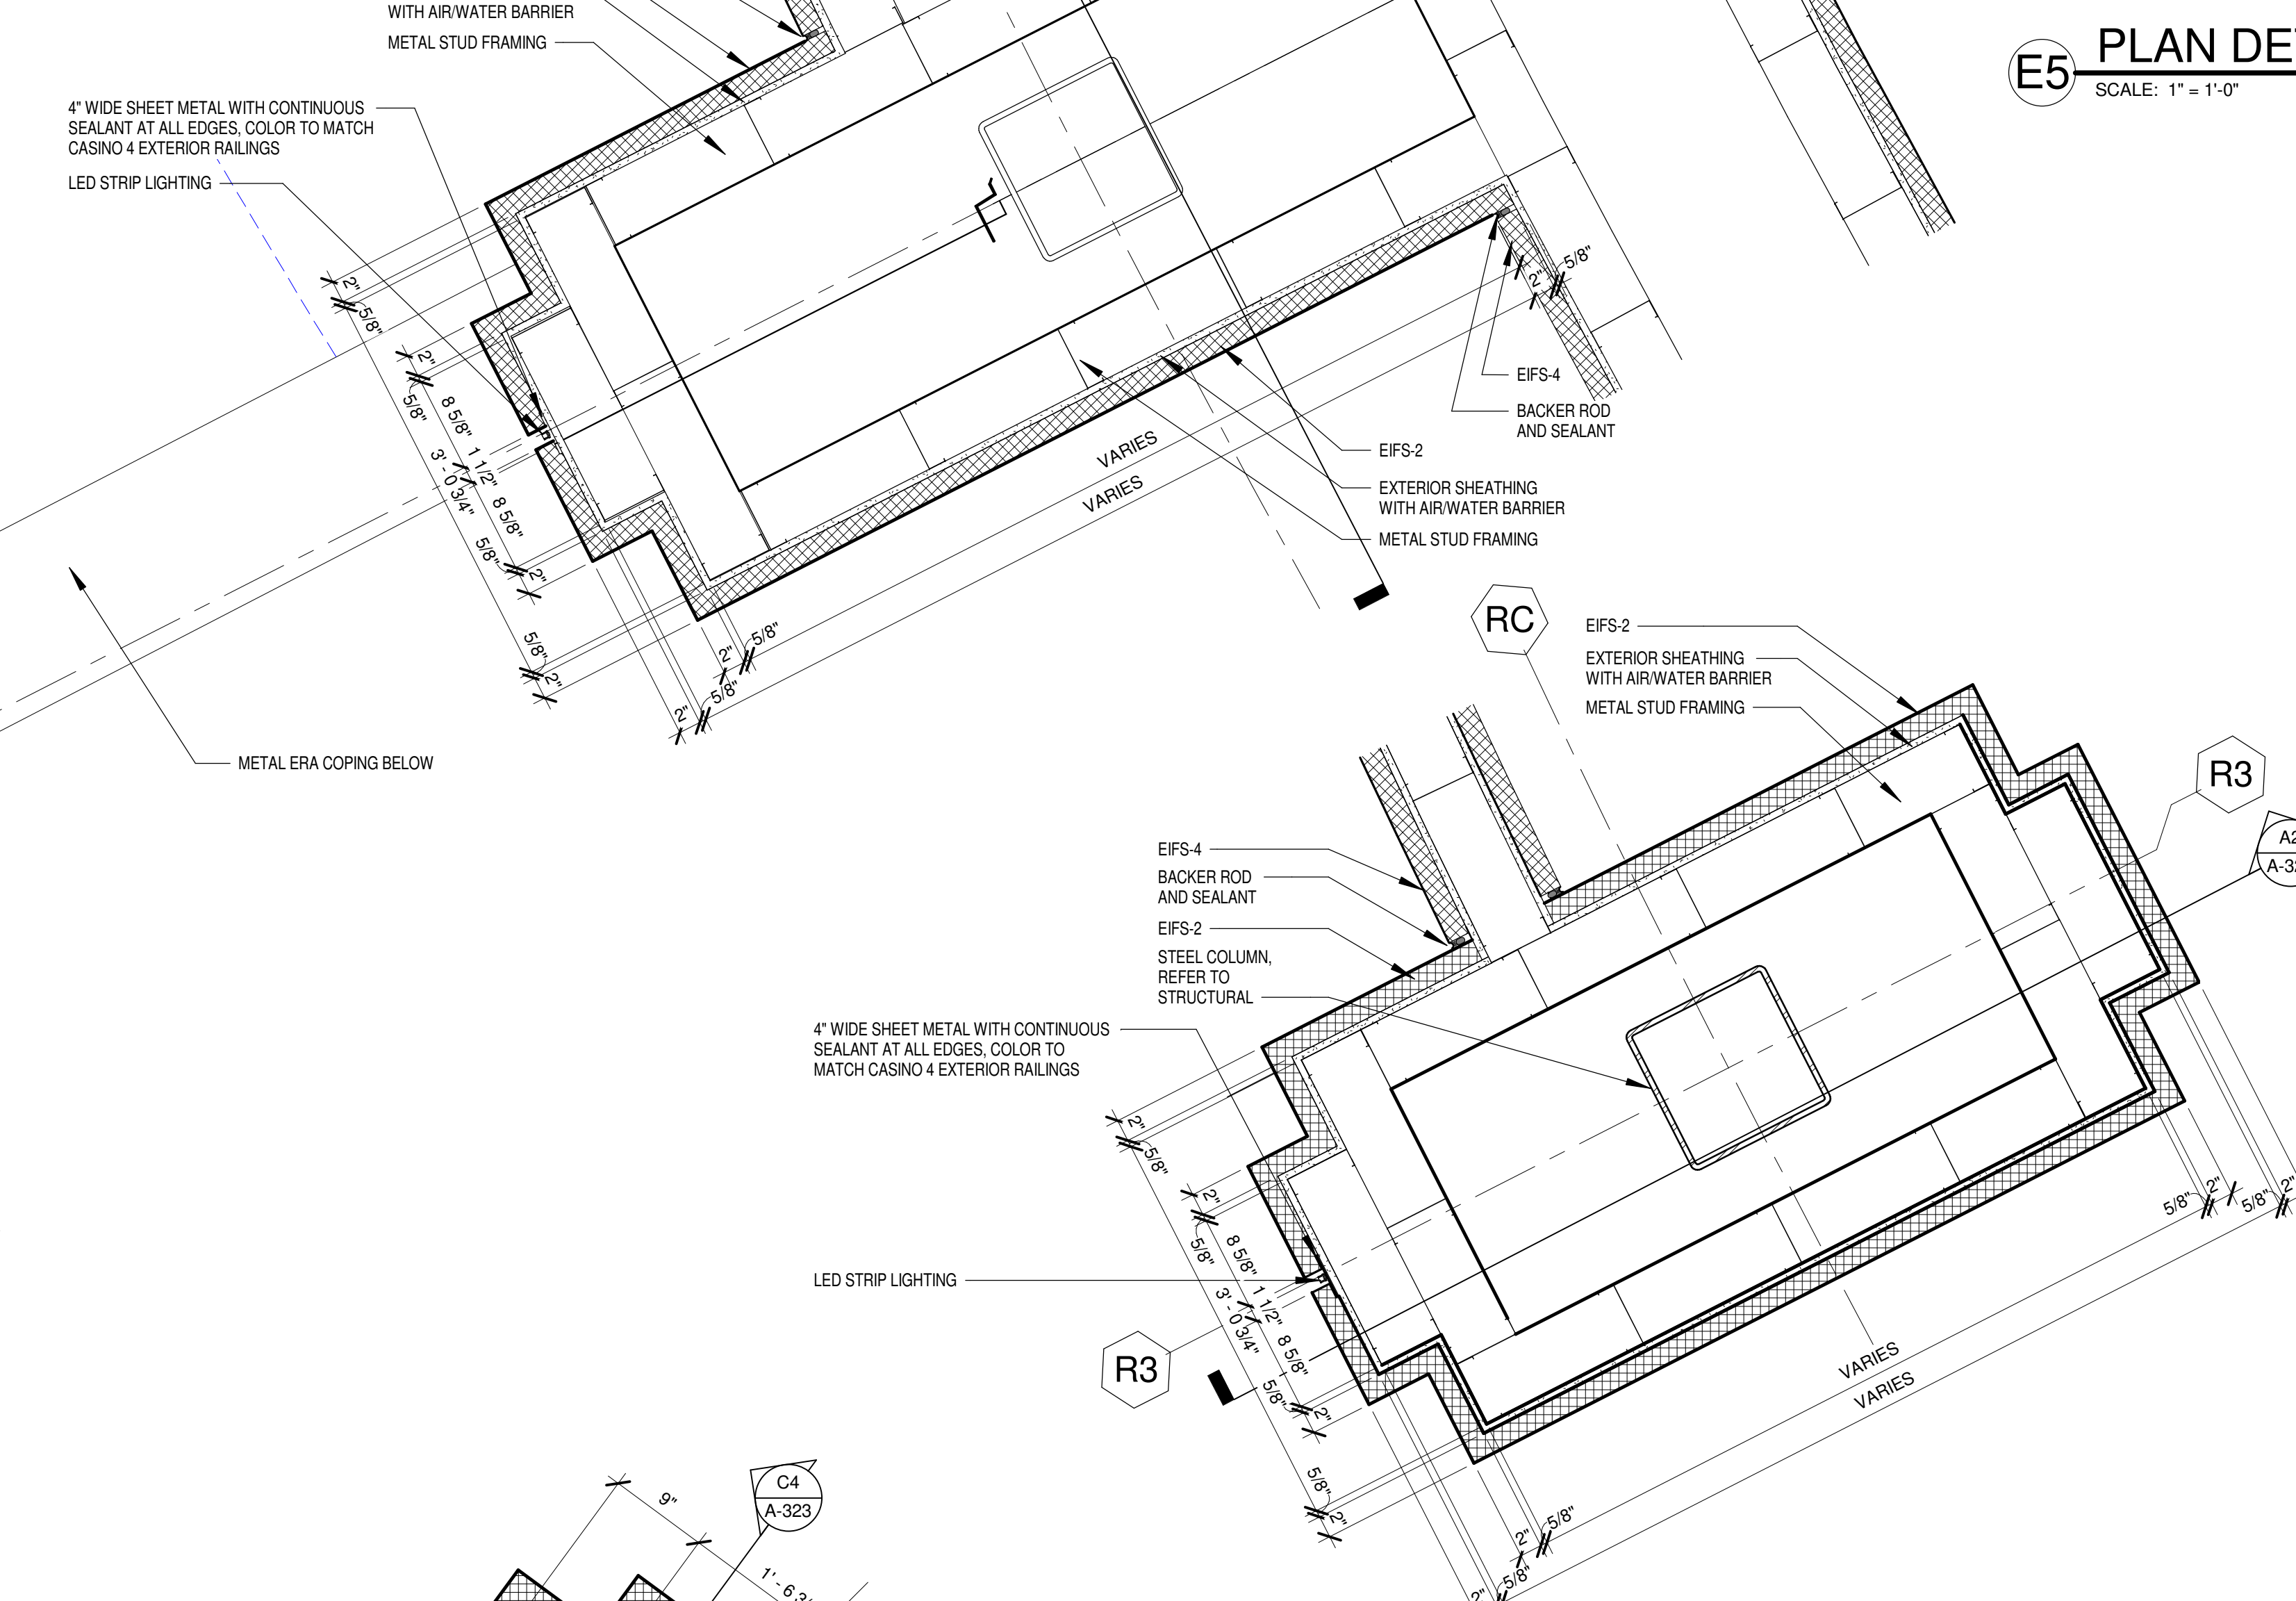


B4 PILASTER PLAN DETAIL
SCALE: 1" = 1'-0"


B6 PILASTER PLAN DETAIL
SCALE: 1" = 1'-0"

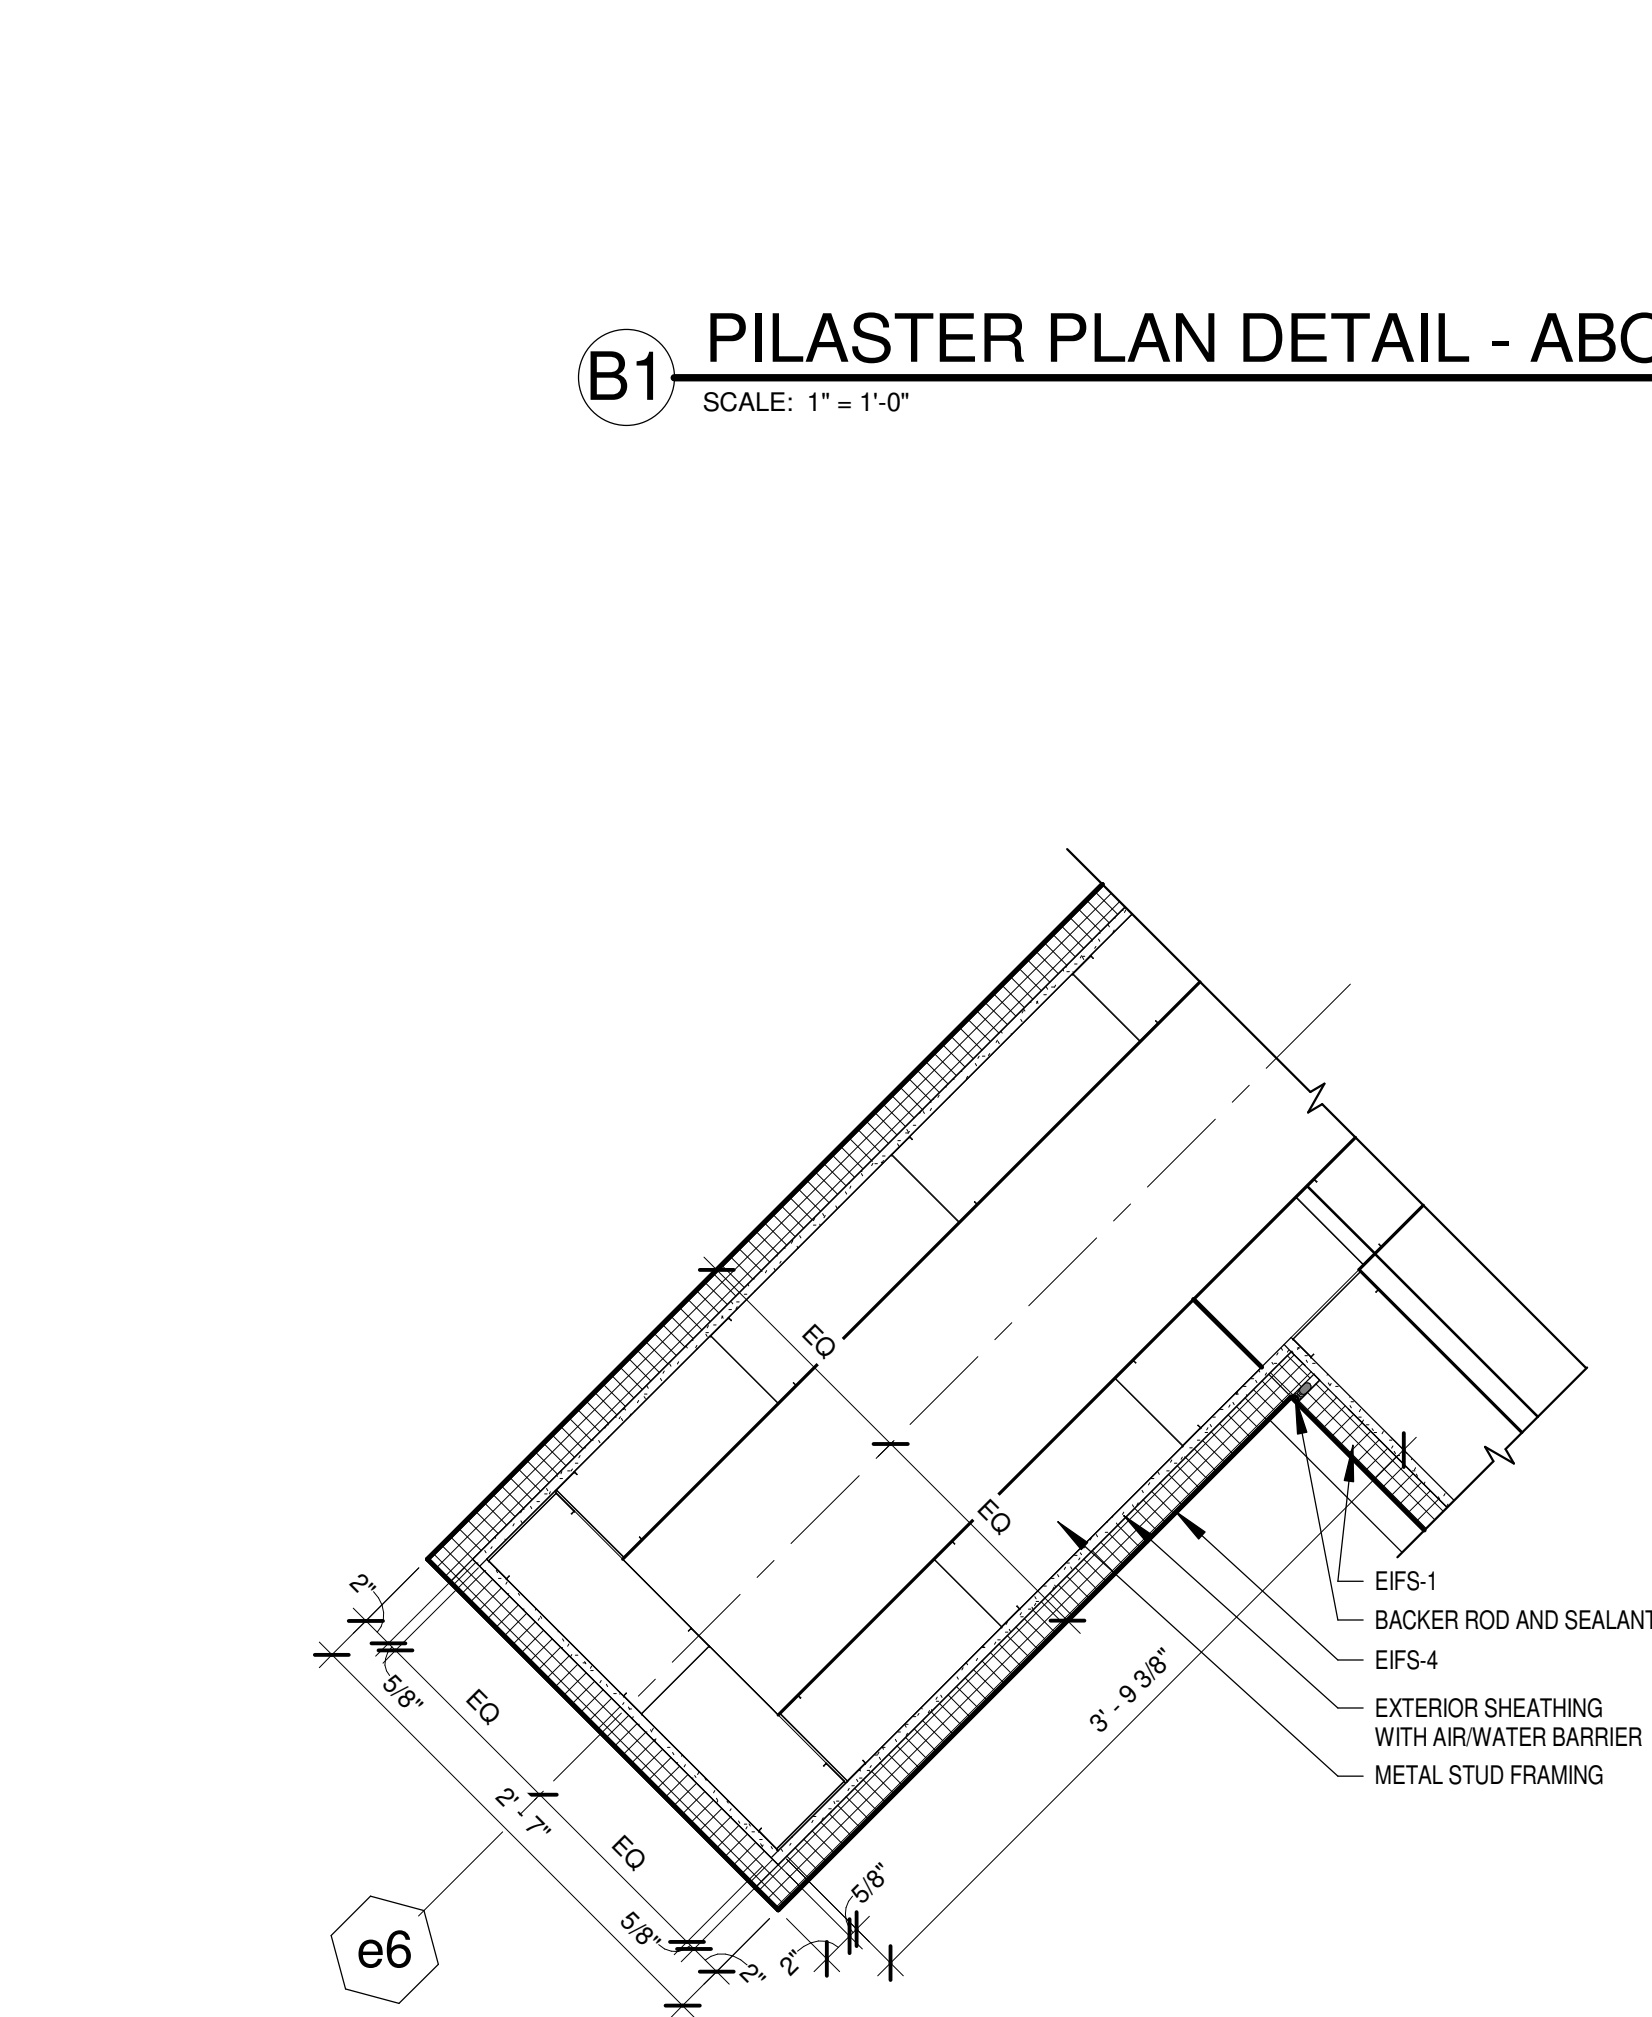


A2 COLUMN PLAN DETAIL
SCALE: 1" = 1'-0"

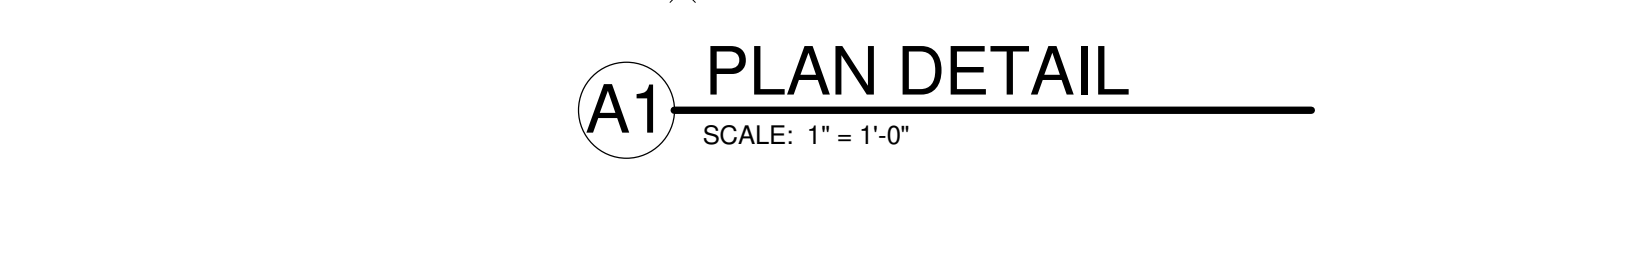

A1 PLAN DETAIL
SCALE: 1" = 1'-0"

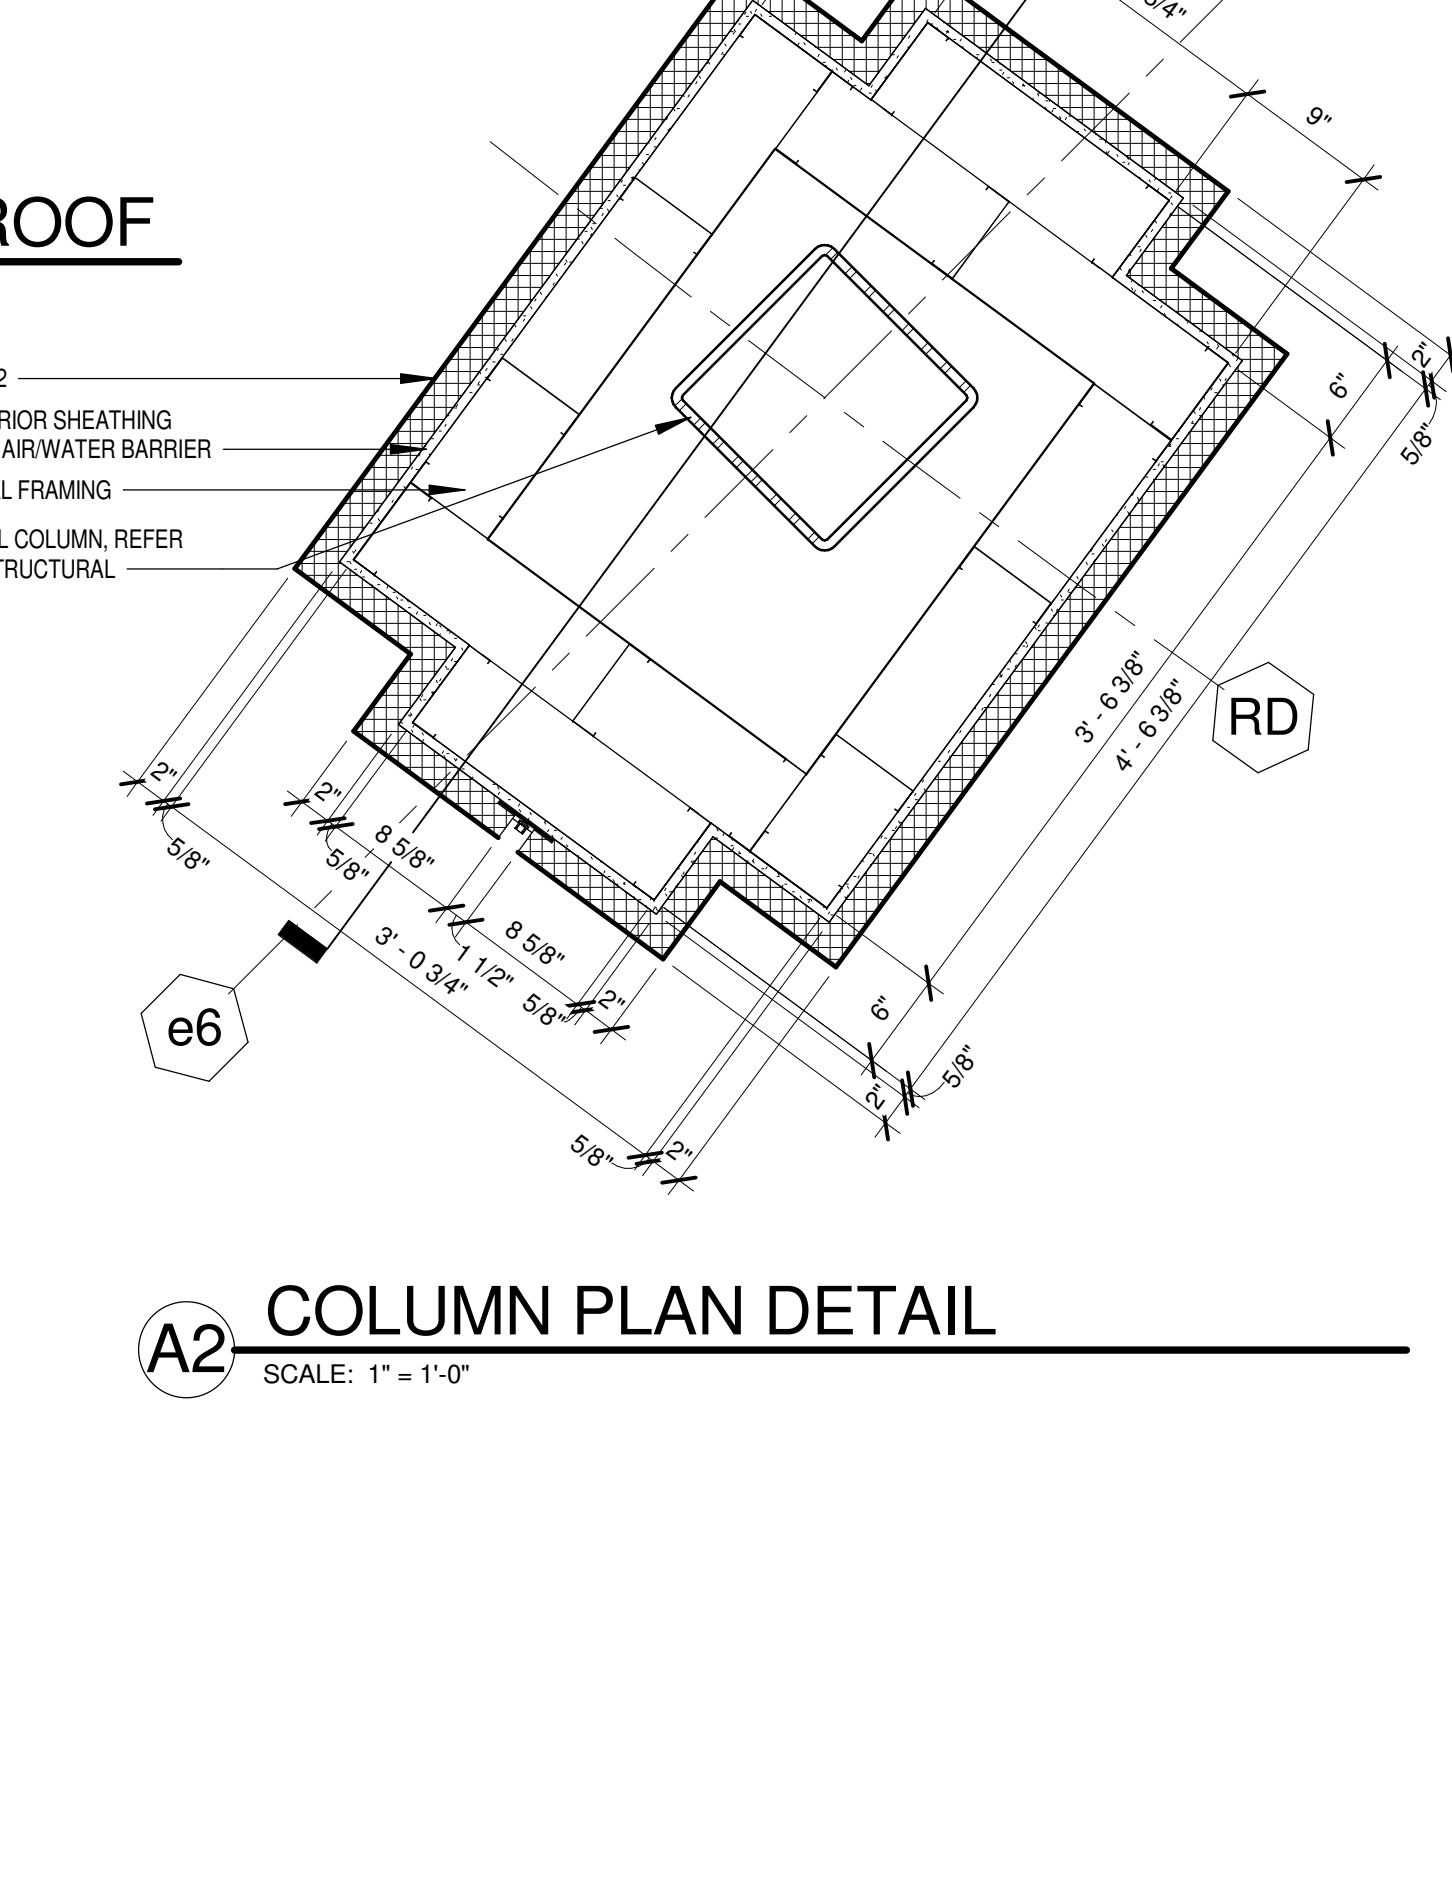

A4 PILASTER PLAN DETAIL
SCALE: 1" = 1'-0"

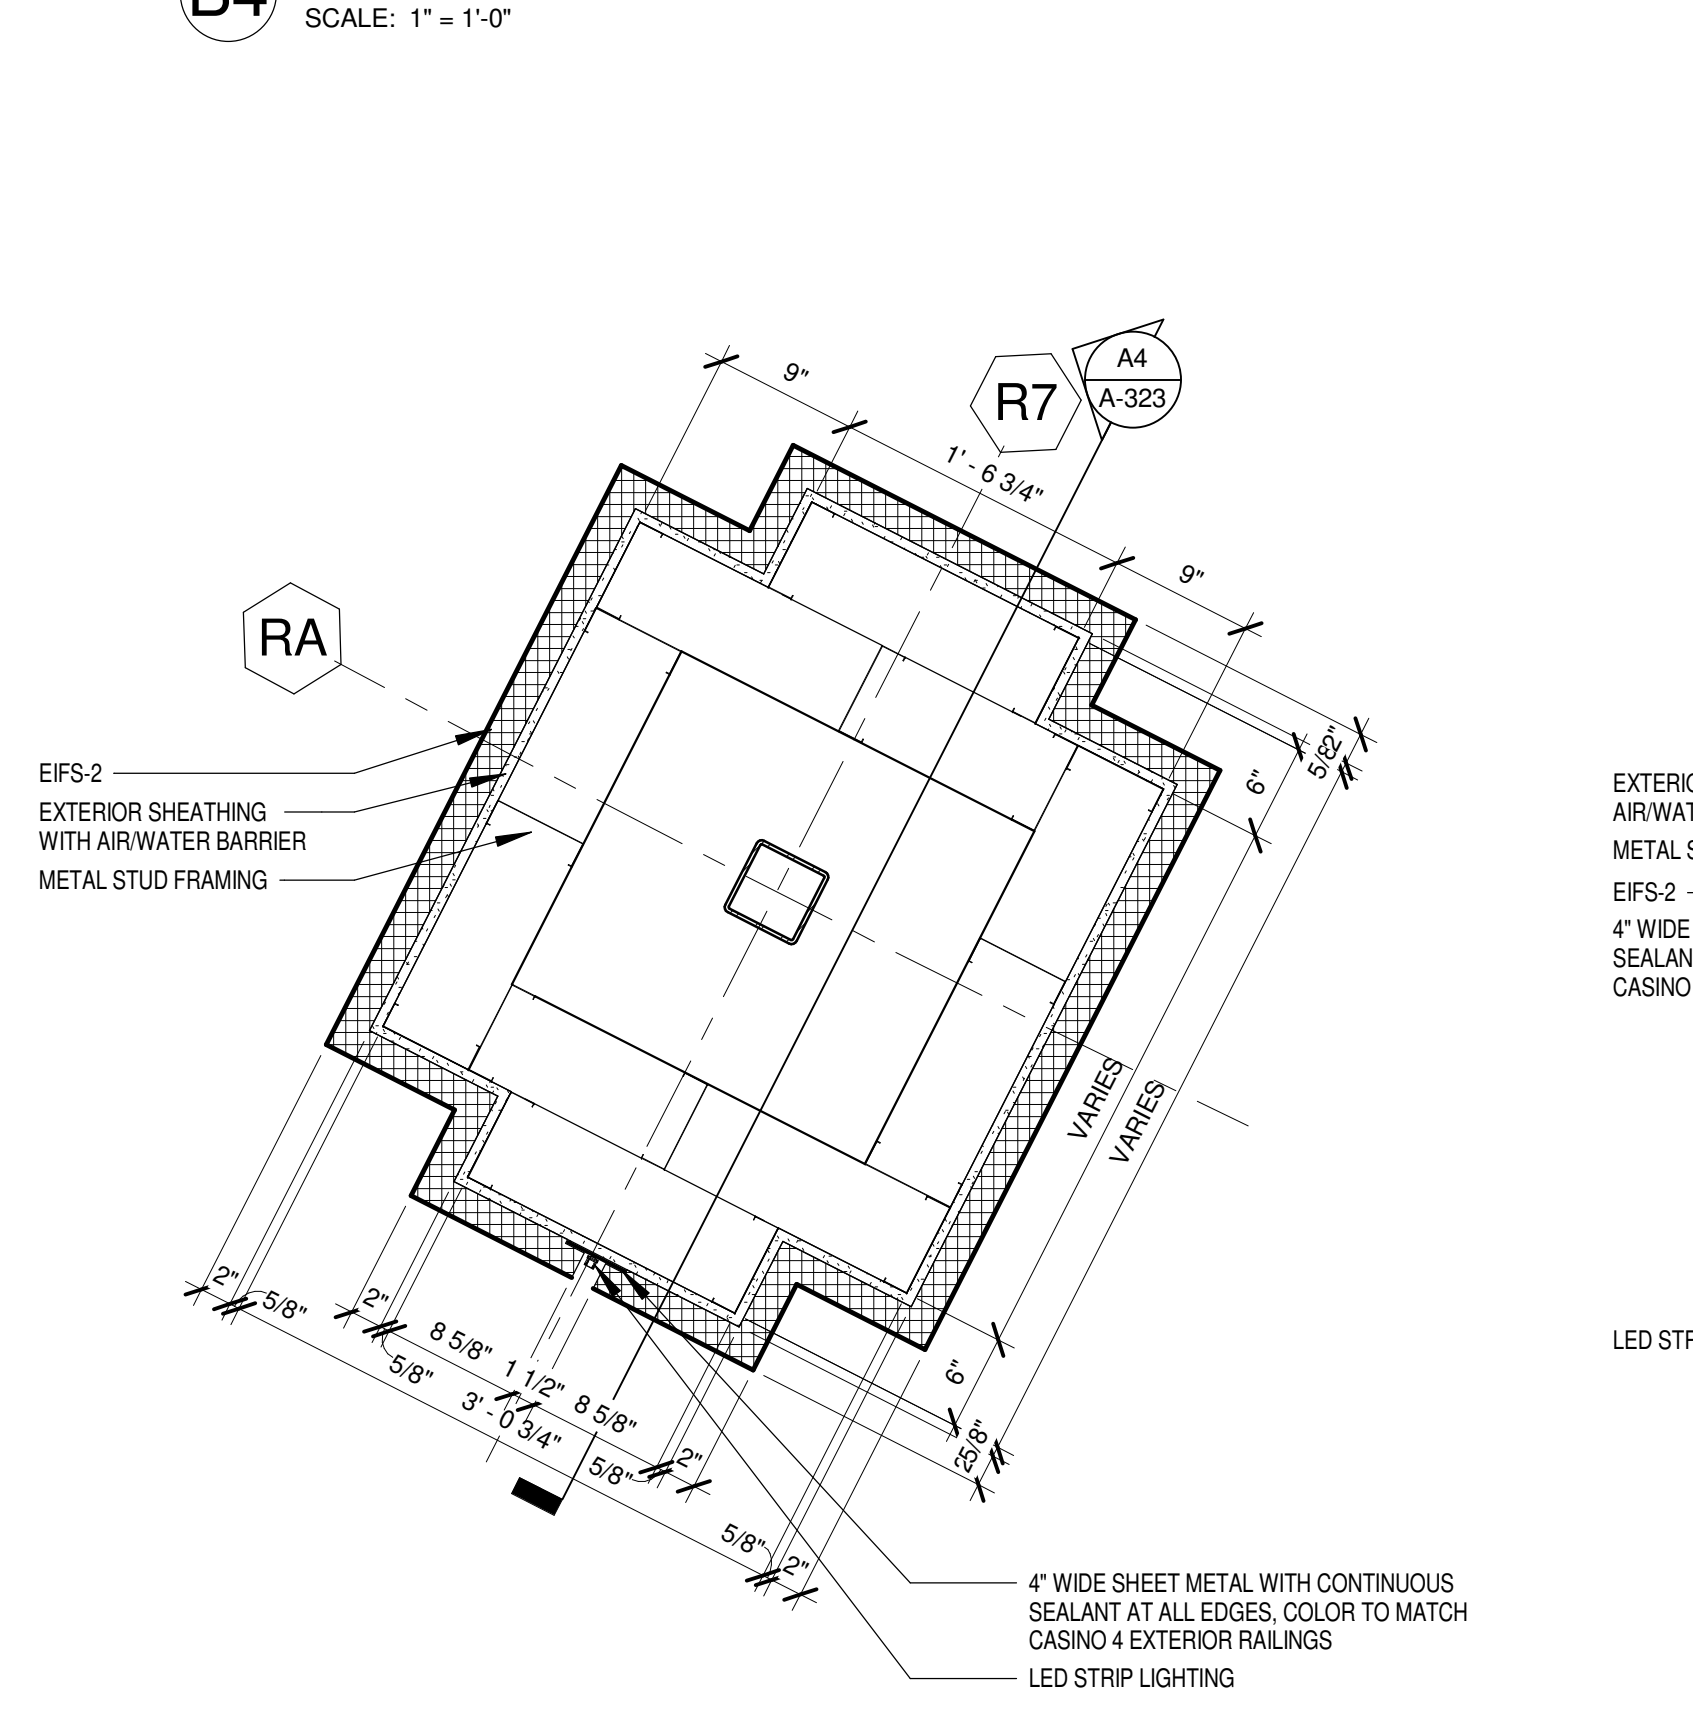

A6 PILASTER PLAN DETAIL
SCALE: 1" = 1'-0"

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EXTERIOR FACADE RENOVATION

KEY PLAN


No.	Description	Date

SECTION DETAILS

CONSTRUCTION SET

PROJECT NO: H17018
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ISSUE DATE: 12/21/2018

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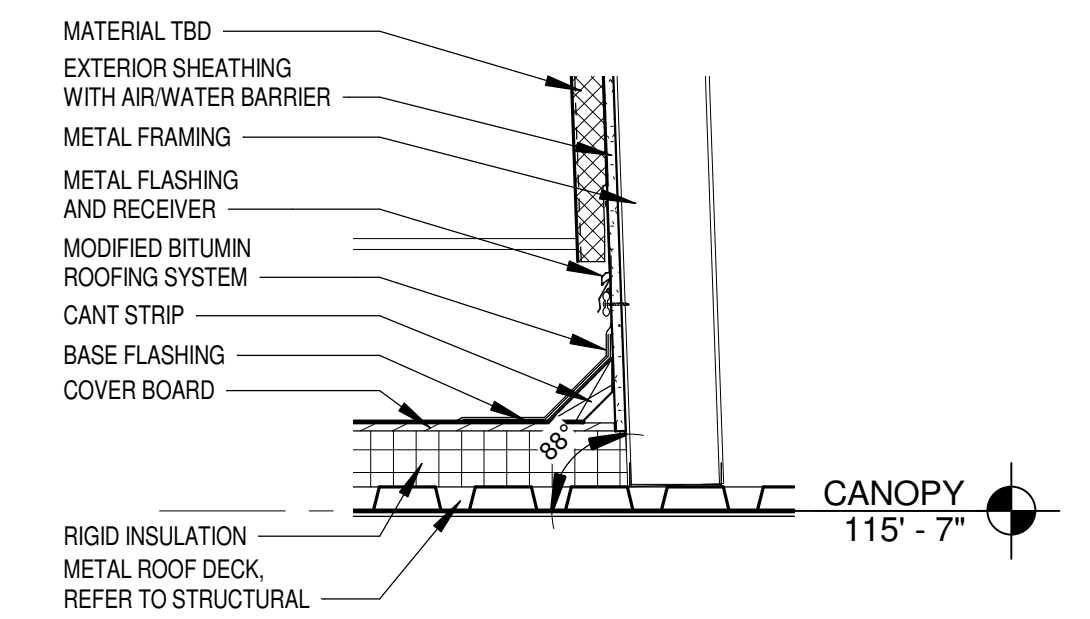
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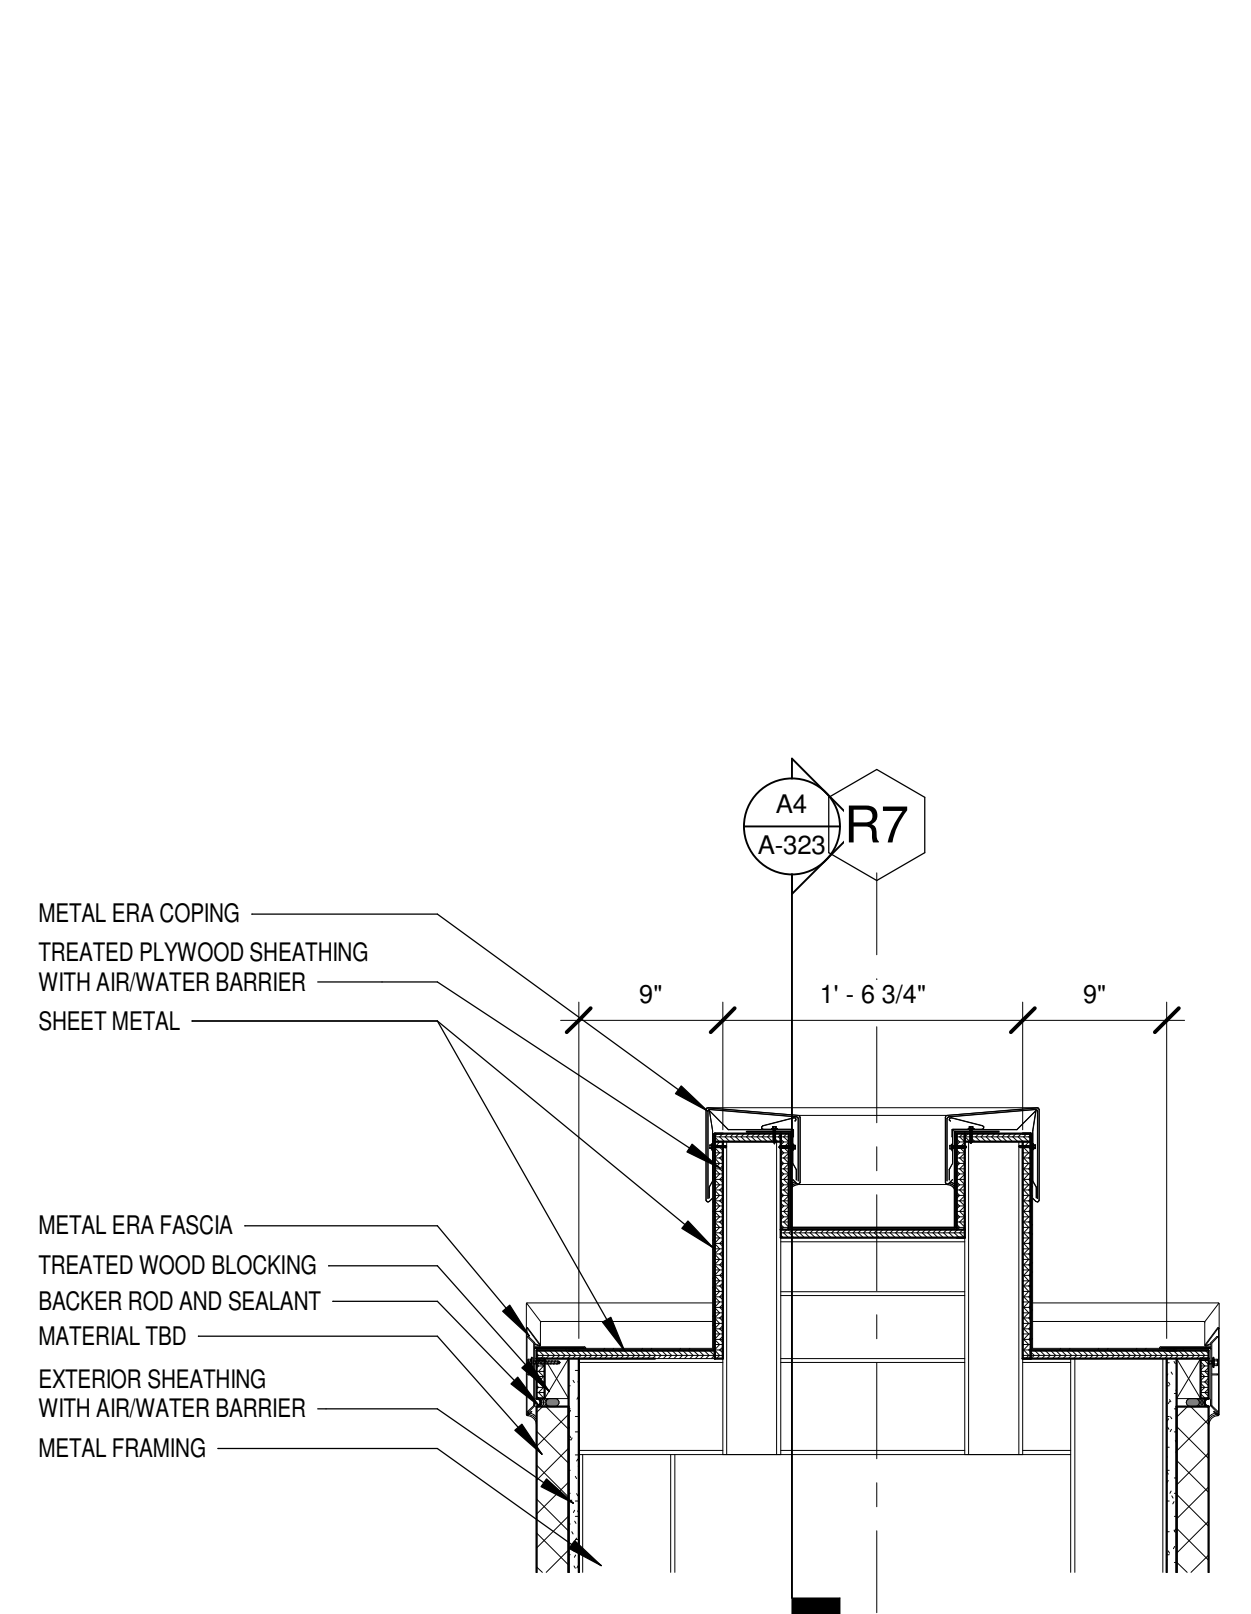
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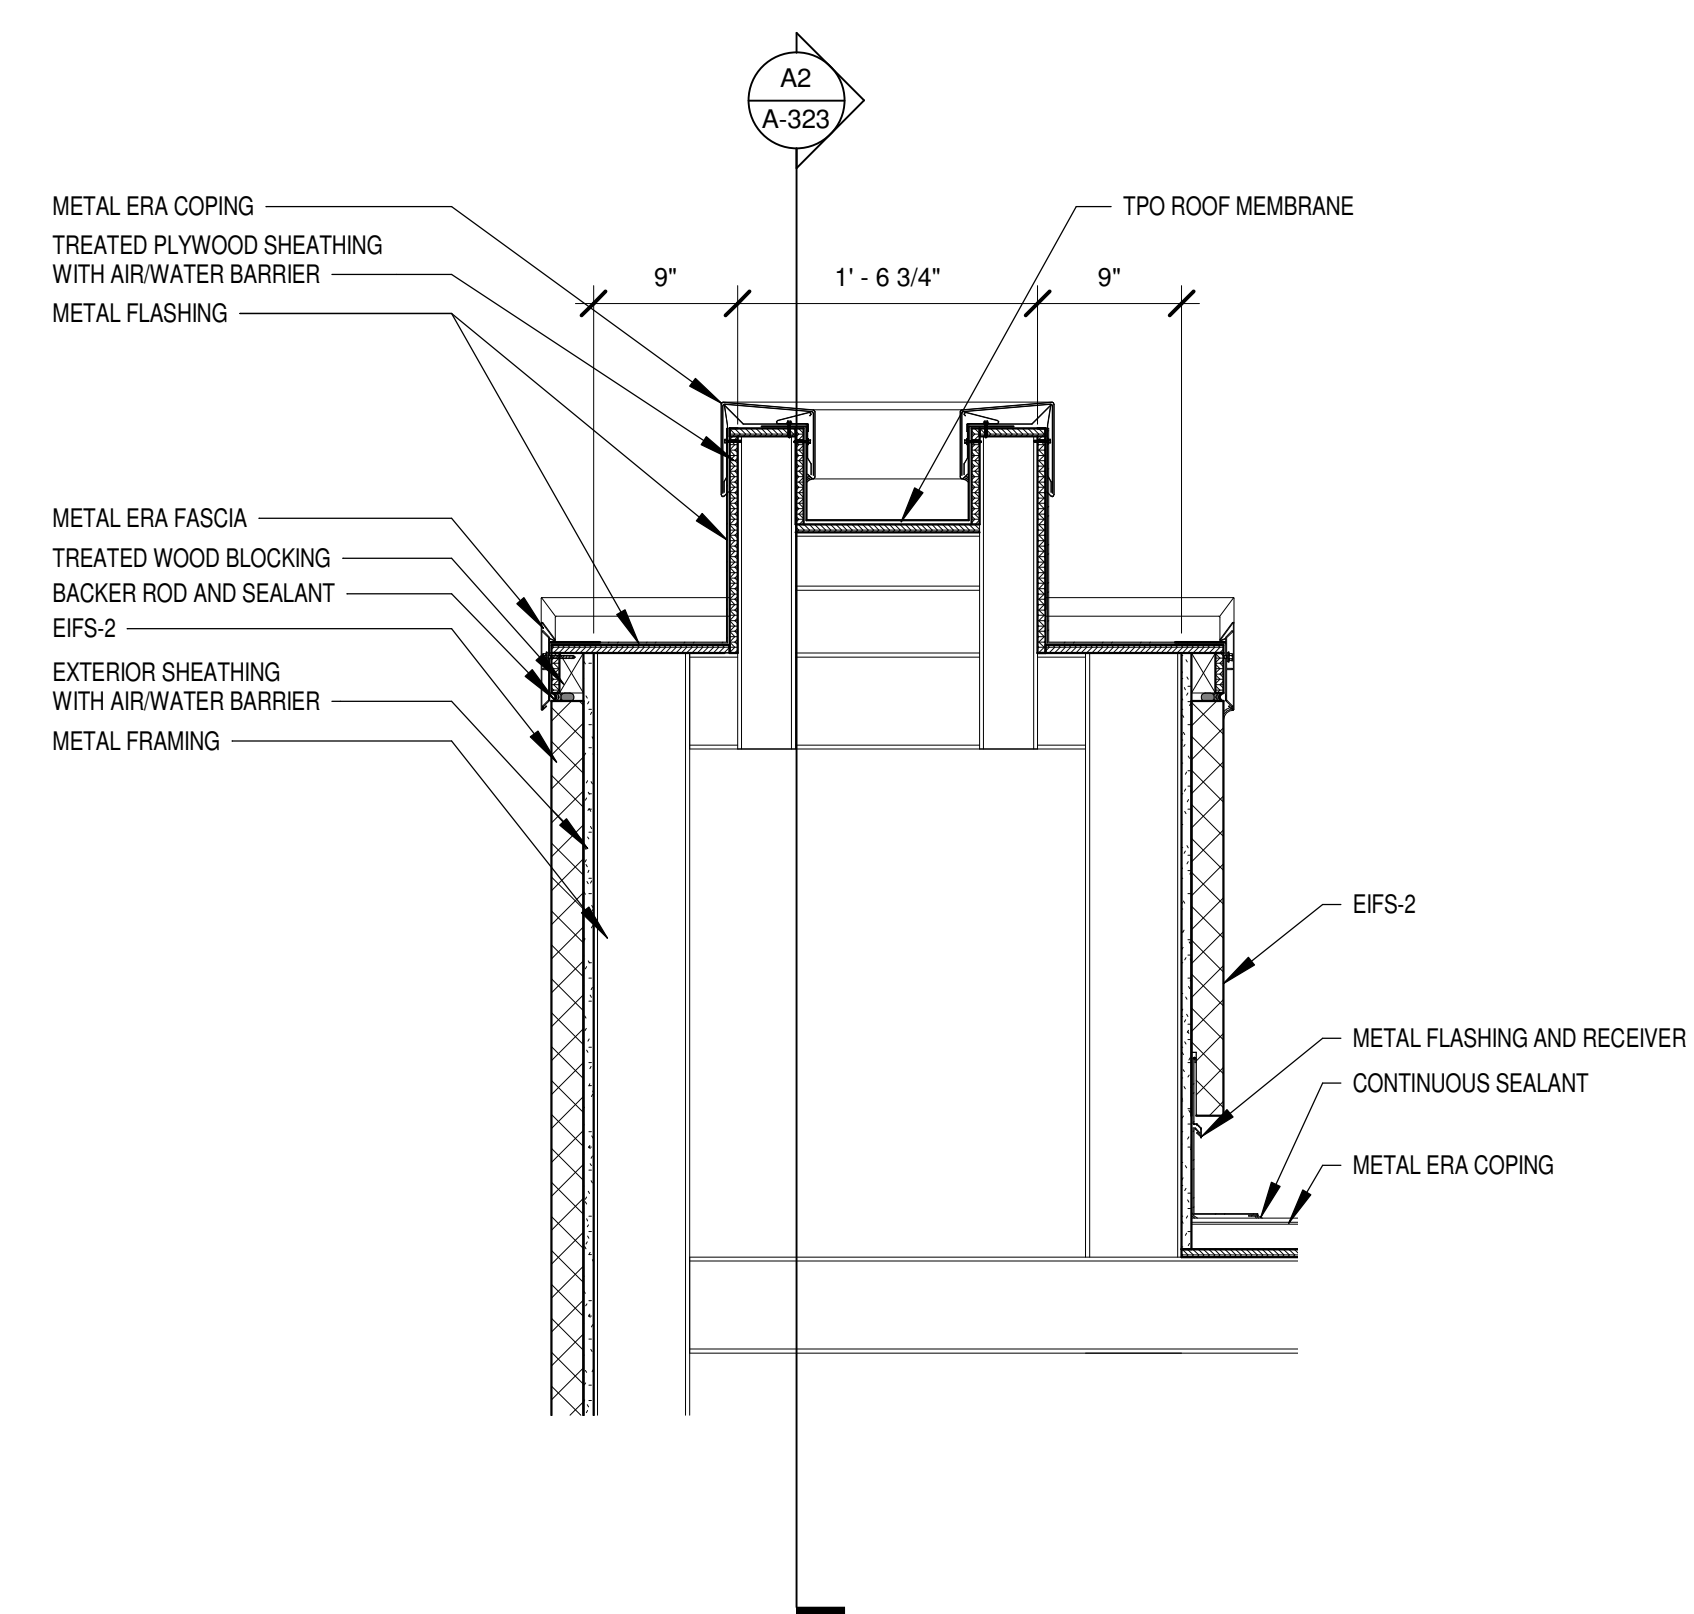
Cherokee Hard Rock Hotel & Casino

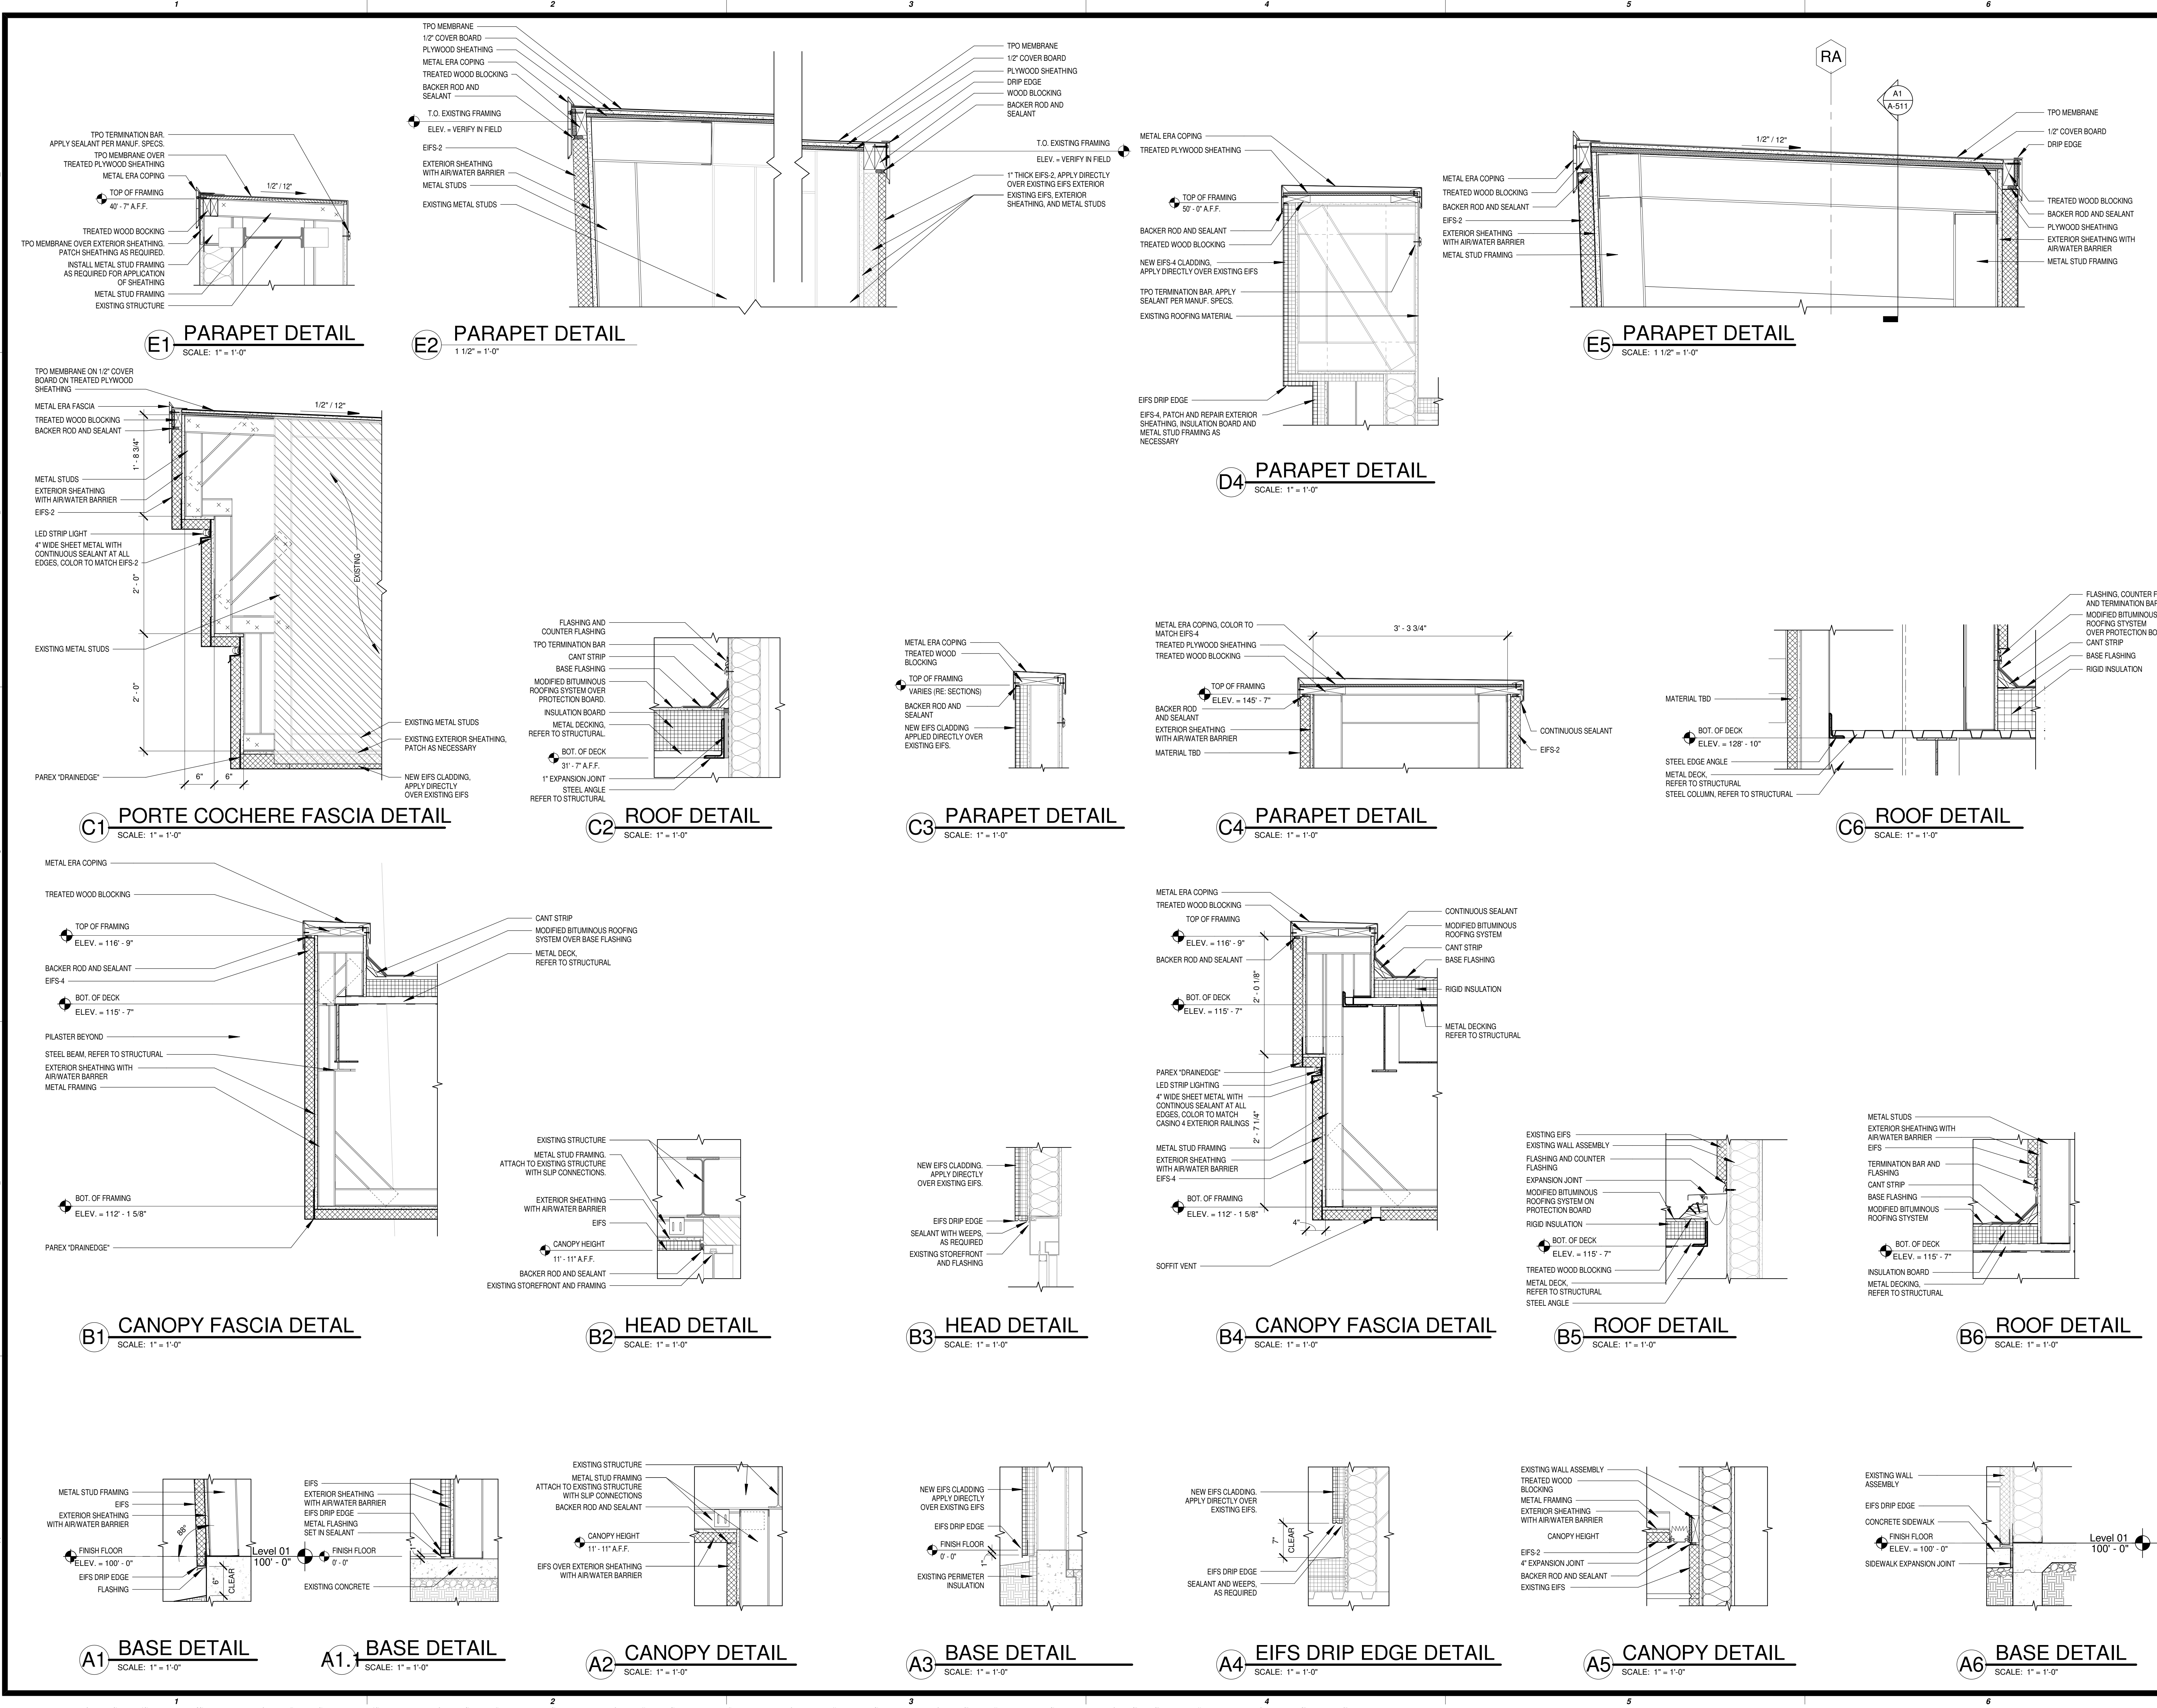


B6 SECTION DETAIL - FLASHING
SCALE: 1" = 1'-0"



A1 SECTION DETAIL - PILASTER
SCALE: 1" = 1'-0"



A2 SECTION DETAIL - PILASTER
SCALE: 1" = 1'-0"

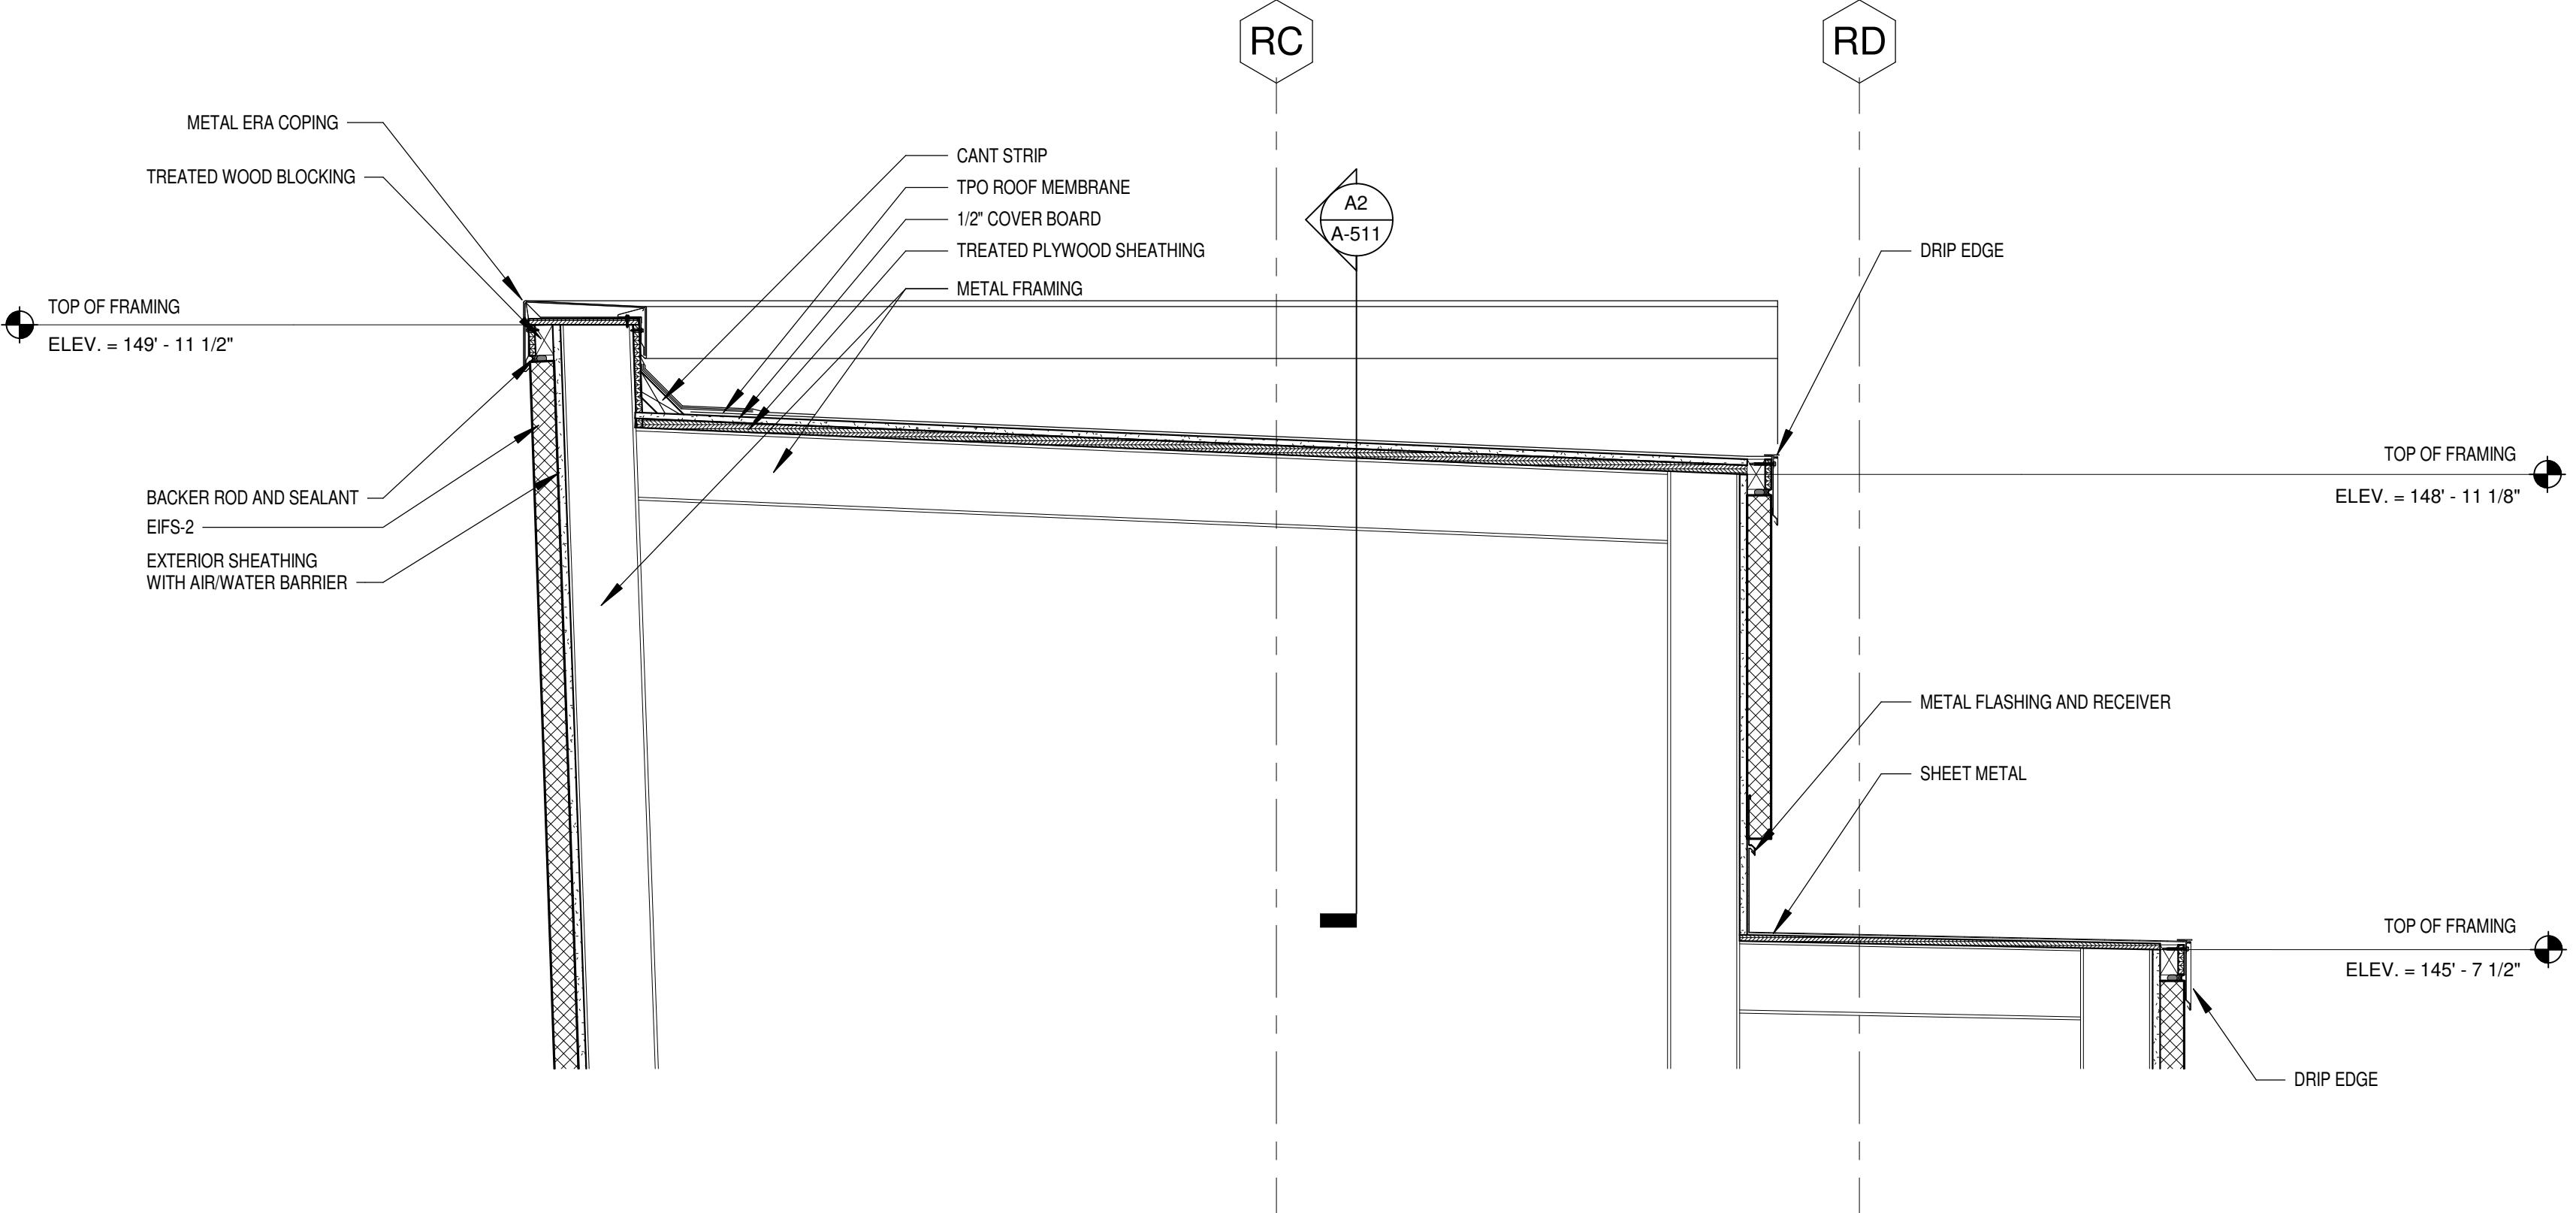

A3 SECTION DETAIL - PILASTER
SCALE: 1" = 1'-0"

EXTERIOR FACADE RENOVATION

KEY PLAN

No.	Description	Date

SHEET TITLE
SECTION DETAILS

CONSTRUCTION SET

PROJECT NO: H17018
DRAWN BY: BJB
CHECKED BY: DH
ISSUE DATE: 12/21/2018



A-511
Scale 1" = 1'-0"

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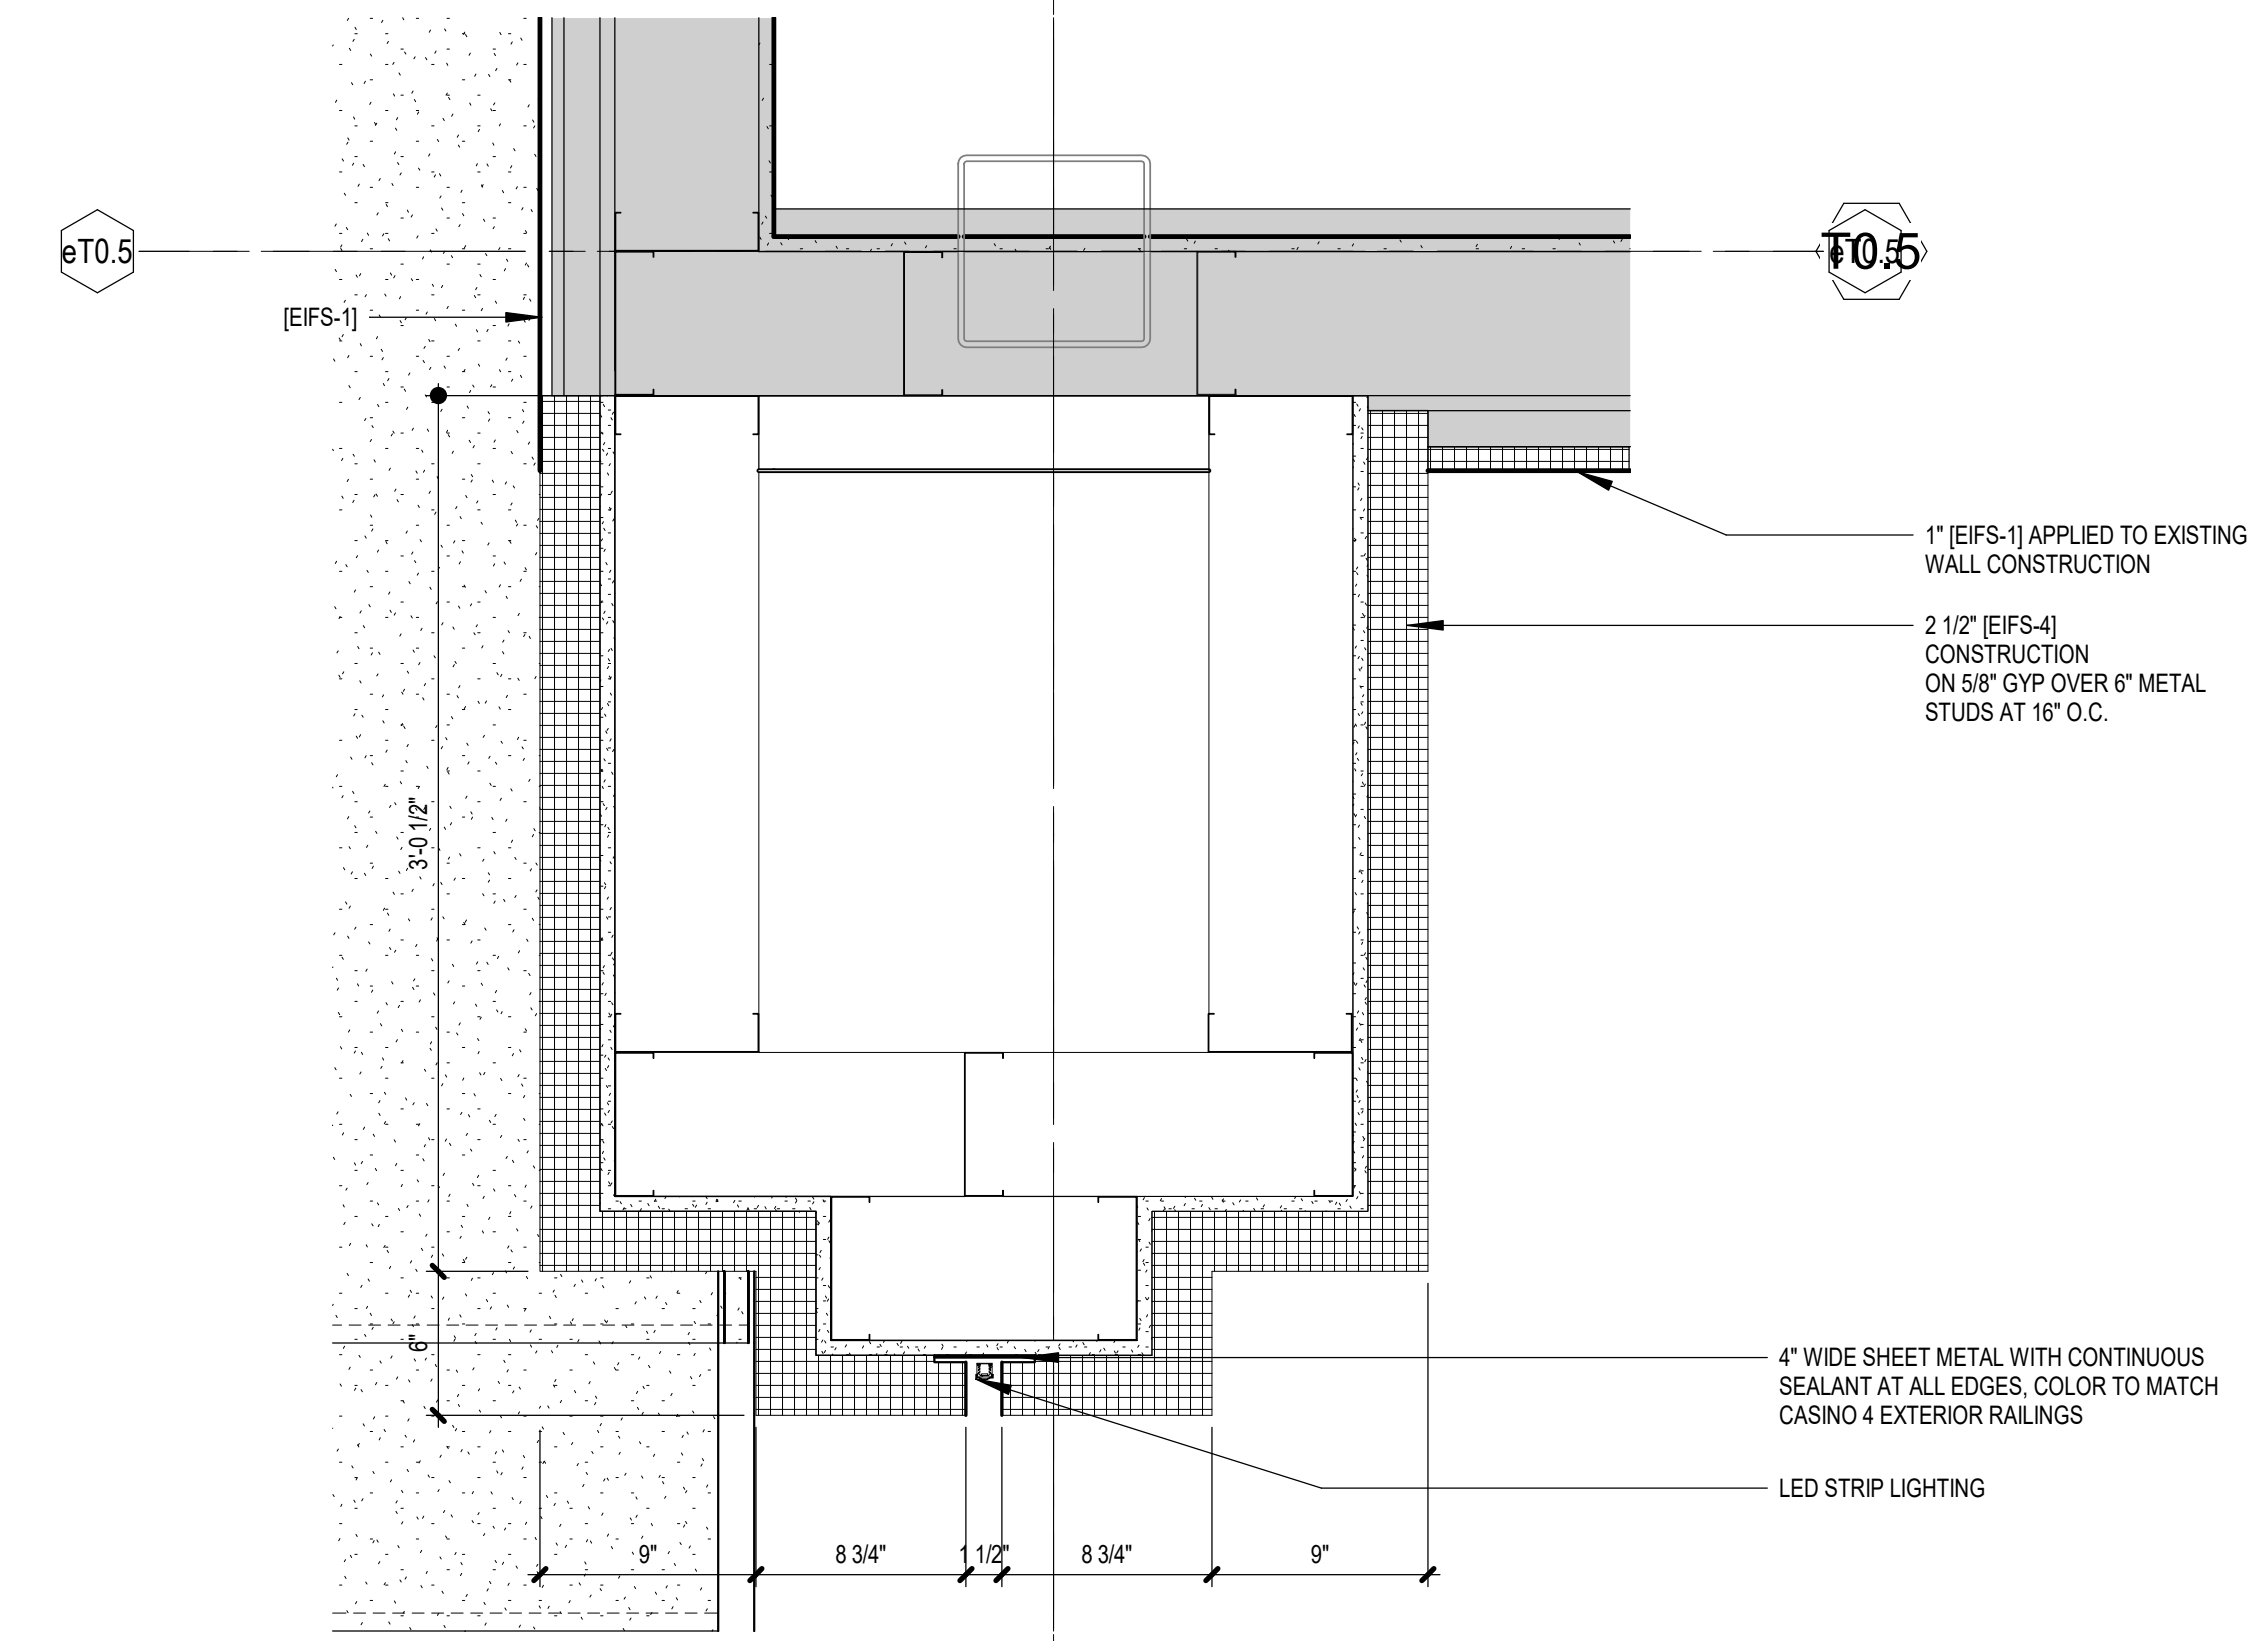
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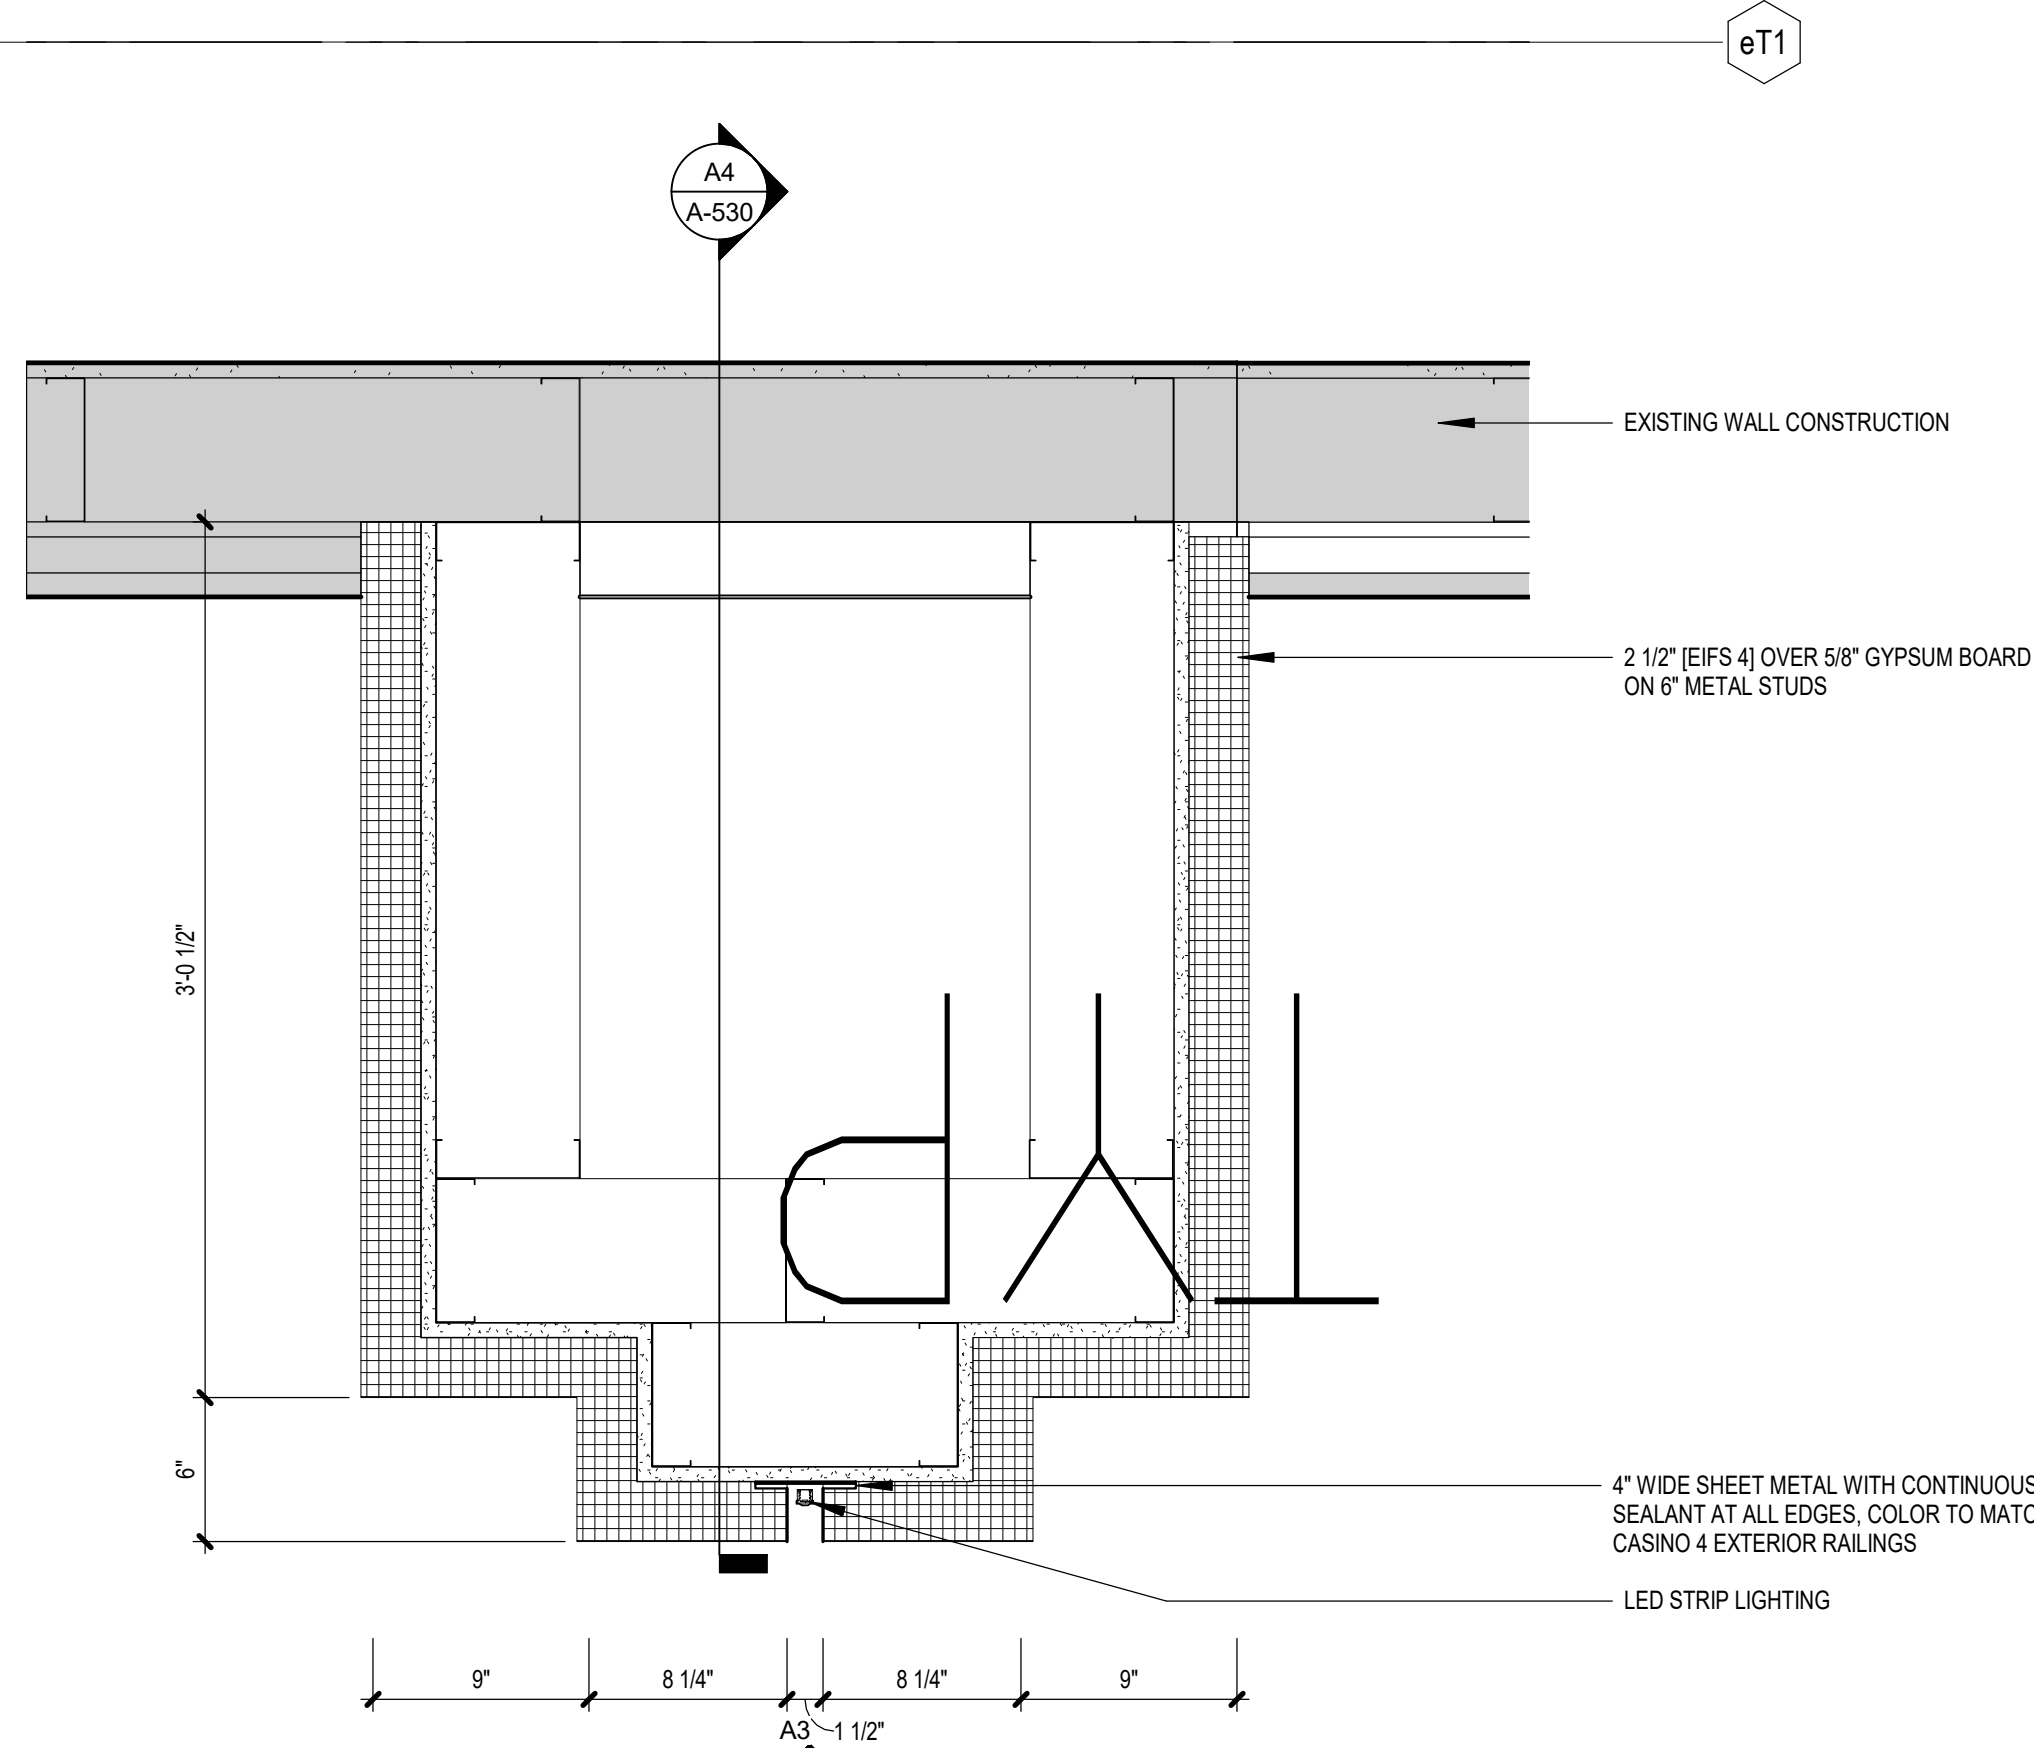
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918-224-7596


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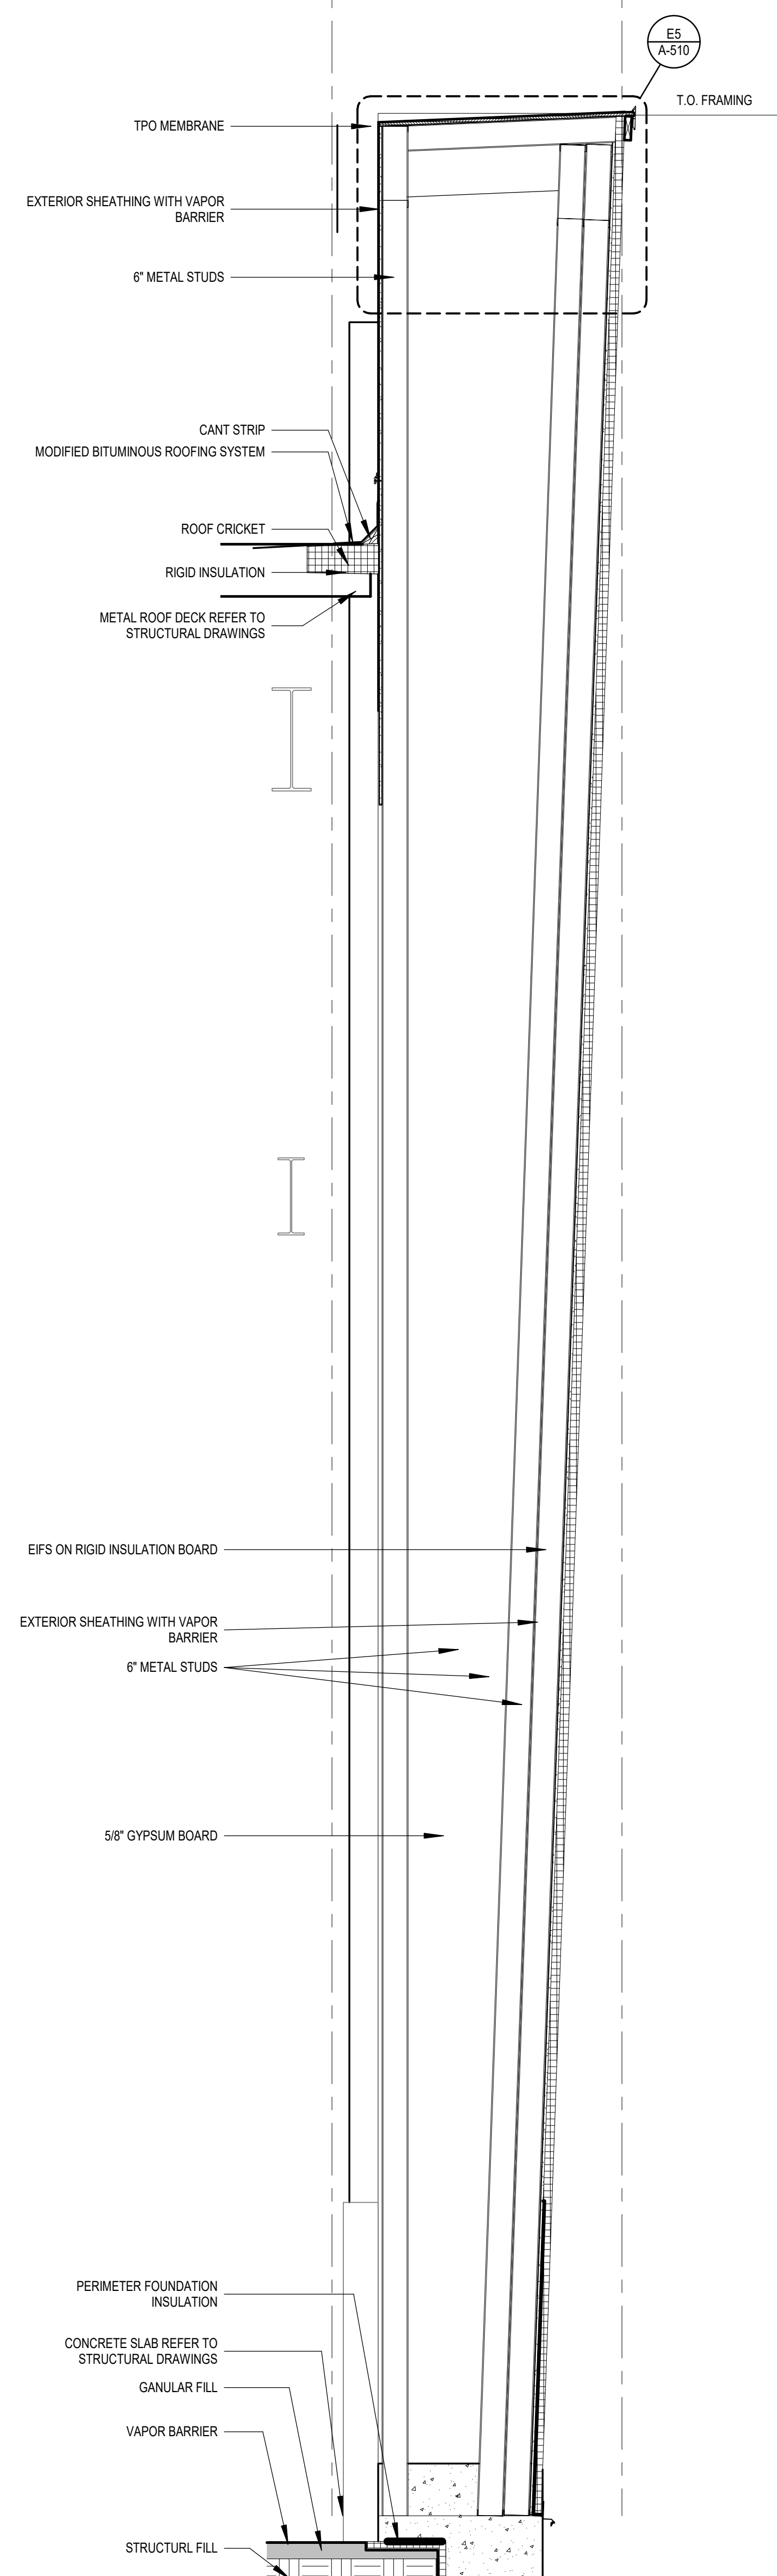
C1 PILASTER DETAIL - CORNER CONDITION
1 1/2" = 1'-0"



A1 PILASTER PLAN DETAIL
1 1/2" = 1'-0"




A3 PILASTER ELEVATION
1/2" = 1'-0"

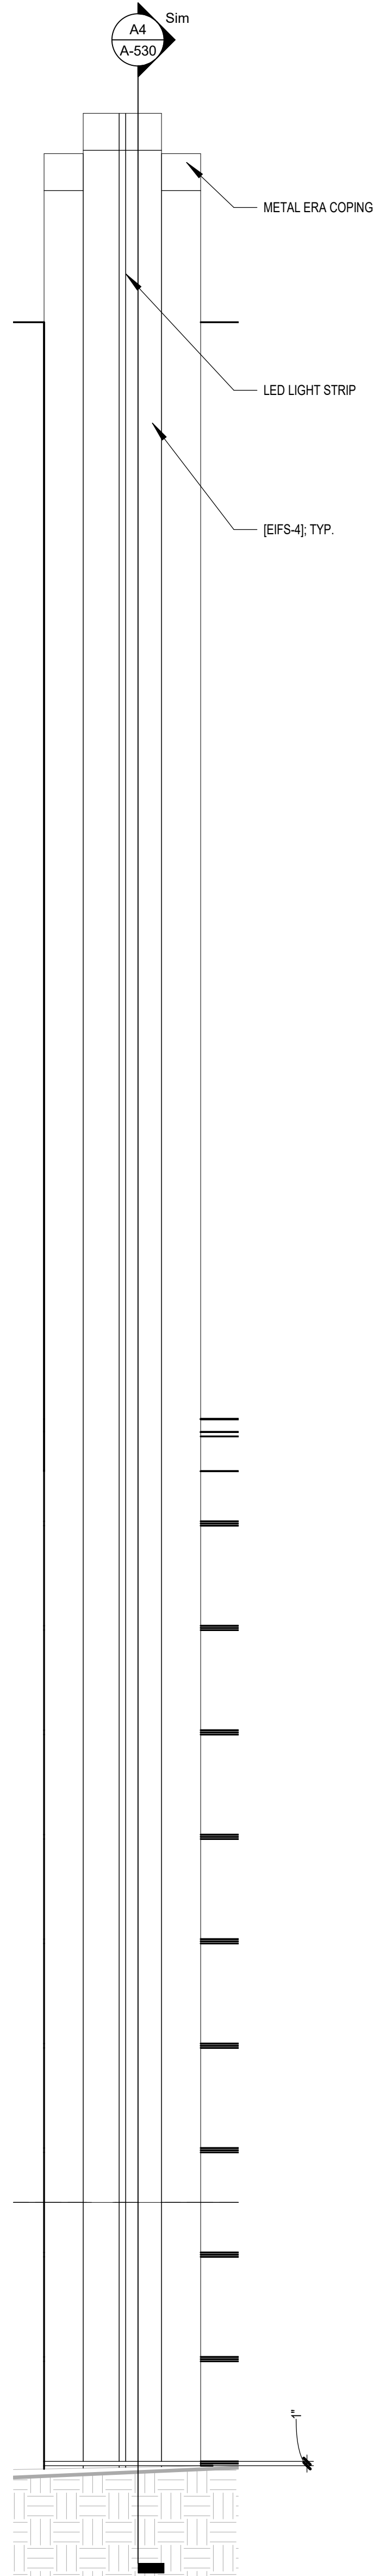

A4 PILASTER WALL SECTION
1/2" = 1'-0"

EXTERIOR FACADE RENOVATION

KEY PLAN

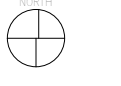


No.	Description	Date

PILASTER PLANS, ELEVATIONS AND SECTIONS

PROGRESS SET

PROJECT NO: H17018.01
DRAWN BY: Author
CHKD BY: Checker
ISSUE DATE: 10/26/2018

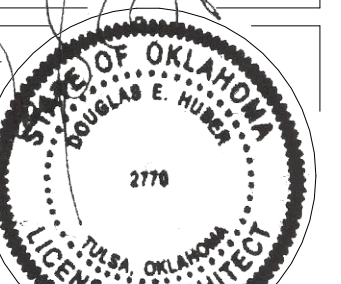

A-530
Scale As indicated

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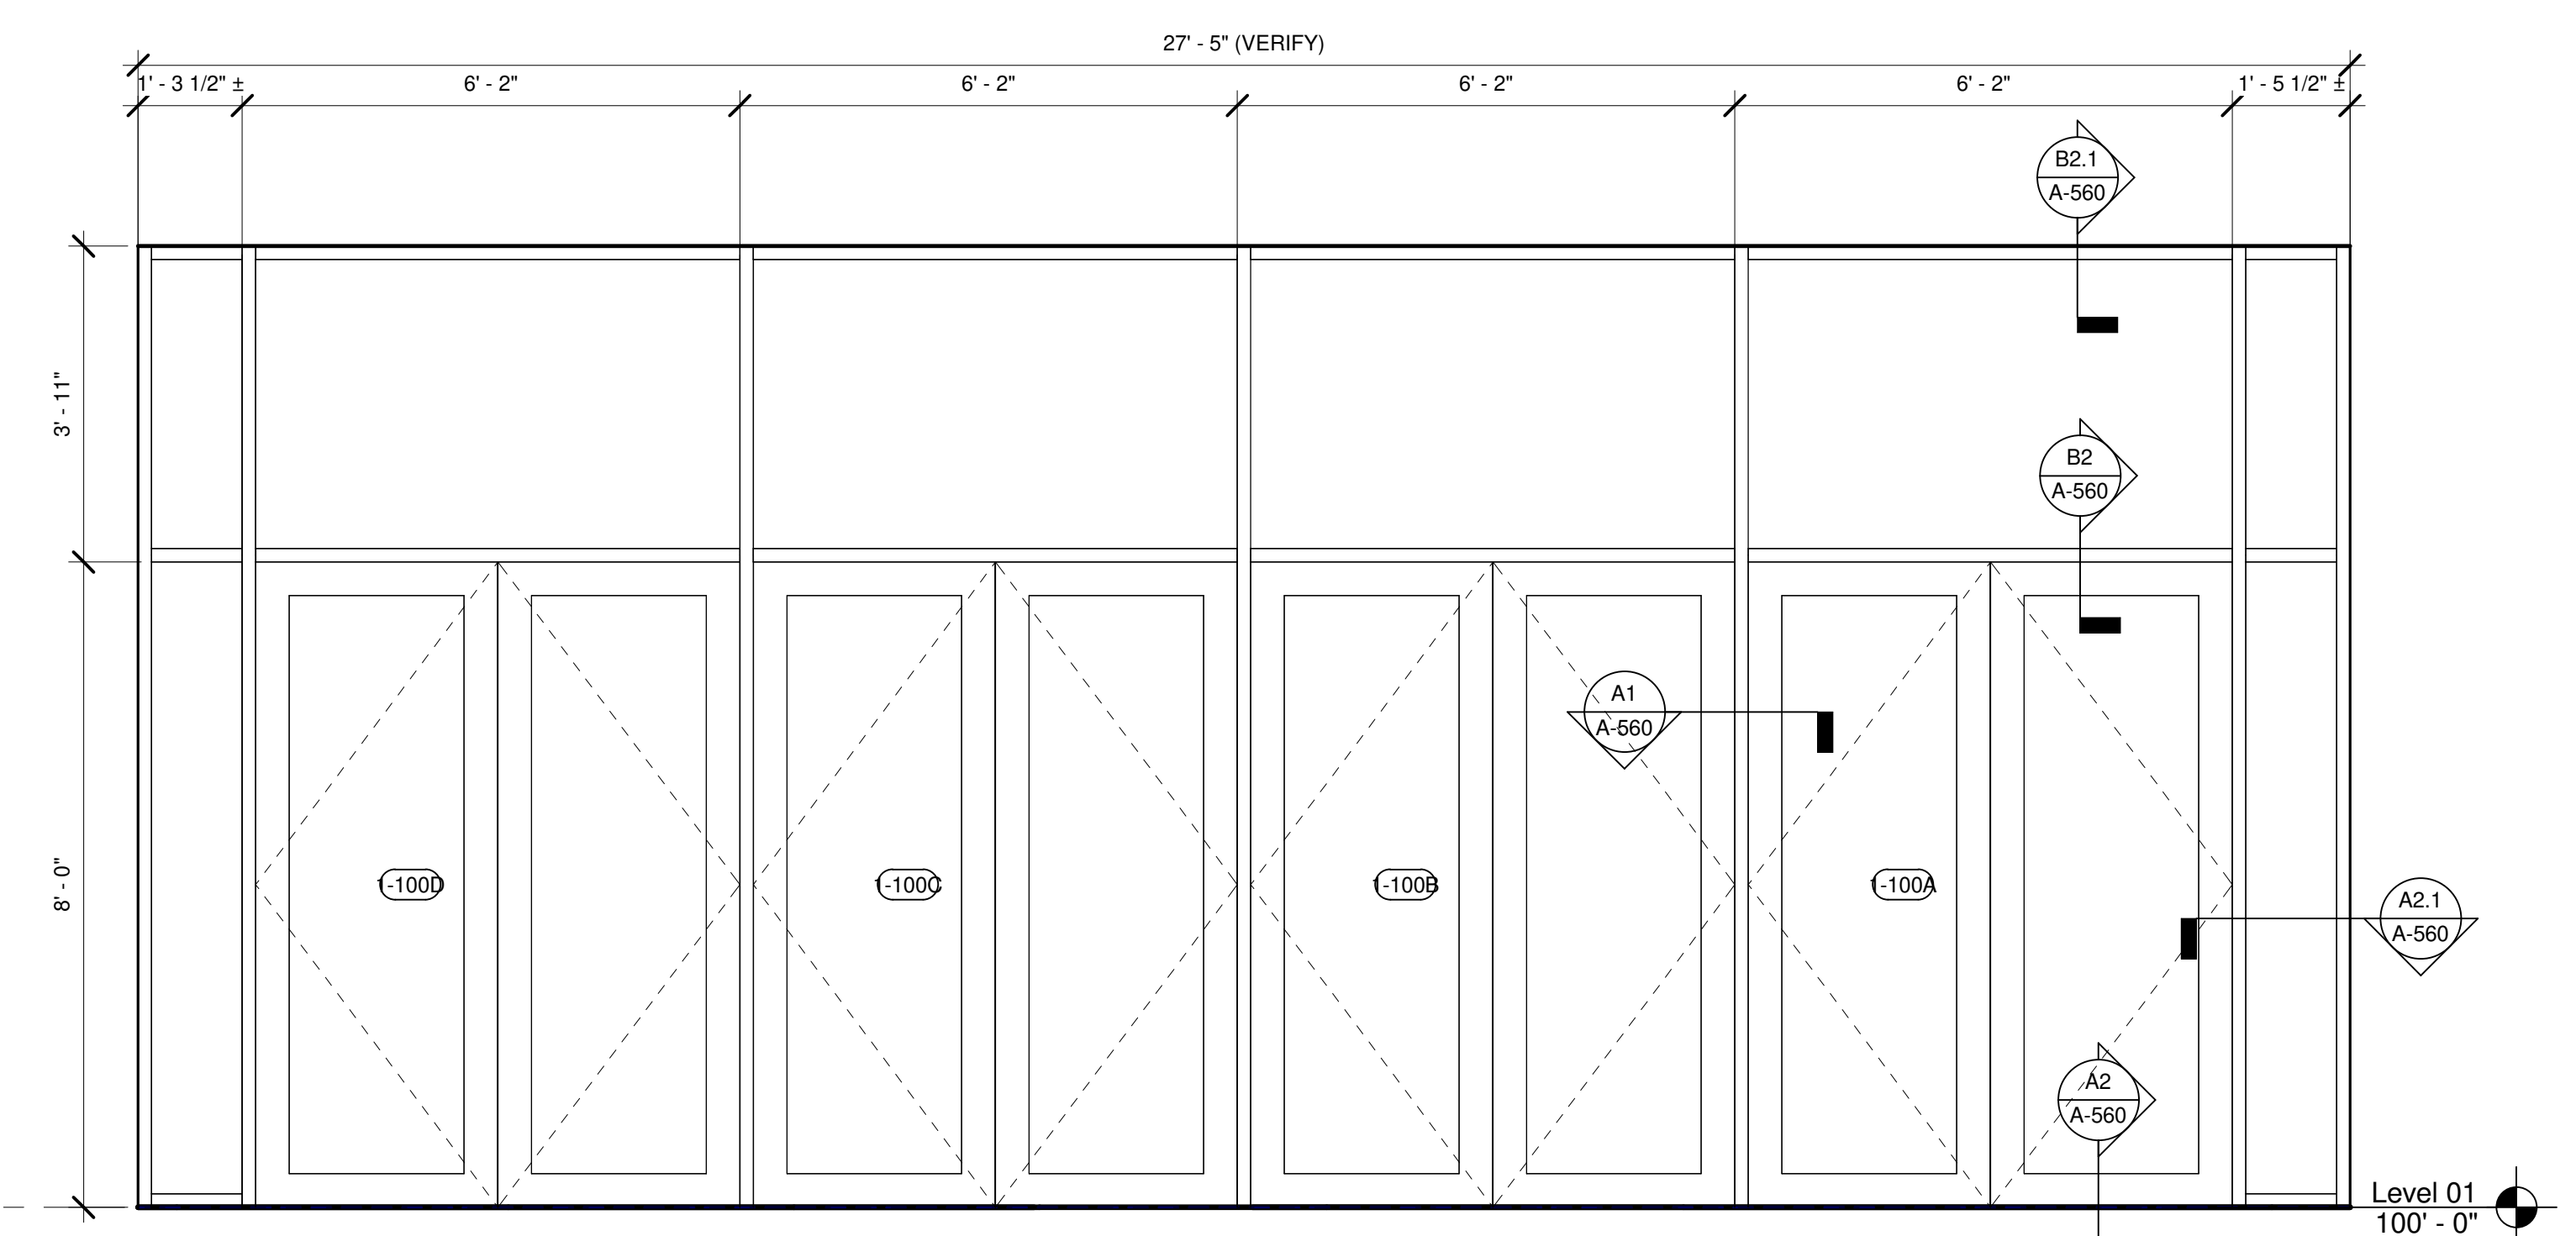
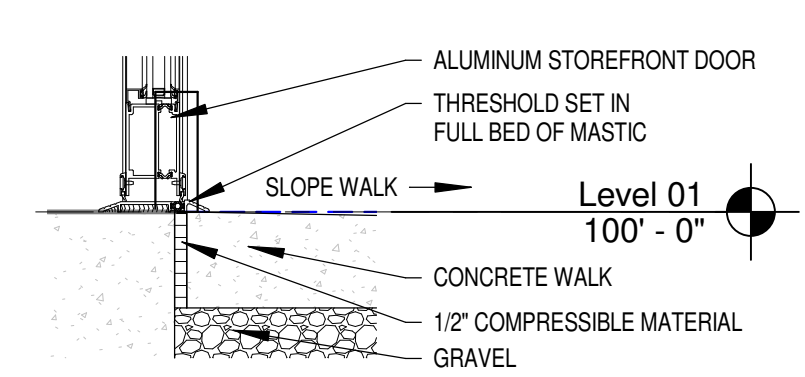
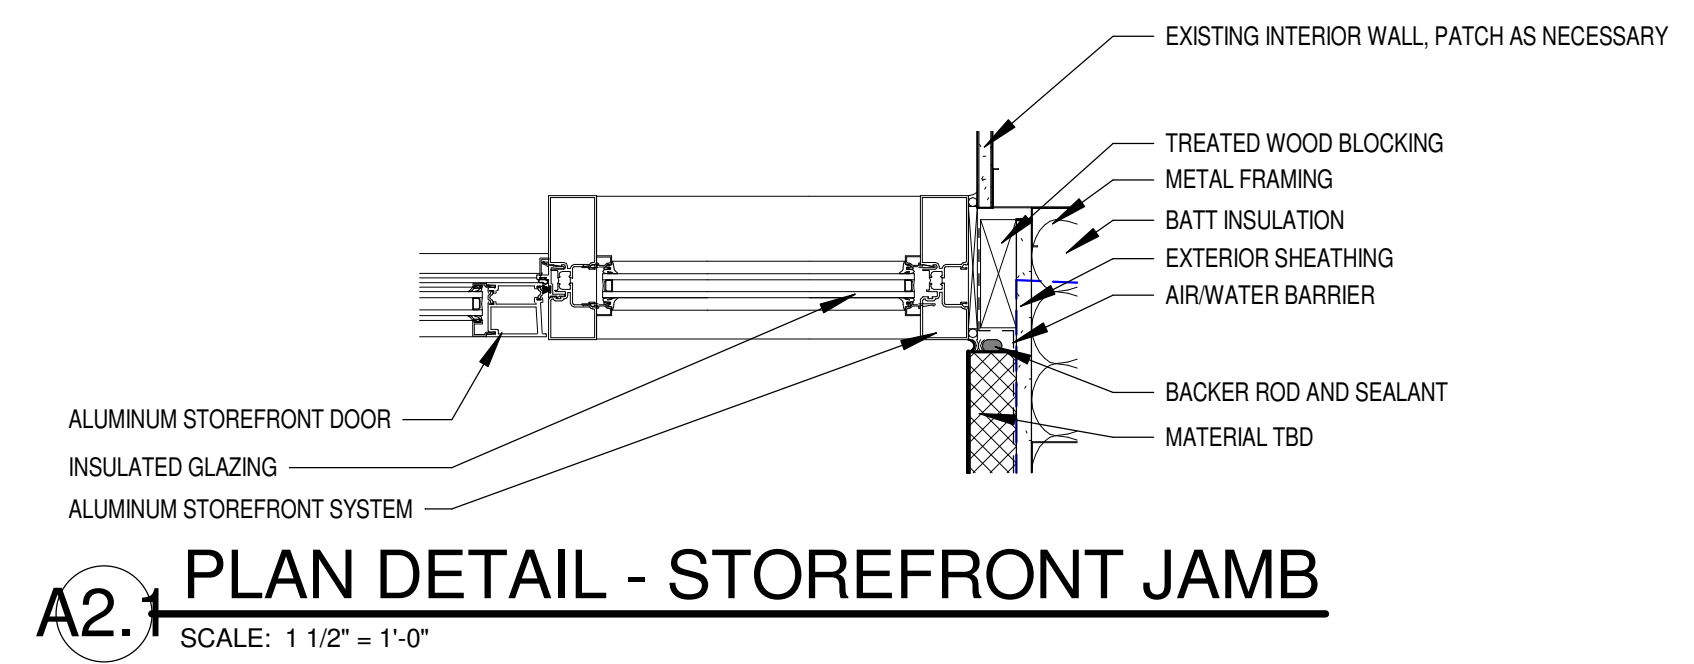
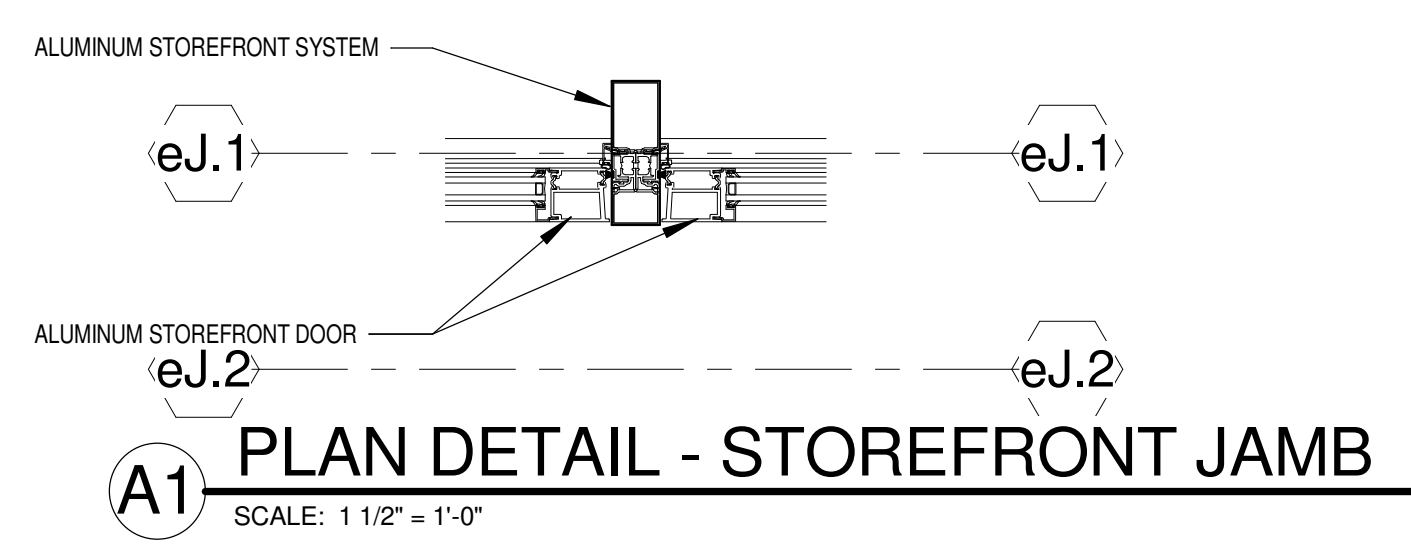
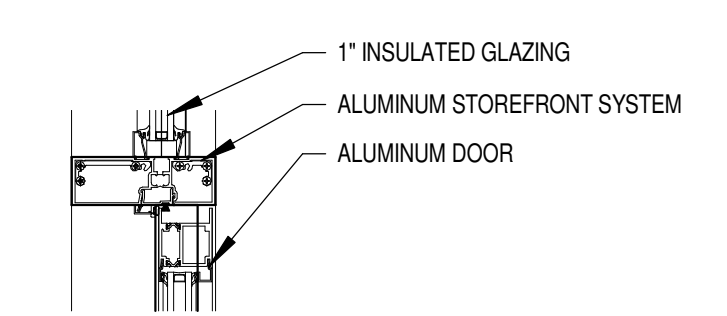
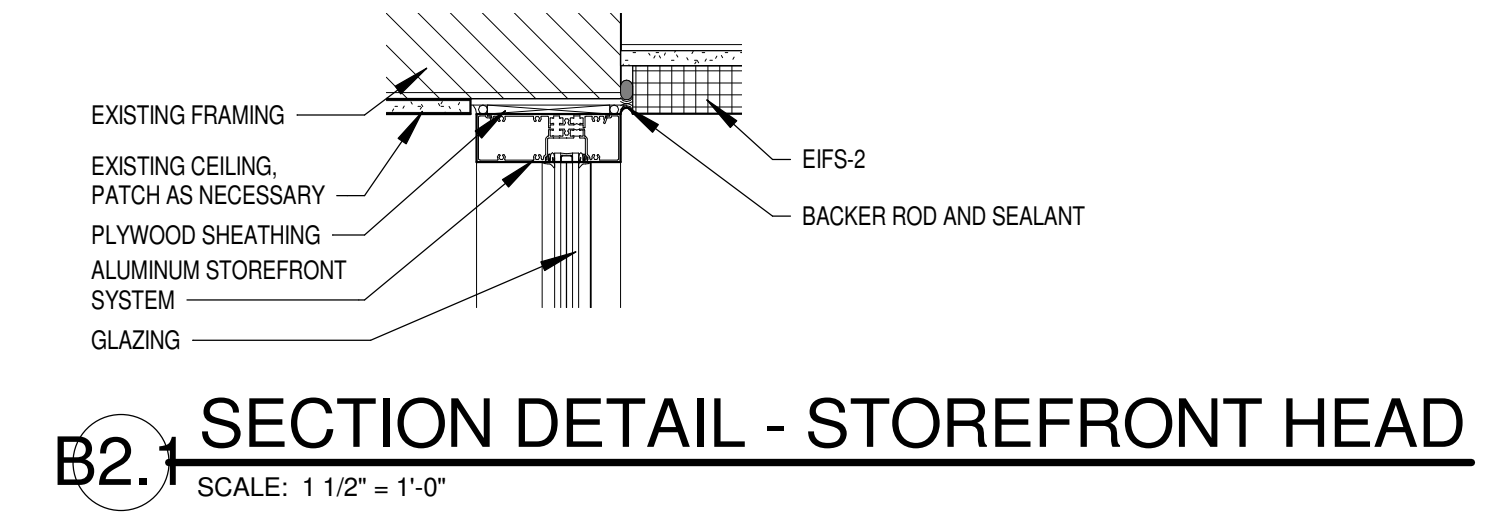
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 505-344-4080

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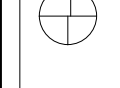
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 918-254-7596

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Door Schedule																	
DOOR NO.	DOOR IDENTIFICATION			DOOR CONSTRUCTION				FRAME CONSTRUCTION				DOOR / FRAME DETAILS			COMMENTS		
	PAIR/SINGLE	WIDTH	HEIGHT	EXISTING	TYPE	MATERIAL	FINISH	EXISTING	TYPE	MATERIAL	FINISH	FIRE RATING	GLAZING	HARDWARE SET			
1-1000	PAIR	8'-0"	8'-0"	S	ALUMGL	BRONZE		SF	ALUM	BRONZE			B2/A-560	A1/A-560, A2/A-560	A2/A-560	IG	
1-100C	PAIR	8'-0"	8'-0"	S	ALUMGL	BRONZE		SF	ALUM	BRONZE			B2/A-560	A1/A-560	A2/A-560	IG	
1-100B	PAIR	8'-0"	8'-0"	S	ALUMGL	BRONZE		SF	ALUM	BRONZE			B2/A-560	A1/A-560	A2/A-560	IG	
1-100A	PAIR	8'-0"	8'-0"	S	ALUMGL	BRONZE		SF	ALUM	BRONZE			B2/A-560	A1/A-560, A2/A-560	A2/A-560	IG	



EXTERIOR FACADE RENOVATION

KEY PLAN



No.	Description	Date

ALUMINUM FRAME ELEVATIONS AND DETAILS
CONSTRUCTION SET

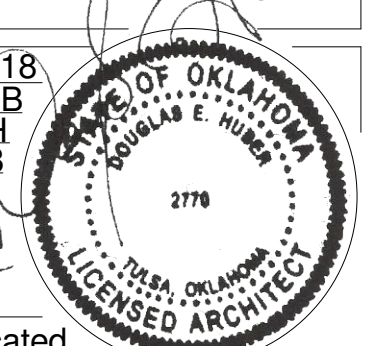 PROJECT NO: H17018
 DRAWN BY: BB
 CHECKED BY: DH
 ISSUE DATE: 12/21/2018

A-560
 Scale As indicated
 12/21/2018

ELECTRICAL SPECIFICATIONS

PART ONE - GENERAL
1.01 THE WORK: ALL WORK SHALL BE NEW UNLESS OTHERWISE NOTED. THE CONTRACTOR SHALL PROVIDE THE WORK SHOWN ON THE DRAWINGS AND SPECIFIED FOR ITS INDIVIDUAL SECTIONS OF WORK. THE WORD "WORK" IS DEFINED AS ALL LABOR, TRANSPORTATION, MATERIAL, EQUIPMENT, TOOLS, INSTALLATION, SUPERVISION AND ANY OTHER INCIDENTAL ITEMS OR SERVICES NECESSARY FOR THE PROPER INSTALLATION AND OPERATION OF THE COMPLETE SYSTEMS, WHICH SHALL BE PROVIDED BY THIS CONTRACTOR WHETHER OR NOT SPECIFICALLY INDICATED OR NOTED.


BIDDING
1.19 SITE VISIT: CONTRACT DOCUMENTS INDICATE NEW WORK TO BE PERFORMED AND DO NOT PURPORT TO SHOW ALL EXISTING CONDITIONS. VISIT THE SITE PRIOR TO SUBMITTING A BID TO BECOME FAMILIAR WITH EXISTING CONDITIONS. COMPARE THE WORK SPECIFIED IN THE CONTRACT DOCUMENTS AGAINST EXISTING CONDITIONS, AND IDENTIFY AND ANNOTATE ALL WORK OR CONDITIONS THAT ARE DIFFERENT FROM THE CONTRACT DOCUMENTS OR THEIR INTENT. UPON DISCOVERY, IMMEDIATELY NOTIFY AND REPORT IN WRITING ANY DISCREPANCIES TO THE ENGINEER. NO EXTRAS OR CHANGE ORDERS WILL BE ALLOWED FOR FAILURE TO PERFORM THE PRE-BID SITE VISIT.

2.16 IDENTIFICATION: IDENTIFY ALL EQUIPMENT, SWITCHBOARD CIRCUITS, AND ELECTRICALLY-CONNECTED EQUIPMENT WITH ENGRAVED NAMEPLATES. NAMEPLATES SHALL BE FASTENED WITH A MINIMUM OF TWO (2) SCREWS. PANEL DIRECTORIES SHALL BE TYPED. IDENTIFY WIRING DEVICES WITH SELF ADHESIVE CLEAR SATIN FINISH LABELS WITH SOURCE AND CIRCUIT NUMBER.

PART THREE - EXECUTION
3.01 GROUNDING: GROUND ALL EQUIPMENT AND SYSTEM NEUTRAL IN ACCORDANCE WITH THE REQUIREMENTS OF NEC ARTICLE 250. PROVIDE CODE-SIZED EQUIPMENT GROUNDING CONDUCTOR IN ALL FEEDERS AND BRANCH CIRCUIT RACEWAYS. WHERE ISOLATED GROUNDS ARE INDICATED, PROVIDE INSULATED CONDUCTOR (GREEN WITH YELLOW STRIPE).

3.02 DEMOLITION: PROVIDE COMPLETE ELECTRICAL DEMOLITION - REMOVE EXISTING OUTLETS AND EQUIPMENT IN CONFLICT WITH NEW CONDITIONS. EXISTING CONDUITS REMOVED FROM SERVICE MAY BE ABANDONED IN PLACE IF IN A CONCEALED LOCATION. REMOVE ALL WIRE FROM ABANDONED RACEWAYS. CONTRACTOR SHALL ENSURE CONTINUITY OF EXISTING CIRCUITING PASSING THROUGH DEMOLITION AREAS - EXTEND AND/OR RELOCATE AS NECESSARY. SHIFT OR RELOCATE EXISTING EQUIPMENT AND CIRCUITING AS REQUIRED TO ACCOMMODATE NEW WORK.

PART FOUR - SPECIAL SYSTEMS
4.01 THIRD PARTY TESTING: PROVIDE ALL ASSOCIATED COSTS FOR THIRD PARTY TESTING OF ALL EQUIPMENT, CONDUCTORS, GROUND FAULT, GROUND FAULT COORDINATION STUDY WITH REPORT PREPARATION, ETC. AS REQUIRED BY THE NEC, AHJ AND ALL OTHER GOVERNING AUTHORITIES.

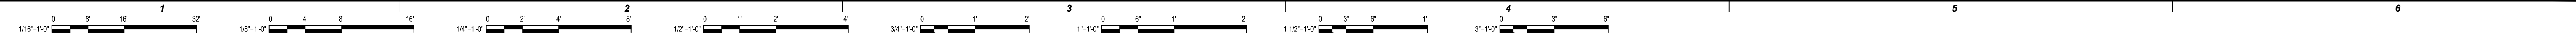

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Cherokee Hard Rock Hotel & Casino

EXTERIOR FACADE RENOVATION




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SPECIFICATIONS

CONSTRUCTION SET

PROJECT NO: L17325-01
DRAWN BY: MSA
CHECKED BY: MSA
DATE: 12/21/2018

E-001
Scale AS NOTED

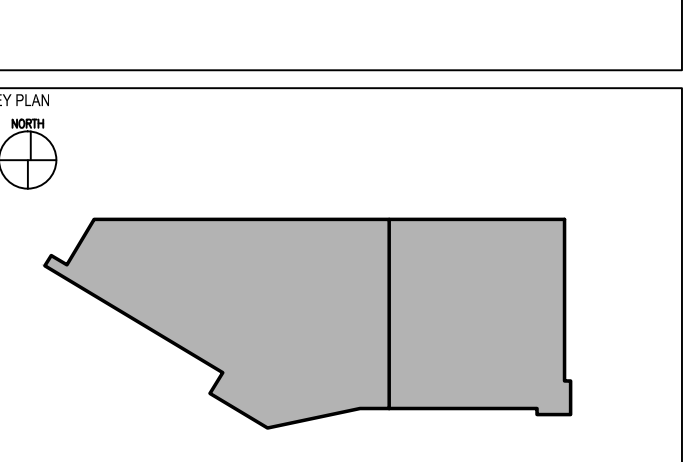

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505-344-4080


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716-645-5092

Cherokee Hard Rock Hotel & Casino

EXTERIOR FACADE RENOVATION



No.	Description	Date

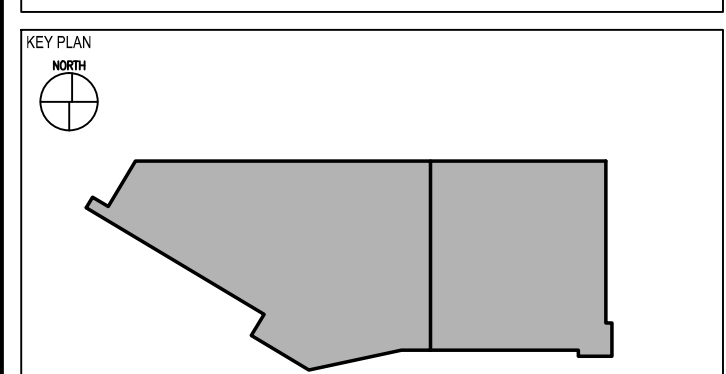PARTIAL SINGLE LINE DIAGRAM

CONSTRUCTION SET

PROJECT NO: L17325 01
DRAWN BY: MSA
CHECKED BY: MSA
ISSUE DATE: 12/21/2018

E-002
Scale: AS NOTED




GENERAL NOTES:

- MINIMUM EQUIPMENT A.I.C. RATINGS ARE 14K A.I.C. @ 480/277V AND 10K A.I.C. @ 208/120V UNLESS OTHERWISE NOTED.
- THE DESIGN PROFESSIONAL HAS PERFORMED ALL REQUIRED SHORT CIRCUIT CALCULATIONS AND THE A.I.C. RATINGS INDICATED FOR EACH DEVICE ARE ADEQUATE TO PROTECT THE EQUIPMENT AND THE ELECTRICAL SYSTEM.
- THE DESIGN PROFESSIONAL HAS PERFORMED ALL THE REQUIRED VOLTAGE DROP CALCULATIONS FOR ALL BRANCH CIRCUITS AND FEEDERS PER 2011 NATIONAL ELECTRICAL CODE ARTICLE 210.19(A)(1), FPN NO. 4.
- PANLEBOARD LOAD SUMMARIES INCLUDE ADDITIONAL 25% OF ALL CONTINUOUS AND LARGEST MOTOR LOADS WHERE APPLICABLE.

SHEET NOTES:

- 1 PROVIDE NEW CIRCUIT BREAKER INDICATED WITH ALL REQUIRED MOUNTING HARDWARE. NEW CIRCUIT BREAKER AIC SHALL MATCH EXISTING.
- 2 (2) 4" - 8#500K, 2#1 GND, THHN/THWN, CU.
- 3 (2) 4" - 3#500K, 1#2 GND, THHN/THWN, CU.
- 4 (3) 4" - 12#500K, 3#2/0 GND, THHN/THWN, CU.
- 5 2" - 4#1/0, 1#6 GND, THHN/THWN, CU.
- 6 4" - 3#350K, 1#4 GND, THHN/THWN, CU.
- 7 (2) 3" - 8#250K, 2#1/0 GND, THHN/THWN, CU.
- 8 EQUIPMENT IS LOCATED IN MAIN EQUIPMENT ROOM/YARD FOR CASINO 2. VERIFY EXACT LOCATION WITH OWNER'S FACILITIES DEPARTMENT REPRESENTATIVE PRIOR TO COMMENCEMENT OF WORK.
- 9 EQUIPMENT IS LOCATED IN MAIN EQUIPMENT ROOM FOR CASINO 1. VERIFY EXACT LOCATION WITH OWNER'S FACILITIES DEPARTMENT REPRESENTATIVE PRIOR TO COMMENCEMENT OF WORK.

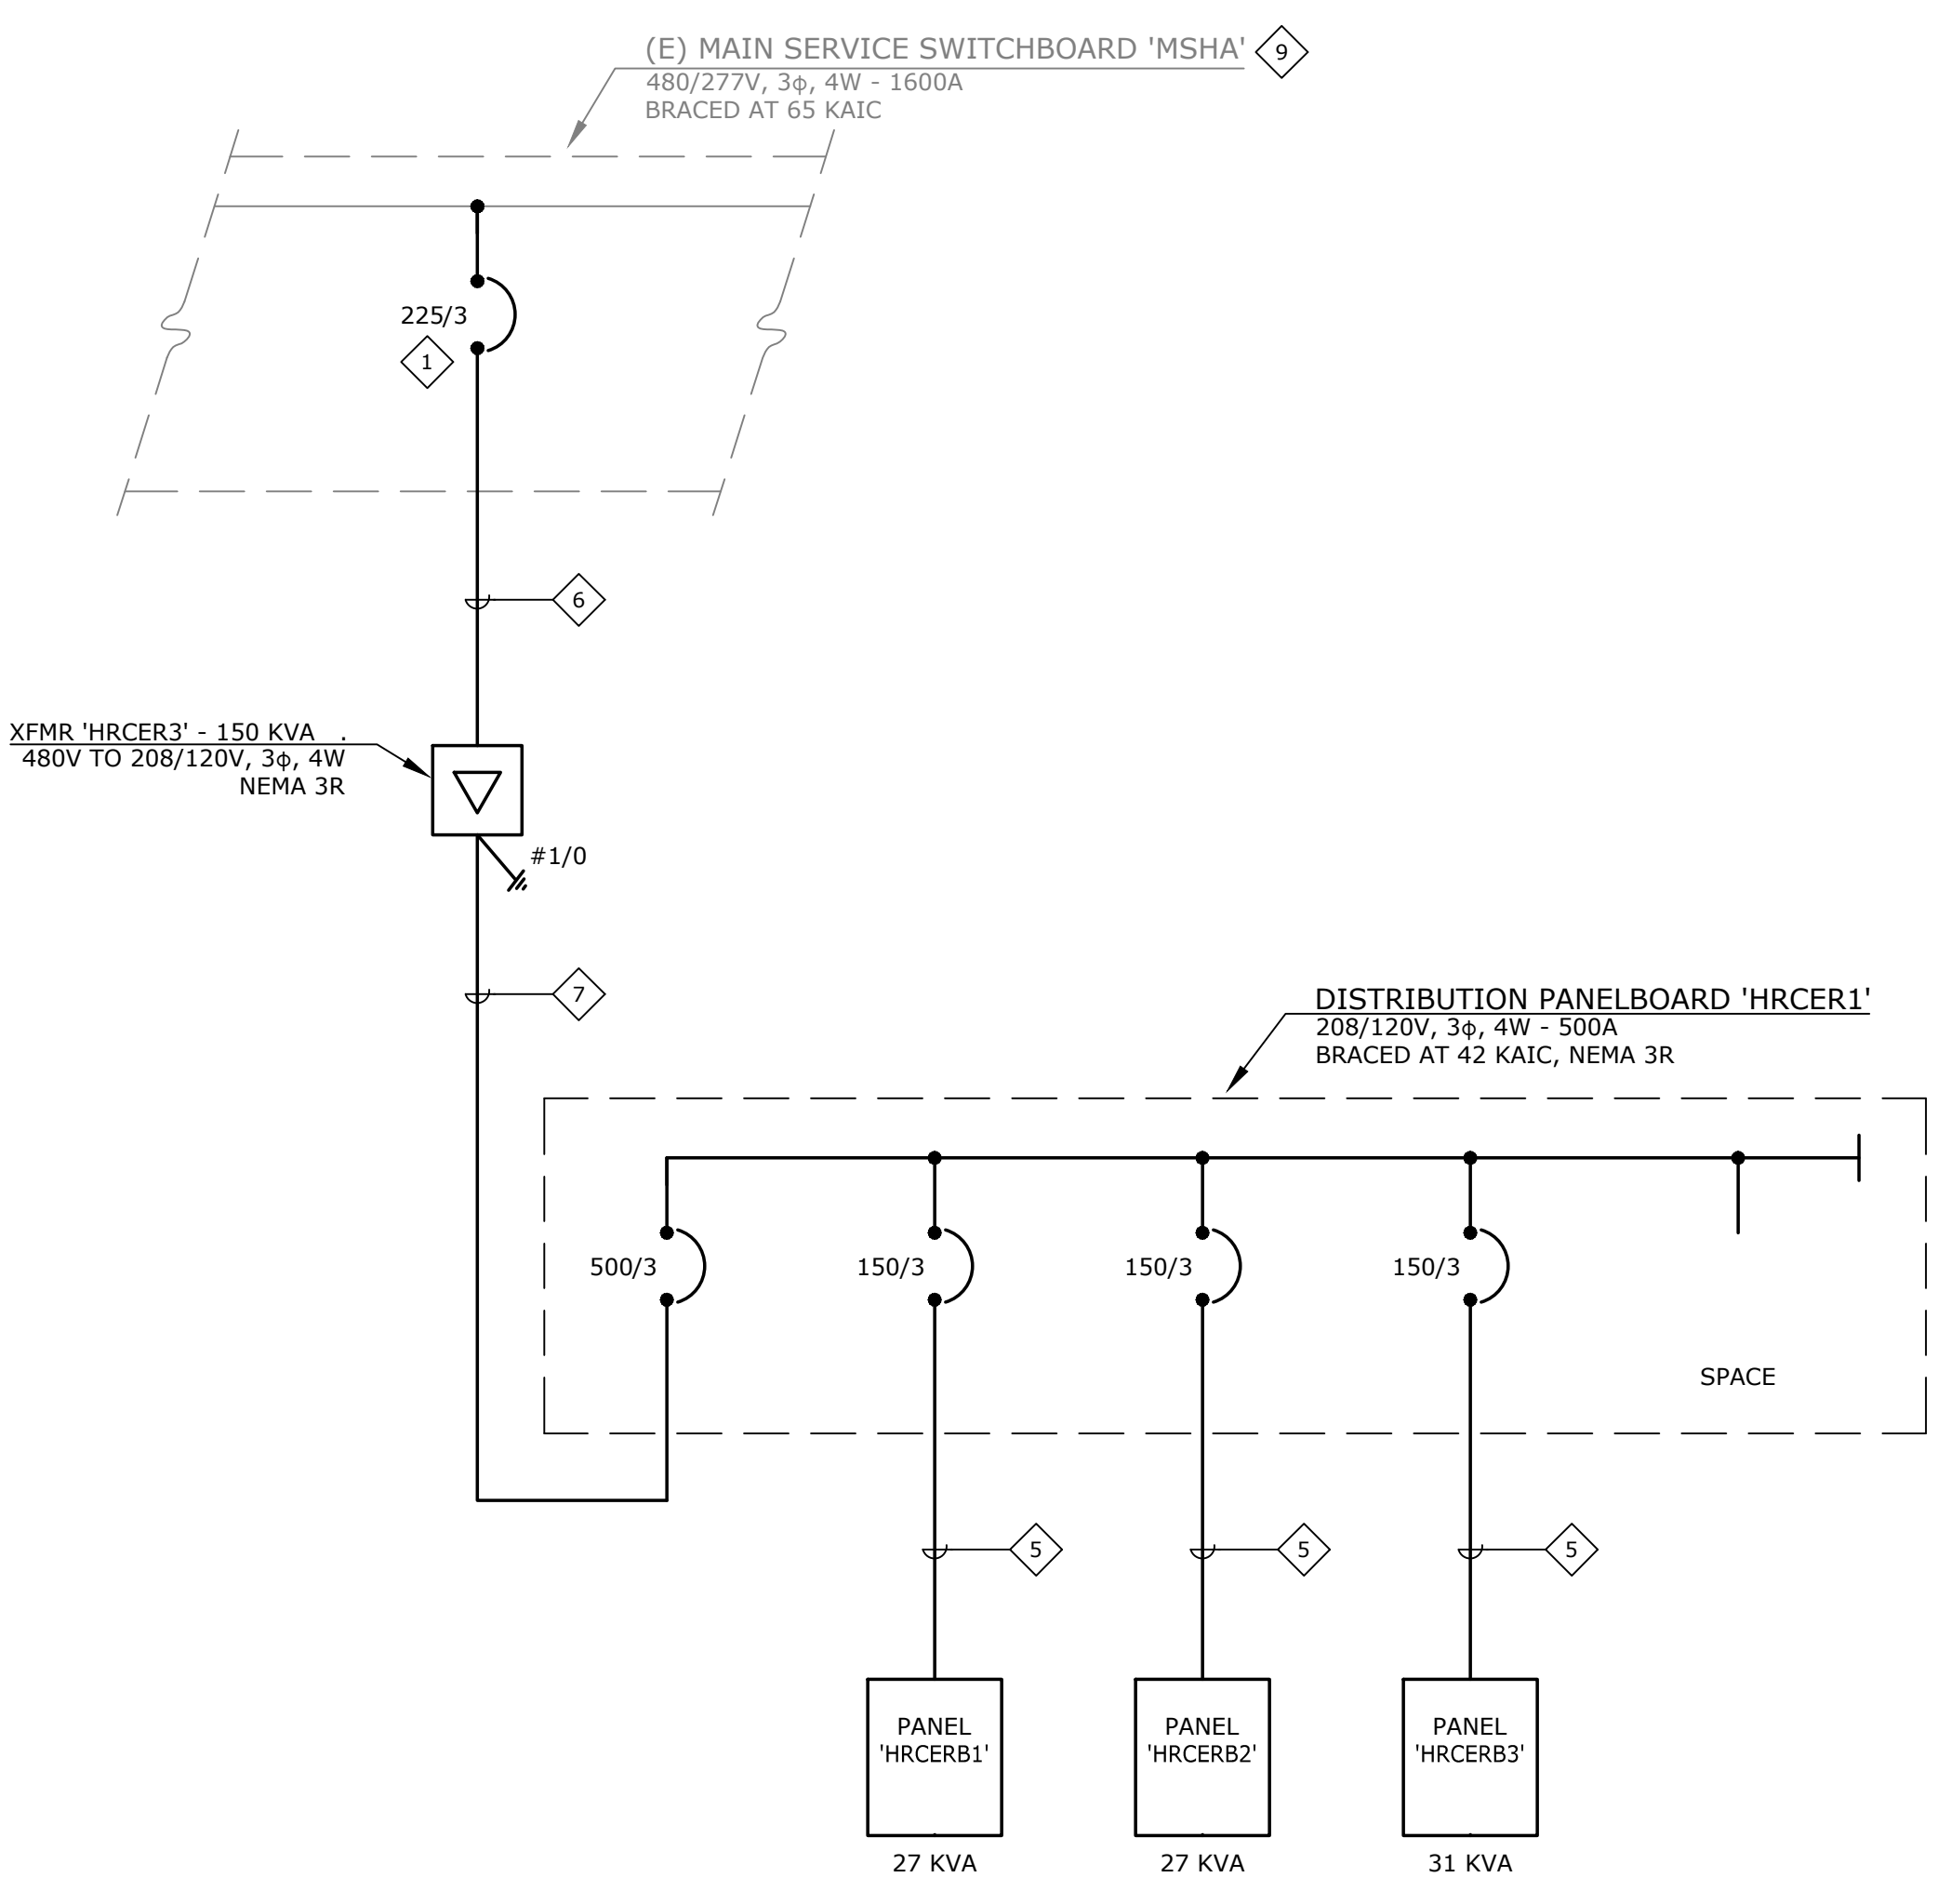

A PARTIAL SINGLE LINE DIAGRAM
NTS



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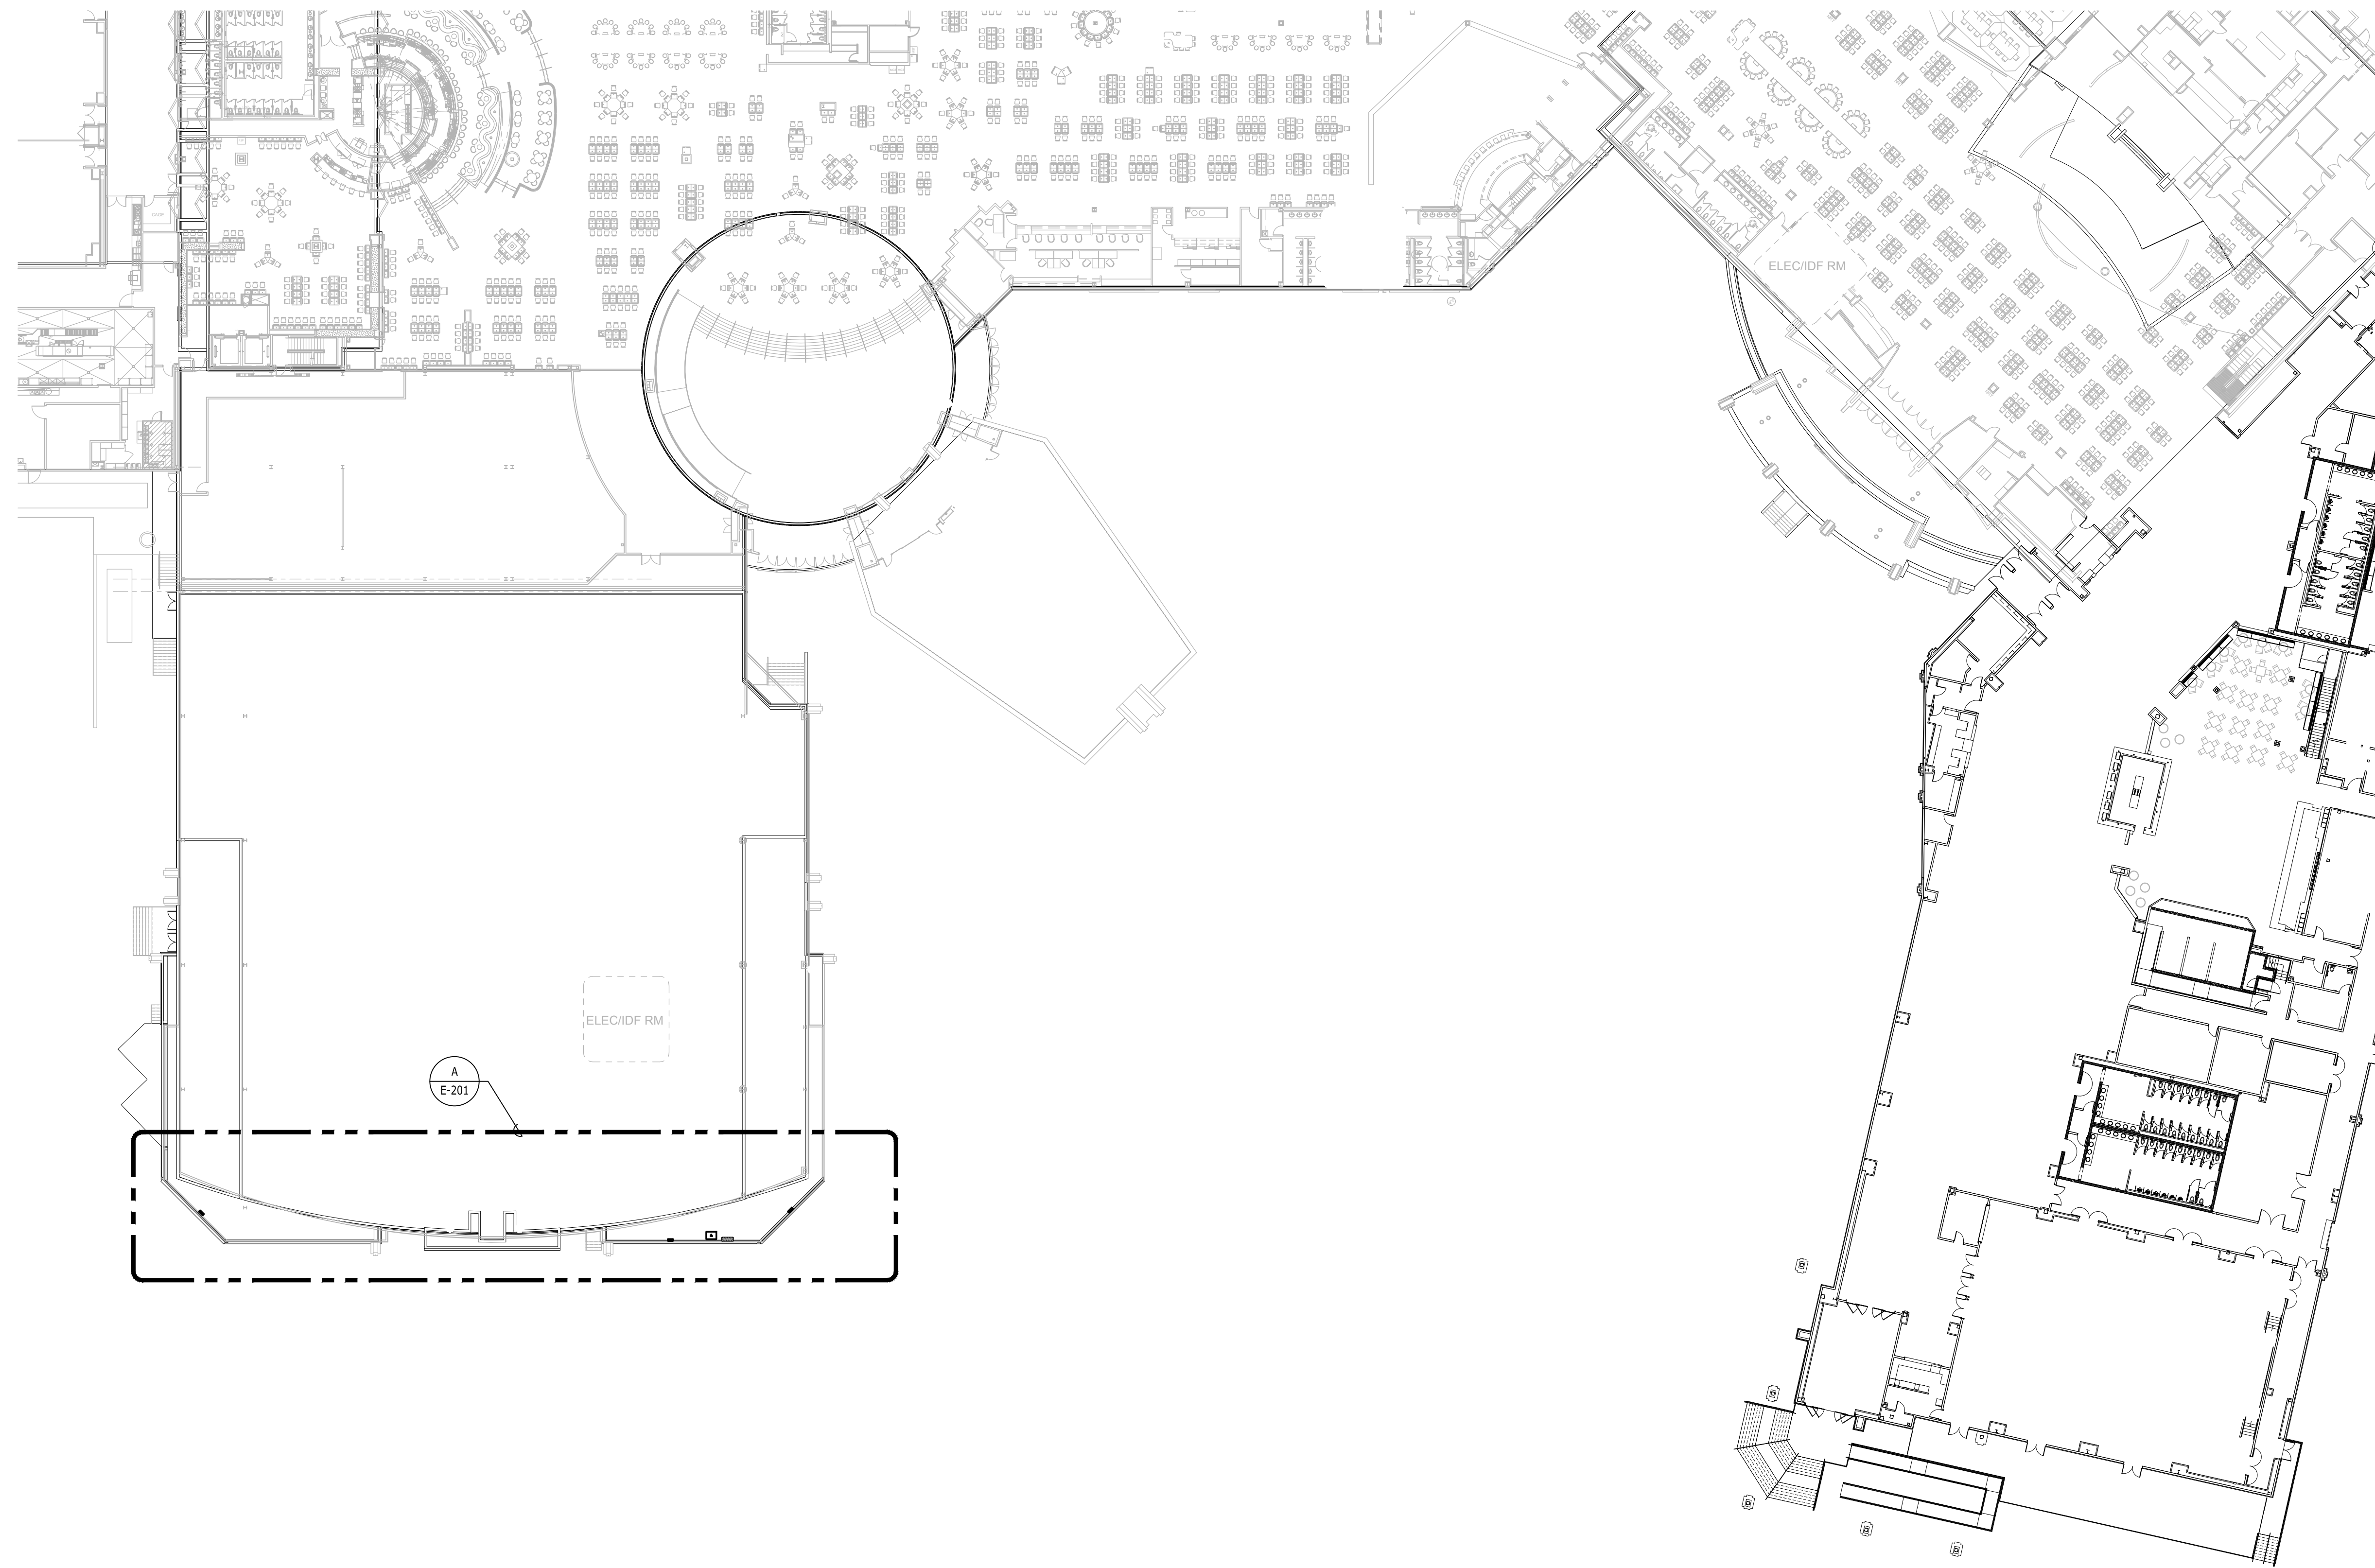
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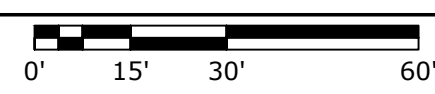
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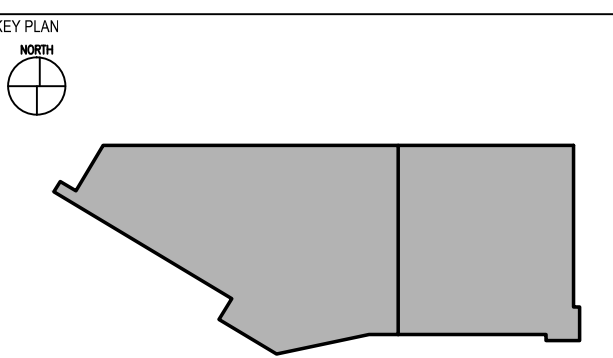
Cherokee Hard Rock Hotel & Casino



A
E-200 EXTERIOR POWER PLAN
1" = 30'-0"



EXTERIOR FACADE RENOVIATION



No.	Description	Date

EXTERIOR POWER PLAN

CONSTRUCTION SET

PROJECT NO. L17325 01
DRAWN BY: MSA
CHECKED BY: MSA
ISSUE DATE: 12/21/2018



E-200
Scale AS NOTED

SHEET NOTES:
 1. PROVIDE JUNCTION BOX FOR CONNECTION TO EXTERIOR READER BOARD. VERIFY EXACT JUNCTION BOX LOCATION AND CONNECTION REQUIREMENTS WITH EQUIPMENT INSTALLER PRIOR TO ROUGH-IN.




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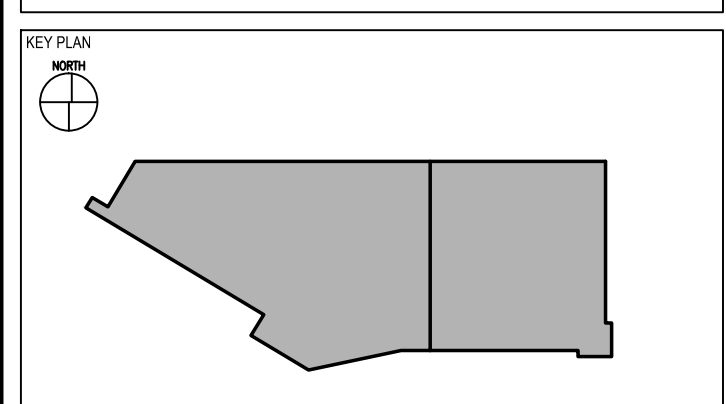
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Cherokee Hard Rock Hotel & Casino

ELEC/IDF RM



EXTERIOR FACADE RENOVATION

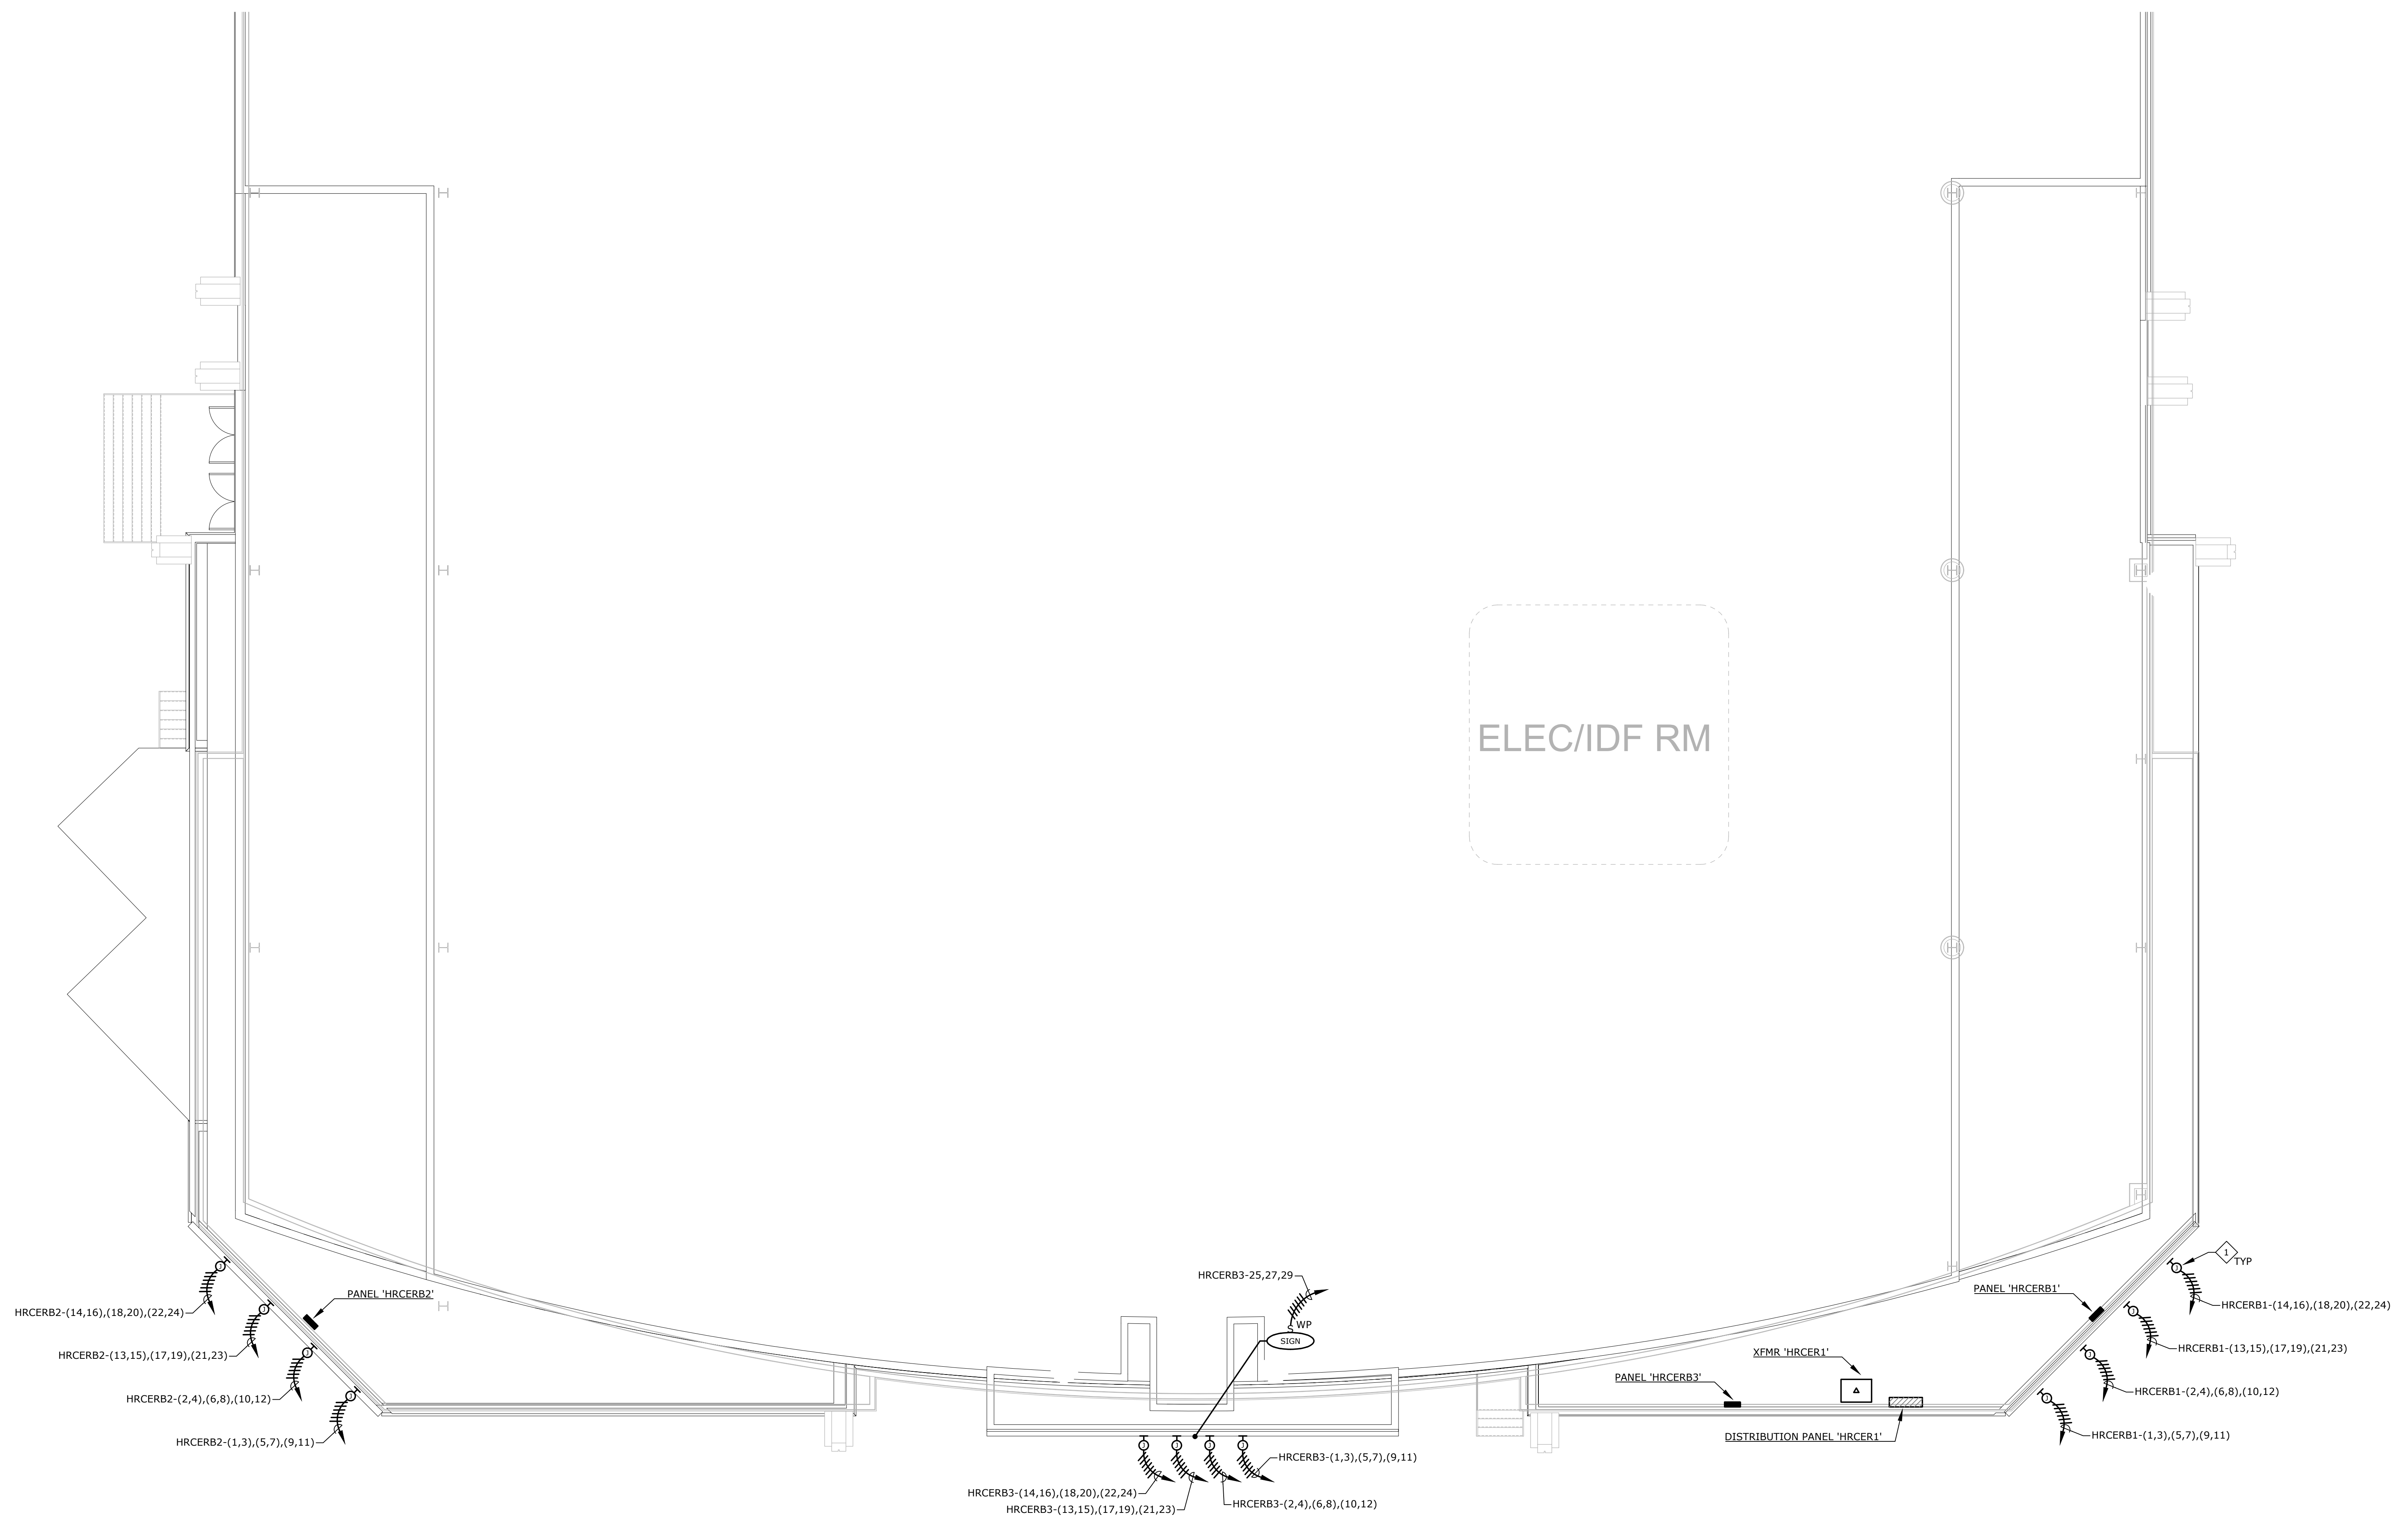


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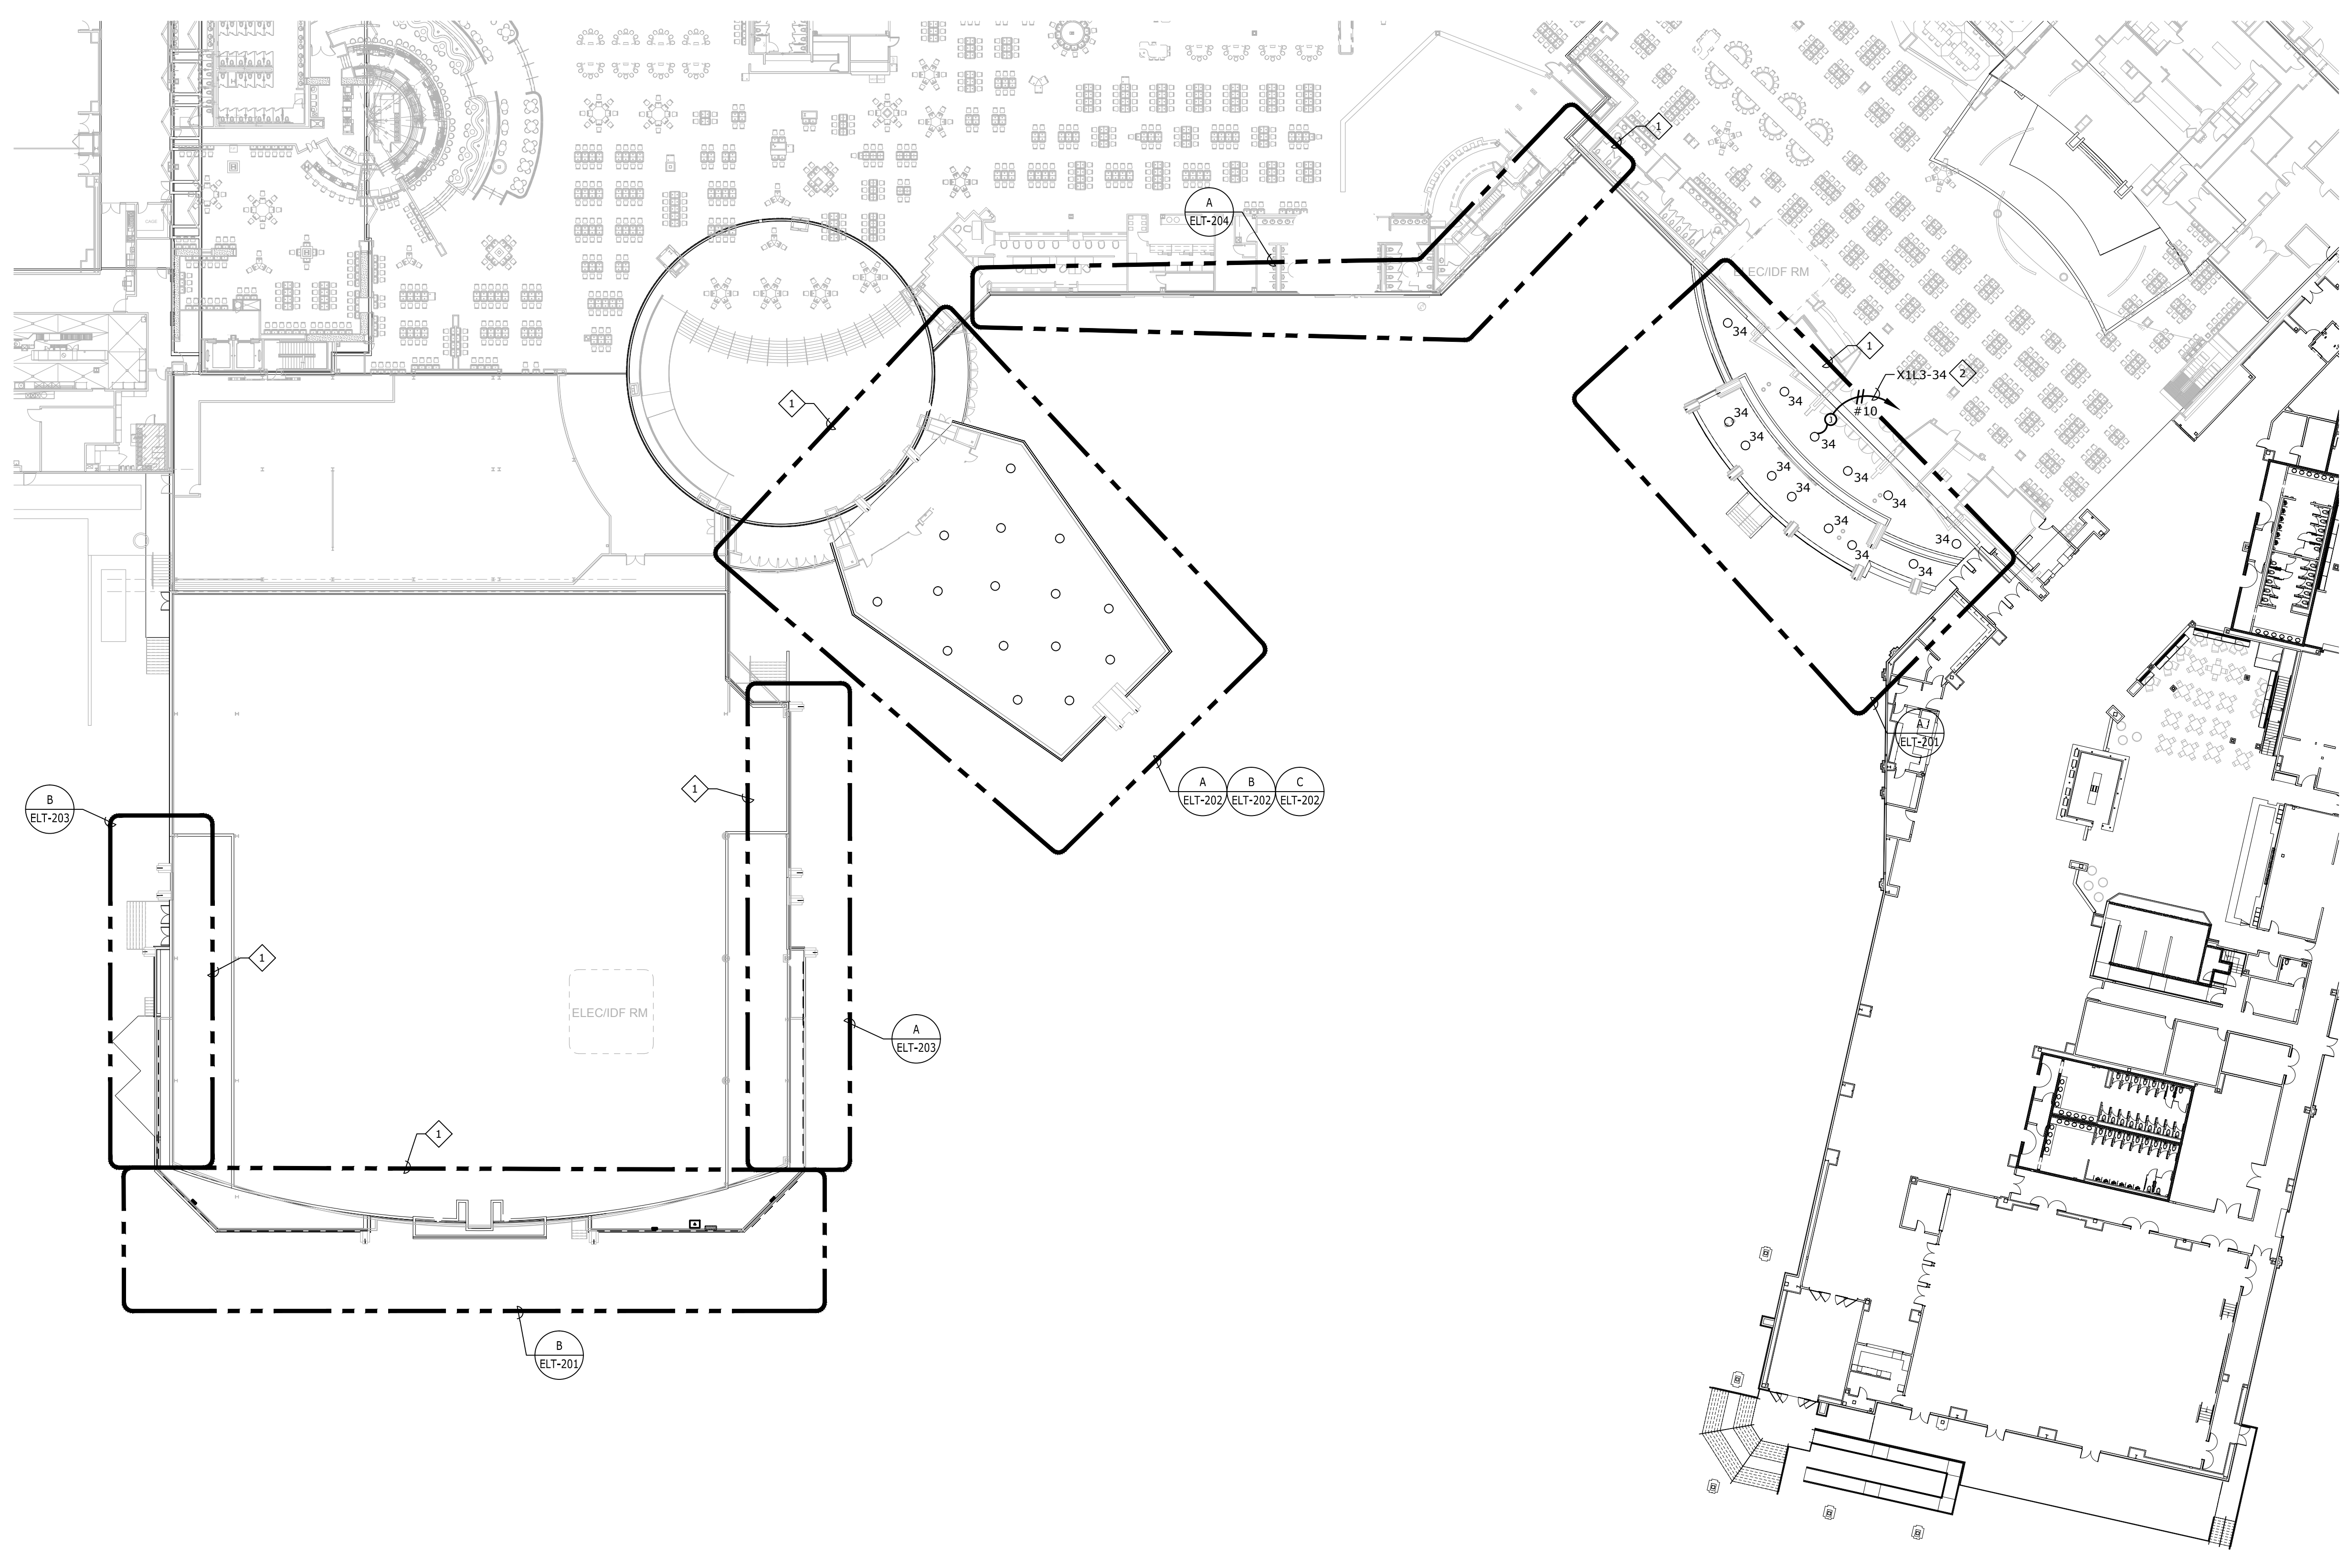
ENLARGED POWER PLAN
 CONSTRUCTION SET

PROJECT NO: L17325 01
 DRAWN BY: MSA
 CHECKED BY: MSA
 ISSUE DATE: 12/21/2018

E-201
 Scale AS NOTED

A ENLARGED POWER PLAN
 E-201 1/8" = 1'-0"



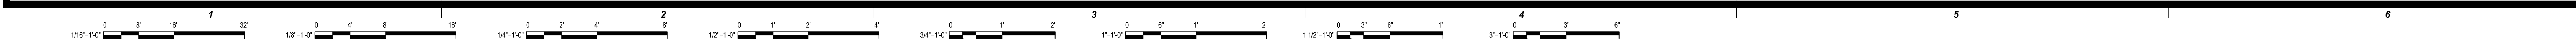

- GENERAL NOTES:**
- REFER TO E DRAWINGS (M/E ENGINEERING) AND ARCHITECTURAL LIGHTING DRAWINGS FOR FIXTURE SPECIFICATIONS AND MOUNTING INSTRUCTIONS.
- SHEET NOTES:**
- ALL EXISTING AREA LIGHTING IN LOWER FACADE/GROUND TO BE REMOVED. THIS SHALL INCLUDE, BUT NOT LIMITED TO LIGHT FIXTURES, OUTLET BOXES, POWER SUPPLIES, CONDUIT, CONDUCTORS, ETC. BACK TO NEAREST ACCESSIBLE POINT OR ORIGINATION OR SOURCE.
 - EXTEND AND CONNECT CIRCUITING FROM JUNCTION BOX TO OUTLETS IN AREA WITH SAME CIRCUIT NUMBERS, ROUTE #12 CONDUCTORS (MINIMUM) THROUGHOUT, UNLESS NOTED OTHERWISE.




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Cherokee Hard Rock Hotel & Casino

EXTERIOR FACADE RENOVATION



No.	Description	Date

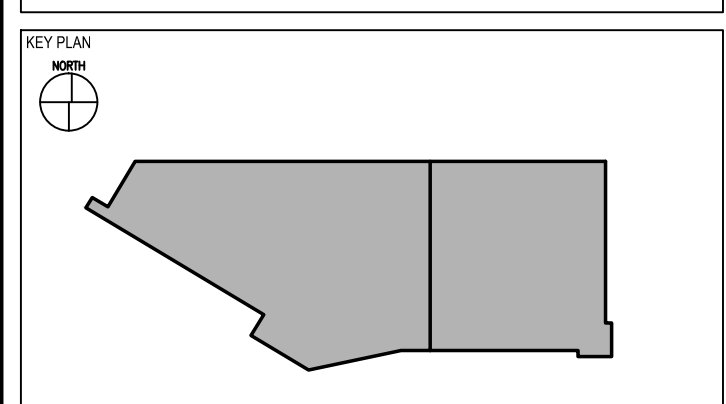
EXTERIOR LIGHTING PLAN

CONSTRUCTION SET

PROJECT NO: L17325 01
 DRAWN BY: MSA
 CHECKED BY: [Signature]
 ISSUE DATE: 12/21/2018

ELT-200
 Scale AS NOTED

A EXTERIOR LIGHTING PLAN
 1" = 30'-0"

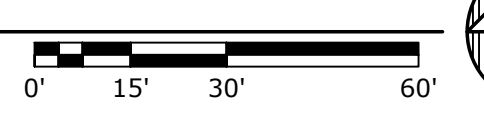

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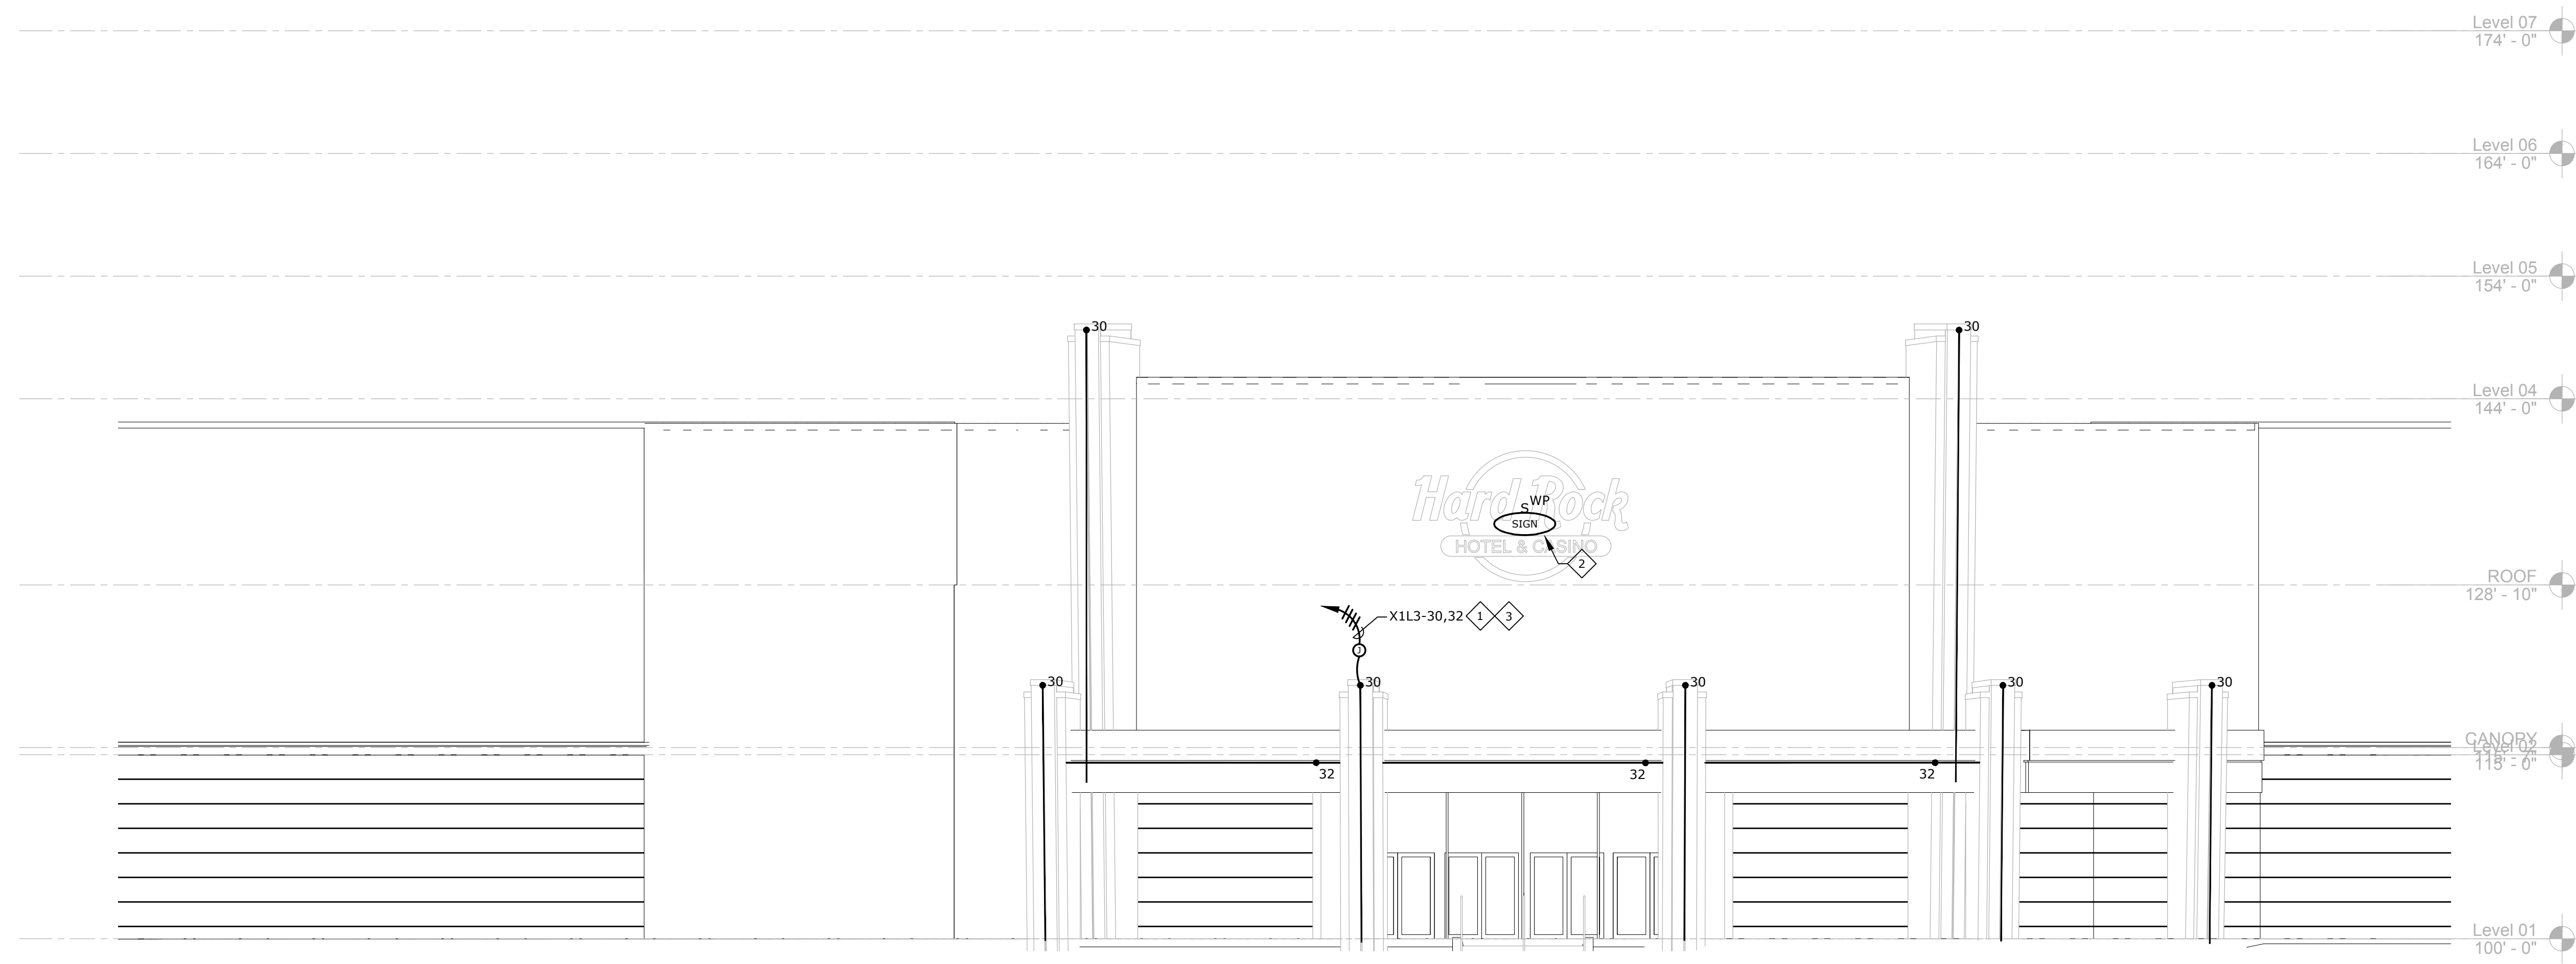
Cherokee Hard Rock Hotel & Casino

GENERAL NOTES:


- REFER TO E DRAWINGS (M/E ENGINEERING) AND ARCHITECTURAL LIGHTING DRAWINGS FOR FIXTURE SPECIFICATIONS AND MOUNTING INSTRUCTIONS.
- EXISTING PANEL 'LP1' IS LOCATED ON LEVEL 2 WITHIN THE JOINT VENUE. VERIFY EXACT PANEL LOCATION WITH OWNER'S REPRESENTATIVE PRIOR TO ROUGH-IN.

SHEET NOTES:

- EXTEND AND CONNECT CIRCUITING FROM JUNCTION BOX TO OUTLETS IN AREA WITH SAME CIRCUIT NUMBERS, ROUTE #12 CONDUCTORS (MINIMUM) THROUGHOUT, UNLESS NOTED OTHERWISE.
- THE CONTRACTOR IS TO REMOVE AND REINSTALL EXISTING SIGNAGE AT LOCATION INDICATED. CONNECT TO EXISTING SIGNAGE CIRCUITS WHICH SERVED SIGNAGE PRIOR TO DEMOLITION.
- CONNECT TO EXISTING CIRCUIT SERVING AREA PRIOR TO DEMOLITION.




A EAST LIGHTING ELEVATION
1/8" = 1'-0"
0' 2' 4' 8' 16'

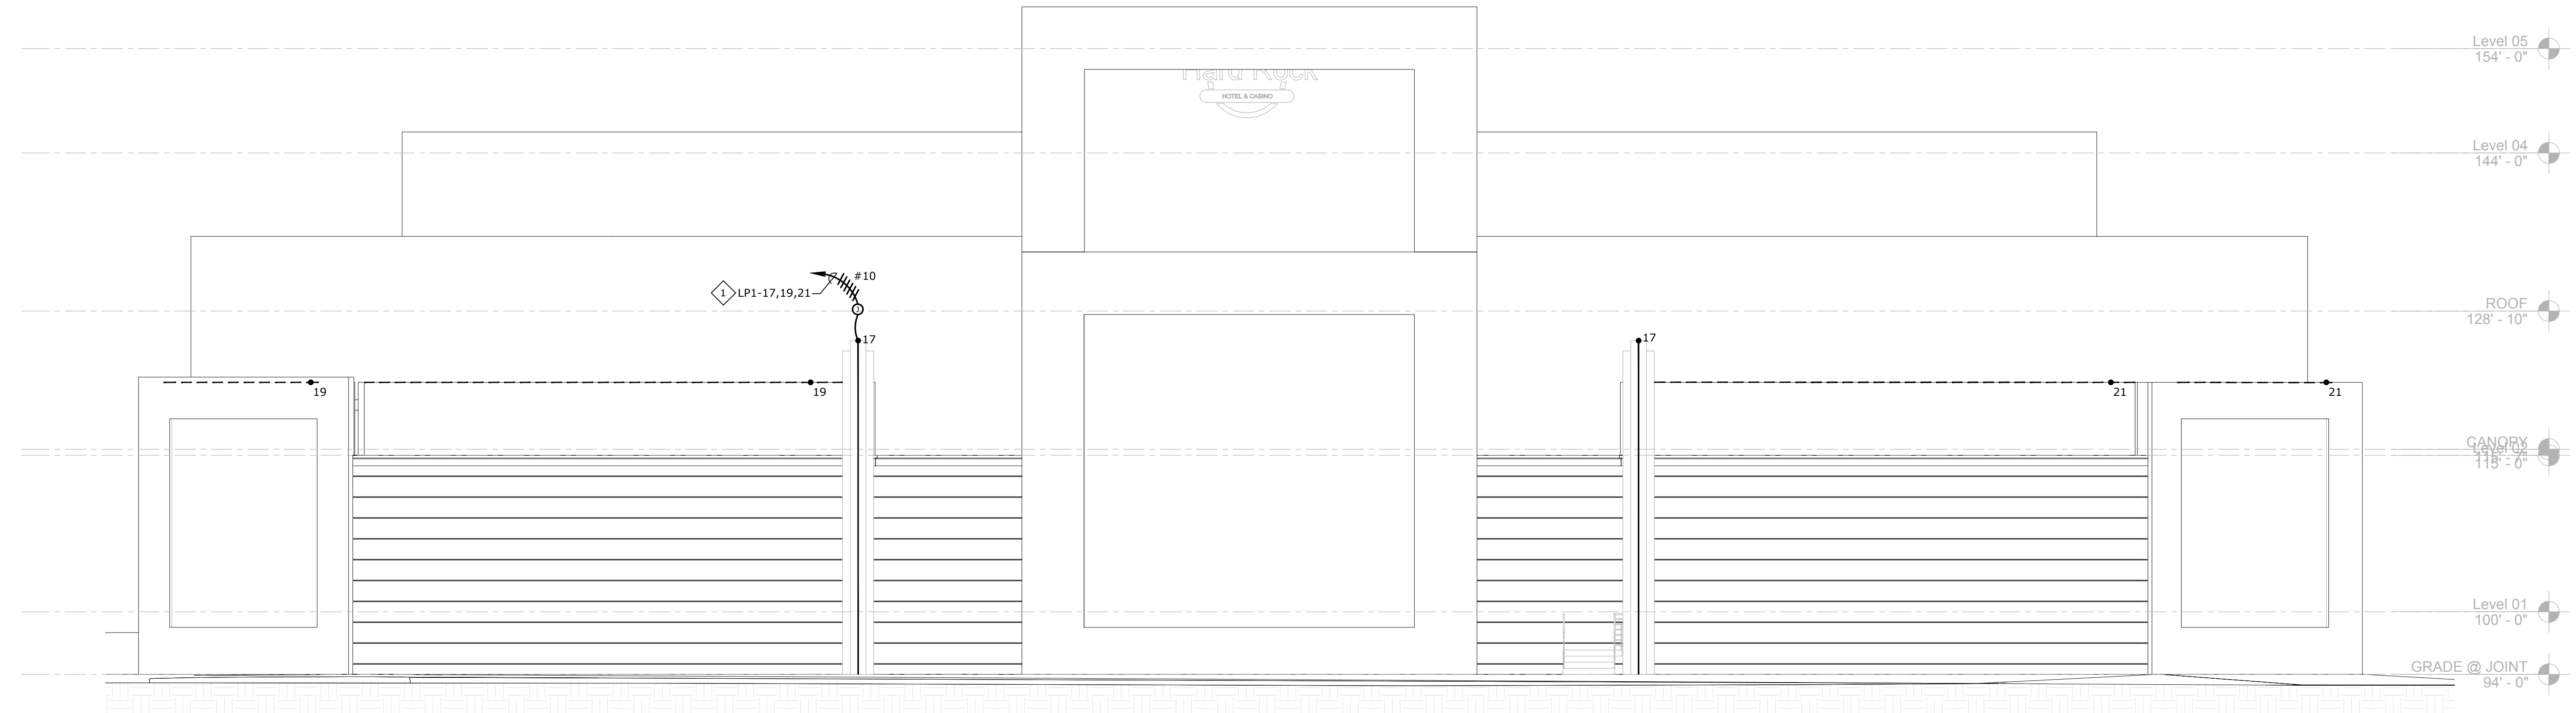

B EAST FACADE LIGHTING ELEVATION
1/8" = 1'-0"
0' 2' 4' 8' 16'

EXTERIOR FACADE RENOVATION

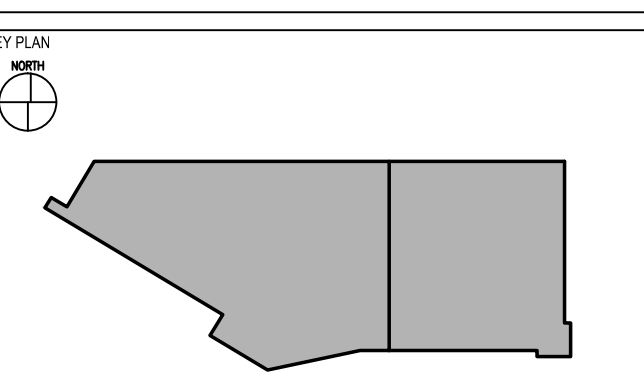


No.	Description	Date

EXTERIOR ELEVATIONS - EAST - LIGHTING

CONSTRUCTION SET

PROJECT NO: L17325 01
DRAWN BY: MSA
CHECKED BY: DAVID HILL
ISSUE DATE: 12/21/2018

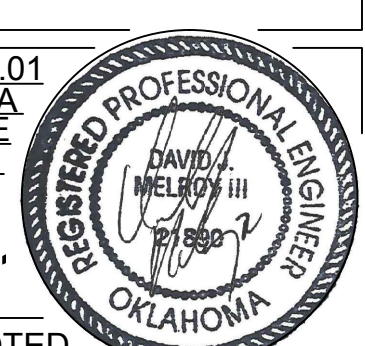

ELT-20
Scale AS NOTED

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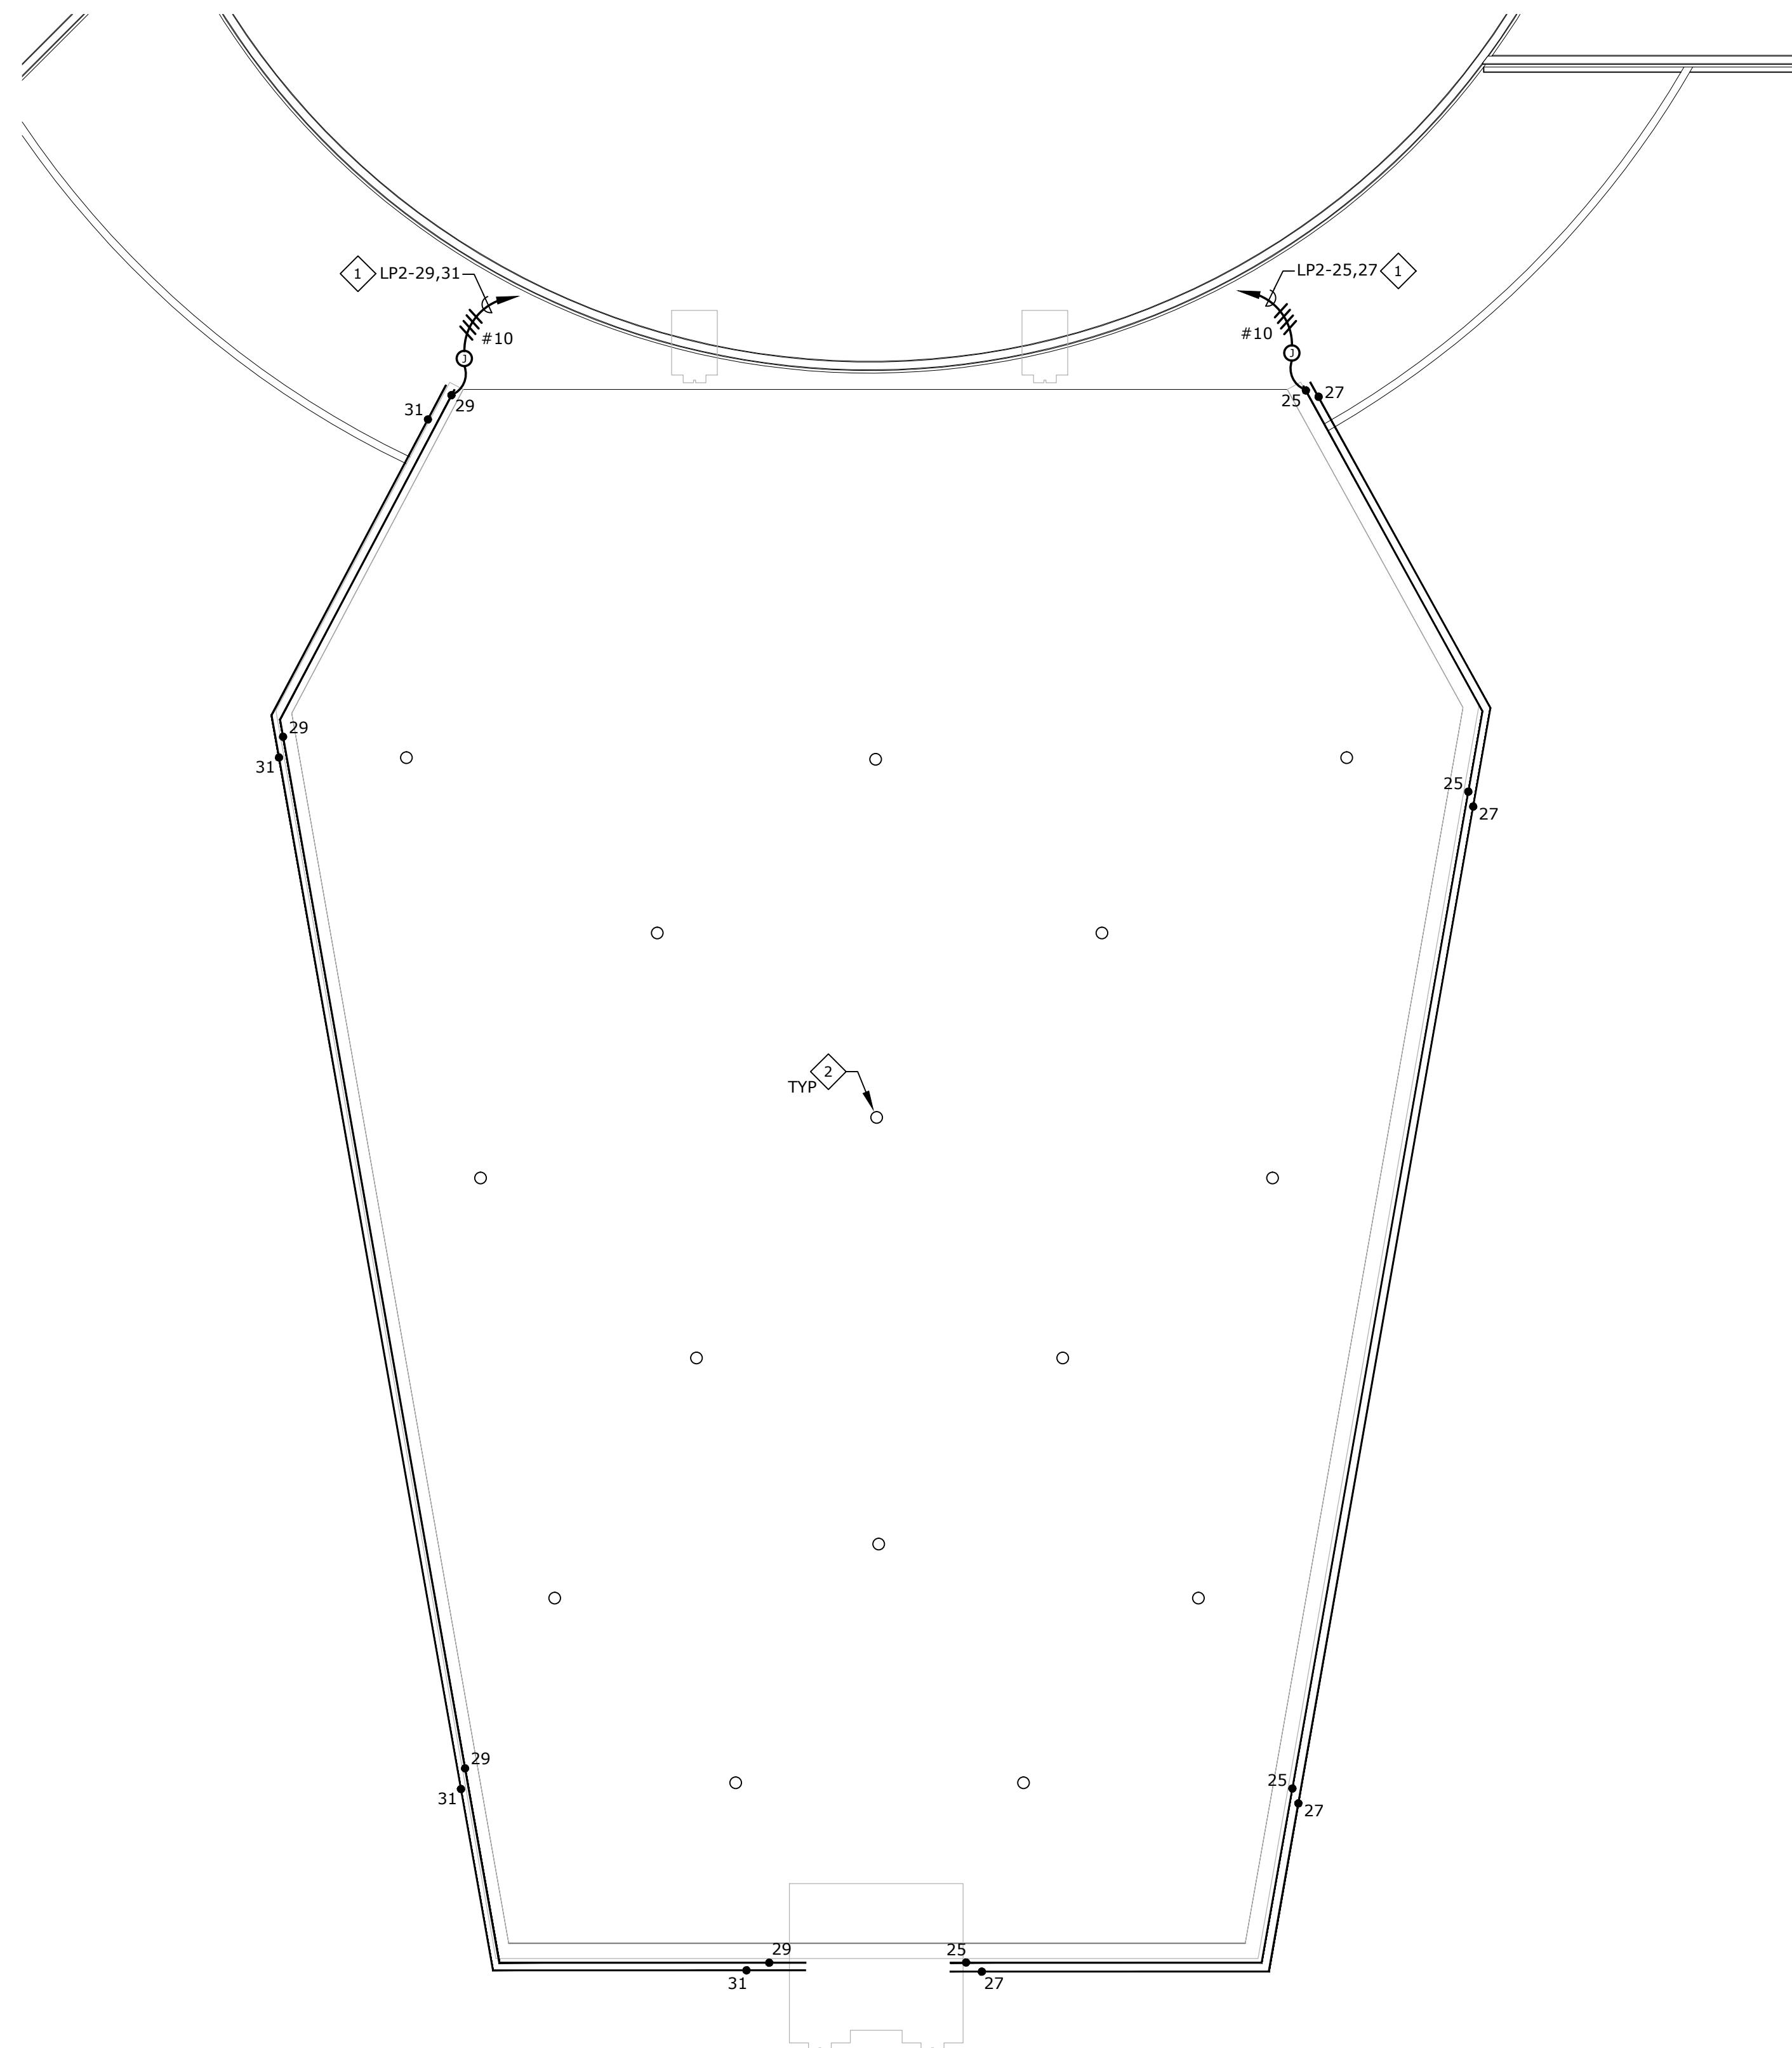
Cherokee Hard Rock Hotel & Casino

GENERAL NOTES:


1. REFER TO E DRAWINGS (M/E ENGINEERING) AND ARCHITECTURAL LIGHTING DRAWINGS FOR FIXTURE SPECIFICATIONS AND MOUNTING INSTRUCTIONS.
2. EXISTING PANEL 'LP2' IS LOCATED ON LEVEL 2 WITHIN THE JOINT VENUE. VERIFY EXACT PANEL LOCATION WITH OWNER'S REPRESENTATIVE PRIOR TO ROUGH-IN.

SHEET NOTES:


1. EXTEND AND CONNECT CIRCUITING FROM JUNCTION BOX TO OUTLETS IN AREA WITH SAME CIRCUIT NUMBERS, ROUTE #12 CONDUCTORS (MINIMUM) THROUGHOUT, UNLESS NOTED OTHERWISE.
2. EXISTING LIGHT FIXTURE TO BE REPLACED WITH NEW AT SAME LOCATION.
3. REFER TO DETAIL B/THIS SHEET FOR CIRCUIT REQUIREMENTS.
4. REFER TO DETAIL A/THIS SHEET FOR CIRCUIT REQUIREMENTS.



A PORTE COCHERE LIGHTING TOP VIEW
ELT-202 1/8" = 1'-0"

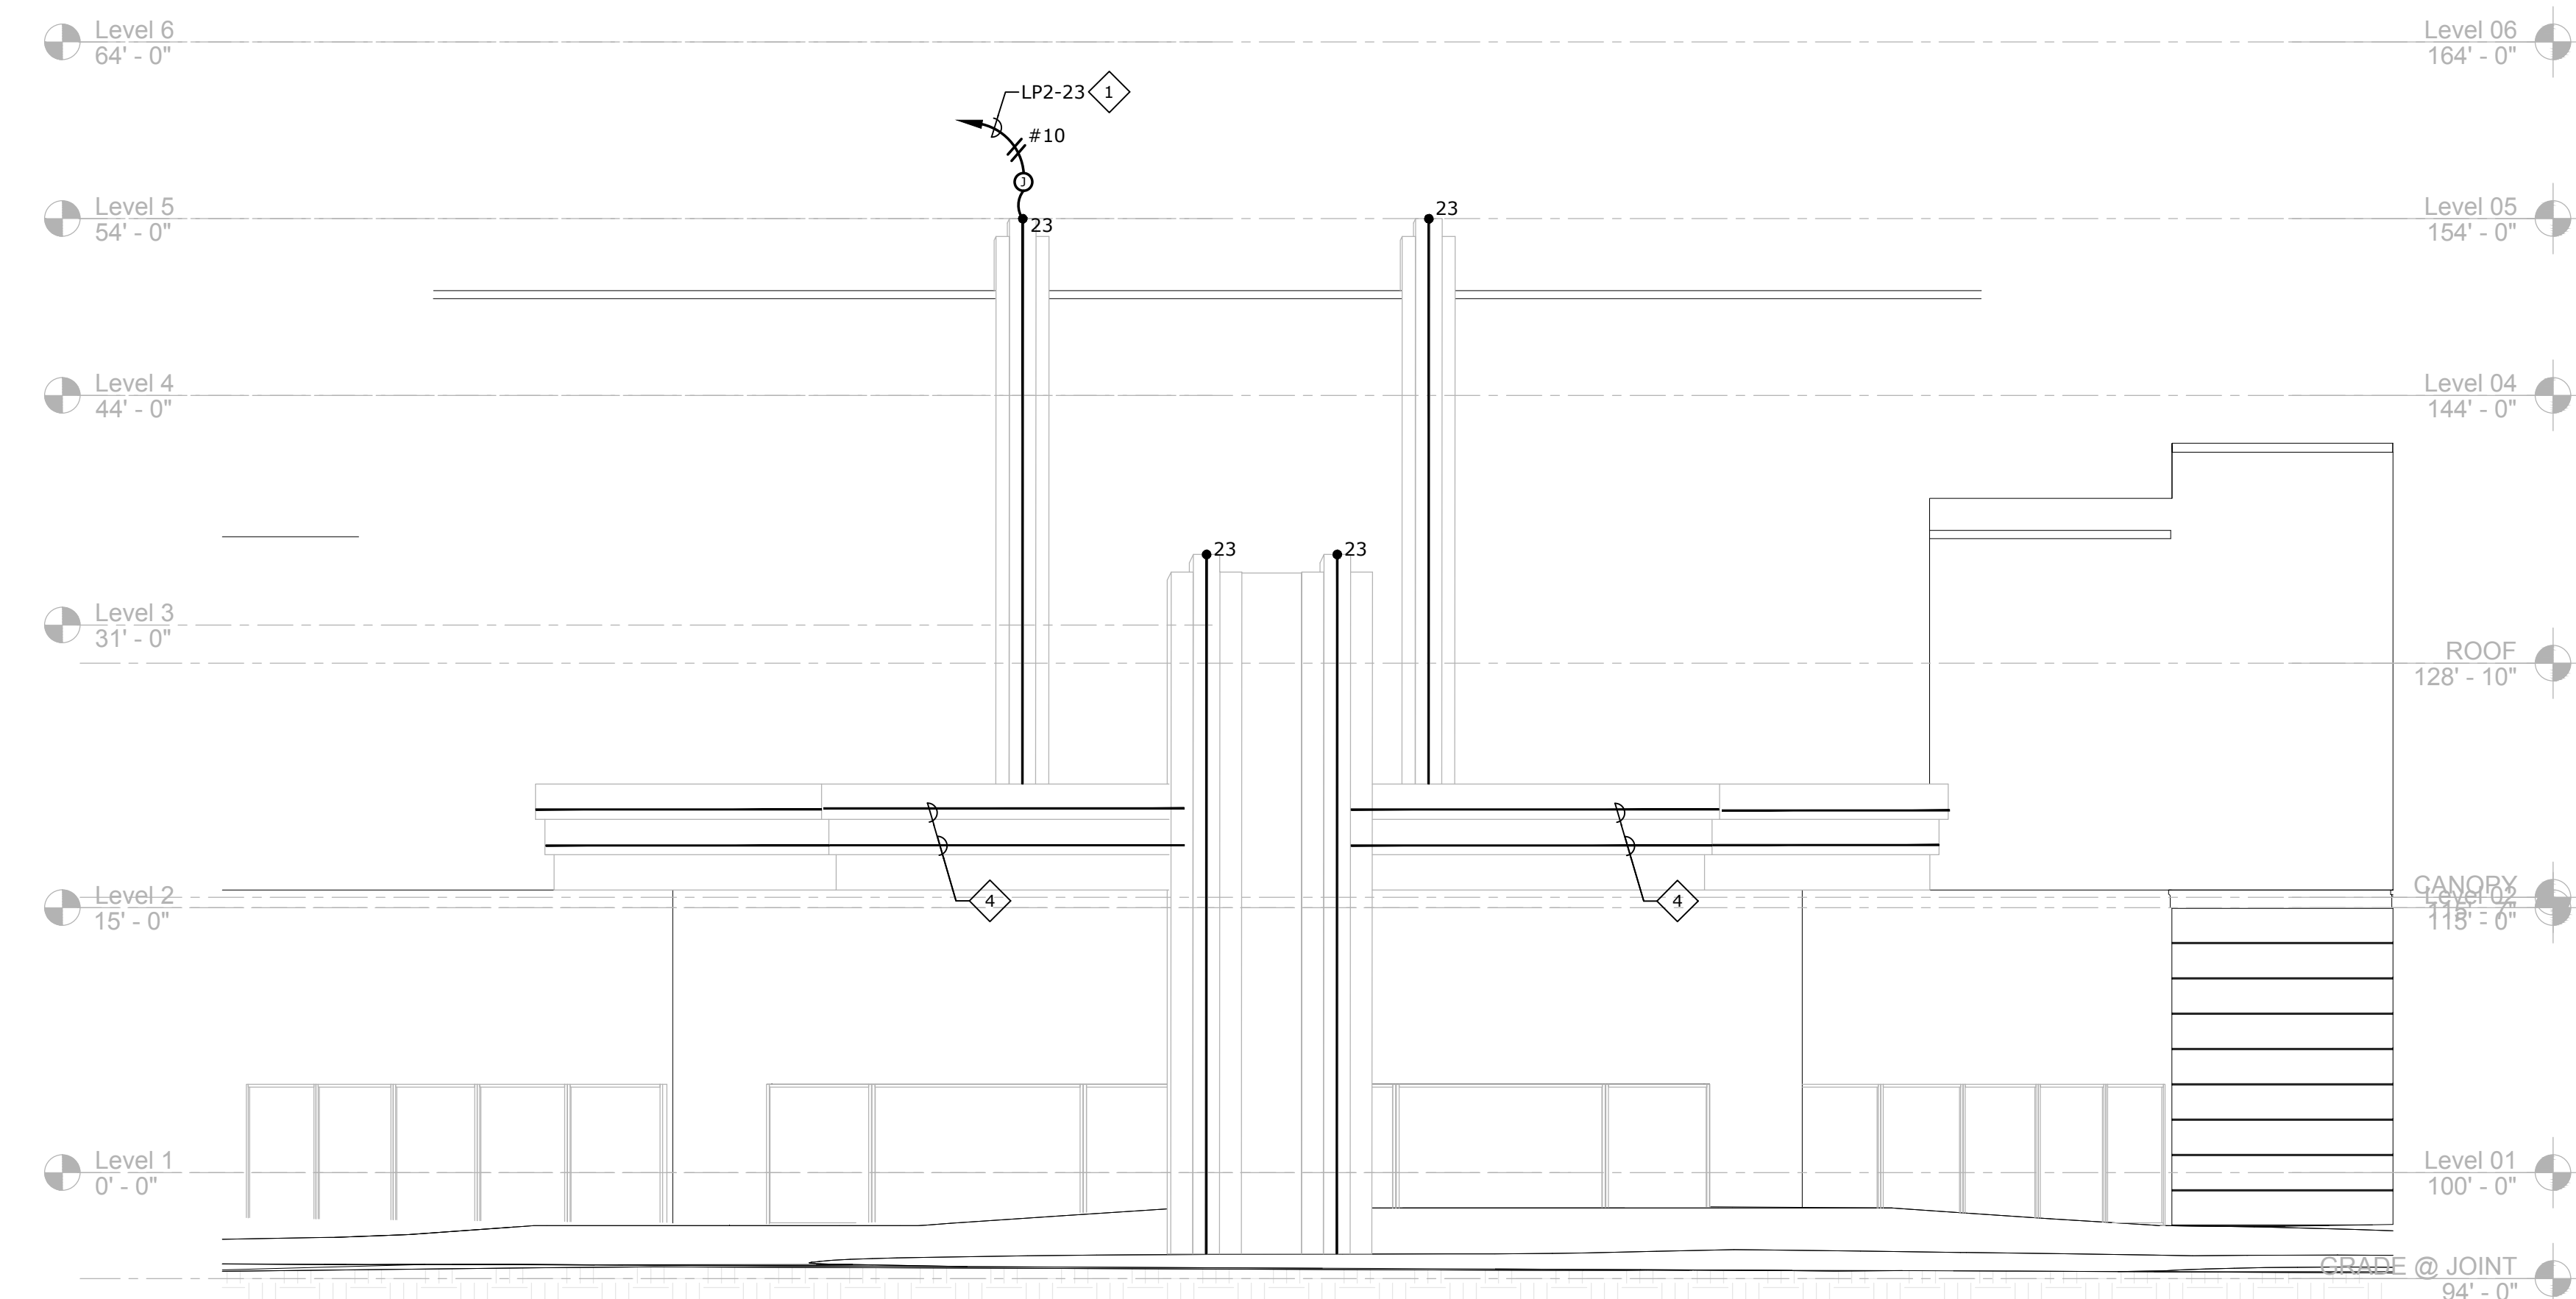


B CASINO 1 PORTE COCHERE LIGHTING ELEVATION
ELT-202 1/8" = 1'-0"

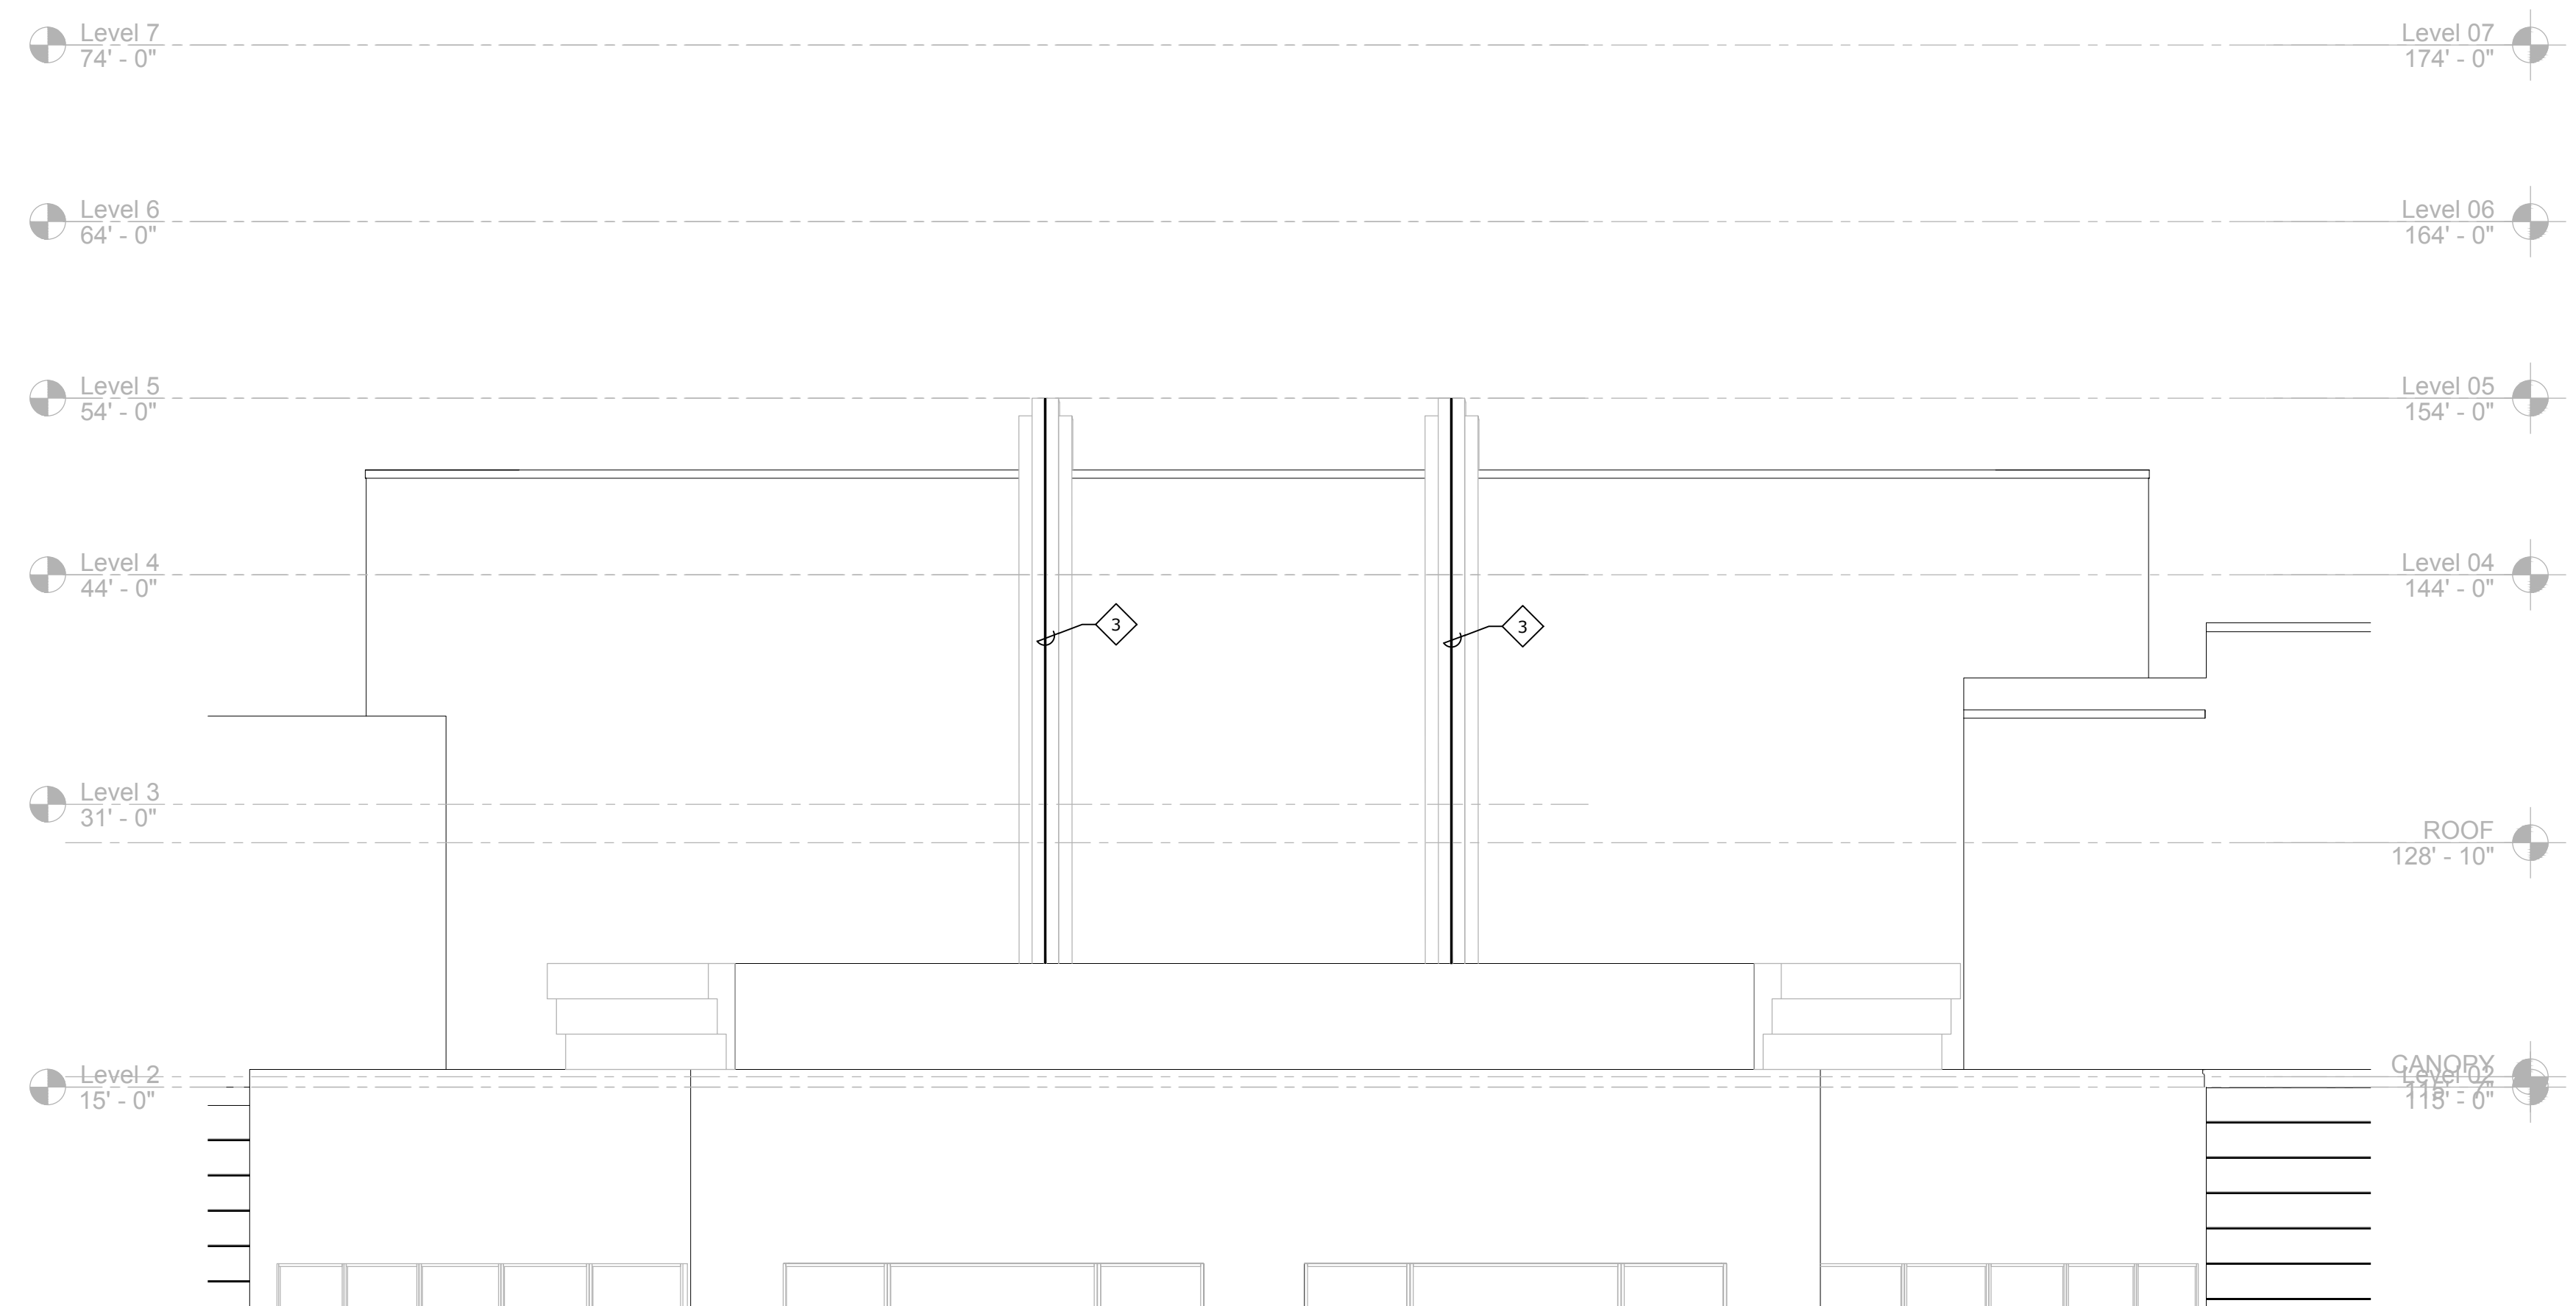

C CASINO 1 ROTUNDA LIGHTING ELEVATION
ELT-202 1/8" = 1'-0"

EXTERIOR FACADE RENOVATION

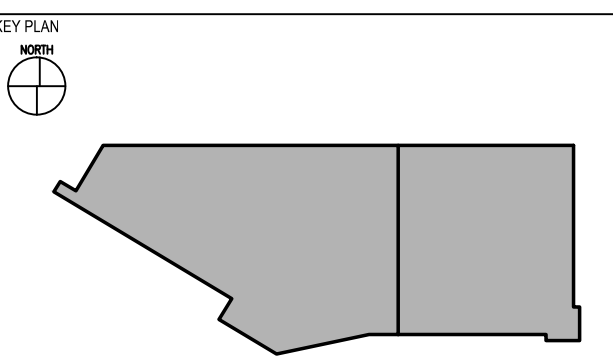

No.	Description	Date

EXTERIOR ELEVATIONS - ROTUNDA - LIGHTING

CONSTRUCTION SET

PROJECT NO: L17325 01
DRAWN BY: M&A
CHECKED BY:
ISSUE DATE: 12/21/2018

ELT-202
Scale: AS NOTED



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GENERAL NOTES:

- REFER TO E DRAWINGS (M/E ENGINEERING) AND ARCHITECTURAL LIGHTING DRAWINGS FOR FIXTURE SPECIFICATIONS AND MOUNTING INSTRUCTIONS.
- EXISTING PANEL 'LP1' IS LOCATED ON LEVEL 2 WITHIN THE JOINT VENUE. VERIFY EXACT PANEL LOCATION WITH OWNER'S REPRESENTATIVE PRIOR TO ROUGH-IN.

SHEET NOTES:

- EXTEND AND CONNECT CIRCUITING FROM JUNCTION BOX TO OUTLETS IN AREA WITH SAME CIRCUIT NUMBERS, ROUTE #12 CONDUCTORS (MINIMUM) THROUGHOUT, UNLESS NOTED OTHERWISE.

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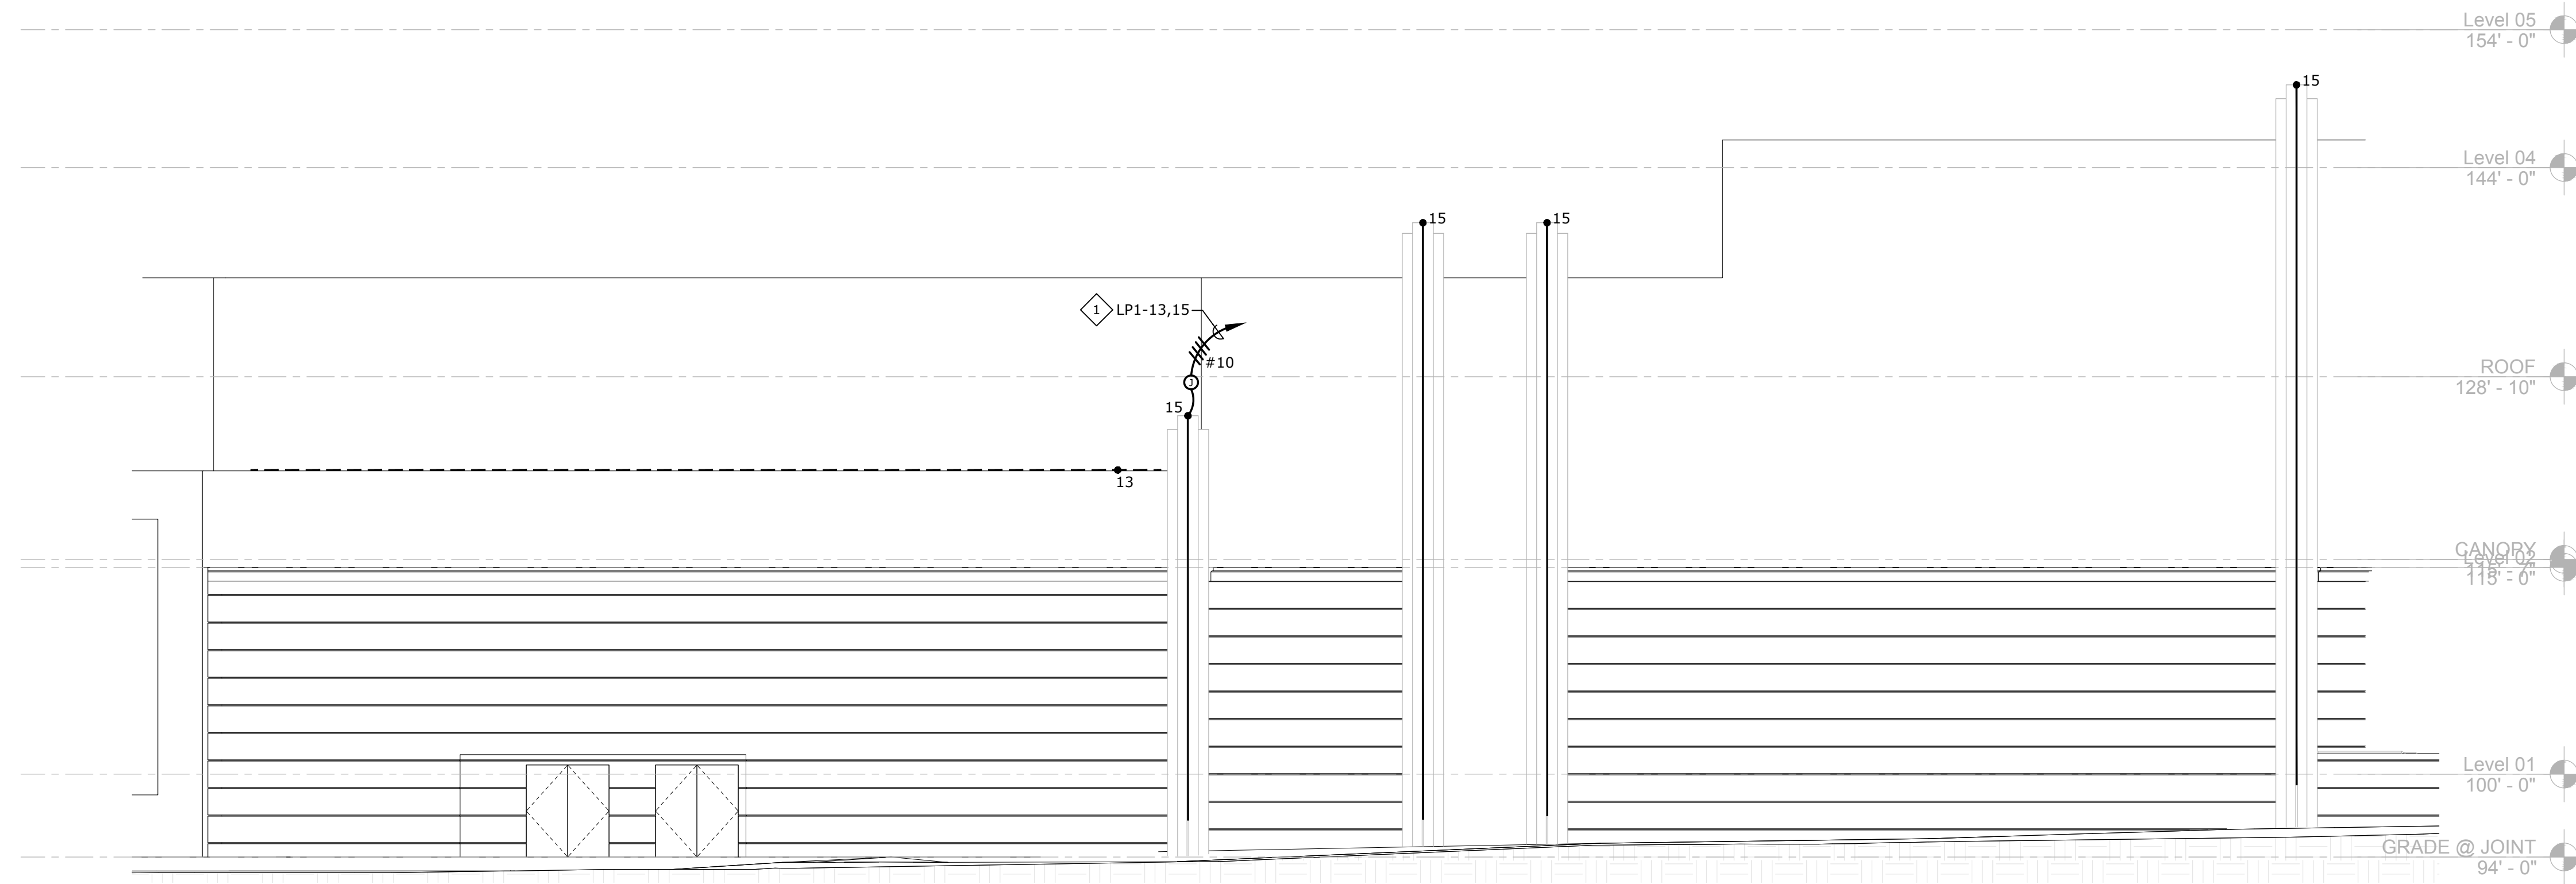
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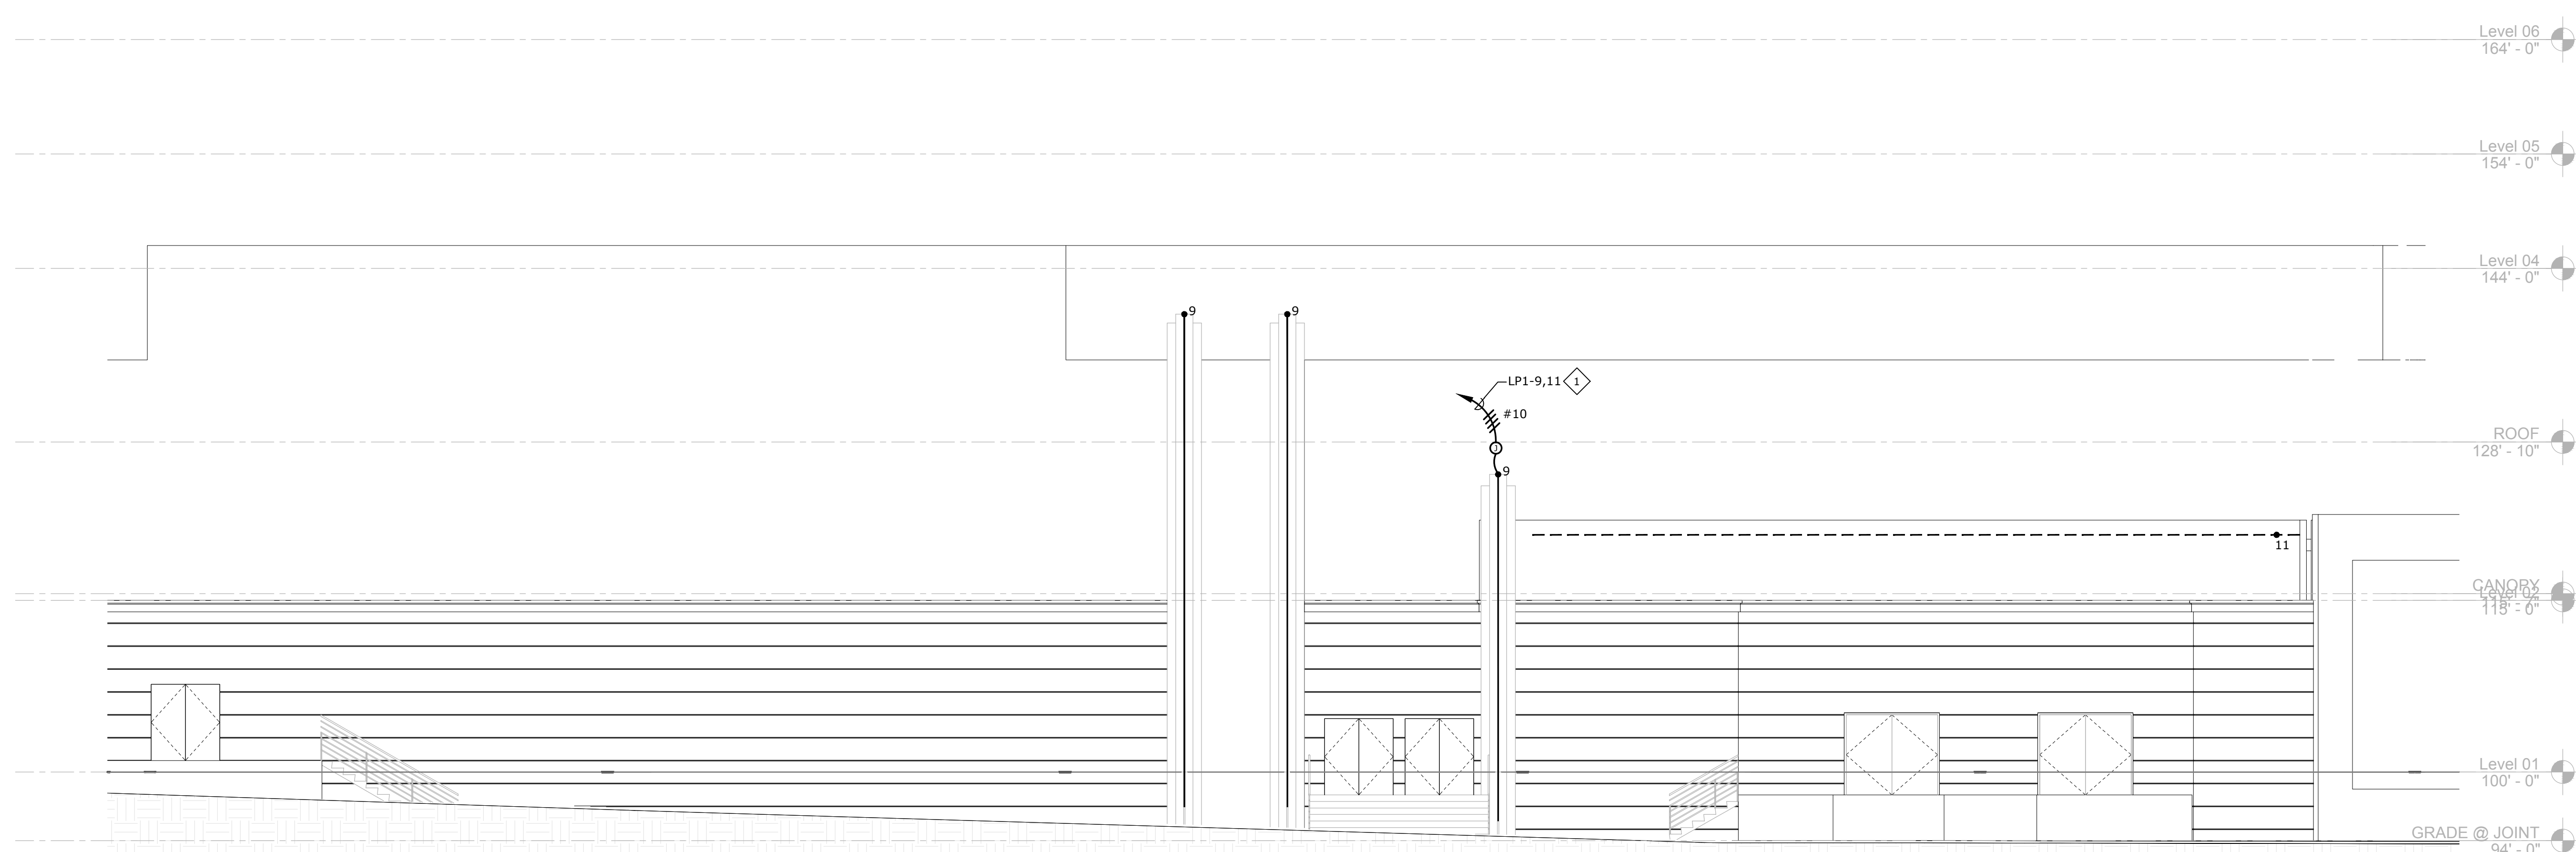
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716-645-5092

Cherokee Hard Rock Hotel & Casino




A SOUTH FACADE LIGHTING ELEVATION
ELT-203 1/8" = 1'-0"
0' 2' 4' 8' 16'



B NORTH FACADE LIGHTING ELEVATION
ELT-203 1/8" = 1'-0"
0' 2' 4' 8' 16'

EXTERIOR FACADE RENOVATION

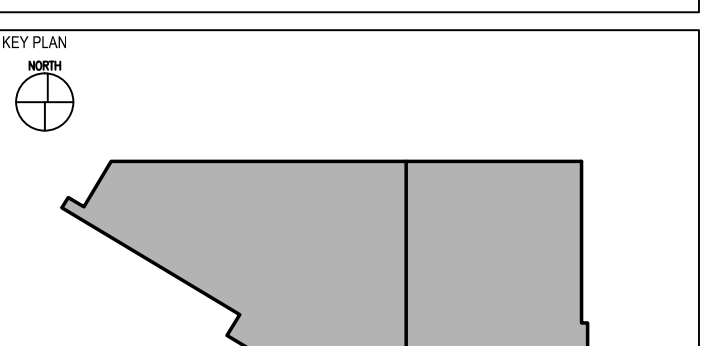


No.	Description	Date

EXTERIOR ELEVATIONS - NORTH & SOUTH FACADE - LIGHTING

CONSTRUCTION SET

PROJECT NO: L17325 01
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ISSUE DATE: 12/21/2018

ELT-203
Scale AS NOTED

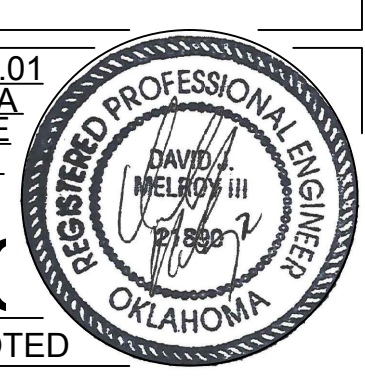

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716-645-0592

GENERAL NOTES:


- REFER TO E DRAWINGS (M/E ENGINEERING) AND ARCHITECTURAL LIGHTING DRAWINGS FOR FIXTURE SPECIFICATIONS AND MOUNTING INSTRUCTIONS.
- EXISTING PANEL 'X1L3' IS LOCATED IN EXISTING CASINO 3. VERIFY EXACT LOCATION WITH OWNER'S REPRESENTATIVE PRIOR TO ROUGH-IN.

SHEET NOTES:

- EXTEND AND CONNECT CIRCUITING FROM JUNCTION BOX TO OUTLETS IN AREA WITH SAME CIRCUIT NUMBERS, ROUTE #12 CONDUCTORS (MINIMUM) THROUGHOUT, UNLESS NOTED OTHERWISE.

Cherokee Hard Rock Hotel & Casino

EXTERIOR FACADE RENOVIATION

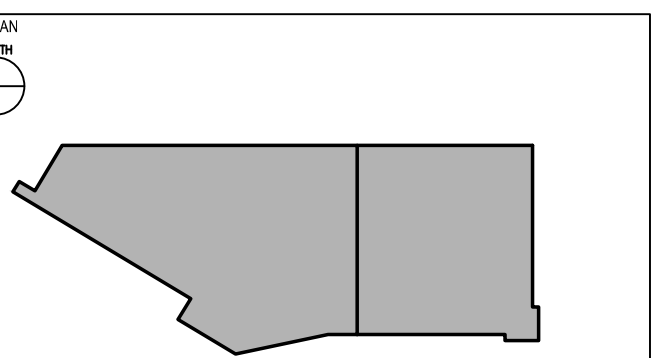


No.	Description	Date

EXTERIOR ELEVATIONS - EAST - LIGHTING


CONSTRUCTION SET

PROJECT NO: L17325 01
DRAWN BY: MSA
CHECKED BY: MSA
ISSUE DATE: 12/21/2018

ELT-204
Scale AS NOTED

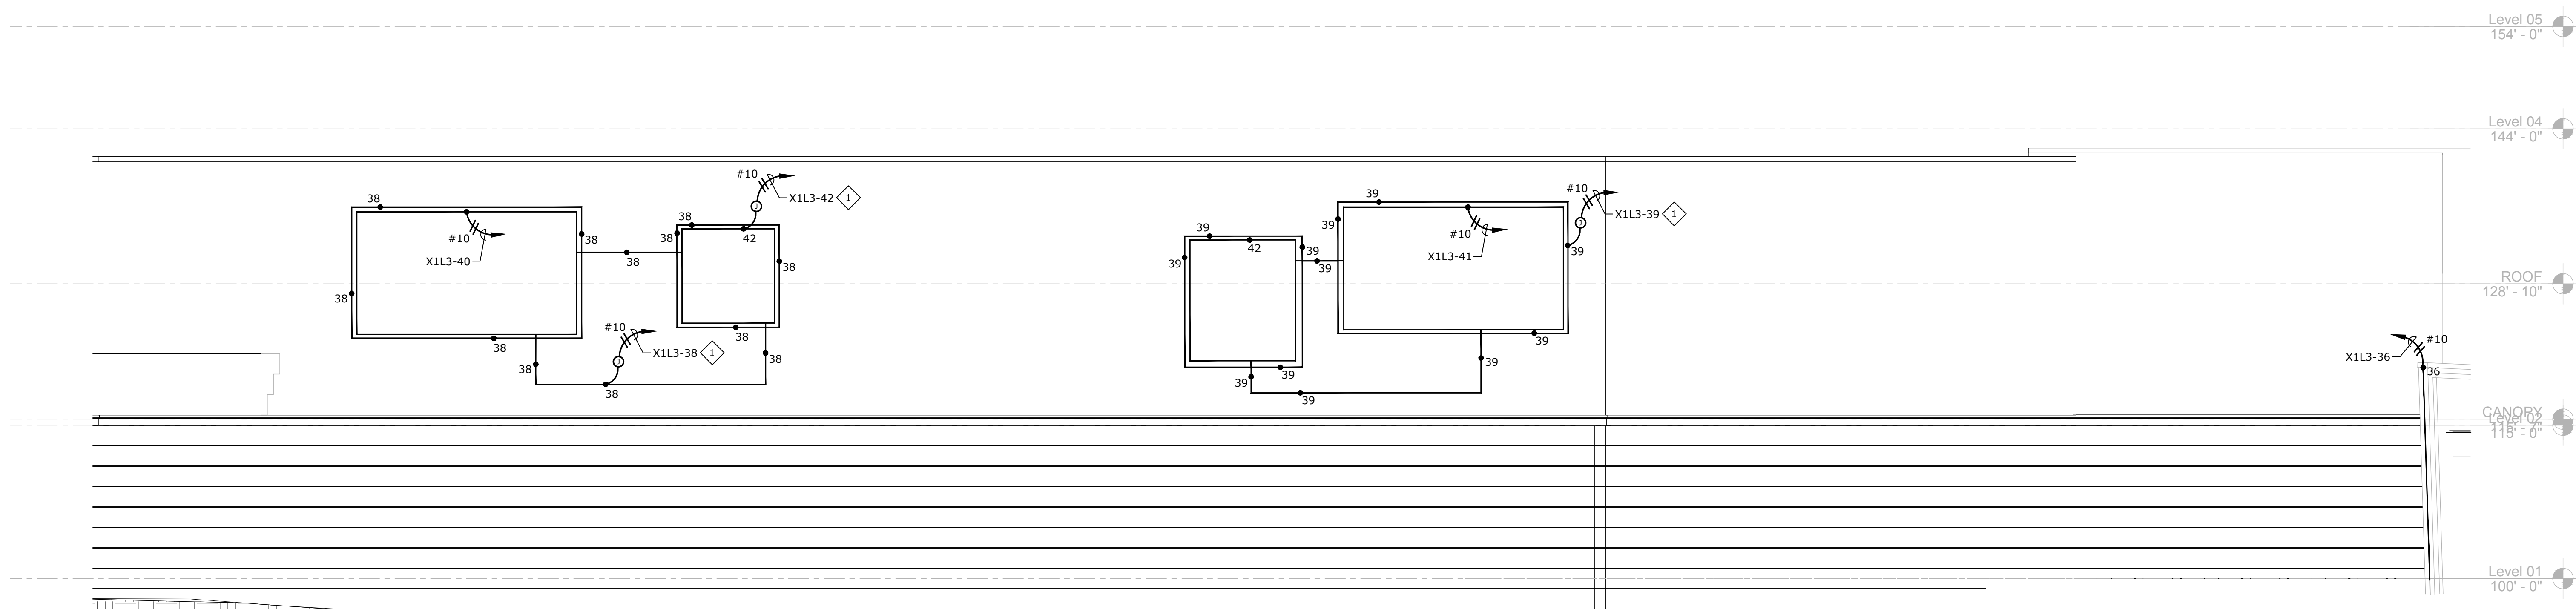

A CASINO EAST WALL LIGHTING ELEVATION
ELT-204 1/8" = 1'-0"

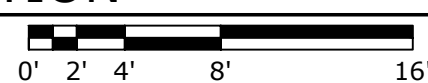

PLUMBING SPECIFICATIONS

PART ONE - GENERAL

1. THE CONTRACTOR SHALL PROVIDE THE WORK SHOWN ON THE DRAWINGS AND SPECIFIED FOR THEIR INDIVIDUAL SECTIONS OF WORK...

2. ALL GENERAL CONDITIONS, SPECIAL REQUIREMENTS OR GENERAL REQUIREMENTS OF THE CONSTRUCTION SPECIFICATIONS ARE MADE PART OF THIS SPECIFICATION AND HAVE THE SAME FORCE AND EFFECT AS IF COMPLETELY REPRODUCED...

3. THE WORD "PROVIDE" SHALL MEAN FURNISH AND INSTALL, MAKE ALL FINAL CONNECTIONS AND LEAVE IN AN APPROVED COMPLETE OPERATING CONDITION...

4. ALL WORK SHALL BE DONE IN ACCORDANCE WITH THE LATEST ADOPED EDITIONS OF THE APPLICABLE INTERNATIONAL BUILDING CODE (IBC), UNIFORM MECHANICAL CODE (UMC), UNIFORM PLUMBING CODE (UPC), NATIONAL ELECTRICAL CODES (NEC) AND ALL OTHER APPLICABLE FEDERAL, STATE, AND LOCAL REGULATIONS...

5. THE CONTRACTOR SHALL BE RESPONSIBLE FOR PAYING ALL FEES AND OBTAINING ALL PERMITS AND INSPECTIONS REQUIRED FOR THE WORK...

6. THE CONTRACTOR SHALL CAREFULLY EXAMINE ALL CONTRACT DOCUMENTS, THE CONTRACTOR SHALL COORDINATE THE WORK WITH ALL OTHER TRADES INCLUDING, BUT NOT LIMITED TO, THE CONTRACT DOCUMENTS, SHOP DRAWINGS, ETC. FOR ALL GENERAL CONSTRUCTION, STRUCTURAL, MECHANICAL, ELECTRICAL AND SPECIALTY CONTRACTOR WORK...

7. DRAWINGS ARE DIAGRAMMATIC AND SCHEMATIC IN NATURE, AND INDICATE THE TYPE, SIZE, ARRANGEMENT AND LOCATION OF MATERIALS AND EQUIPMENT...

8. ALL WORK REQUIRED FOR IDENTICAL ITEMS SHOWN ON THE DRAWINGS SHALL BE PROVIDED, ALTHOUGH EACH SPECIFIC IDENTICAL ITEM MAY NOT BE SHOWN IN DETAIL...

9. THE CONTRACTOR SHALL SUBMIT FIVE SETS OF SHOP DRAWINGS AND TECHNICAL DATA SHEETS FOR ALL EQUIPMENT AND MATERIALS SPECIFIED HEREIN TO THE ENGINEER...

10. ALL SUBSTITUTIONS SHALL BE SUBMITTED TO THE ENGINEER FOR CONSIDERATION PRIOR TO BIDDING. THE OWNER'S REPRESENTATIVE SHALL PREAPPROVE ANY PROPOSED SUBSTITUTION IN WRITING...

11. UPON COMPLETION OF CONSTRUCTION, THE CONTRACTOR SHALL SUPPLY THE ENGINEER WITH FIVE (5) COMPLETE SETS OF AS-BUILT DOCUMENTS ACCURATELY SHOWING THE MATERIALS AND EQUIPMENT AS INSTALLED...

12. ALL MATERIALS AND WORKMANSHIP SHALL BE GUARANTEED FOR A MINIMUM OF ONE (1) YEAR FROM DATE OF ACCEPTANCE BY OWNER...

13. CONTRACTOR SHALL CHECK AND VERIFY ALL SIZES, DIMENSIONS, AND CONDITIONS BEFORE STARTING ANY WORK...

14. PROVIDE BASE AND COUNTER FLASHING FOR ITEMS PENETRATING THE ROOF OR EXTERIOR WALLS...

15. STARTERS AND CONTROLS FOR MOTORS, ETC. TO BE FURNISHED BY MECHANICAL CONTRACTOR, ELECTRICAL CONTRACTOR TO INSTALL THE AFOREMENTIONED ITEMS...

16. ALL WORK SHOWN IS NEW UNLESS NOTED OTHERWISE.

17. MAINTAIN OCCUPANCY AND FIRE WALL SEPARATION INTEGRITY AS REQUIRED. REFER TO ARCHITECTURAL PLANS FOR LOCATIONS OF ALL OCCUPANCY/FIREWALL SEPARATIONS AND SPECIFIC DETAILS FOR CONSTRUCTION...

18. PIPE HANGERS: PIPE SIZES 1/2" TO 1 1/2" - 6" Ø MAX SPACING, 3/8" ROD DIAMETER; PIPE SIZES 2" TO 3" - 10" Ø MAX SPACING, 1/2" ROD DIAMETER...

19. WATER PROOFING AND FLASHING OF PIPE PENETRATIONS THROUGH EXTERIOR WALL AND ROOF SHALL BE BY THIS CONTRACTOR...

20. PROVIDE CLEAN OUTS IN ROOF DRAIN LINES AS SHOWN AND AS REQUIRED BY LOCAL CODE. ALL CLEANOUTS SHALL BE READILY ACCESSIBLE.

21. THE CONTRACTOR SHALL VISIT THE SITE PRIOR TO SUBMITTING A BID TO BECOME FAMILIAR WITH THE EXISTING CONDITIONS...

22. BASE PROPOSAL ON MANUFACTURER NAMES LISTED UNLESS "OR EQUAL" IS INDICATED. PROVIDE SUBSTITUTION REQUESTS A MINIMUM OF FIVE (5) BUSINESS DAYS PRIOR TO BID DATE...

PART TWO - PRODUCTS

PLUMBING EQUIPMENT

1. PROVIDE PLUMBING EQUIPMENT AS SPECIFIED AND/OR SCHEDULED HEREIN AND IN ACCORDANCE WITH MANUFACTURER'S PUBLISHED INSTALLATION INSTRUCTIONS...

PLUMBING PRODUCTS

1. PIPE INSULATION: ALL ROOF DRAIN PIPING ABOVE GROUND SHALL BE INSULATED WITH 1" THICK FIBERGLASS PIPE INSULATION WITH ALL-SERVICE JACKET AND MAXIMUM K VALUE OF 0.27 AT 75°F...

NOTES

1. DIELECTRIC FITTINGS SHALL BE USED WHEREVER DISSIMILAR METALS ARE JOINED. 2. ALL UNDERGROUND WATER PIPING SHALL BE WRAPPED WITH TAPE, ENCASED WITH A FOAM, COATED WITH A PROTECTIVE COATING, OR ROUTED THROUGH CONDUIT FOR PASSIVE CATHODIC PROTECTION...

PART THREE - EXECUTION

1. THE CONTRACTOR SHALL PROVIDE ALL SLEEVES, OPENINGS, CUTTING AND PATCHING NECESSARY FOR THE INSTALLATION OF THE WORK. 2. THE CONTRACTOR SHALL PROVIDE ALL RIGGING, HANDLING OF MATERIALS AND EQUIPMENT...

3. THE CONTRACTOR WILL, WITHOUT DELAY OR WITHOUT COST TO THE OWNER, PROVIDE WHATEVER ADDITIONAL EQUIPMENT, MATERIAL, AND LABOR REQUIRED TO CORRECT THE DEFICIENCY AND COMPLY WITH THE REQUIREMENTS OF THE DRAWINGS AND SPECIFICATIONS.

4. THE CONTRACTOR SHALL BE RESPONSIBLE FOR RETAINING AND PAYING FOR THE DESIGN SERVICES OF A STRUCTURAL ENGINEER TO CREATE THE DESIGN AND INSTALLATION DRAWINGS FOR MECHANICAL/PLUMBING SYSTEMS SEISMIC RESTRAINT SUPPORT...

5. WATER PROOFING AND FLASHING OF PIPE PENETRATIONS THROUGH EXTERIOR WALL AND ROOF SHALL BE BY THIS CONTRACTOR. PLUMBING CONTRACTOR SHALL COORDINATE LOCATIONS AND METHODS WITH GENERAL CONTRACTOR PRIOR TO CONSTRUCTION OF ROOF DECK.

6. PROVIDE CLEAN OUTS IN ROOF DRAIN LINES AS SHOWN AND AS REQUIRED BY LOCAL CODE. ALL CLEANOUTS SHALL BE READILY ACCESSIBLE.

PLUMBING SYMBOL LIST

NOTE: THIS IS A MASTER SCHEDULE. NOT ALL SYMBOLS CONTAINED HEREIN MAY APPEAR ON THE DRAWINGS.

Table mapping plumbing symbols to their respective components. Includes categories like ROOF DRAIN PIPING, ACID VENT PIPING, ABOVE GROUND ACID WASTE PIPING, etc.

PLUMBING ABBREVIATIONS

NOTE: THIS IS A MASTER SCHEDULE. NOT ALL ABBREVIATIONS CONTAINED HEREIN MAY APPEAR ON THE DRAWINGS.

Table of plumbing abbreviations such as AFF (ABOVE FINISHED FLOOR), AP (ACCESS PANEL), ASHRAE (AMERICAN SOCIETY OF HEATING, REFRIGERATION, AND AIR CONDITIONING ENGINEERS), etc.

PLUMBING FIXTURE SPECIFICATIONS



Table with columns for MARK and DESCRIPTION. Includes items like ROOF DRAIN - JAY R. SMITH #1010Y, OVERFLOW ROOF DRAIN - JAY R. SMITH #1070Y.

PLUMBING FIXTURE SCHEDULE

Table with columns for MARK, FIXTURE, C.W., TW, HW, V, S/W, TRAP, and REMARKS. Includes items like ROOF DRAIN, OVERFLOW R.D.

DRAWING INDEX

Index table listing drawing numbers (P-000, P-200) and their corresponding titles (SYMBOLS LIST AND SCHEDULES, PLUMBING ROOF PLAN).

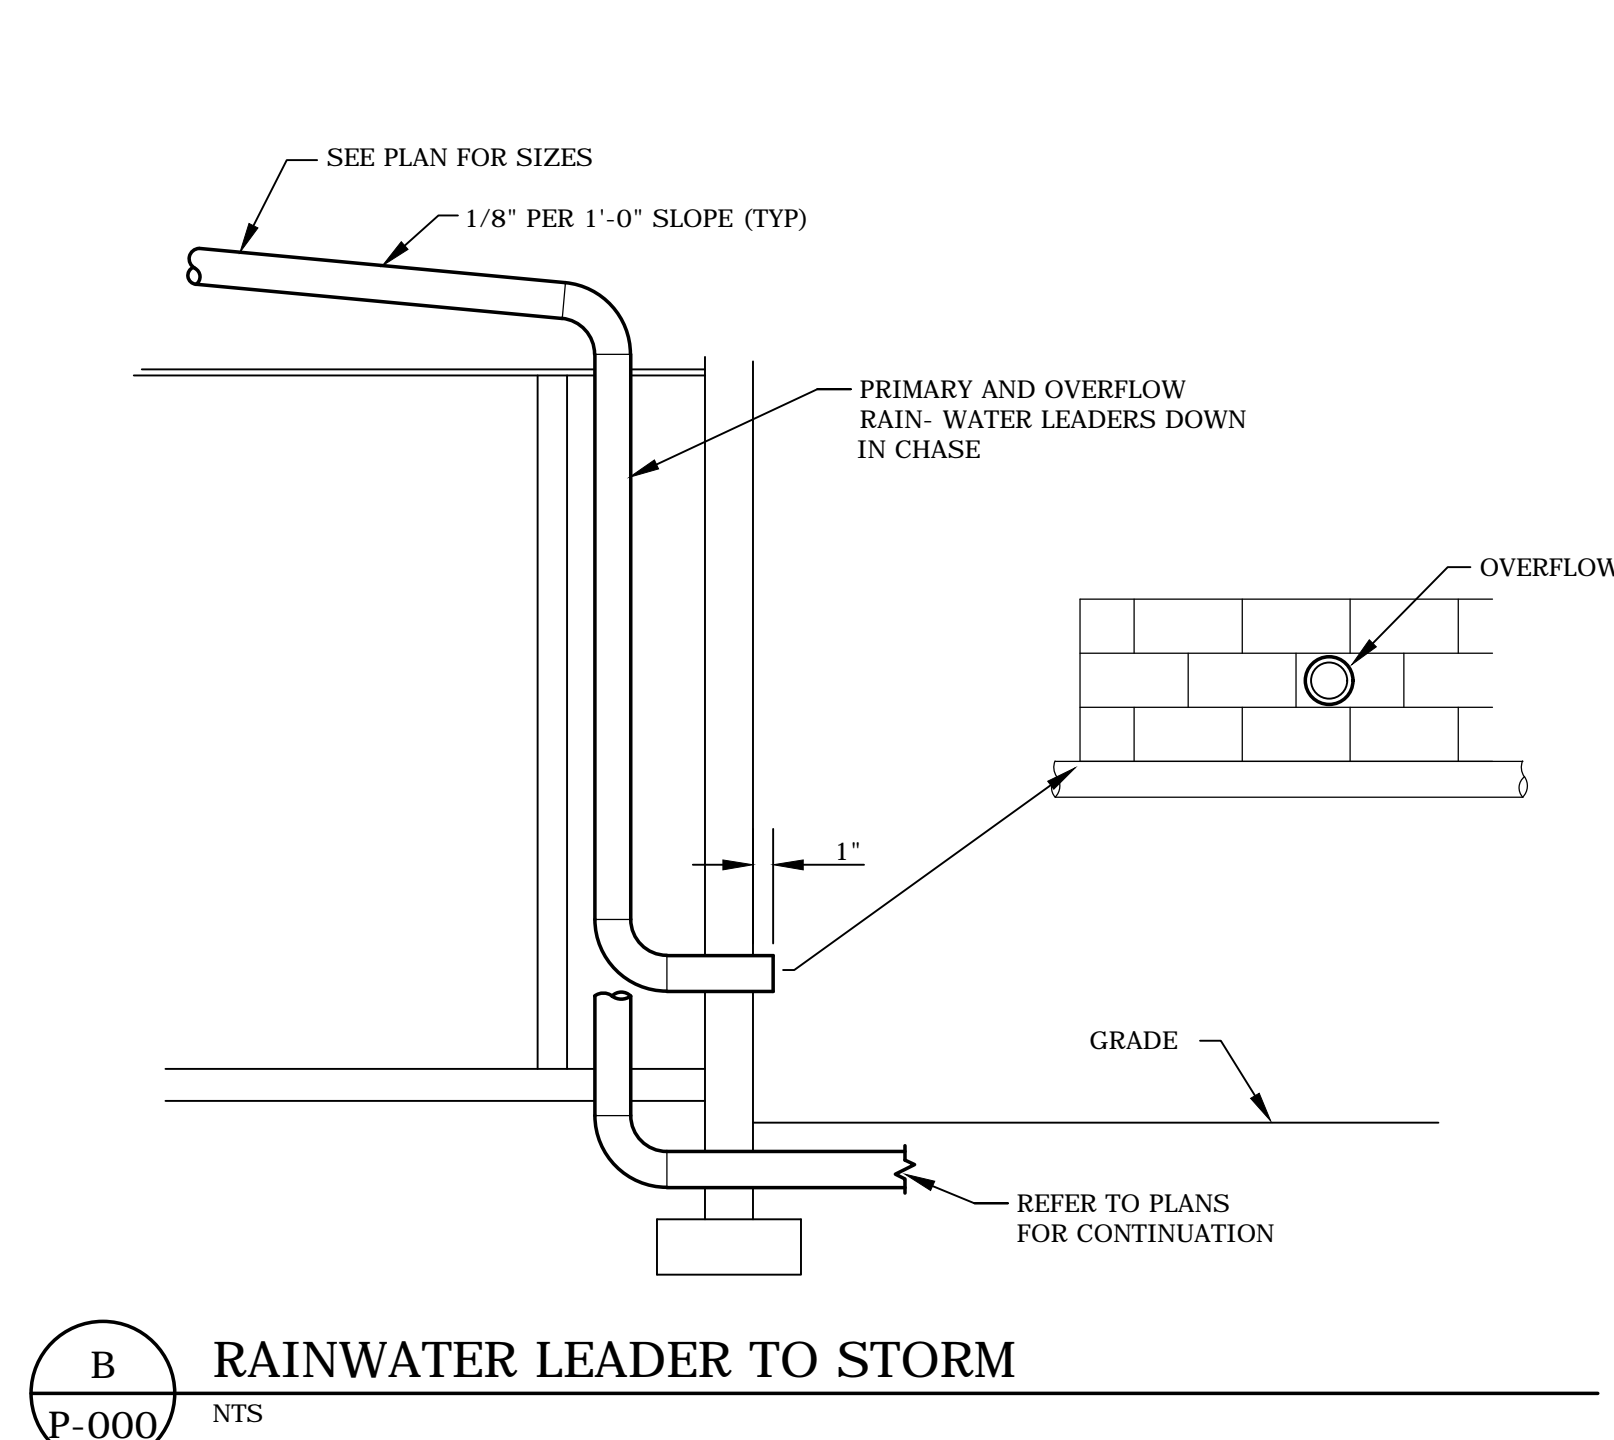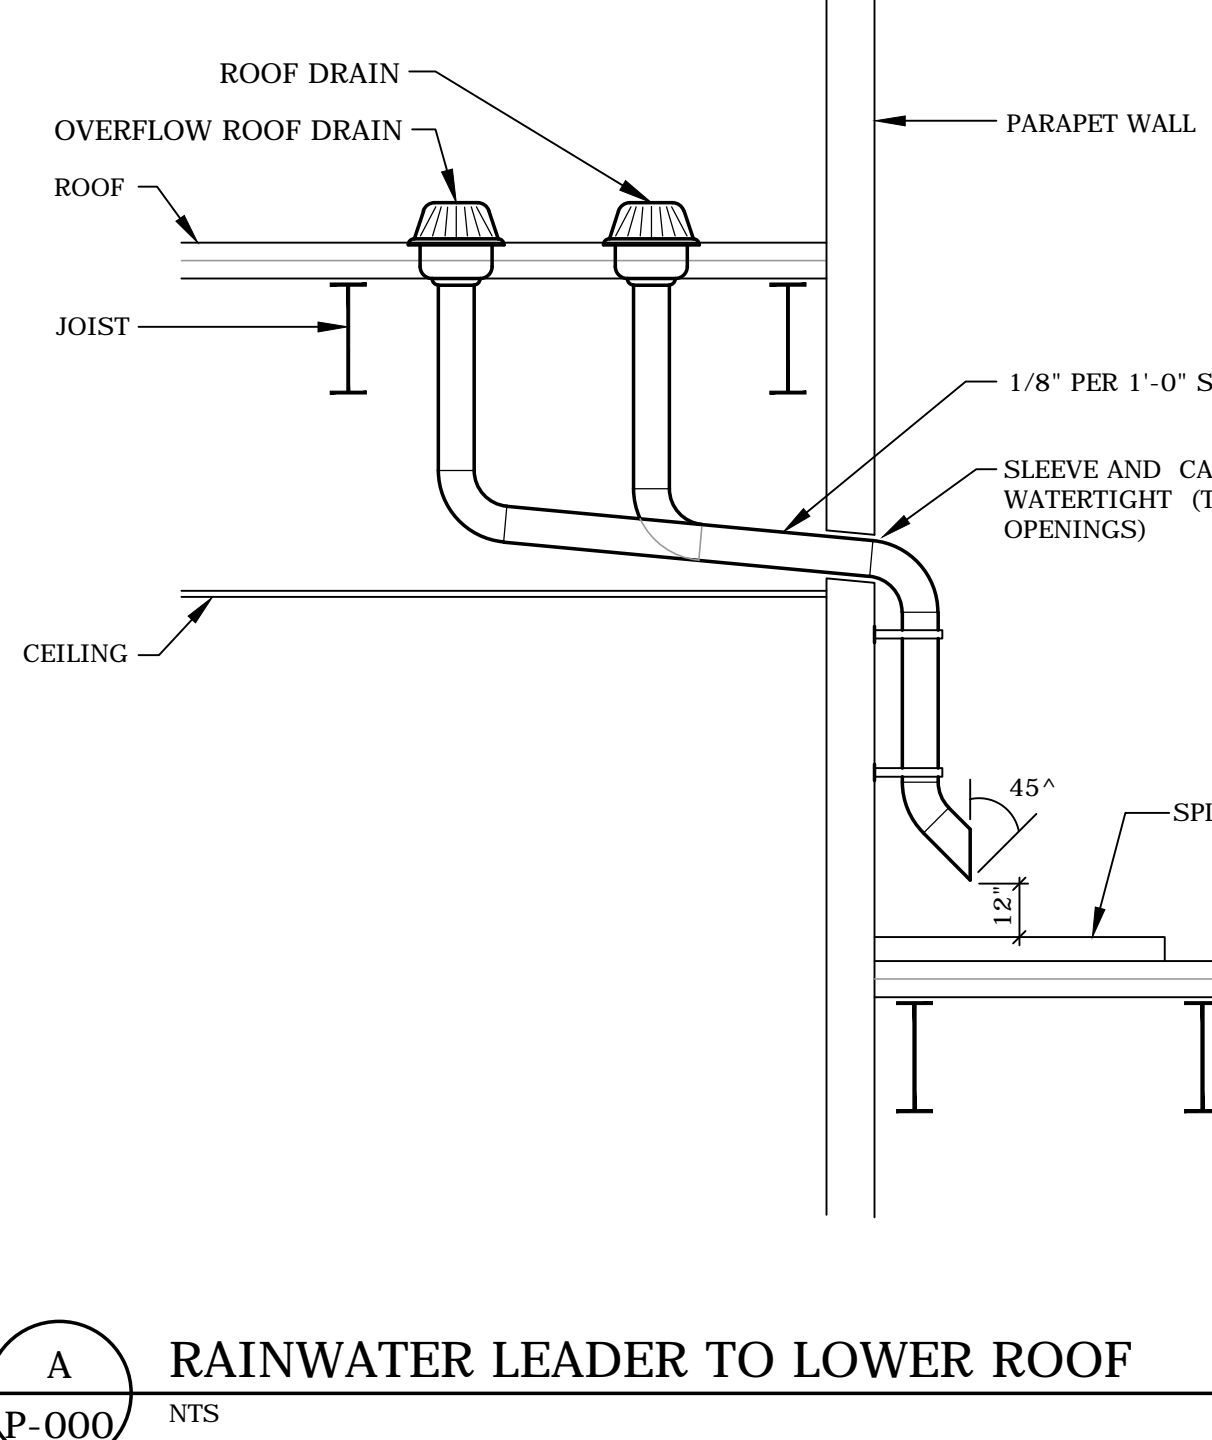

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- MEP ENGINEERING: MSA Engineering Consultants, 370 E. Windmill Ln, Suite 100, Tulsa, OK 74146. CIVIL ENGINEERING / SURVEYING: Native Plains Surveying and Mapping / R&K & Associates P.L.C., 5807 S. Garnett Rd, Suite K, Tulsa, OK 74146.

- LOW VOLTAGE / THEME LIGHTING: ME Engineers, 80 Lakeshore Boulevard, Suite 300, Buffalo, NY 14202.

Cherokee Hard Rock Hotel & Casino

EXTERIOR FACADE RENOVATION

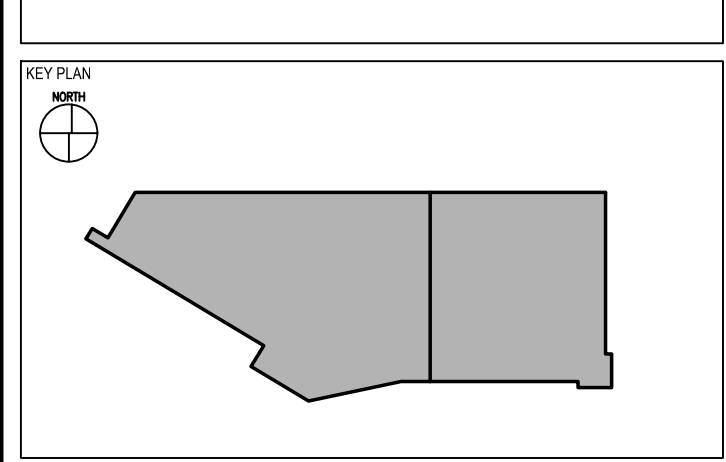


Table with columns for No., Description, and Date. Intended for recording change orders or construction notes.

Project information section including SHEET TITLE (SYMBOLS LIST AND SCHEDULES), CONSTRUCTION SET details (PROJECT NO. L17325-01, DATE: 12/21/2018), and a Professional Engineer seal for Benjamin D. Williams, Oklahoma License #1568.

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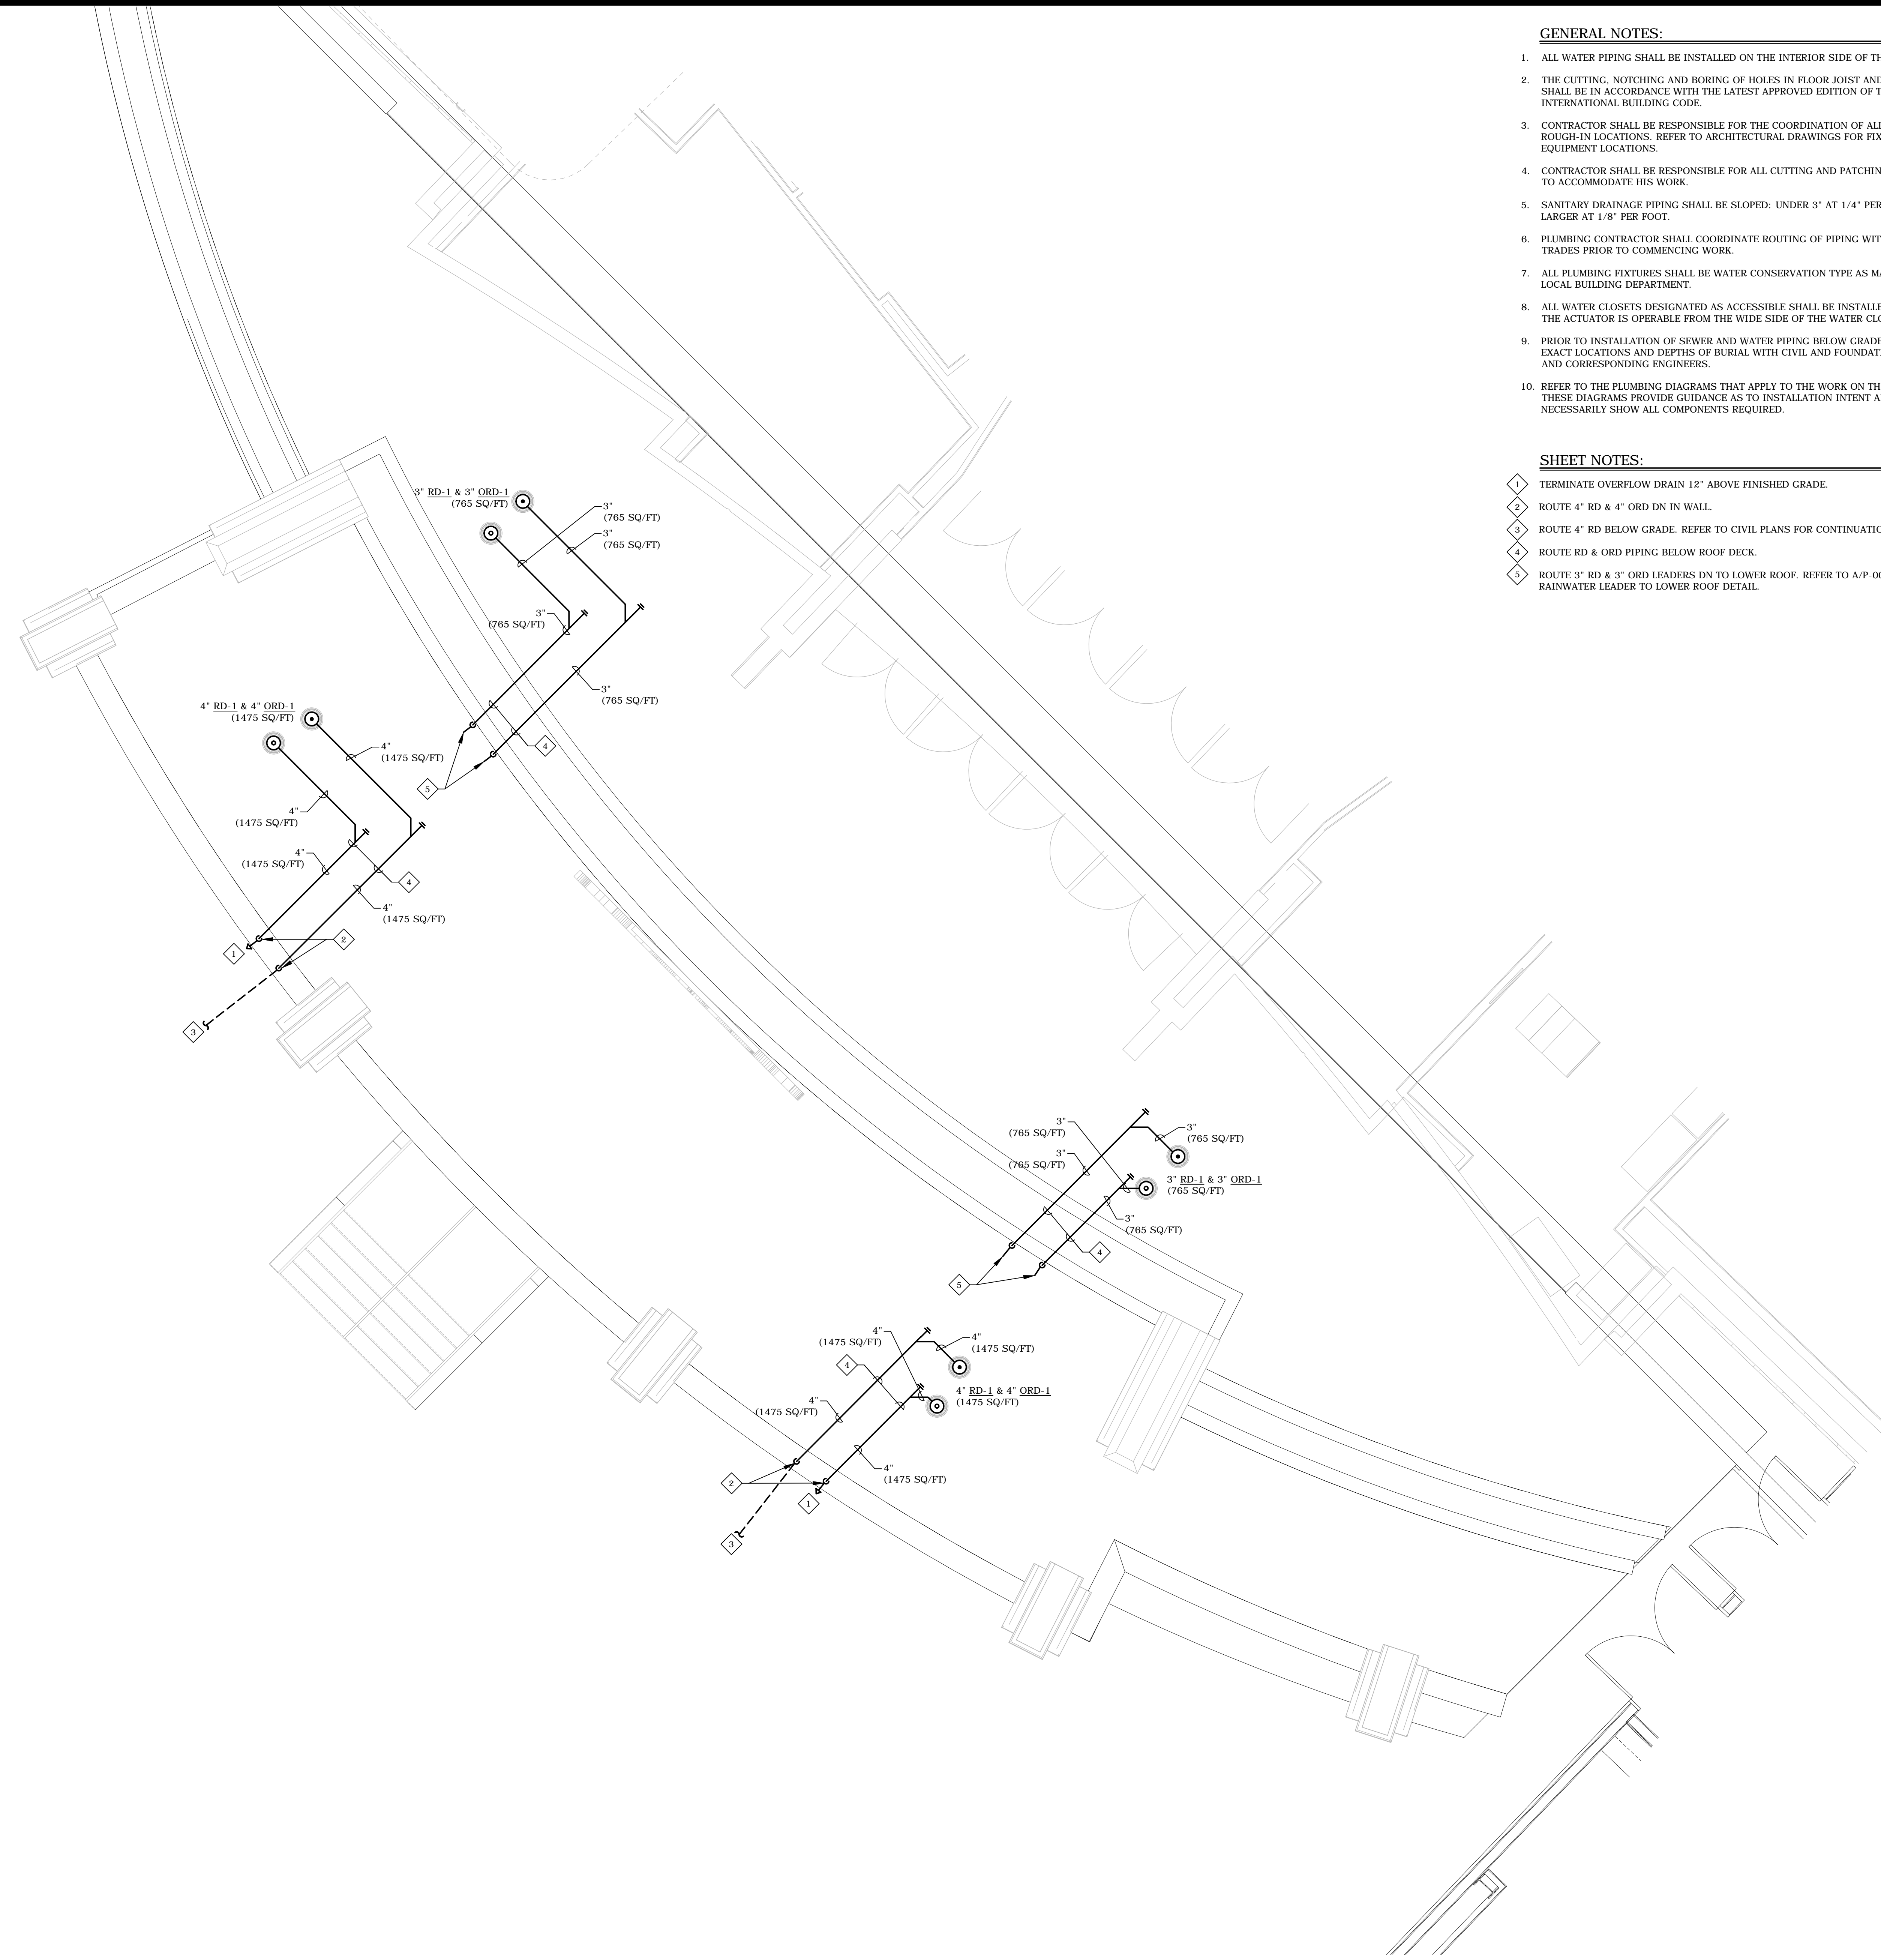
Cherokee Hard Rock Hotel & Casino

GENERAL NOTES:


1. ALL WATER PIPING SHALL BE INSTALLED ON THE INTERIOR SIDE OF THE BUILDING.
2. THE CUTTING, NOTCHING AND BORING OF HOLES IN FLOOR JOIST AND WALL STUDS SHALL BE IN ACCORDANCE WITH THE LATEST APPROVED EDITION OF THE INTERNATIONAL BUILDING CODE.
3. CONTRACTOR SHALL BE RESPONSIBLE FOR THE COORDINATION OF ALL PLUMBING ROUGH-IN LOCATIONS. REFER TO ARCHITECTURAL DRAWINGS FOR FIXTURES AND EQUIPMENT LOCATIONS.
4. CONTRACTOR SHALL BE RESPONSIBLE FOR ALL CUTTING AND PATCHING AS REQUIRED TO ACCOMMODATE HIS WORK.
5. SANITARY DRAINAGE PIPING SHALL BE SLOPED: UNDER 3" AT 1/4" PER FOOT, 3" AND LARGER AT 1/8" PER FOOT.
6. PLUMBING CONTRACTOR SHALL COORDINATE ROUTING OF PIPING WITH ALL OTHER TRADES PRIOR TO COMMENCING WORK.
7. ALL PLUMBING FIXTURES SHALL BE WATER CONSERVATION TYPE AS MANDATED BY LOCAL BUILDING DEPARTMENT.
8. ALL WATER CLOSETS DESIGNATED AS ACCESSIBLE SHALL BE INSTALLED SUCH THAT THE ACTUATOR IS OPERABLE FROM THE WIDE SIDE OF THE WATER CLOSET.
9. PRIOR TO INSTALLATION OF SEWER AND WATER PIPING BELOW GRADE COORDINATE EXACT LOCATIONS AND DEPTHS OF BURIAL WITH CIVIL AND FOUNDATION DRAWINGS AND CORRESPONDING ENGINEERS.
10. REFER TO THE PLUMBING DIAGRAMS THAT APPLY TO THE WORK ON THIS DRAWING. THESE DIAGRAMS PROVIDE GUIDANCE AS TO INSTALLATION INTENT AND DO NOT NECESSARILY SHOW ALL COMPONENTS REQUIRED.

SHEET NOTES:


1. TERMINATE OVERFLOW DRAIN 12" ABOVE FINISHED GRADE.
2. ROUTE 4" RD & 4" ORD DN IN WALL.
3. ROUTE 4" RD BELOW GRADE. REFER TO CIVIL PLANS FOR CONTINUATION.
4. ROUTE RD & ORD PIPING BELOW ROOF DECK.
5. ROUTE 3" RD & 3" ORD LEADERS DN TO LOWER ROOF. REFER TO A/P-000 FOR RAINWATER LEADER TO LOWER ROOF DETAIL.



A PLUMBING ROOF PLAN
1/4" = 1'-0"

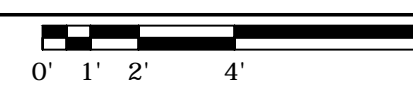

EXTERIOR FACADE RENOVATION

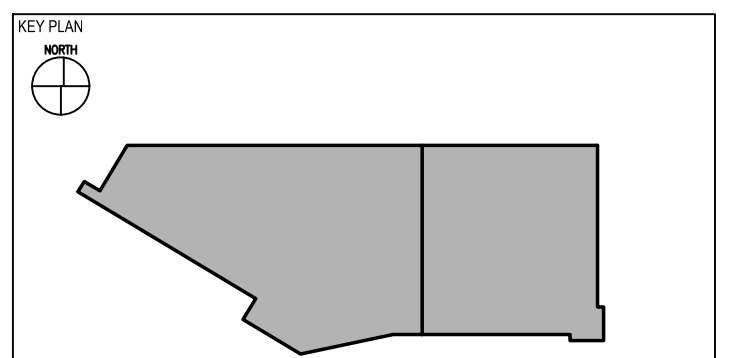


No.	Description	Date

PLUMBING ROOF PLAN

CONSTRUCTION SET

PROJECT NO: L17325.01
DRAWN BY: MBE
CHECKED BY: B. J. JAMES
ISSUE DATE: 12/21/2018

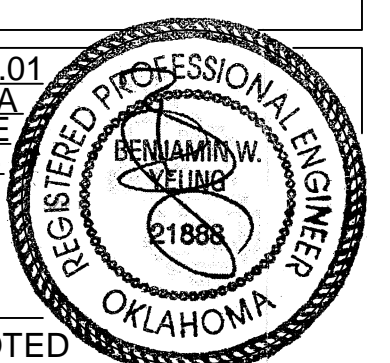

P-200
Scale AS NOTED

LIGHTING CONTROL DETAIL NOTES

- 1 FIXTURES SHOWN FOR DIAGRAMMATIC PURPOSES ONLY. REFER TO PLANS FOR QUANTITY OF FIXTURES.
2 DMX DATA ENABLER DEVICE SHOWN FOR DIAGRAMMATIC PURPOSES ONLY. REFER TO MANUFACTURER INFORMATION FOR SPECIFIC REQUIREMENTS, CABLING, MOUNTING, PROGRAMMING ETC.
3 PROVIDE AMX/DMX DATA CONVERTER FOR INTEGRATION INTO EXISTING CASINO MADRIX LIGHTING CONTROL SYSTEM. PATHWAY: ULTIMATE DMX CONVERTER 8680 OR APPROVED EQUAL.
4 REFER TO ENGINEERING DRAWINGS FOR CIRCUITING.



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GENERAL NOTES:



- A. EXTERIOR FACADE LIGHTING SYSTEM IS AND EXTENSION OF THE CASIO 4 LIGHTING DESIGN. THE SYSTEMS SHALL ALL CONNECT BACK TO OWNERS EXISTING MADRIX USER INTERFACE.
B. CONTRACTOR SHALL MOUNT LOW VOLTAGE POWER SUPPLIES IN COORDINATION WITH ARCHITECTURAL ACCESS PANELS.
C. THE COLOR CHANGE PROGRAMMING OF THE SYSTEM SHALL BE COMPLETED BY A THIRD PARTY SYSTEM INTEGRATOR.
D. BELOW IS A GENERIC PROGRAMMING SPECIFICATION AND SHALL BE USED AS A GUIDE FOR BIDDING THE SYSTEM.

LIGHTING CONTROL SYSTEM

- A. SUPERVISION OF INSTALLATION AND FINAL TESTING
1. THE LIGHTING CONTROL SYSTEM MANUFACTURER SHALL INCLUDE IN HIS PRICING TO THE ELECTRICAL CONTRACTOR 40 HOURS TO PERFORM TESTING AND START-UP OF ALL SYSTEM COMPONENTS.
B. EFFECTS PROGRAMMING:
1. PROVIDE DYNAMIC TIME-BASED RGBW CONTROL PROGRAMMING FOR ALL NEW FIXTURES.
2. GENERAL DESCRIPTION OF PROGRAMMING:
a. ALL VERTICAL RUNS OF TYPE LP03 TO BE PROGRAMMED AS SINGLE-ZONE DYNAMIC COLOR CHANGE RUNS.
b. ALL HORIZONTAL RUNS OF TYPE LP11 TO BE PROGRAMMED AS SINGLE-ZONE DYNAMIC COLOR CHANGE RUNS.

DOCUMENTATION

A. AS-BUILTS
CONTRACTOR TO PROVIDE PRINT AND DIGITAL COPY OF AS-BUILT CONDITION AFTER COMPLETION OF PROJECT. AS-BUILTS SHALL BE COMPLETED IN CAD FORMAT.

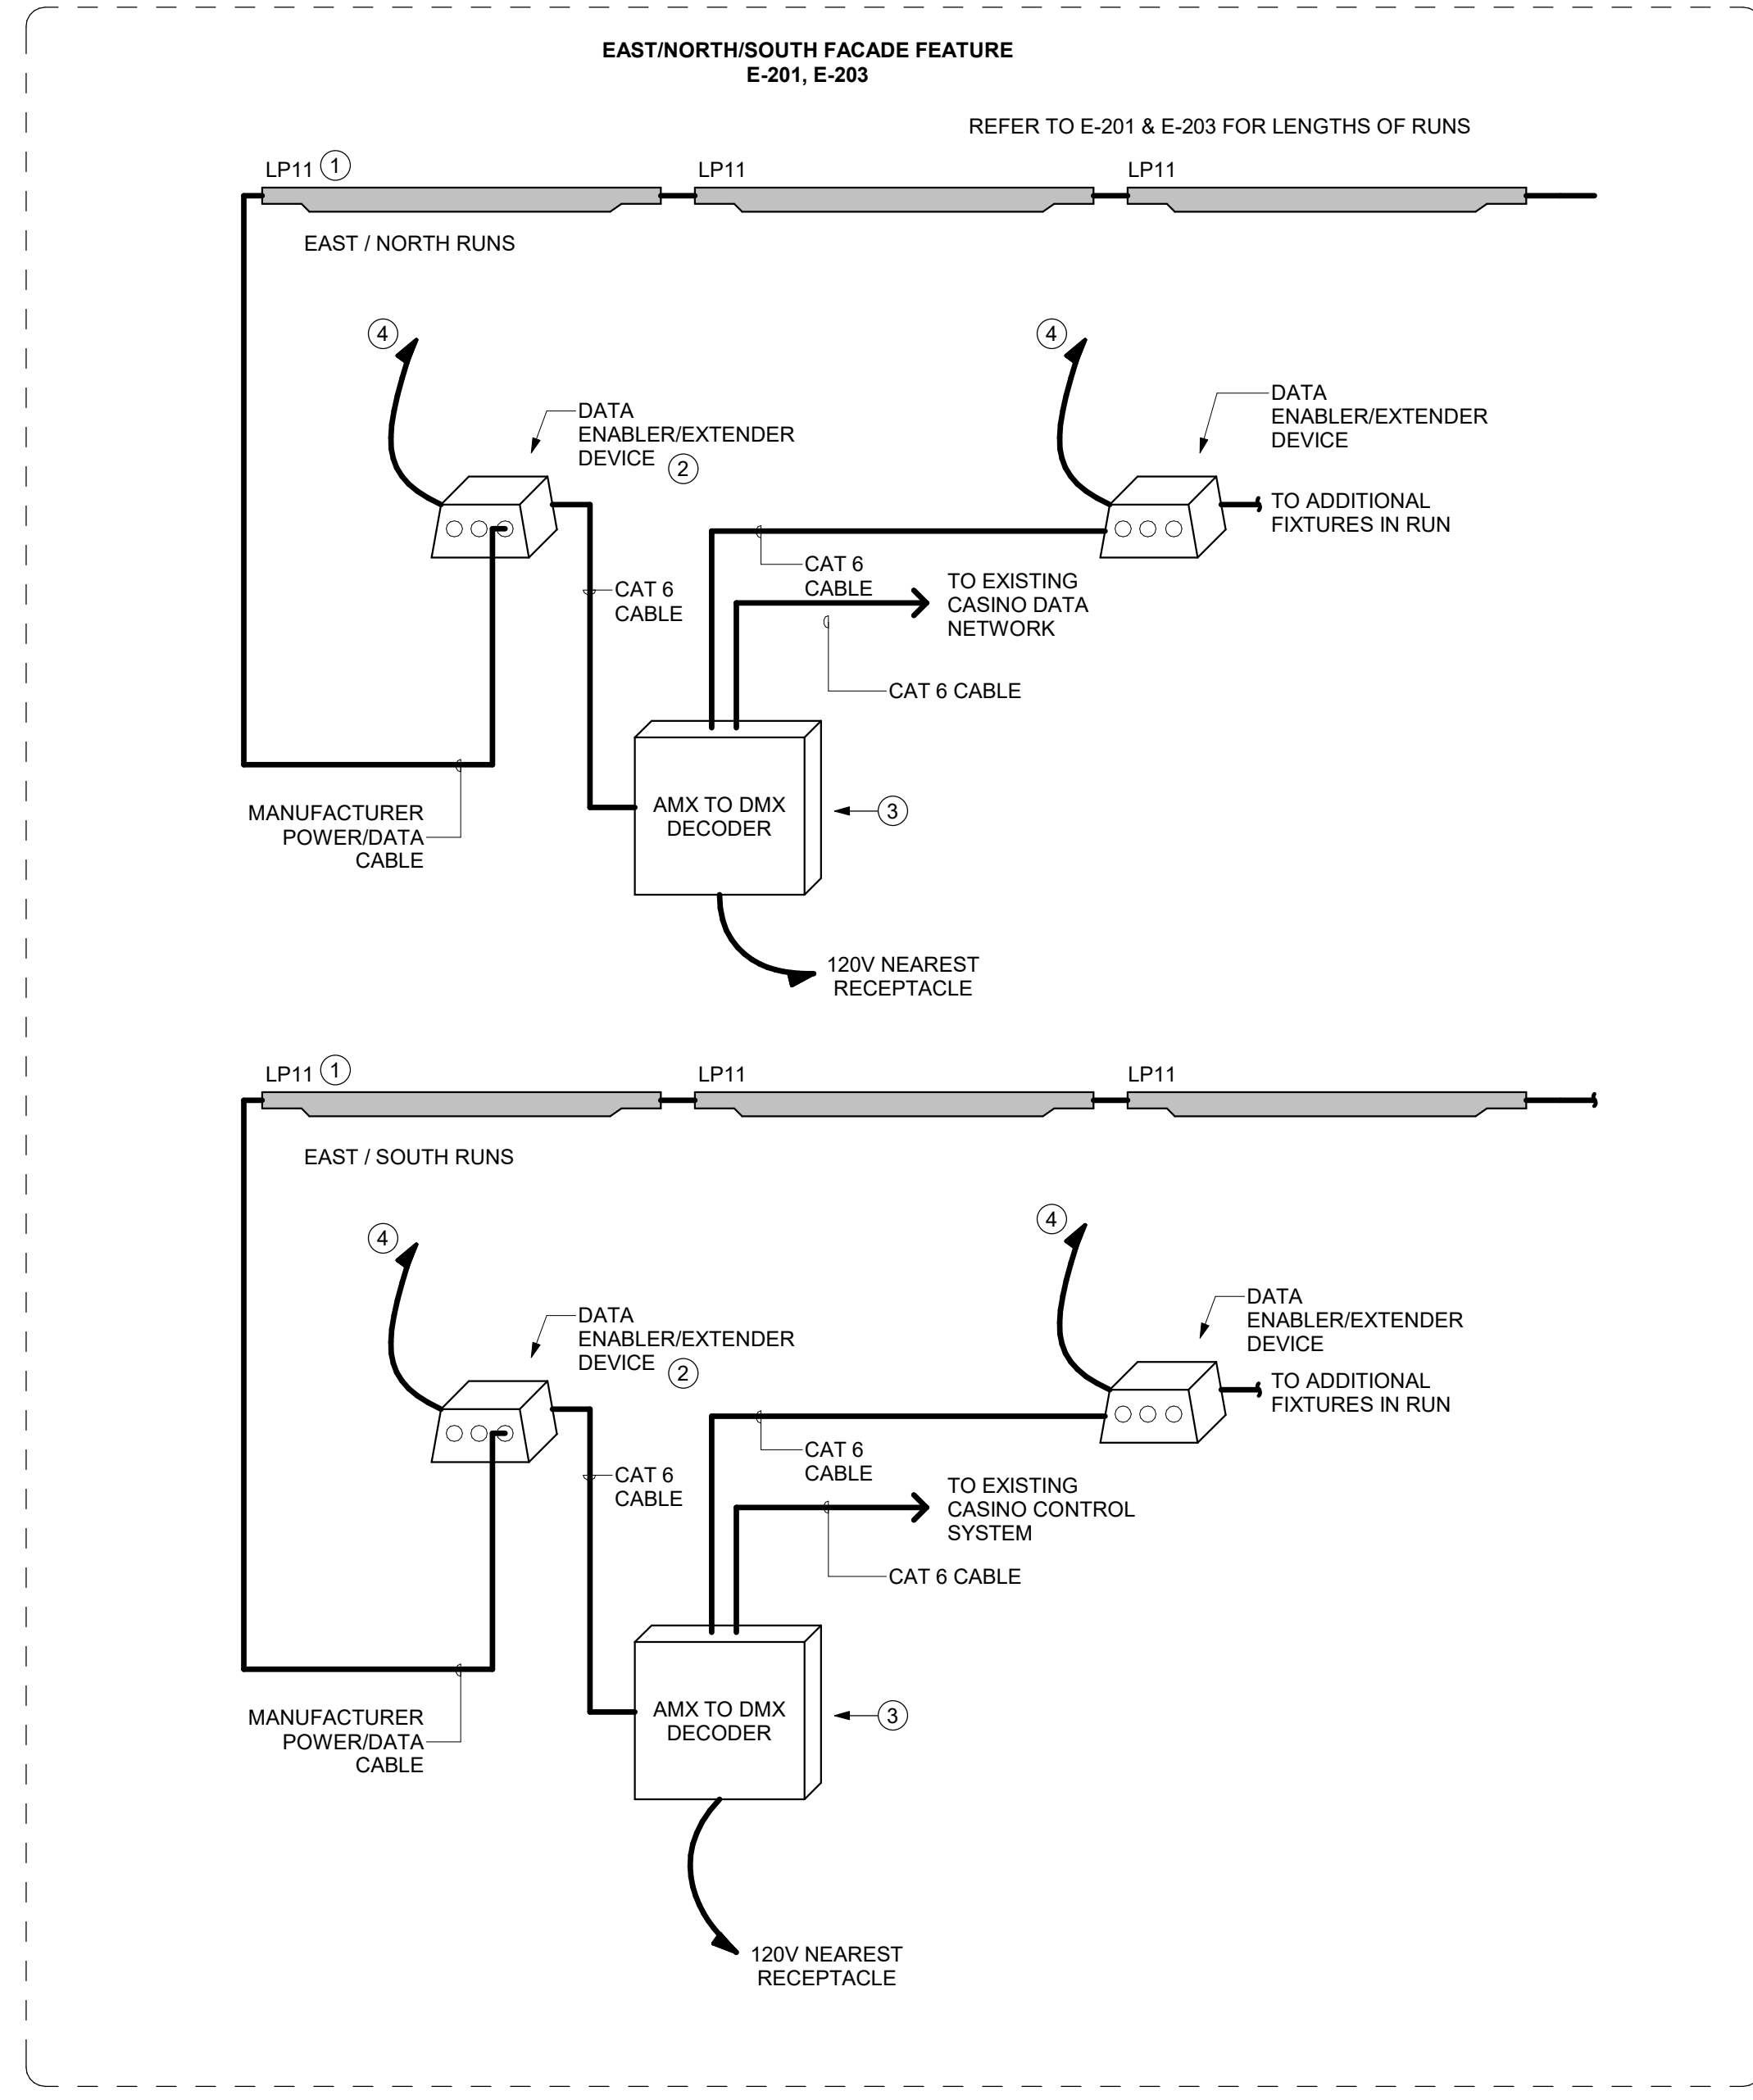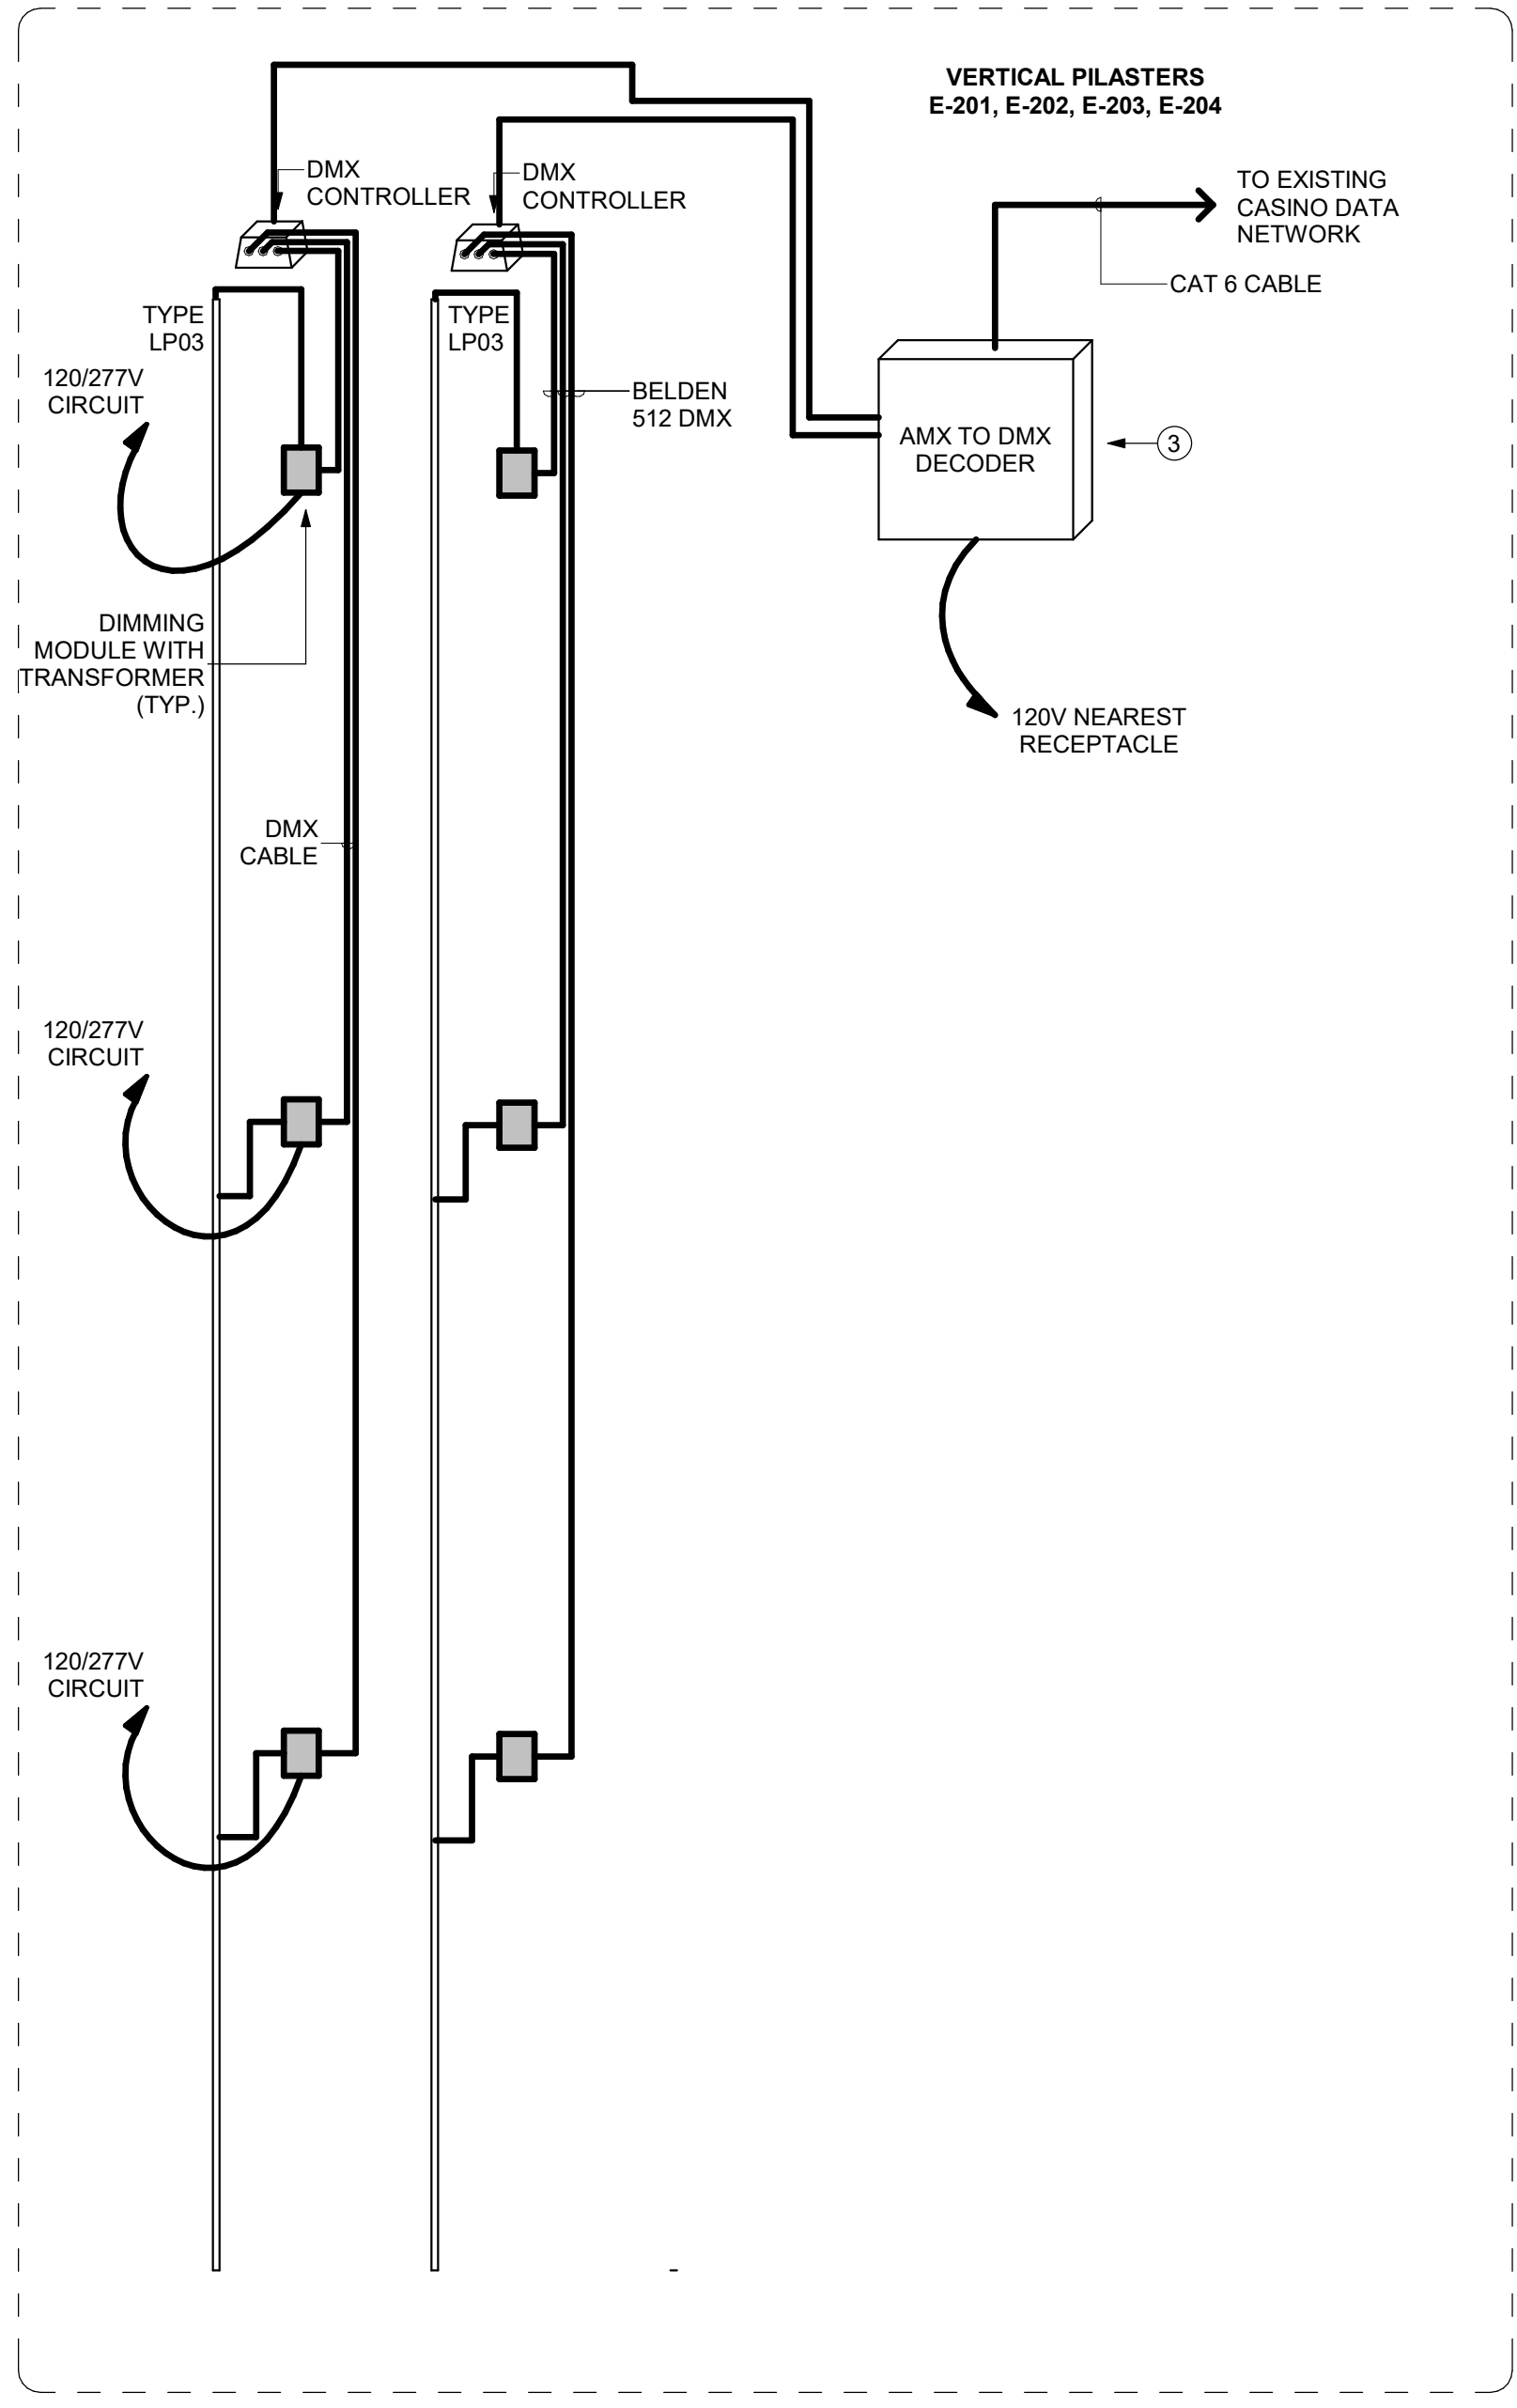

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Cherokee Hard Rock Hotel & Casino

EXTERIOR RENOVATION

KEY PLAN



Table with columns: No., Description, Date. Multiple empty rows for tracking.

DETAILS & SPECIFICATIONS

CONSTRUCTION SET

PROJECT NO: H17018
DRAWN BY: DSL
CHKD BY: RJR
ISSUE DATE: 12/21/2018

LT-001
Scale As indicated

12/21/2018 2:35:30 PM

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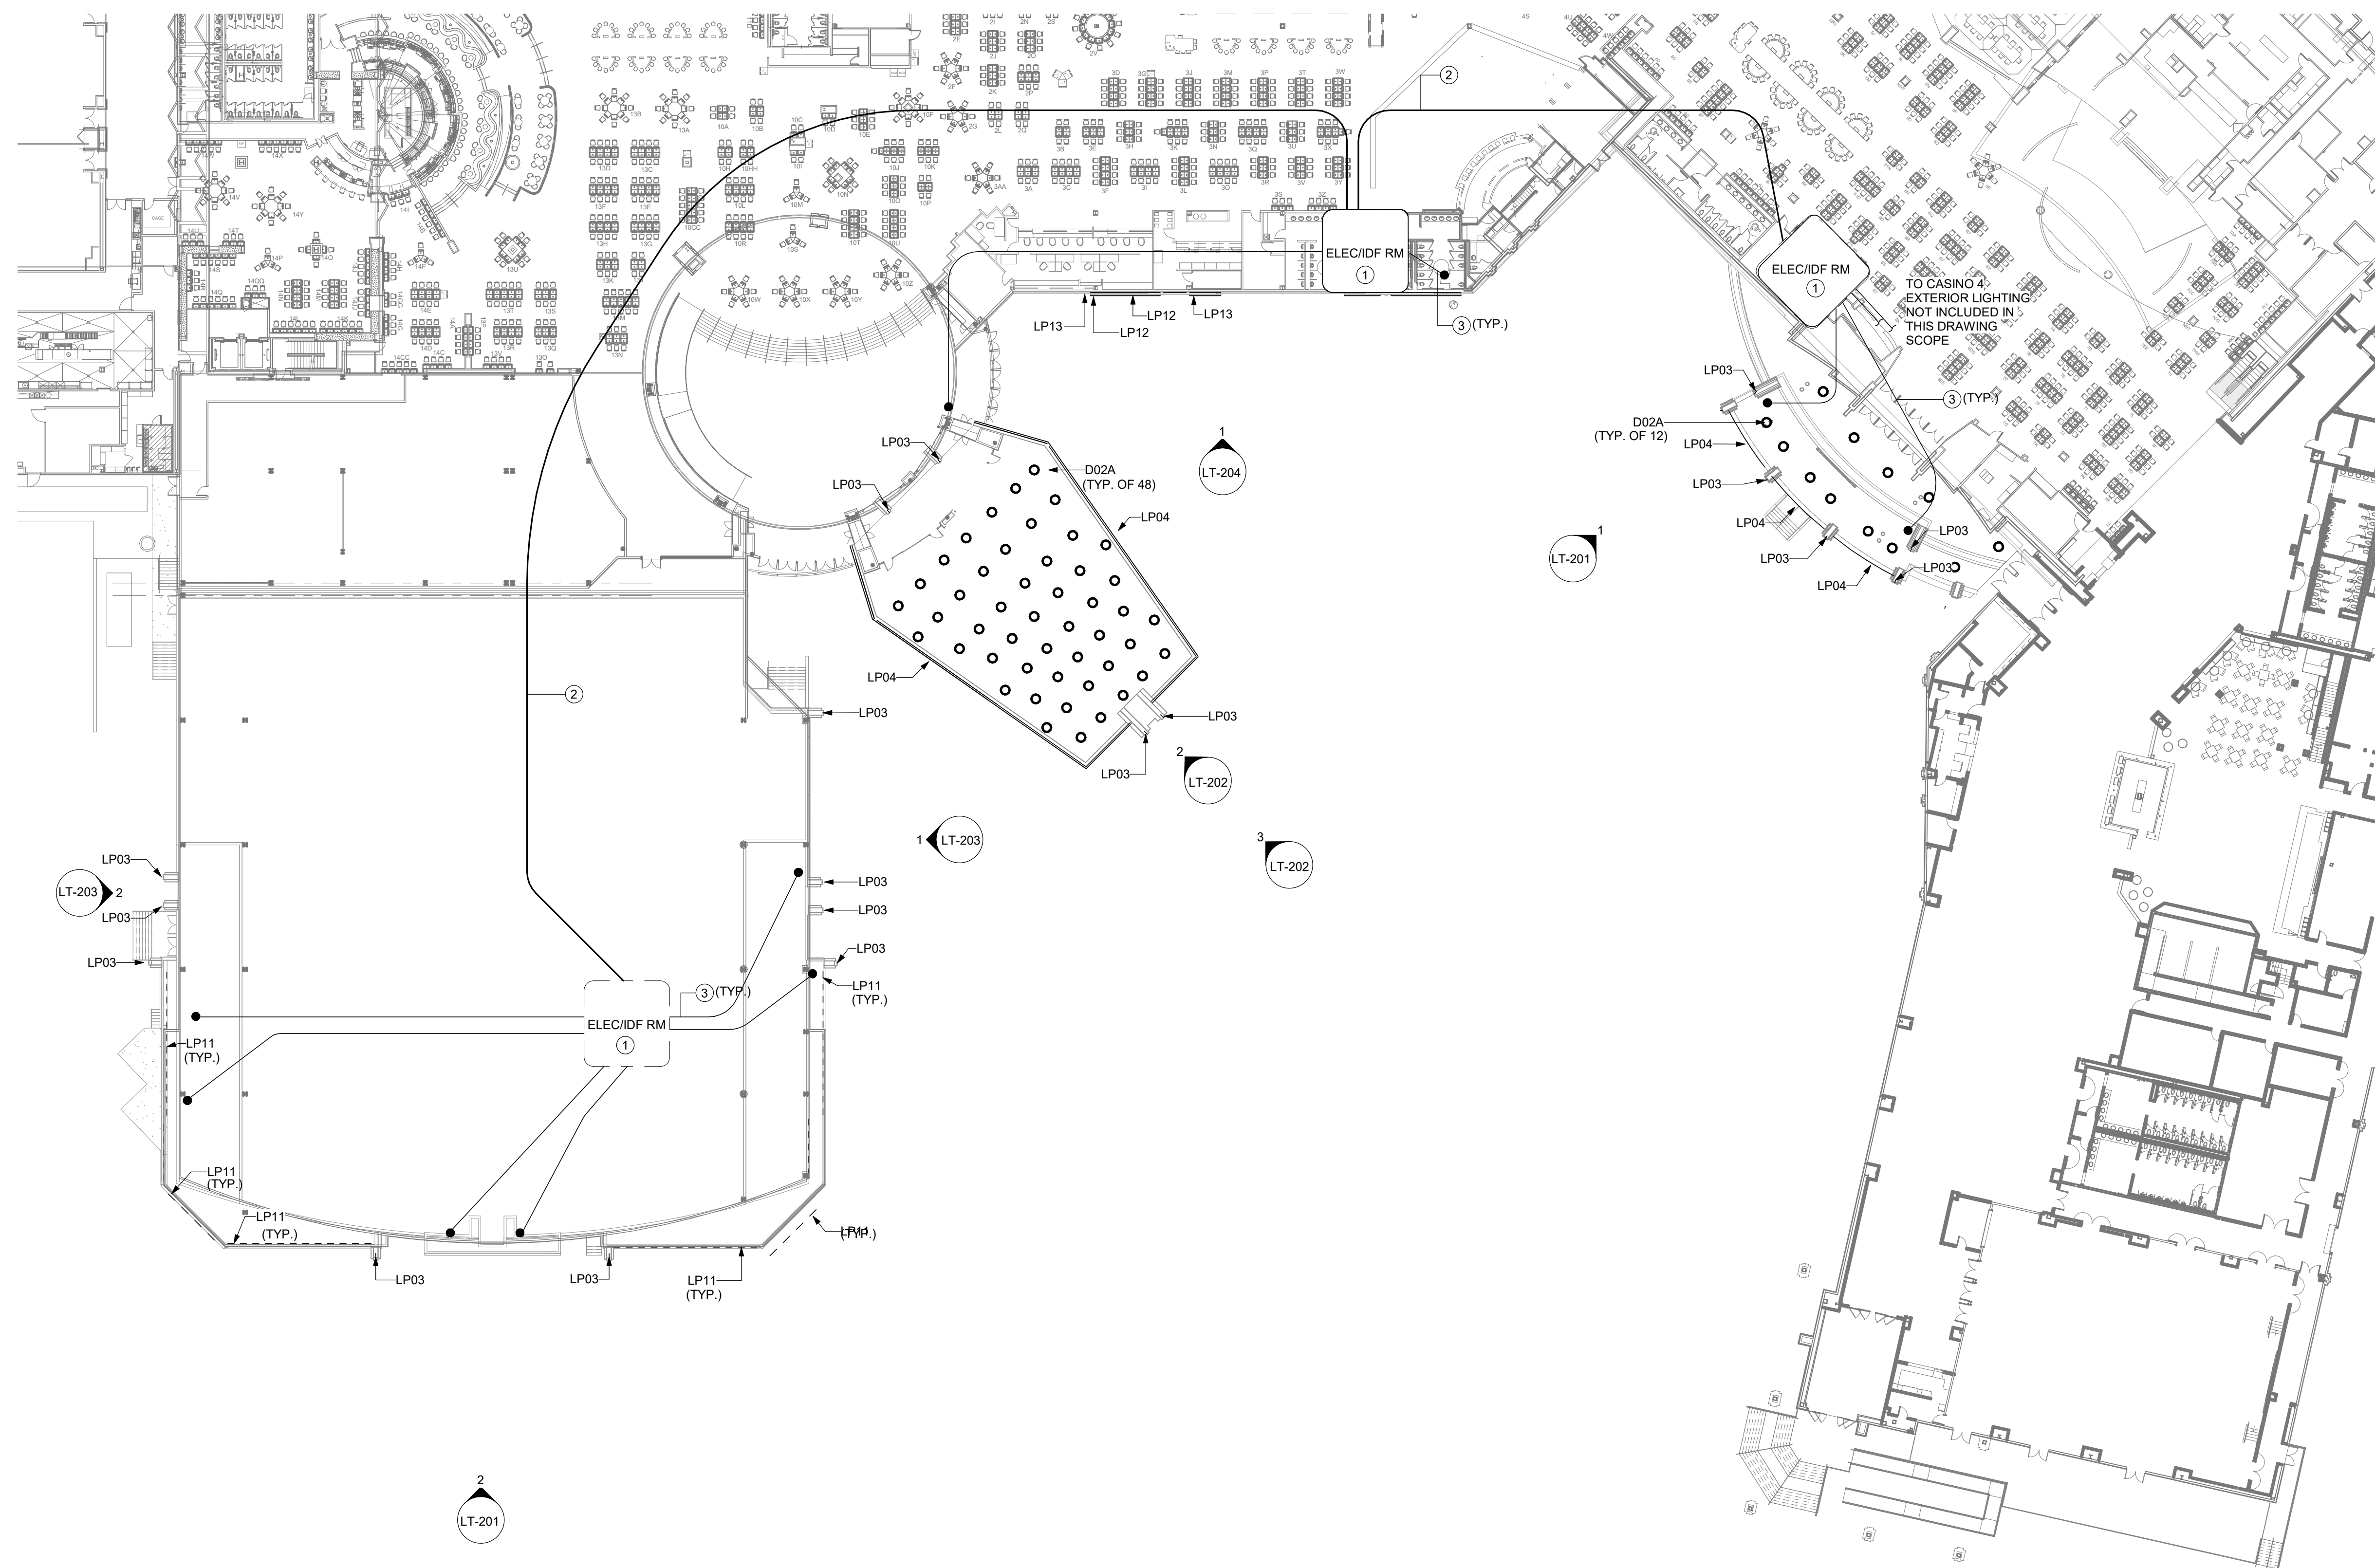
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 716-845-5092

Cherokee Hard Rock Hotel & Casino



1 OVERALL EXTERIOR PLAN
 1" = 30'-0"

1" = 30'-0"

OVERALL EXTERIOR PLAN DRAWING NOTES

- ELEC/IDF ROOM SHOWN FOR DIAGRAMMATIC PURPOSES ONLY. VERIFY EXACT LOCATION IN FIELD PRIOR TO BID.
- PROVIDE RJ45 NETWORK CABLE TO INTERCONNECT ELEC/IDF ROOM CONTROL DEVICES. ROUTING SHOWN FOR DIAGRAMMATIC PURPOSES ONLY. VERIFY LOCATIONS AND LENGTHS IN FIELD. APPROXIMATE LENGTH OF 1000 FT FOR BIDDING PURPOSES.
- PROVIDE AMX CONTROL CABLE TO AMX/DMX CONVERTER LOCATIONS. ROUTING SHOWN FOR DIAGRAMMATIC PURPOSES ONLY. VERIFY LOCATIONS AND LENGTHS IN FIELD. APPROXIMATE LENGTH OF 500 FT FOR BIDDING PURPOSES.

LUMINAIRE SCHEDULE

TYPE	DESCRIPTION	MFGR. & CATALOG No.	LAMP	DRIVER VOLTAGE	UNIT WATTS	COLOR TEMP [K]	MOUNTING	DIMMING	LOCATION	REMARKS
D02A	8" APERTURE HI LUMEN OPEN LED EXTERIOR DOWNLIGHT. GALVANIZED STEEL FRAME WITH JOINT BOX AND HINGED ACCESS COVER. ADJUSTABLE MOUNTING BRACKETS. WET LOCATION RATED.	PATHWAY: BL8TV-80-4K-1-XW60-D8+8PL ED-HAZPF OR APPROVED EQUAL.	80 CRI 7000 LUMEN LED	120/277V	52W	4000K	RECESSED	0-10V	PORTE COCHERE	
LP03	EXTERIOR RATED LINEAR TAPE STYLE RGB LED FIXTURE. EXTRUSION WITH CLEAR LENS. IP68 RATED.	ACCLAIM: FLEX II EXTERIOR RGB FLEXZERGB OR APPROVED EQUAL.	85 LUMEN / FT RGB LED ARRAY	12VDC	4.4W/FT	RGB	SURFACE	DMX	EXTERIOR FACADE	
LP04	EXTERIOR RATED LINEAR DIRECT VIEW LED NEON FIXTURE. EXTRUSION WITH CLEAR LENS. IP68 RATED.	TIVOLI: FLEXLUM FXLM-32-S-D-24-8 OR APPROVED EQUAL.	30 LUMEN/FT LED ARRAY	24VDC	4W/FT	3200K	SURFACE	0-10V	EXTERIOR FACADE	
LP11	LINEAR EXTERIOR RGBW LED WALL GRAZING FIXTURE. 15X30 BEAM ANGLE.	LUMENPULSE: LOGHO-120-48-RGBW-WW-JMA S-XXX-DMX-RDM OR APPROVED EQUAL.	890 LUMEN/FT RGBW LED ARRAY	120/277V	19W/FT	RGBW	SURFACE	DMX	EXTERIOR FACADE	
LP12	LINEAR TAPE IN EXTRUSION. WET LOCATION LISTED.	ACCLAIM: FLEX II SO, KLUS SILER EXTRUSION OR APPROVED EQUAL.	70 LUMEN / FT RGB LED ARRAY	120/277V	2.4W/FT	4000K	SURFACE	0-10V	EXTERIOR FACADE	
LP13	LED DAMP LOCATION FLEXIBLE TILE SYSTEM	COOL EDGE EXTERIOR R2 OR APPROVED EQUAL.	600 LUMEN/SQ FT LED ARRAY	120/277V / 58VDC	5.6W/SQ FT	4000K	SURFACE	0-10V	EXTERIOR FACADE	

EXTERIOR RENOVATION

KEY PLAN



No.	Description	Date

EXTERIOR PLAN

CONSTRUCTION SET

PROJECT NO: H17018
 DRAWN BY: DSL
 CHECKED BY: RJR
 ISSUE DATE: 12/21/2018

LT-200
 Scale 1" = 30'-0"




LT-201 DEMOLITION NOTES


- DISCONNECT AND REMOVE EXISTING FACADE WASH LIGHTS IN THIS LOCATION.

LT-201 DRAWING NOTES

- COORDINATE DATA CONNECTION / AV INTEGRATION REQUIREMENTS FOR VIDEO WALL(S) WITH OWNER.
- MOUNT POWER SUPPLY FOR LINEAR TAPE RUNS AT TOP OF COLUMNS. TYPICAL ALL COLUMN LOCATIONS.

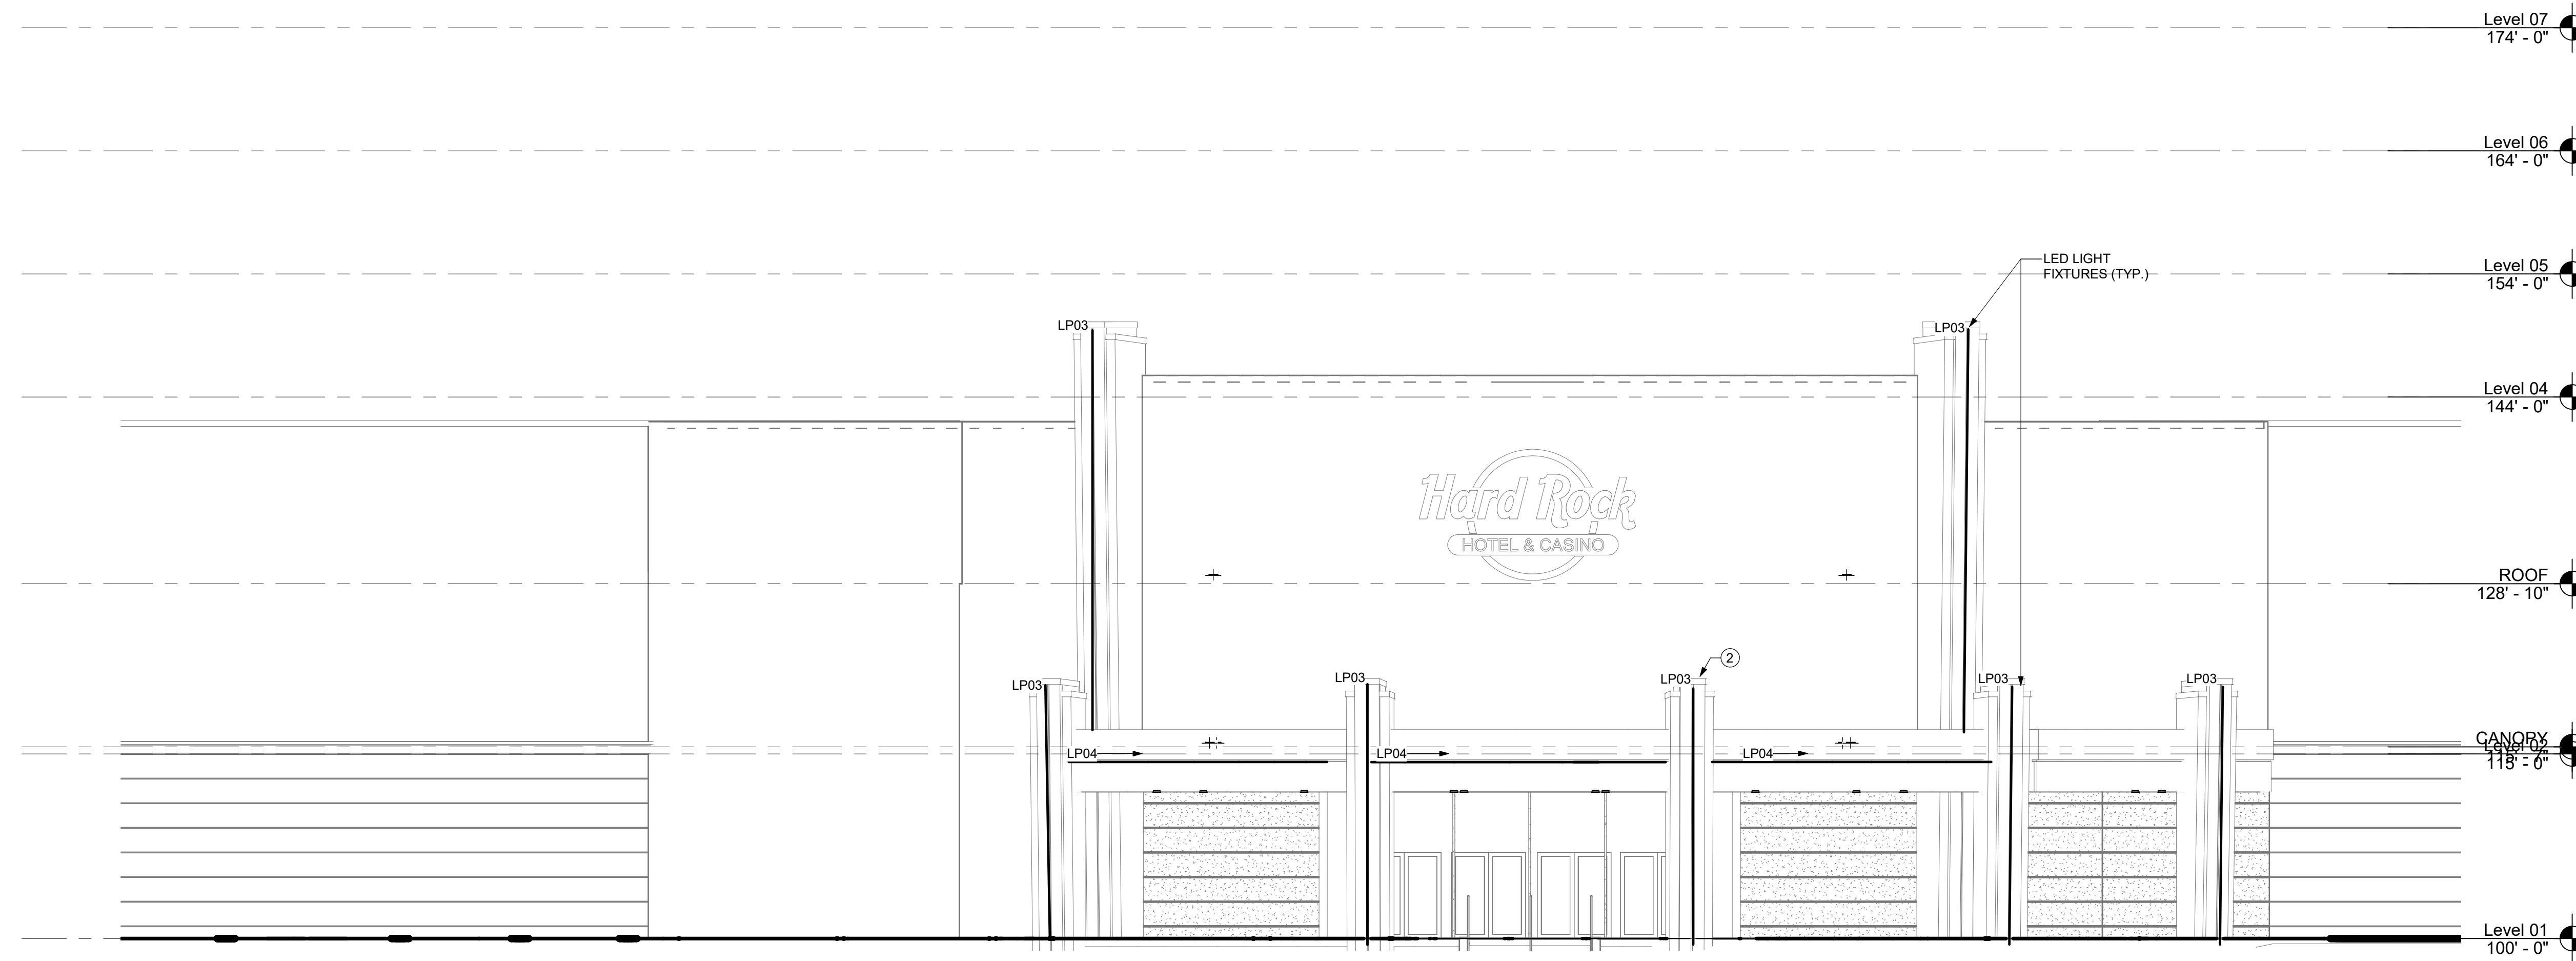

1 EAST ELEVATION
1/8" = 1'-0"

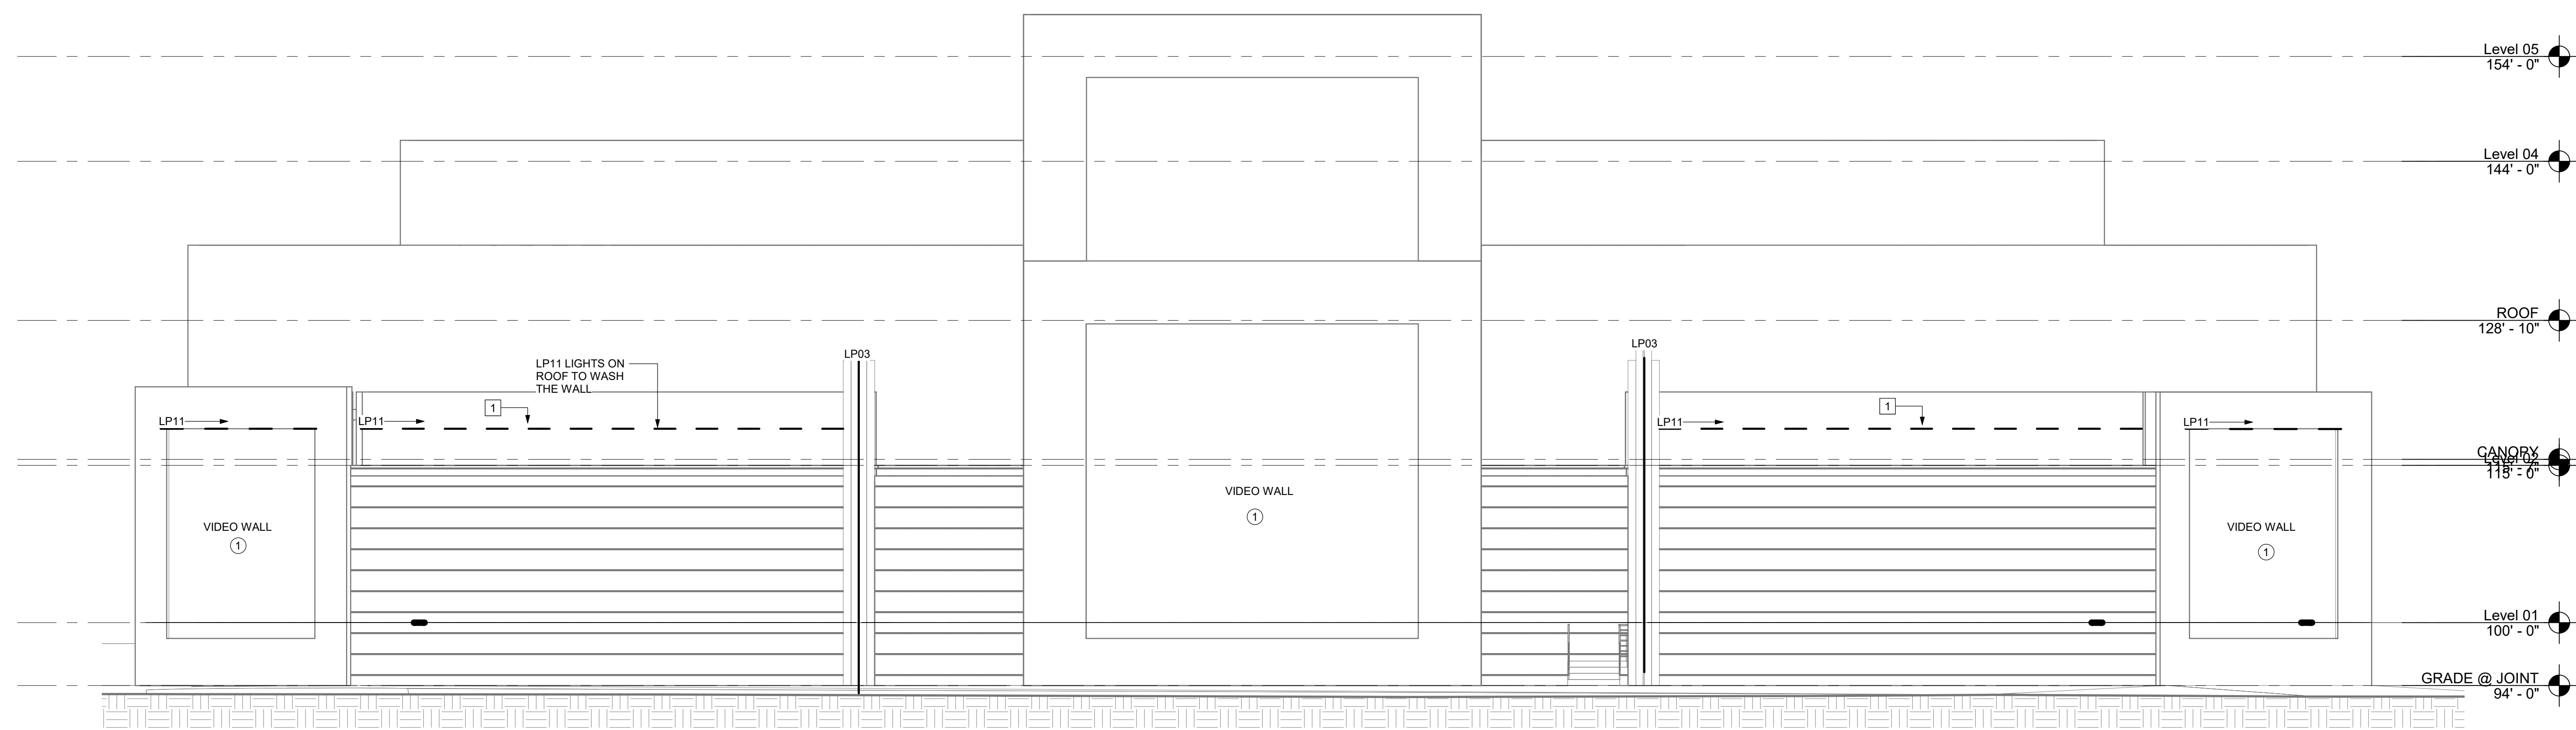

2 EAST FACADE ELEVATION
1/8" = 1'-0"

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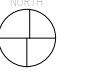
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EXTERIOR RENOVATION

KEY PLAN



No.	Description	Date

EXTERIOR ELEVATIONS - EAST - LIGHTING

CONSTRUCTION SET

PROJECT NO. H17018
DRAWN BY: DSL
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ISSUE DATE: 12/21/2018

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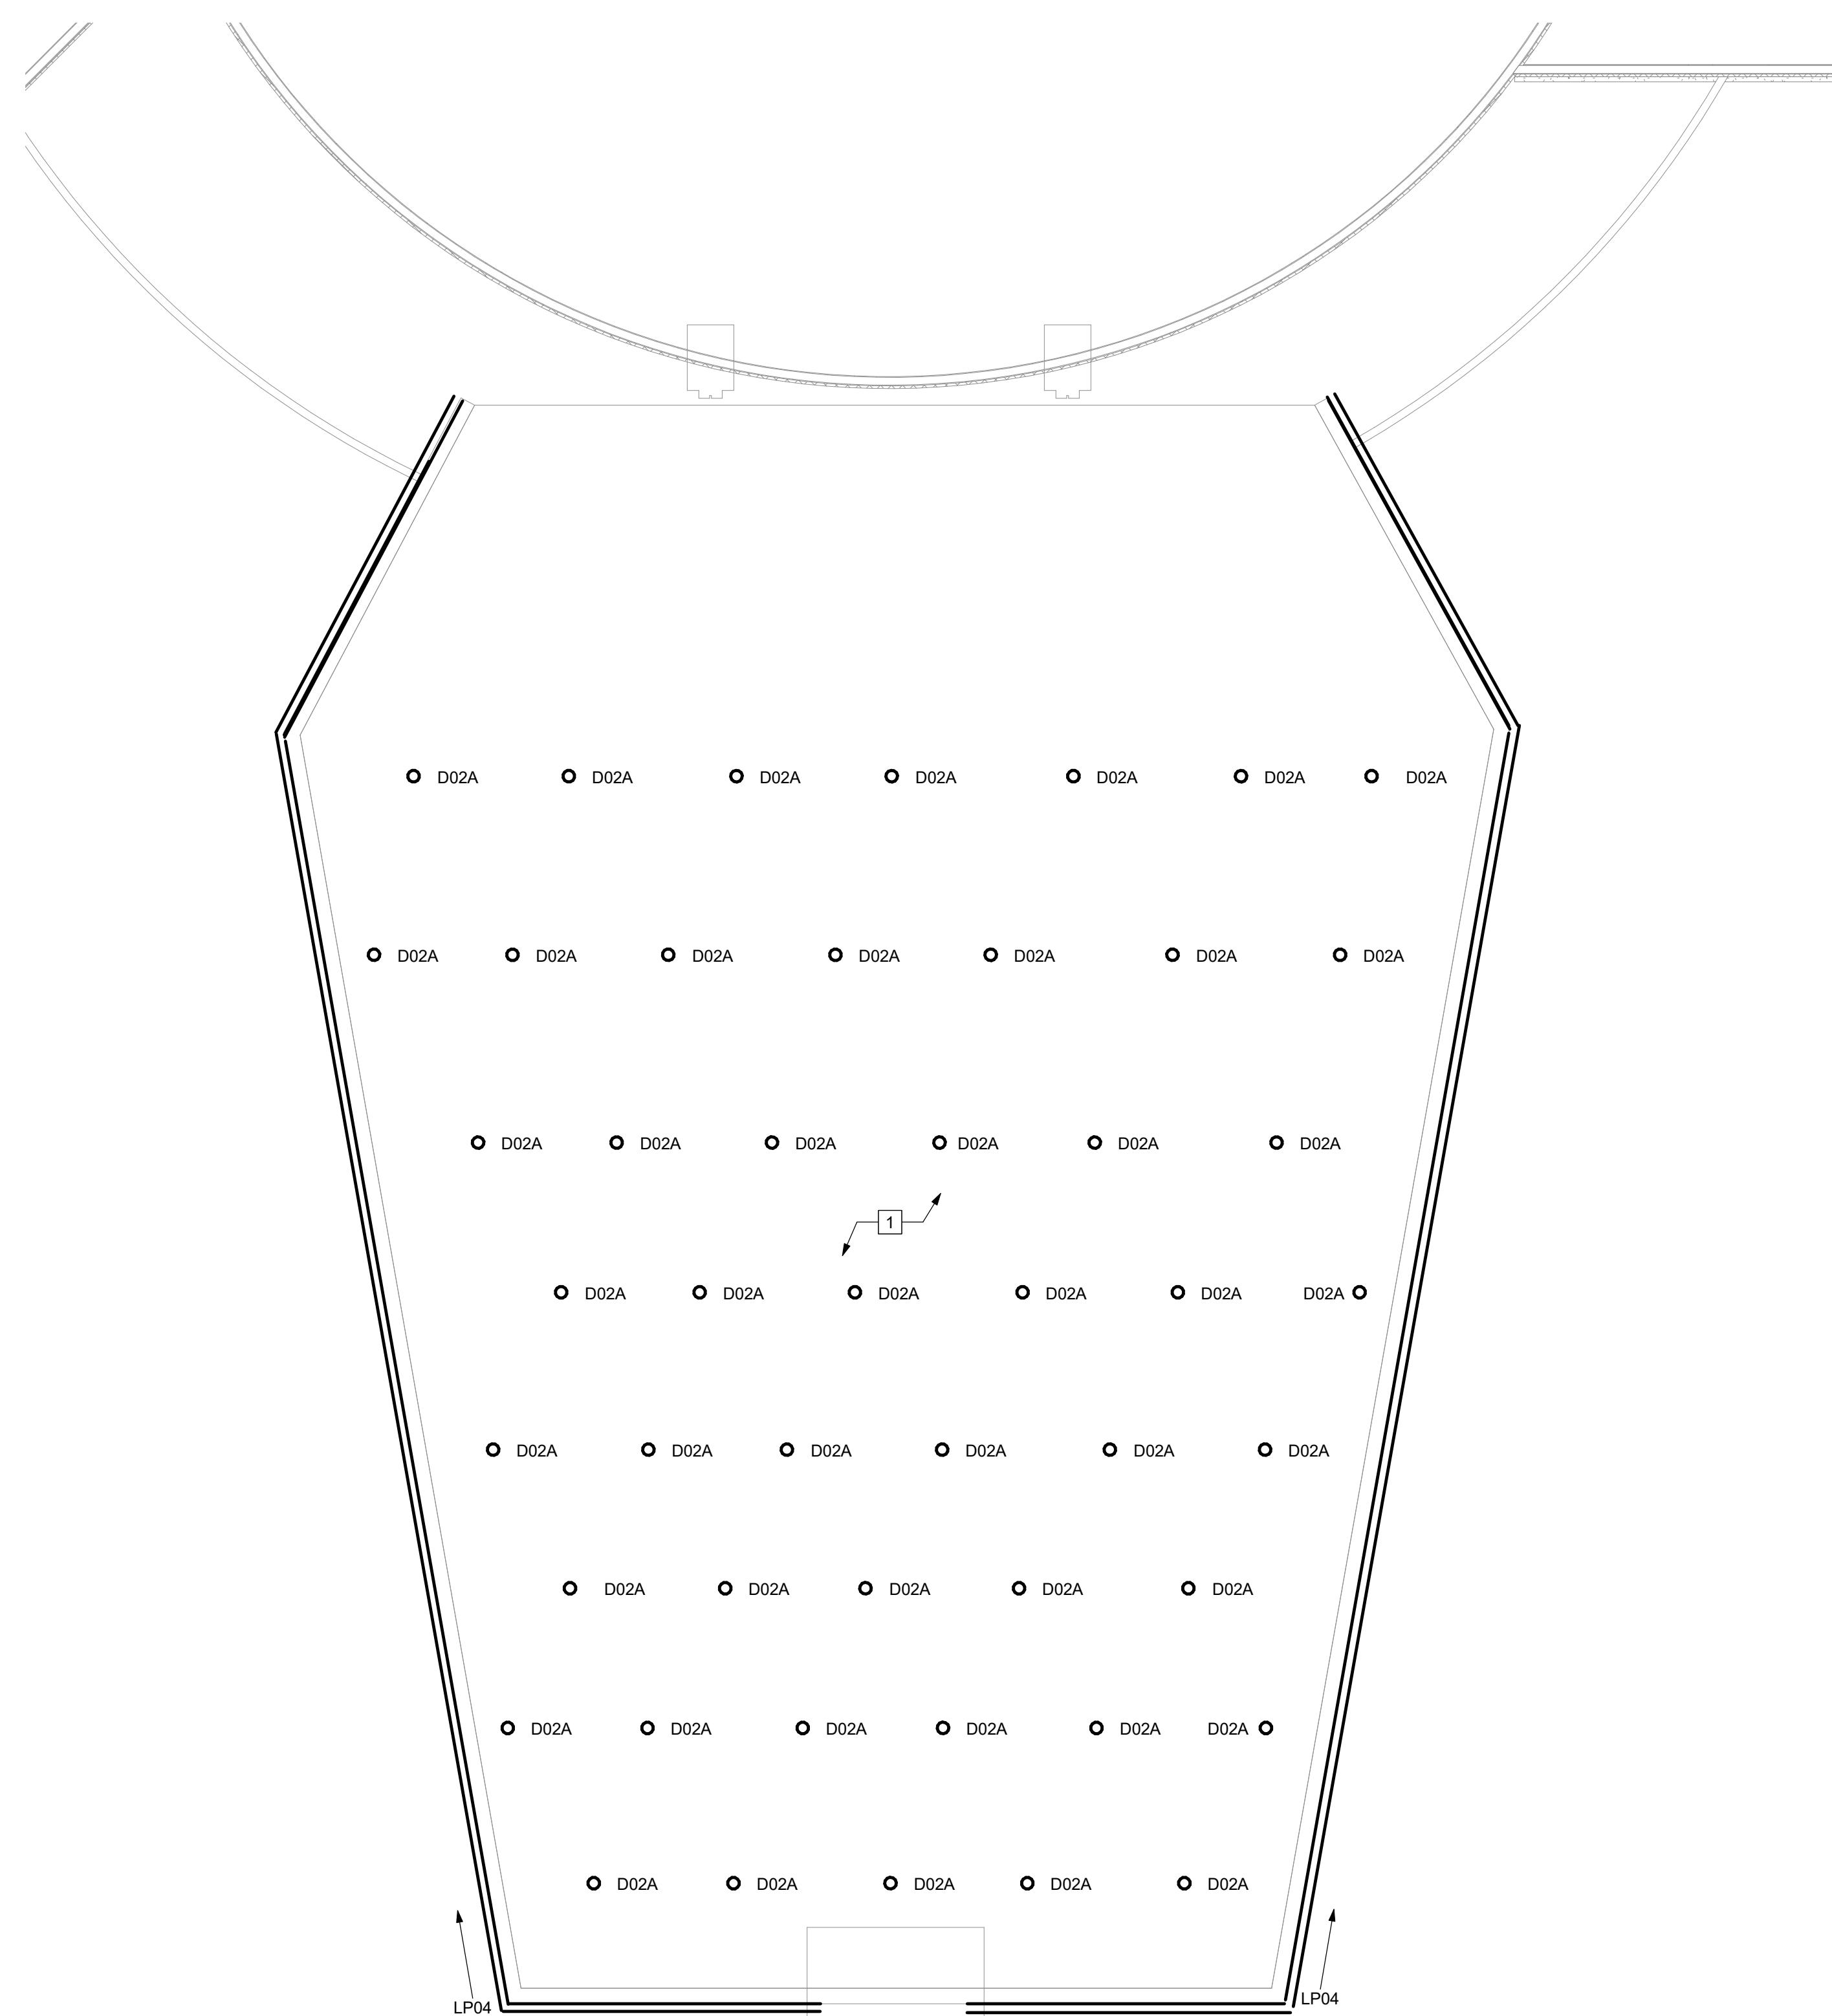
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LT-202 DEMOLITION NOTES


- 1 DISCONNECT AND REMOVE ALL EXISTING DOWNLIGHTS IN THIS AREA.
- 2 DISCONNECT AND REMOVE EXISTING FLOOD LIGHTS IN THIS AREA.

LT-202 DRAWING NOTES


- 1 MOUNT POWER SUPPLY FOR LINEAR TAPE RUNS AT TOP OF COLUMNS, TYPICAL ALL COLUMN LOCATIONS.



1 PORTE COCHERE TOP VIEW
1/8" = 1'-0"

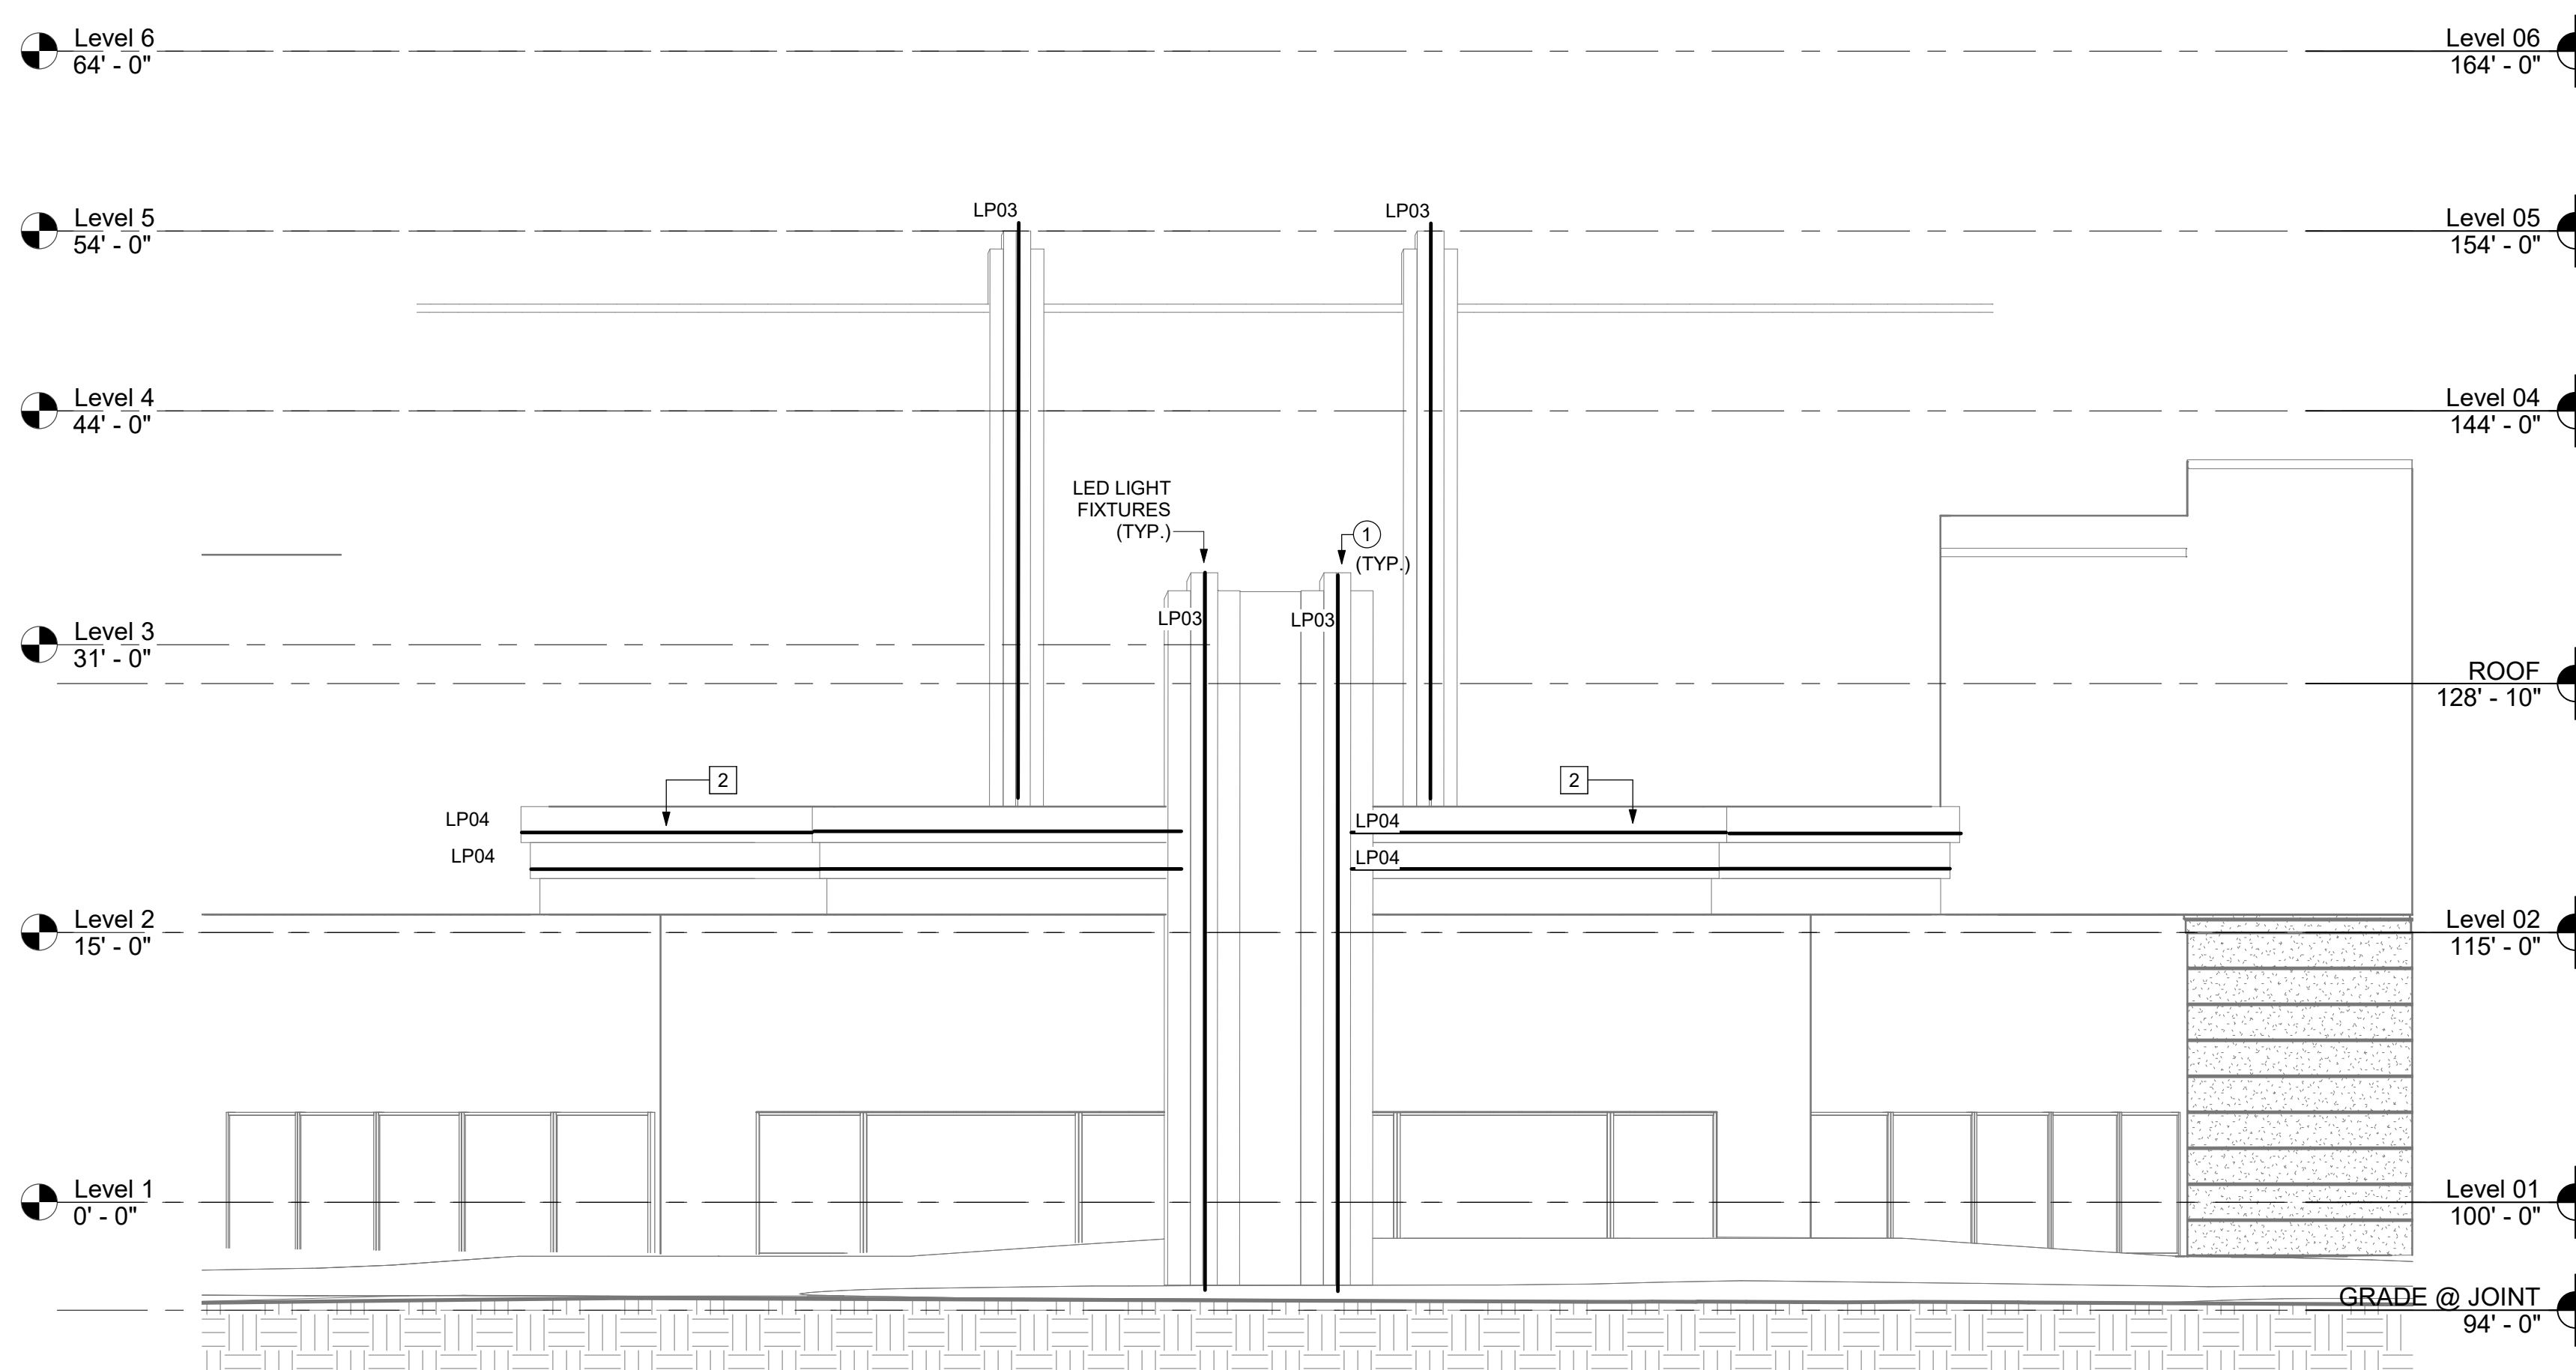

2 CASINO 1 PORTE COCHERE ELEVATION
1/8" = 1'-0"

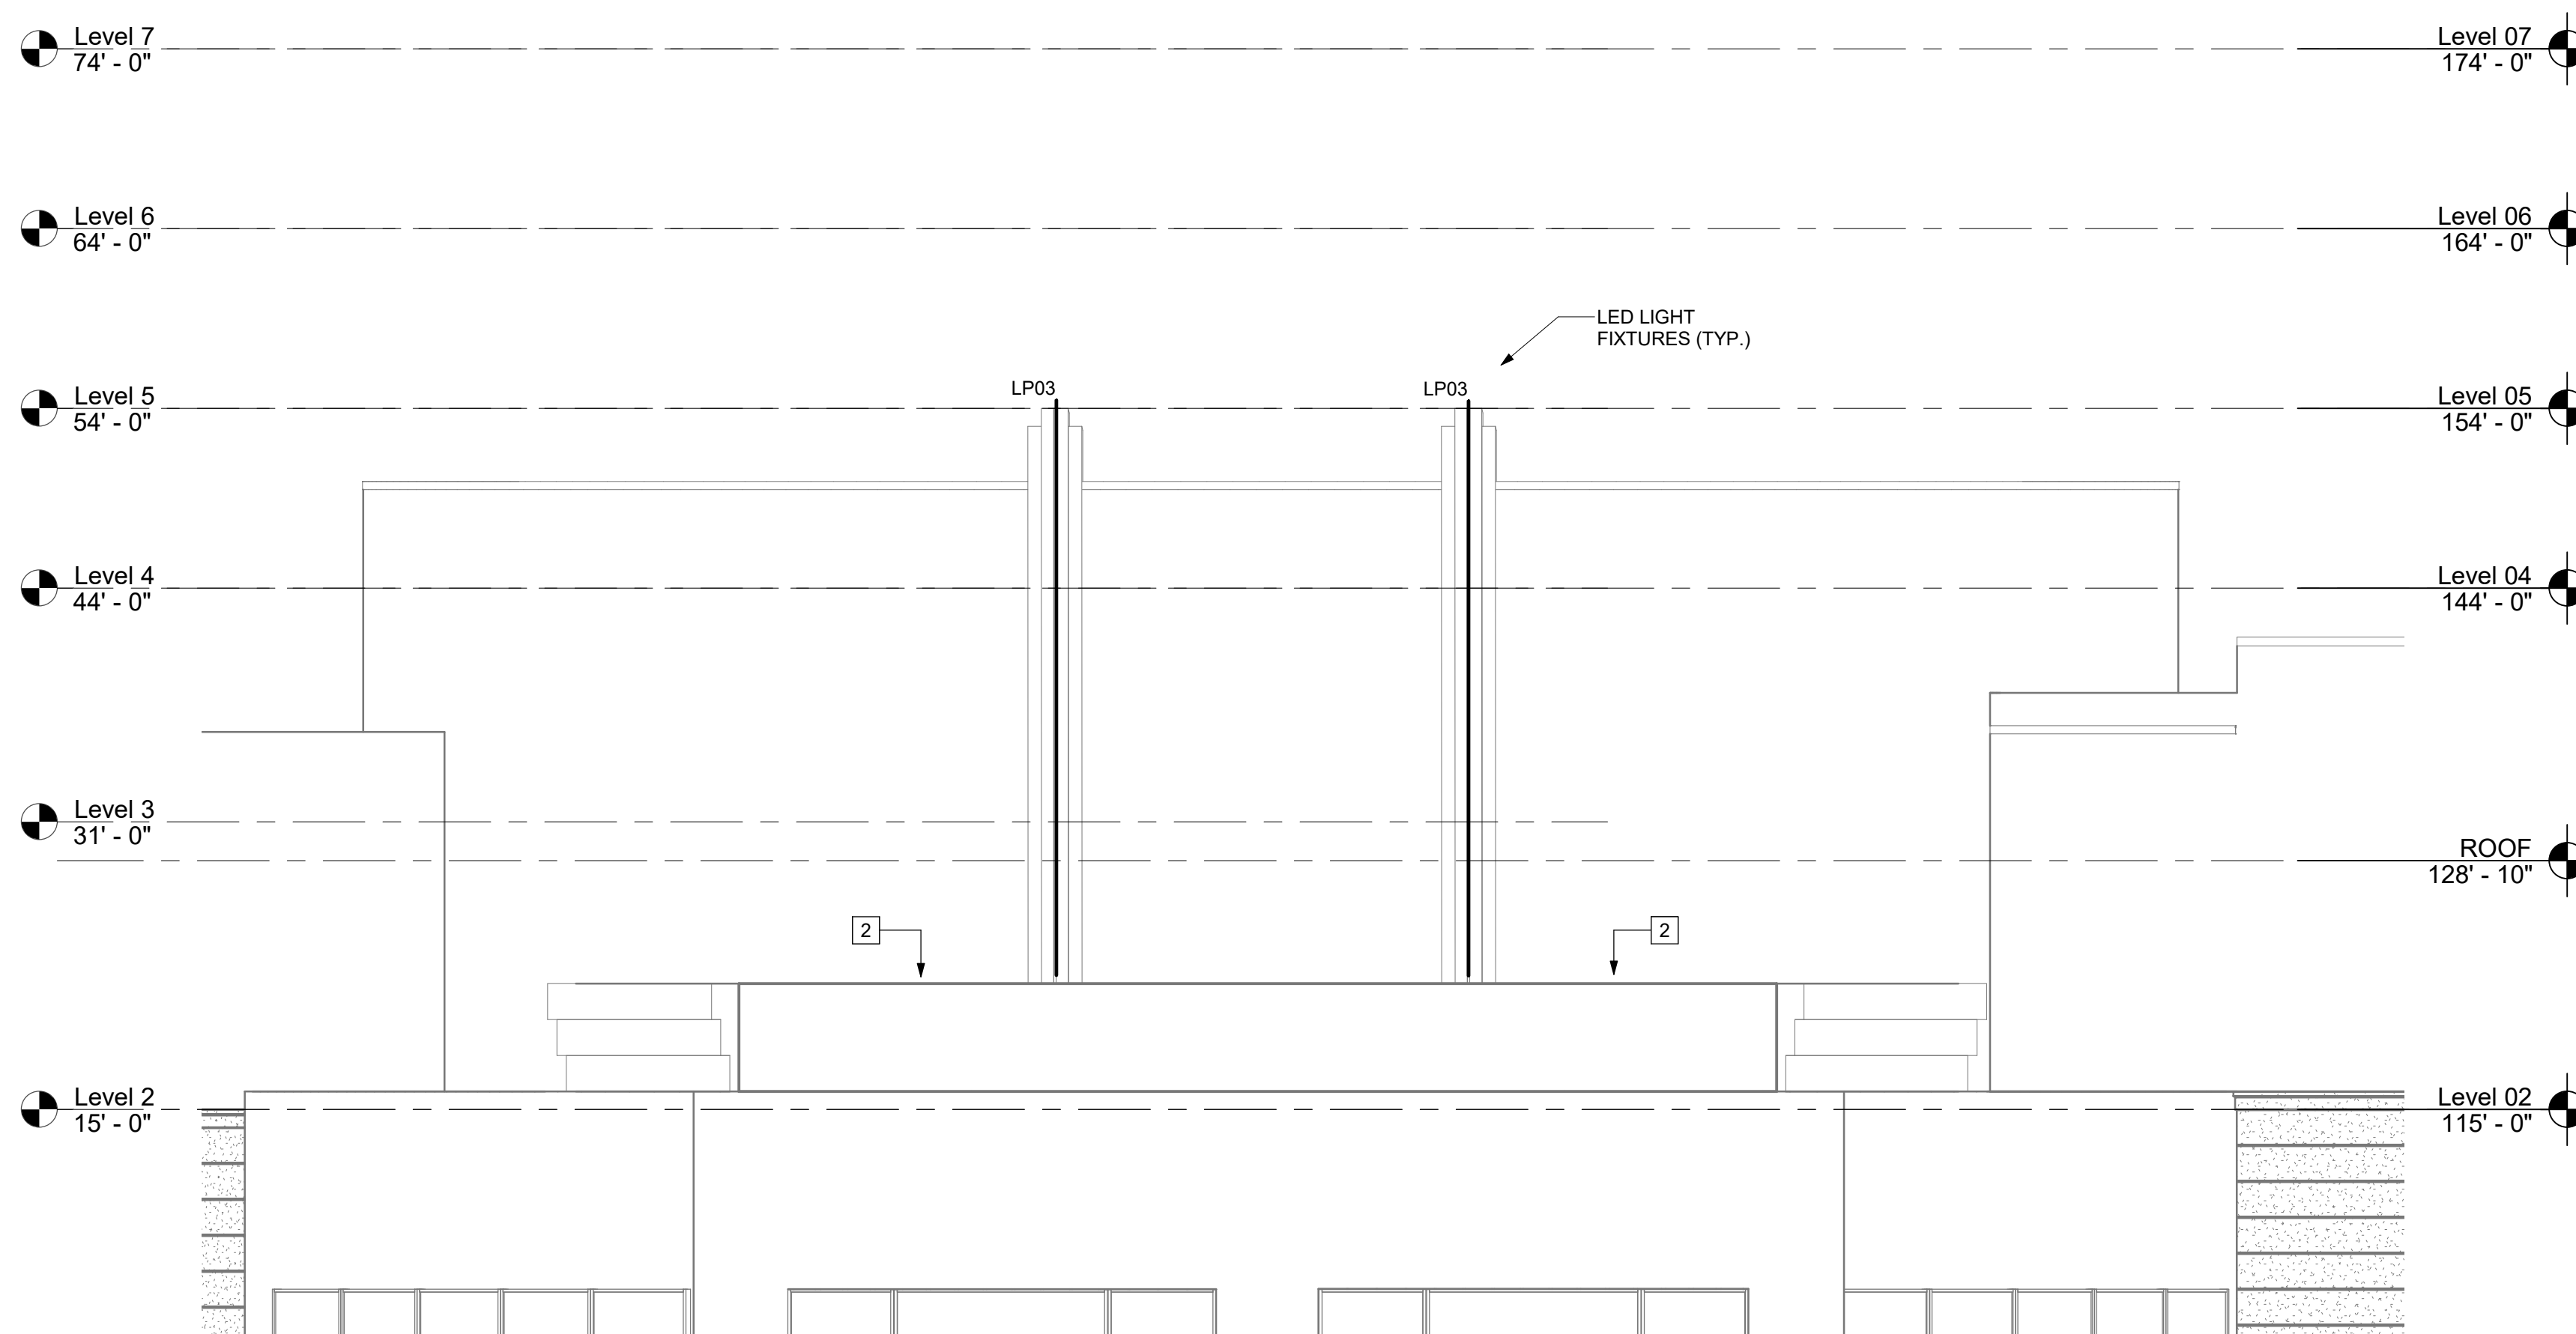

3 CASINO 1 ROTUNDA ELEVATION
1/8" = 1'-0"



Cherokee Hard Rock Hotel & Casino

EXTERIOR RENOVATION

No.	Description	Date

CONSTRUCTION SET
PROJECT NO: H17018
DRAWN BY: DSL
CHECKED BY: RJR
ISSUE DATE: 12/21/2018

LT-202

Scale 1/8" = 1'-0"

LT-203 DEMOLITION NOTES

1 DISCONNECT AND REMOVE EXISTING FACADE WASH LIGHTS IN THIS LOCATION.



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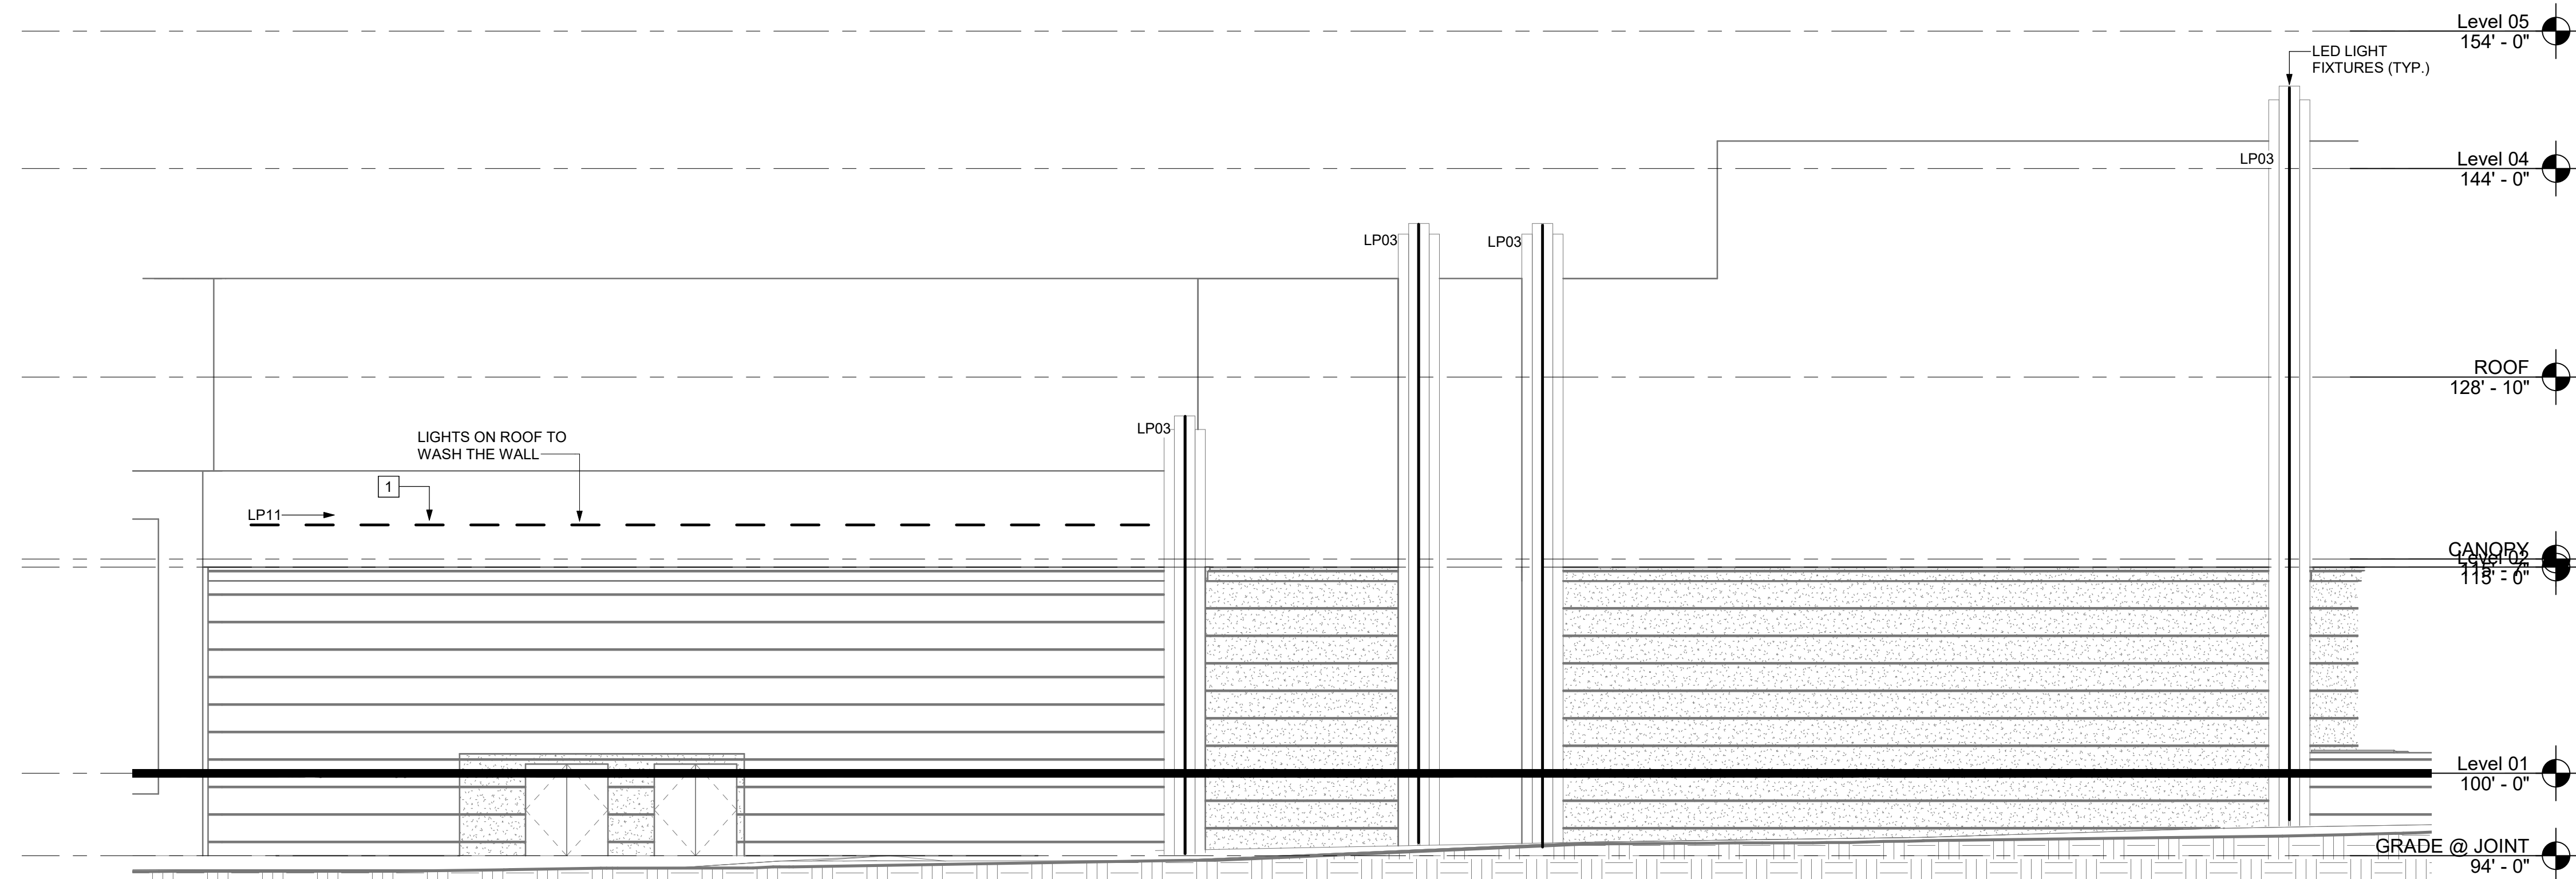
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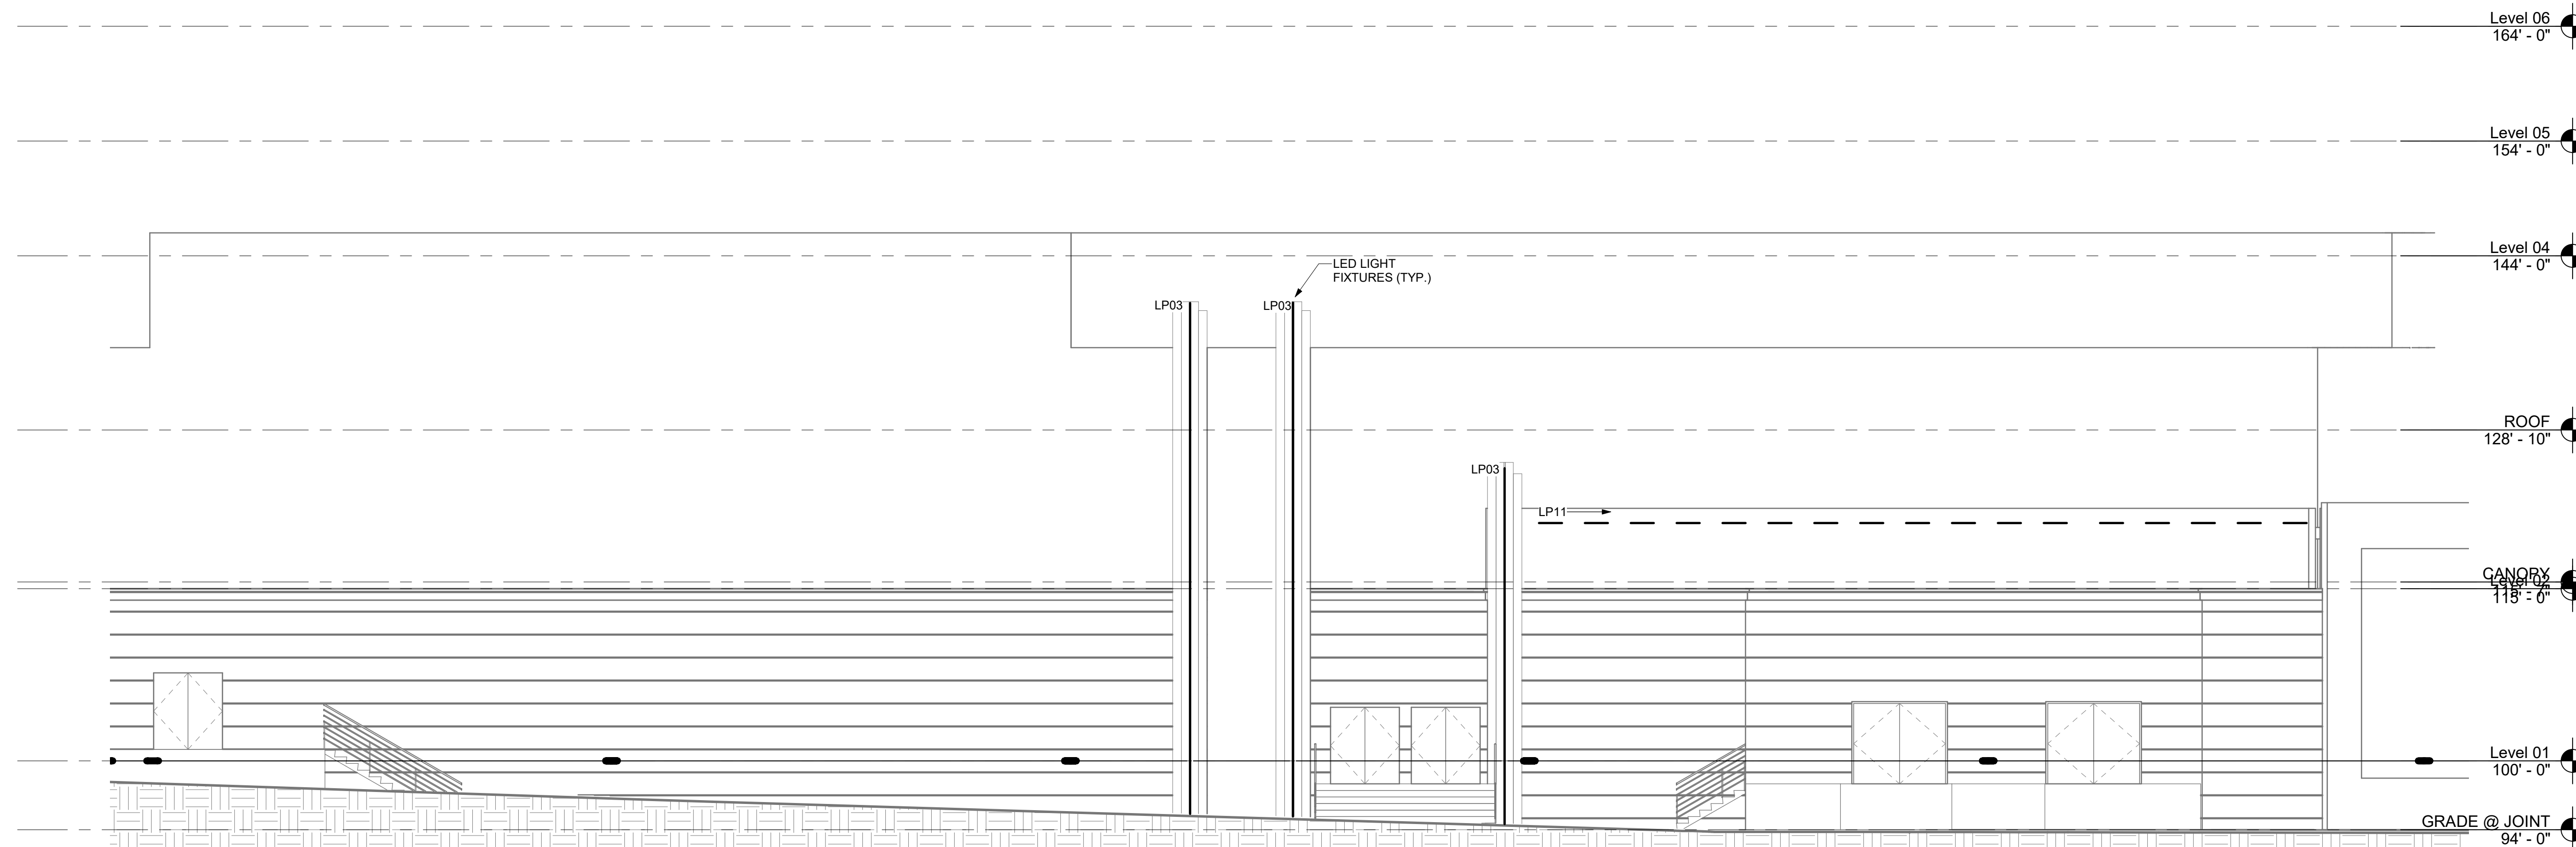
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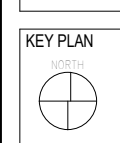
1 SOUTH FACADE ELEVATION
1/8" = 1'-0"



2 NORTH FACADE ELEVATION
1/8" = 1'-0"

Cherokee Hard Rock Hotel & Casino

EXTERIOR RENOVATION



No.	Description	Date

EXTERIOR ELEVATIONS - NORTH & SOUTH FACADE - LIGHTING

CONSTRUCTION SET

PROJECT NO: H17018
DRAWN BY: DSL
CHECKED BY: RJR
ISSUE DATE: 12/21/2018

LT-203

Scale 1/8" = 1'-0"

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LT-204 DEMOLITION NOTES

1 DISCONNECT AND REMOVE GROUND MOUNTED EXISTING FLOOD LIGHTS IN THIS AREA.

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MEP ENGINEERING


M&A Engineering Consultants
370 E. Windmill Ln.
Suite 100
Las Vegas, NV 89123
702-896-1100

CIVIL ENGINEERING / SURVEYING


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918-234-7596

LOW VOLTAGE / THEME LIGHTING

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60 Lakesfront Boulevard
Suite 300
Buffalo, NY 14202
716-845-5092

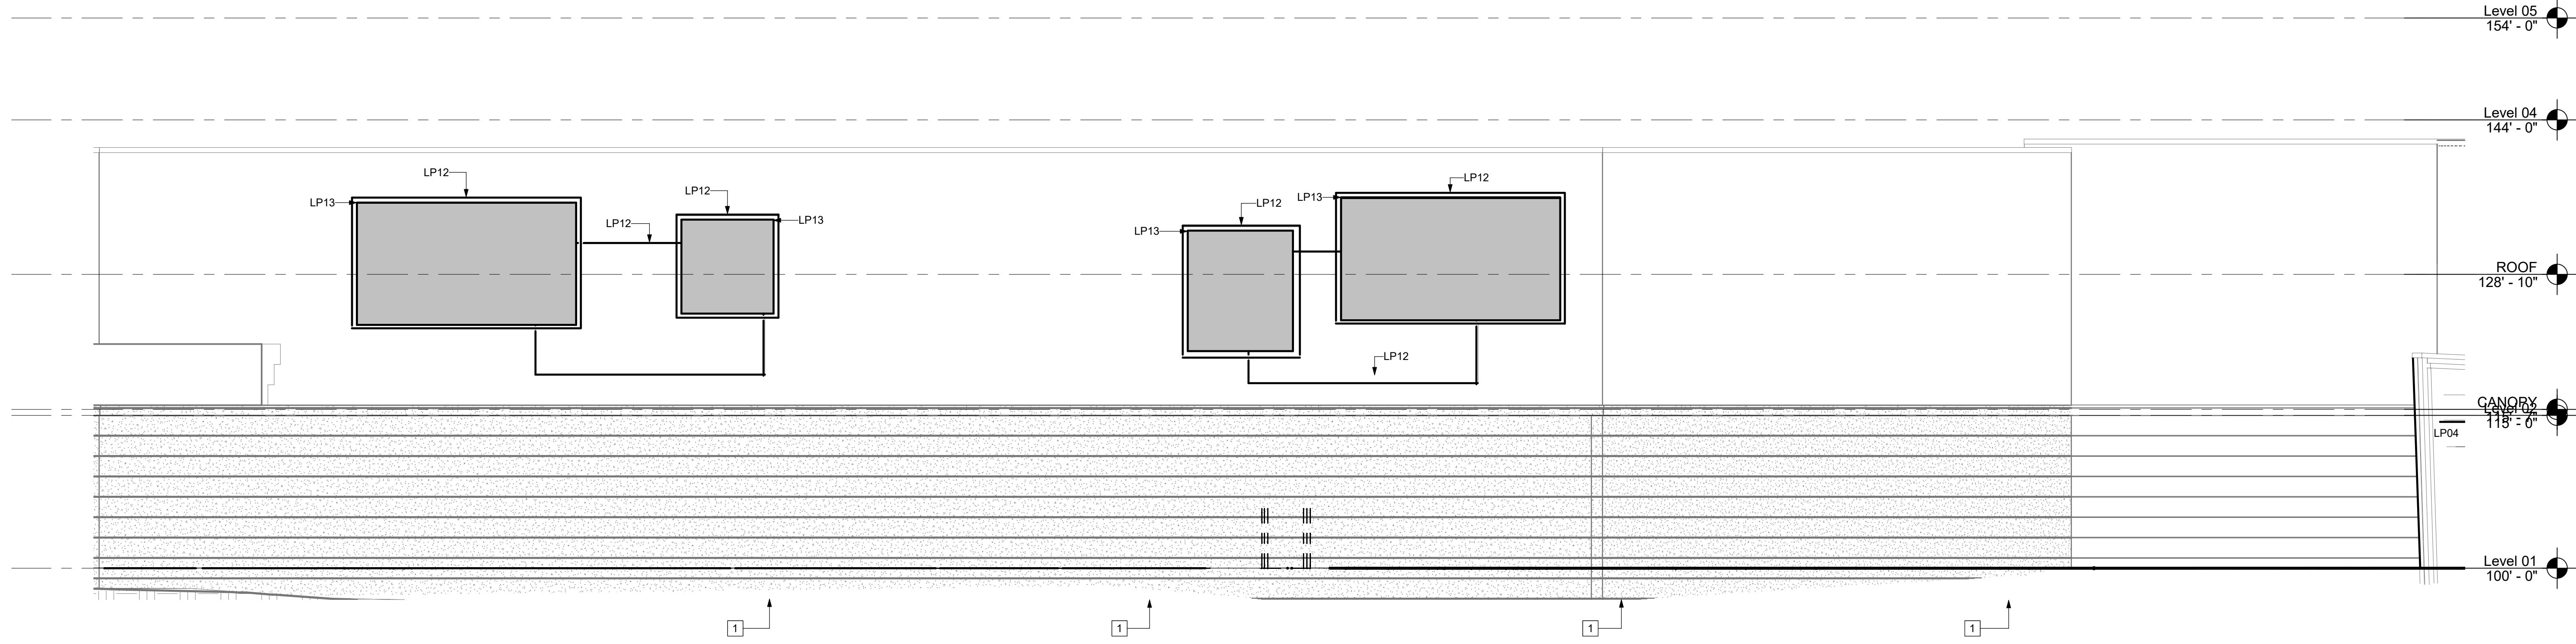

1 CASINO EAST WALL ELEVATION
1/8" = 1'-0"

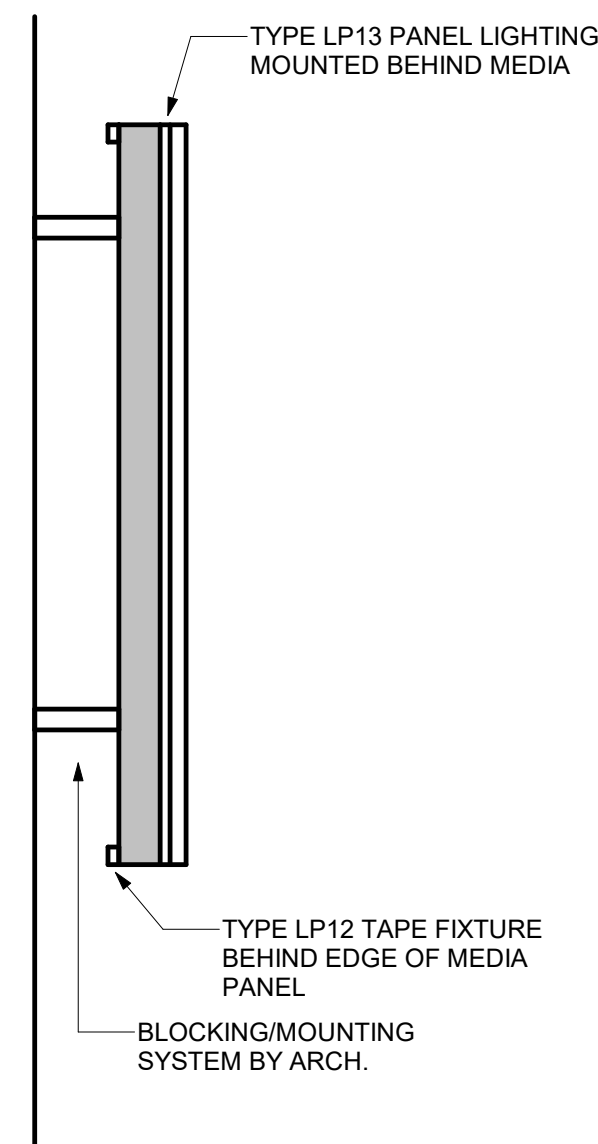

2 BACKLIT MEDIA PANEL DETAIL
1/8" = 1'-0"

Cherokee Hard Rock Hotel & Casino

EXTERIOR RENOVATION

KEY PLAN



No.	Description	Date

EXTERIOR ELEVATIONS - EAST - LIGHTING

CONSTRUCTION SET

PROJECT NO: H17018
DRAWN BY: DSL
CHECKED BY: RJR
ISSUE DATE: 12/21/2018

LT-204
Scale 1/8" = 1'-0"

12/21/2018 2:56:01 PM