

# PLANS FOR N 586 Rd Waterline DELAWARE COUNTY RURAL WATER DISTRICT #11

CHEROKEE NATION **COMMUNITY SERVICES** 



### STATE OF OKLAHOMA




# RURAL WATER DISTRICT BOARD OF DIRECTORS

...CLAYTON WILLIAMS ...BILL WELLS

CHAIRMAN... VICE — CHAIRMAN... SECRETARY... ...DEREK REYNOLDS ...BRENT POLLETT
...JOHN RATCHFORD MEMBER... MEMBER... MEMBER... ...BOB HUMPHRIES MEMBER... ...MAX WOLLARD

CHEROKEE NATION

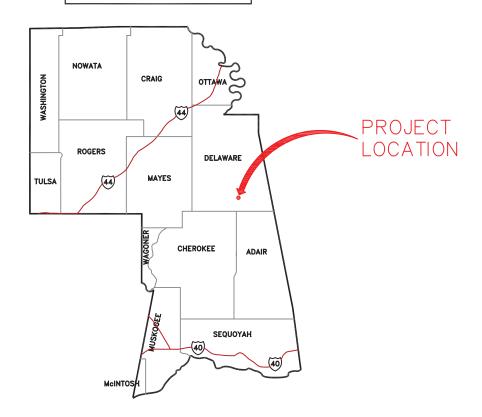


## CONTENTS

...COVER SHEET
...LOCATION SHEET
...PLAN SHEET
...PLAN SHEET SHEET 1 OF 5... SHEET 2 OF 5... SHEET 3 OF 5... SHEET 4 OF 5... SHEET 5 OF 5... ...DETAIL SHEET





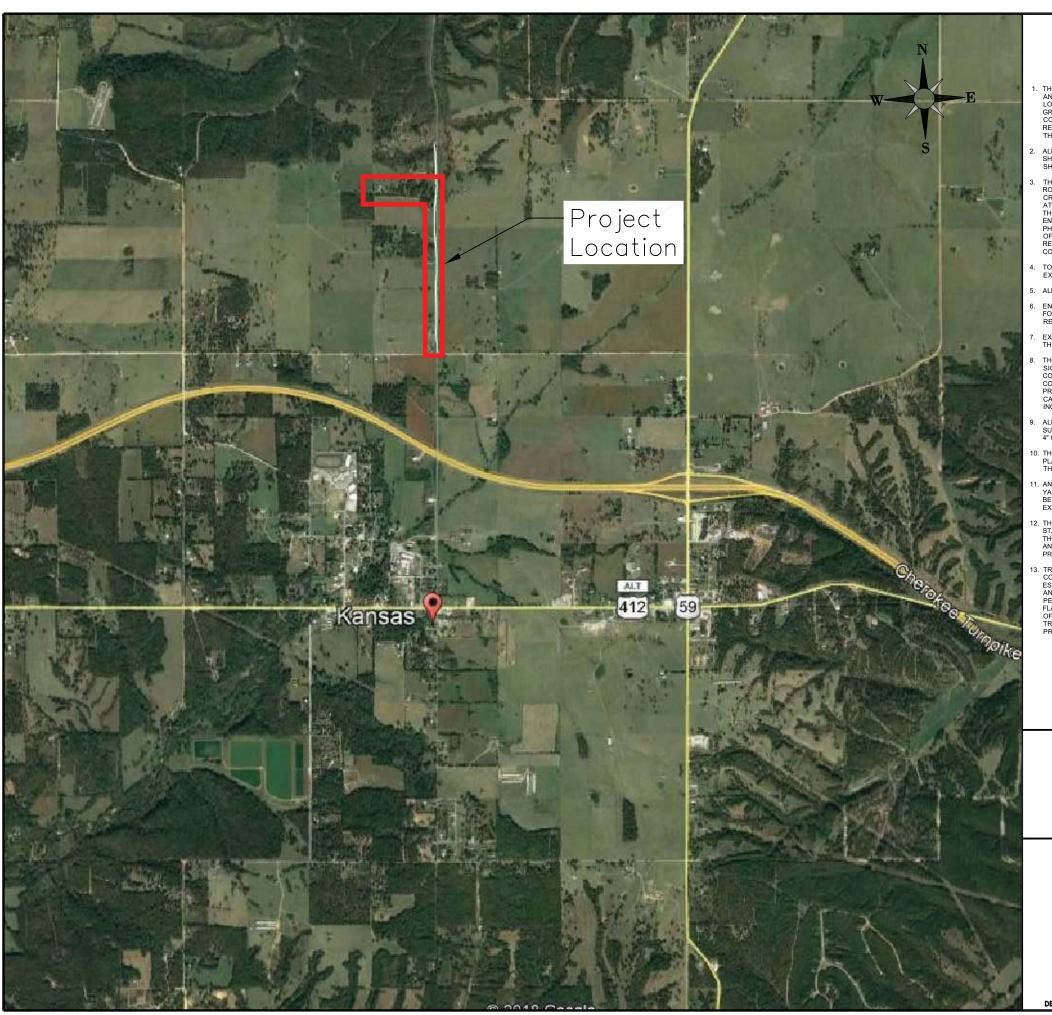

#### GENERAL NOTES

- THE CONTRACTOR SHALL CONTACT 'CALL OKIE' AT 1-800-522-6543
   AND EACH UTILITY COMPANY PRIOR TO DIGGING TO DETERMINE THE LOCATION OF THEIR FACILITIES. ANY CHANGES IN ALIGNMENT OR GRADE CAUSED BY INTERFERING UTILITIES SHALL BE MADE BY THE CONTRACTOR AT NO COST TO THE OWNER. THE CONTRACTOR SHALL BE RESPONSIBLE FOR THE COST OF REPAIR OF UTILITIES DAMAGED BY THE CONSTRUCTION.
- 2. ALL BEDDING, BACKFILLING AND SPECIAL SURFACE CROSSINGS SHALL BE PERFORMED IN STRICT ACCORDANCE WITH THE DETAILS SHOWN ON PLANS.
- 3. THE CONTRACTOR SHALL VIDEO ALL PORTIONS OF THE WATER LINE ROUTE AND PHOTOGRAPH THE AREAS SURRONDING ALL ROAD CROSSINGS PRIOR TO ANY CONSTRUCTION OR CLEARING ACTIVITIES AT THE REQUEST OF THE OWNER OR ENGINEER. THREE COPIES OF THE VIDEO AND PHOTOGRAPH FILES SHALL BE DELIVERED TO THE ENGINEER AT TEH PRE-CONSTRUCTION MEETING. THE VIDEOS AND PHOTOGRAPHS WILL BE USED BY THE OWNER AND REPRESENTATIVES OF THE LOCAL GOVERNING BOARD TO CONFIRM THAT THE RIGHT OF WAN RESTORATION HAS BEEN COMPLETED IN ACCORDANCE WITH THE CONTRACT REQUIREMENTS.
- . TOPSOIL SHALL BE REPLACED TO A DEPTH OF 4" OR THE DEPTH OF EXISTING TOPSOIL, WHICHEVER IS GREATER.
- ALL RESTRAINT JOINTS SHALL BE MIDCO OR APPROVED EQUAL.
- ENGINEER SHALL PROVIDE BENCHMARK AND HORIZONTAL CONTROL FOR TANK AND PUMP STATION SITES. CONTRACTOR SHALL BE RESPONSIBLE FOR CONSTRUCTION LAYOUT.
- . EXISTING GAS, TELEPHONE AND ELECTRIC LINES ARE NOT SHOWN ON THE PLANS.
- 8. THE CONTRACTOR SHALL REMOVE AND REINSTALL ALL FENCING AND SIGNAGE REQURED TO CONSTRUCT THE PROJECT. THE CONTRACTOR SHALL PROVIDE TEMPORARY FENCING DURING THE CONSTRUCTION AS REQUIRED FOR SAFETY AND TO PROTECT PRIVATE PROPERTY. NEW FENCING SHALL BE PROVIDED IF THE EXISTING FENCE CANNOT BE REINSTALLED TO ORIGINAL CONDITION. COST TO BE INCLUDED IN COST OF OTHER BID ITEMS.
- ALL DRIVES AND ROADS SHALL BE REPLACED TO MATCH EXISTING SURFACE TYPE AND DEPTH BUT SHALL HAVE A MINIMUM SURFACE OF 4" OF DOD'T TYPE '4" COMPACTED AGGREGATE BASE.
- 10. THE CONTRACTOR SHALL PREPARE A 'STORMWATER PREVENTION PLAN' AND EROSION CONTROL MEASURES TO AVOID SILT FROM LEAVING THE JOB SITE. COST TO BE INCLUDED IN COST OF OTHER BID ITEMS.
- 11. ANY DAMAGE TO THE ROADWAY, PAVEMENT, DRIVEWAYS, SIDEWALKS, YARDS OR FIELDS CAUSED BY THE CONTRACTOR'S OPERATION SHALL BE REPAIRED TO THE OWNER'S SATISFACTION AT THE CONTRACTOR'S EXPENSE.
- 12. THE CONTRACTOR SHALL COMPLY WITH ALL APPLICABLE, FEDERAL, STATE AND LOCAL LAWS GOVERNING SAFETY, HEALTH AND SANITATION. THE CONTRACTOR SHALL PROVIDE ALL SAFEGUARDS, SAFETY DEVICES AND PROTECTIVE EQUIPMENT AND TAKE ANY OTHER ACTION TO PROTECT PROPERTY AND PERSONS IN THE PERFORMANCE OF THE WORK
- 13. TRAFFIC CONTROL: THE CONTRCTOR SHALL WORK IN COOPERATION WITH THE BOARD OF COUNTY COMMISSIONERS TO ESTABLISH, INSTALL, MAINTAIN AND OPERATE COMPLETE, ADEQUATE AND SAFE TRAFFIC CONTROL DURING THE ENTIRE CONSTRUCTION PERIOD. THE CONTRACTOR SHALL PLACE TRAFFIC CONTROL FLAGMEN, BARRICADES AND OTHER DEVICES WITHIN THE WICINITY OF THE CONSTRUCTION AS REQUIRED BY THE MANUAL OF UNIFORM TRAFFIC CONTROL. COST OF TRAFFIC CONTROL TO BE INCLUDED IN

- ITEMS INCLUDED IN THIS CONTRACT BY NOT INCLUDED IN THE PROPOSAL SHALL BE CONSIDERED INCIDENTAL AND SHALL BE INCLUDED IN THE COST OF OTHER ITEMS.
- 15. BID ITEMS INCLUDED IN THE BID SCHEDULE SHALL INCLUDE ALL WORK SHOWN ON THE PLANS AND REQUIRED BY THE SPECIFICATIONS IF THERE ARE CONFLICTS BETWEEN THE PAY ITEMS IN THE BID SCHEDULE AND THE SPECIFICATIONS, THE BID PROPOSAL SHALL GOVERN
- 16. THE CONTRACTOR SHALL FIELD VERIFY ELEVATION OF ALL EXISTING UTILITY CROSSINGS BY EXCAVATING 100 FEET IN ADVANCE OF WATER LINE CONSTRUCTION.
- 17. STREETS AND ROADS SHALL BE KEPT OPEN FOR LOCAL TRAFFIC AT ALL TIMES UNLESS APPROVED BY THE LOCAL GOVERNING BOARD.
- 18. PIPE WILL BE PAID FOR BASED ON THE HORIZONTAL MEASUREMENT
- 19. THE CONTRACTOR SHALL CONTACT THE LAND OWNERS WHOSE PROPERTY ACCESS WILL BE DISTRIBUTED BY THE CONSTRUCTION TO REVIEW AND SCHEDULE DRIVEWAY CUTS, PROTECTION OF CATTLE AND FENCE REMOVAL AND REPLACEMENT.
- 20. LINE TESTING AND STERILIZATION
- a. ALL LINES SHALL BE TESTED AND STERILIZED IN ACCORDANCE WITH THE MOST RECENT AWWA STANDARDS. WATER TO BE PROVIDED BY THE OWNER FROM THE EXISTING SYSTEM. WATER FOR FLUSHING, TESTING AND STERILIZATION SHALL BE METERED AND PAID FOR BY CONTRACTOR.
- b. EXISTING VALVE SHALL BE OPERATED BY THE OWNER. THE CONTRACTOR SHALL PROVIDE VALVES, FITTINGS, PUMPS, ETC. REQUIRED FOR THE FLUSHING, TESTING AND STERILIZATION OF THE LINES.
- c. THE CONTRACTOR SHALL REMOVE AIR FROM LINES TO SATISFACTION OF THE ENGINEER / OWNER. FINAL PAYMENT WILL NOT BE APPROVED UNTIL THE OWNER IS SATISFIED THAT NEW LINES ARE FREE FROM AIR AND FLOWING AT FULL CAPACITY.
- 21. ALL CONNECTIONS OF POLYETHYLENE PIPE TO VALVES, FITTINGS OR TIE-INS TO EXSTING LINES SHALL BE RESTRAINED USING MJ/PE ADAPTER KIT BY INDEPENDENCE PRODUCTS, INC. OR APPROVED EQUAL.
- 22. THE NEW BARBED WIRE FENCE PAY ITEM SHALL ONLY BE USED WITH THE CONCURRENCE OF THE ENGINEER WHEN SPACE, SOIL CONDITIONS (I.E. ROCK) OR EXISTING UTILITIES REQUIRE THE REMOVAL OF THE EXISTING FENCE. BID PRICE SHALL INCLUDE REMOVAL AND DISPOSAL OF EXISTING FENCE.
- 23. CONTRACTOR SHALL VERIFY OWNER TO RECEIVE A METER SETTING WITH THE DISTRICT MANAGER AND CONSULT WITH THE DISTRICT MANAGER REGARDING LOCATION OF EACH METER SETTING.
- 24. SEPARATION REQUIREMENTS
- a. WATER MAINS SHALL BE AT LEAST 10' HORIZONTALLY FROM ANY EXISTING OR PROPOSED SEWER LINES.
- b. WATER MAINS SHALL BE AT LEAST 5' HORIZONTALLY FROM ANY EXISTING OR PROPOSED STORM SEWERS, RAW WATER LINES, PETROLEUM PRODUCT LINES, NATURAL GAS LINES, AND OTHER BURIED UTILITY LINES.
- . CAST IRON WATER LINES SHALL BE AT LEAST 10' HORIZONTALLY FROM ANY GASOLINE STORAGE TANK AND LINES; PVC WATER LINES SHALL BE AT LEAST 50' HORIZONTALLY FROM ANY GASOLINE STORAGE TANK AND LINES.
- d. WATER LINES SHALL BE AT LEAST 15' HORIZONTALLY FROM ALL PARTS OF SEPTIC TANKS AND ABSORPTION FIELDS OR OTHER SEWAGE TREATMENT AND DISPOSAL SYSTEMS.
- 9. WATER LINES SHALL HAVE A 2' VERTICAL SEPARATION BETWEEN WATER LINES AND ANY EXISTING OR PROPOSED STORM SEWERS, RAW WATER LINES, PETROLEUM PRODUCT LINES, NATURAL GAS LINES, AND OTHER DUBBE UTILITIES.

DELAWARE COUNTY KANSAS QUADRANGLE SECTION 12 TOWNSHIP 20 NORTH RANGE 23 EAST

Gate Valve

Air Relief Valve

GV w/ Flush Hydrant

Water Line

G=Gravel
A=Asphalt
C=Concrete
B=Bore

Gate Valve

Air Relief Valve

Proposed Crossing



location sheet
N 586 Rd W/L
Delaware county rwd #11

LEGEND

**EXISTING** 

**%** 


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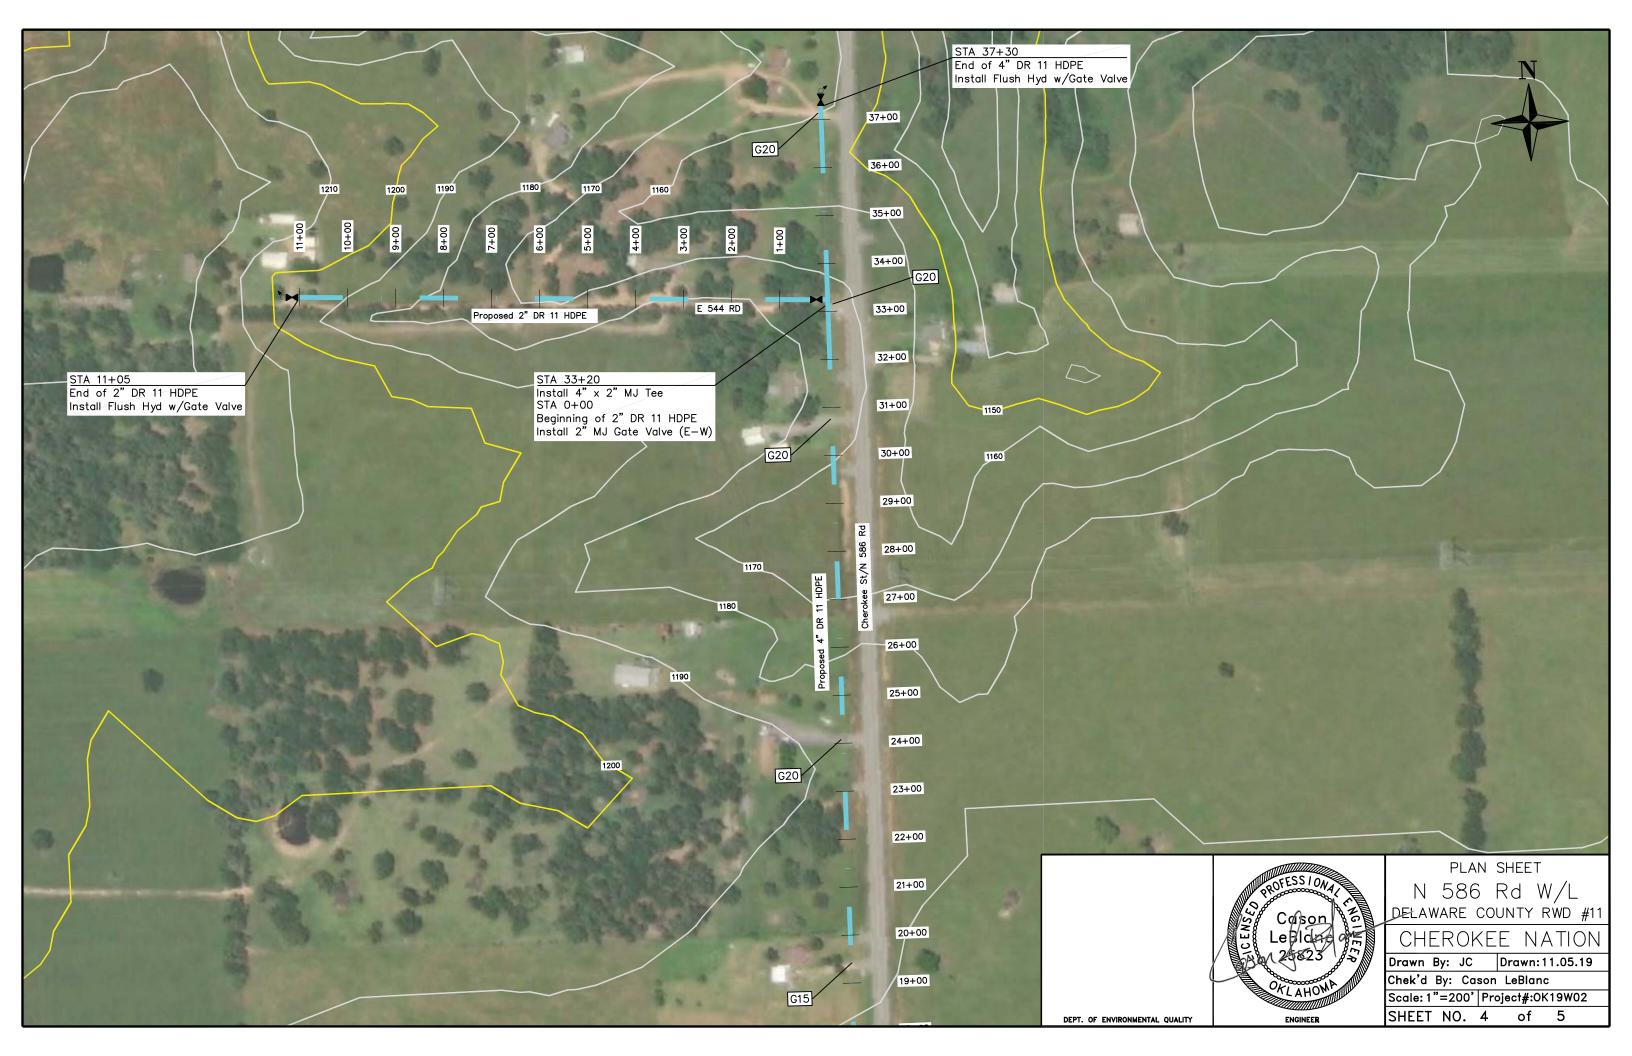
CHEROKEE NATION


Drawn By: JC Drawn: 11.05.19
Chek'd By: Cason LeBlanc

Scale: NTS | Project#:0K19W02 SHEET NO. 2 of 5

DEPT. OF ENVIRONMENTAL QUALITY



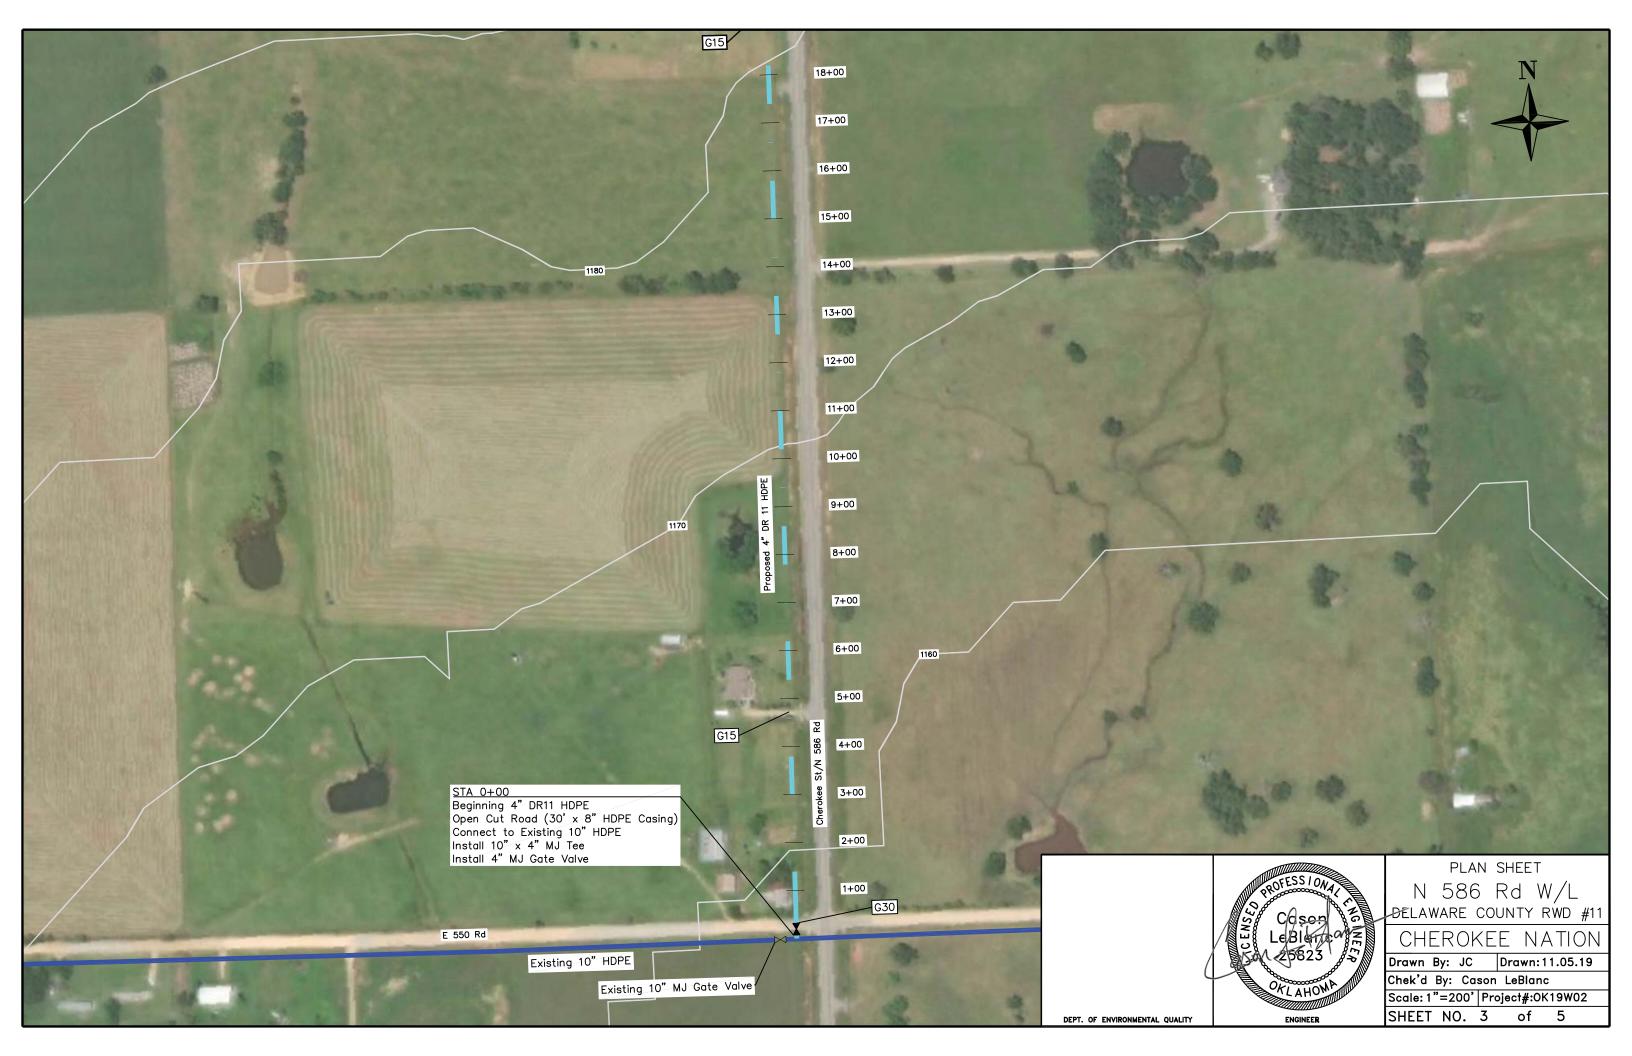

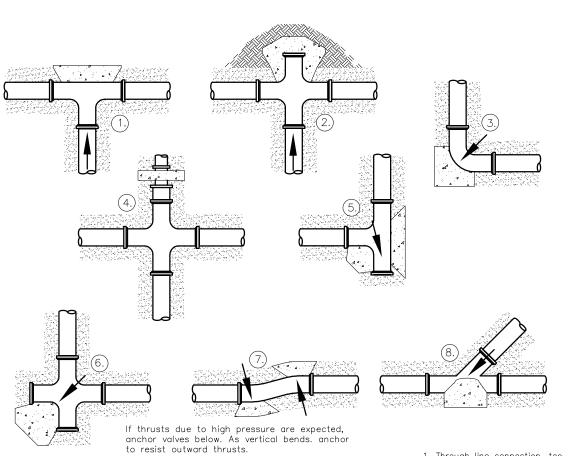

THRUST RESTRAINT

NTS

SYMMETRICAL ABOUT

- ENCASEMENT PIPE

1. ENCASEMENT PIPE WILL NORMALLY TERMINATE AT TOE OF


- Through line connection, tee
   Through line connection, cross used as tee.
- 3. Direction change, tee elbow.4. Change line size, reducer.
- 5. Direction change, tee used as
- elbow.
  6. Direction change, cross used as elbow.
- 7. Direction change.

36" MIN. DITCH COVER

CARRIER PIPE


8. Through line connection, wye.
9. Direction change vertical, bend


2" GALVANIZED VENT PIPE AT ROW

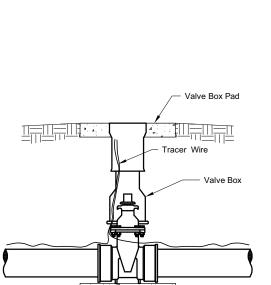



GATE VALVE DETAIL with Push On-Ends NTS

#### NOTES:

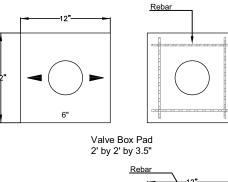

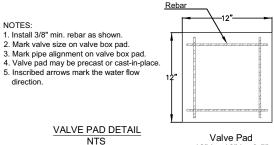

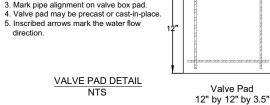


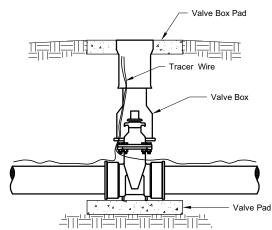




1. Center Valve Box Over Valve Stem

2. Set Lid of Valve Box Flash with Finish Grade

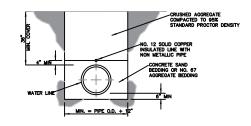


UNDER STREET, DRIVEWAY OR SIDEWALK

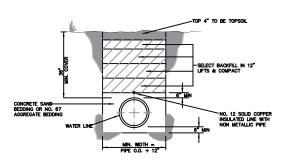

OPEN AREAS

#### WATER LINE BEDDING DETAIL

POLYETHELENE PIPE SHALL BE ALLOWED TO COOL OVERNIGHT IN THE TRENCH TO ALLOW SHRINKAGE PRIOR TO MAKING TIE-INS IN ORDER TO PREVENT PULL-C ER REMOVED FOR A DEPTH OF AT LEÄST MICLUDE ANCHORS IN THE COST OF BEDDING FOR PIPE.

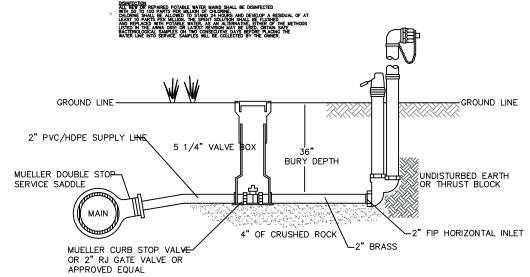

FLUSH HYDRANT DETAIL


NTS

POST HYDRANTS SHALL BE NON-FREEZING, SELF DRAINING TYPE WITH A 3' BURY. THESE HYDRANTS WILL BE FURNISHED WITH A 2" FIP HORIZONTAL INLET, A NON-TURNING OPERATING ROD, AND SHALL OPEN LEFT. BRONZE OPERATING MECHANISM AND ALUMINUM PLUNGER
DESIGN. AND BE SERVICEABLE FROM ABOVE GRADE WITH NO DIGGING. THE OUTLET SHALL ALSO BE BRONZE AND BE 2-1/2" NST. HYDRANTS SHALL BE LOCKABLE TO PREVENT UNAUTHORIZED USE AS MANUFACTURED BY KUPFERLE FOUNDRY CO. ST. LOUIS, MO. OR APPROVED EQUAL.



NOTES:

direction.

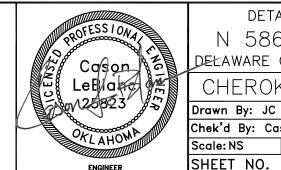

DETAIL SHEET N 586 Rd W/L DELAWARE COUNTY RWD #11

CHEROKEE NATION

Drawn: 11.05.19

Chek'd By: Cason LeBlanc

Project #: OK19W02 Scale: NS SHEET NO. 5 of

DEPT. OF ENVIRONMENTAL QUALITY

2" GALVANIZED VENT PIPE AT ROW

∠ CONCRETE PLUG

OR FLEX SEAL

2. ENCASEMENT PIPE WILL NORMALLY TERMINATE AT TOE OF SLOPE IN FILL SECTION OF HIGHWAY

2. ENCASEMENT PIPE SHALL NORMALLY BE TWICE THE DIAMETER OF THE CARRIER PIPE UNLESS OTHERWISE SHOWN.

3. OPEN CUT DITCH WILL NORMALLY TERMINATE 10' FROM EDGE OF PAVING

NATURAL GROUND SURFACE

**ROAD CROSSING** 

NOT TO SCALE