

NO.	DESCRIPTION	DATE
1	ISSUED FOR PERMIT	11/22/2022
2	ISSUED FOR CONSTRUCTION	11/22/2022
3	ISSUED FOR RECORD	11/22/2022

THIS SURVEY IS FOR GENERAL INFORMATION ONLY. IT IS NOT TO BE USED FOR CONSTRUCTION. ANY CHANGES TO THIS DRAWING MUST BE APPROVED BY THE ARCHITECT.

WALDOCK DESIGN COLLECTIVE
ARCHITECTS
11222
2240219
11/22/2022



THE CONTRACTOR IS SPECIFICALLY CAUTIONED THE LOCATION OF THE UTILITY MARKERS SHOWN ON THESE PLANS ARE BASED ON RECORDS OF THE MUNICIPAL UTILITY DEPARTMENT AND CONSTRUCTION RECORDS. THE CONTRACTOR SHALL VERIFY THE LOCATION OF ALL UTILITIES BY EXCAVATION TO A MINIMUM DEPTH OF 7 FEET PRIOR TO ANY EXCAVATION WORK.

PLANT TYPE	ACRE	PER 1000 PLANTING	DATE	DEPTH OF BEDDING
ANNUAL PERENNIALS	40 LBS.	2 BU.	09/25-10/01	18 IN.
ELBOW PINE	2 BU.	3 LBS.	09/25-10/01	24 IN.
WHAT	2 BU.	3 LBS.	09/25-10/01	24 IN.
GRASS	2 BU.	2 LBS.	09/25-10/01	24 IN.
SODD GRASS	60 LBS.	1 LBS.	09/25-10/01	24 IN.


DEMOLITION NOTES:
 1. ALL CONCRETE AND MORTAR NOTES FOR REMOVAL SHALL BE SHOWN WITH CUT-FILL DEPTH AND REMOVAL POINTS.
 2. CONTRACTOR SHALL PROTECT ALL SURVEY CONTROL POINTS.
 3. CONTRACTOR SHALL REMOVE ALL WASTE MATERIALS FROM SITE.
 4. ALL EXISTING STRUCTURES, UTILITIES, AND OTHER ITEMS TO BE REMOVED OR DEMOLISHED SHALL BE REMOVED OR DEMOLISHED IN ACCORDANCE WITH THE CITY OF OKLAHOMA DEPARTMENT OF PUBLIC WORKS AND SAFETY.
 5. WITH PRIOR APPROVAL, CONTRACTOR MAY ESTABLISH AN EXISTING REMOVAL STAGING AREA AT THE CONSTRUCTION SITE.
 6. CONTRACTOR SHALL BE RESPONSIBLE FOR PROTECTING REMOVAL STAGING AREA FROM CONSTRUCTION EQUIPMENT AND MATERIALS.
 7. CONTRACTOR SHALL BE RESPONSIBLE FOR PROTECTING REMOVAL STAGING AREA FROM CONSTRUCTION EQUIPMENT AND MATERIALS.
 8. CONTRACTOR SHALL PROTECT ALL ABOVE GROUND UTILITIES, EXISTING STRUCTURES, AND OTHER ITEMS TO BE REMOVED OR DEMOLISHED.
 9. CONTRACTOR SHALL BE RESPONSIBLE FOR PROTECTING REMOVAL STAGING AREA FROM CONSTRUCTION EQUIPMENT AND MATERIALS.
 10. CONTRACTOR SHALL BE RESPONSIBLE FOR PROTECTING REMOVAL STAGING AREA FROM CONSTRUCTION EQUIPMENT AND MATERIALS.
 11. CONTRACTOR SHALL BE RESPONSIBLE FOR ALL TRAFFIC CONTROL DURING CONSTRUCTION WORK. ALL TRAFFIC CONTROL SHALL BE IN ACCORDANCE WITH THE CITY OF OKLAHOMA DEPARTMENT OF PUBLIC WORKS AND SAFETY.
 12. UTILITIES DISCONNECTED FROM TO ANY DEMOLITION SHALL BE RECONNECTED OR RELOCATED.
 13. NO UTILITIES SHALL BE ALLOWED WITHOUT CONSENT OF THE OWNER. THE CONTRACTOR SHALL NOTIFY THE OWNER AND ARCHITECT A MINIMUM OF FOUR WORKING DAYS PRIOR TO THE REQUESTED SHUT-DOWN.
 14. CONTRACTOR SHALL PROVIDE TEMPORARY UTILITY SERVICE IF DAMAGED THROUGHOUT THE COURSE OF CONSTRUCTION.
 15. ALL EXCAVATIONS SHALL BE COVERED WITH CONCRETE OR COMPACTED TO THE STANDARD PROCTOR.
 16. ALL EXCAVATIONS SHALL BE COVERED WITH CONCRETE OR COMPACTED TO THE STANDARD PROCTOR.

TEMPORARY EROSION CONTROL:
 THE CONTRACTOR SHALL BE RESPONSIBLE FOR THE CONSTRUCTION OF ALL EROSION CONTROL MEASURES AND STRUCTURES IN ACCORDANCE WITH THE CITY OF OKLAHOMA DEPARTMENT OF PUBLIC WORKS AND SAFETY. ALL EROSION CONTROL MEASURES SHALL BE DONE IN STRICT ACCORDANCE WITH THE STANDARD SPECIFICATIONS FOR EROSION CONTROL MEASURES AND STRUCTURES.

EROSION CONTROL NOTES:
 ALL EROSION CONTROL MEASURES SHALL BE DONE IN STRICT ACCORDANCE WITH THE STANDARD SPECIFICATIONS FOR EROSION CONTROL MEASURES AND STRUCTURES.

BENCHMARK NOTES:
 ALL BENCHMARKS SHALL BE IN ACCORDANCE WITH THE STANDARD SPECIFICATIONS FOR BENCHMARKS.

DEMOLITION NOTES:
 1. ALL CONCRETE AND MORTAR NOTES FOR REMOVAL SHALL BE SHOWN WITH CUT-FILL DEPTH AND REMOVAL POINTS.
 2. CONTRACTOR SHALL PROTECT ALL SURVEY CONTROL POINTS.
 3. CONTRACTOR SHALL REMOVE ALL WASTE MATERIALS FROM SITE.
 4. ALL EXISTING STRUCTURES, UTILITIES, AND OTHER ITEMS TO BE REMOVED OR DEMOLISHED SHALL BE REMOVED OR DEMOLISHED IN ACCORDANCE WITH THE CITY OF OKLAHOMA DEPARTMENT OF PUBLIC WORKS AND SAFETY.
 5. WITH PRIOR APPROVAL, CONTRACTOR MAY ESTABLISH AN EXISTING REMOVAL STAGING AREA AT THE CONSTRUCTION SITE.
 6. CONTRACTOR SHALL BE RESPONSIBLE FOR PROTECTING REMOVAL STAGING AREA FROM CONSTRUCTION EQUIPMENT AND MATERIALS.
 7. CONTRACTOR SHALL BE RESPONSIBLE FOR PROTECTING REMOVAL STAGING AREA FROM CONSTRUCTION EQUIPMENT AND MATERIALS.
 8. CONTRACTOR SHALL PROTECT ALL ABOVE GROUND UTILITIES, EXISTING STRUCTURES, AND OTHER ITEMS TO BE REMOVED OR DEMOLISHED.
 9. CONTRACTOR SHALL BE RESPONSIBLE FOR PROTECTING REMOVAL STAGING AREA FROM CONSTRUCTION EQUIPMENT AND MATERIALS.
 10. CONTRACTOR SHALL BE RESPONSIBLE FOR PROTECTING REMOVAL STAGING AREA FROM CONSTRUCTION EQUIPMENT AND MATERIALS.
 11. CONTRACTOR SHALL BE RESPONSIBLE FOR ALL TRAFFIC CONTROL DURING CONSTRUCTION WORK. ALL TRAFFIC CONTROL SHALL BE IN ACCORDANCE WITH THE CITY OF OKLAHOMA DEPARTMENT OF PUBLIC WORKS AND SAFETY.
 12. UTILITIES DISCONNECTED FROM TO ANY DEMOLITION SHALL BE RECONNECTED OR RELOCATED.
 13. NO UTILITIES SHALL BE ALLOWED WITHOUT CONSENT OF THE OWNER. THE CONTRACTOR SHALL NOTIFY THE OWNER AND ARCHITECT A MINIMUM OF FOUR WORKING DAYS PRIOR TO THE REQUESTED SHUT-DOWN.
 14. CONTRACTOR SHALL PROVIDE TEMPORARY UTILITY SERVICE IF DAMAGED THROUGHOUT THE COURSE OF CONSTRUCTION.
 15. ALL EXCAVATIONS SHALL BE COVERED WITH CONCRETE OR COMPACTED TO THE STANDARD PROCTOR.
 16. ALL EXCAVATIONS SHALL BE COVERED WITH CONCRETE OR COMPACTED TO THE STANDARD PROCTOR.

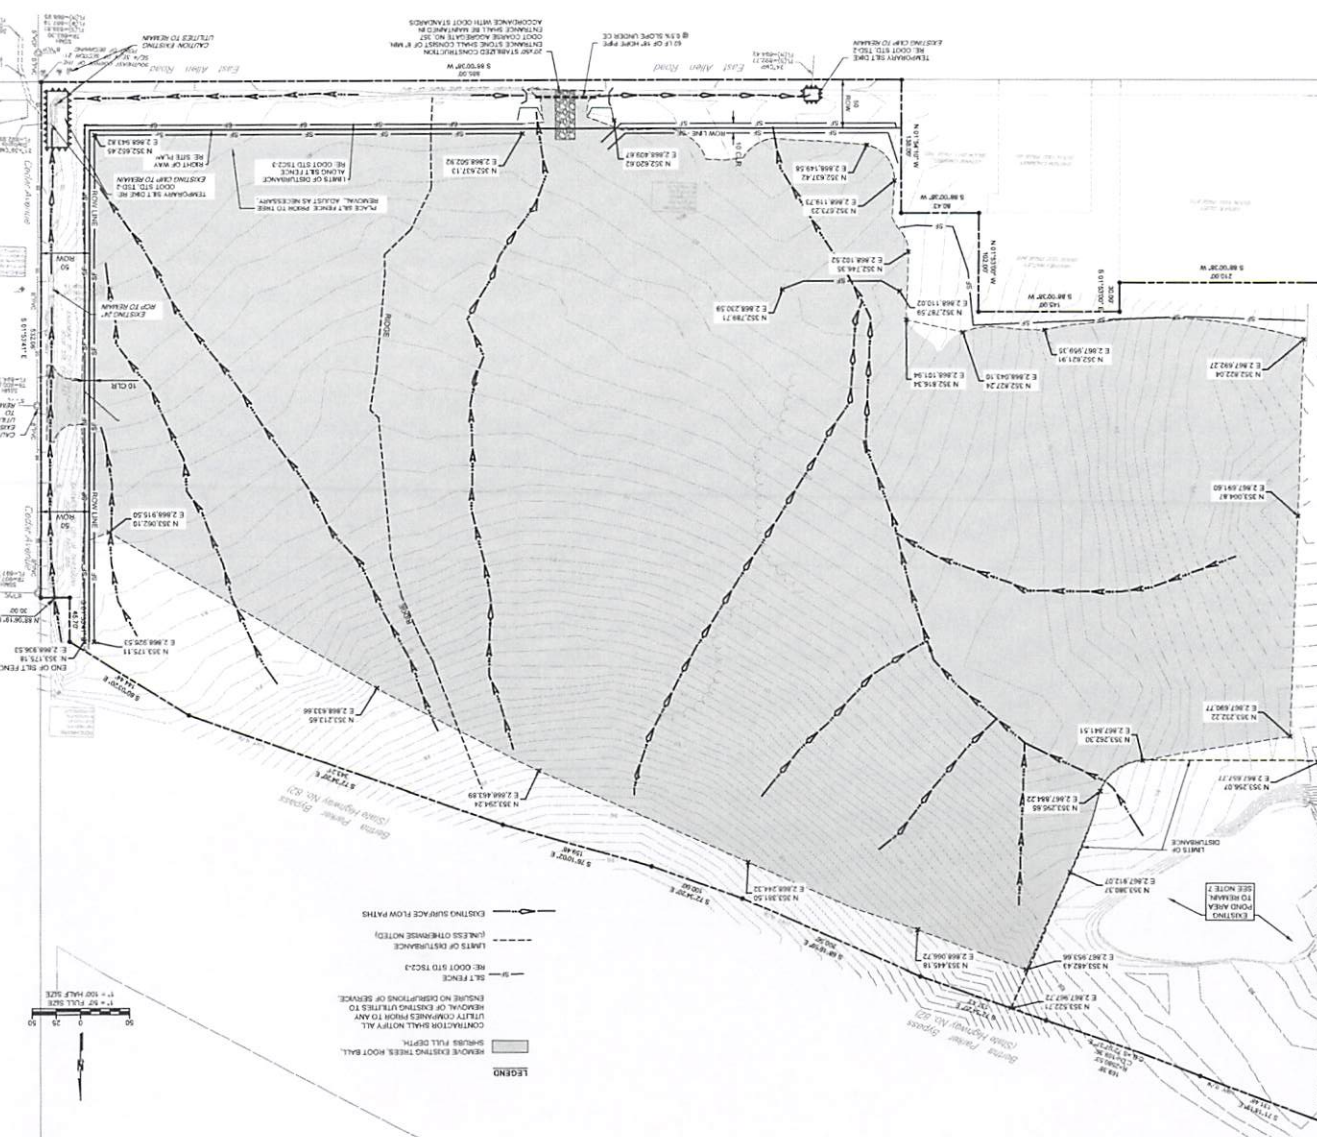

EROSION CONTROL PLAN
 PROJECT NO. 220231
 DATE: 10/11/2022
 DRAWN BY: [Name]
 CHECKED BY: [Name]
 APPROVED BY: [Name]

CONSTRUCTION DOCUMENTS
 220231
 10/11/2022


blue river ARCHITECTS
 1000 N. W. 100th Ave., Suite 100
 Oklahoma City, Oklahoma 73127
 Phone: (405) 555-1234
 Fax: (405) 555-5678
 Website: www.blueriverarchitects.com

CHEROKEE HOUSING
TAHALEQUAH OKLAHOMA

blue river ARCHITECTS
 1000 N. W. 100th Ave., Suite 100
 Oklahoma City, Oklahoma 73127
 Phone: (405) 555-1234
 Fax: (405) 555-5678
 Website: www.blueriverarchitects.com


INTERIM REVIEW ONLY

blue river ARCHITECTS
 1000 N. W. 100th Ave., Suite 100
 Oklahoma City, Oklahoma 73127
 Phone: (405) 555-1234
 Fax: (405) 555-5678
 Website: www.blueriverarchitects.com

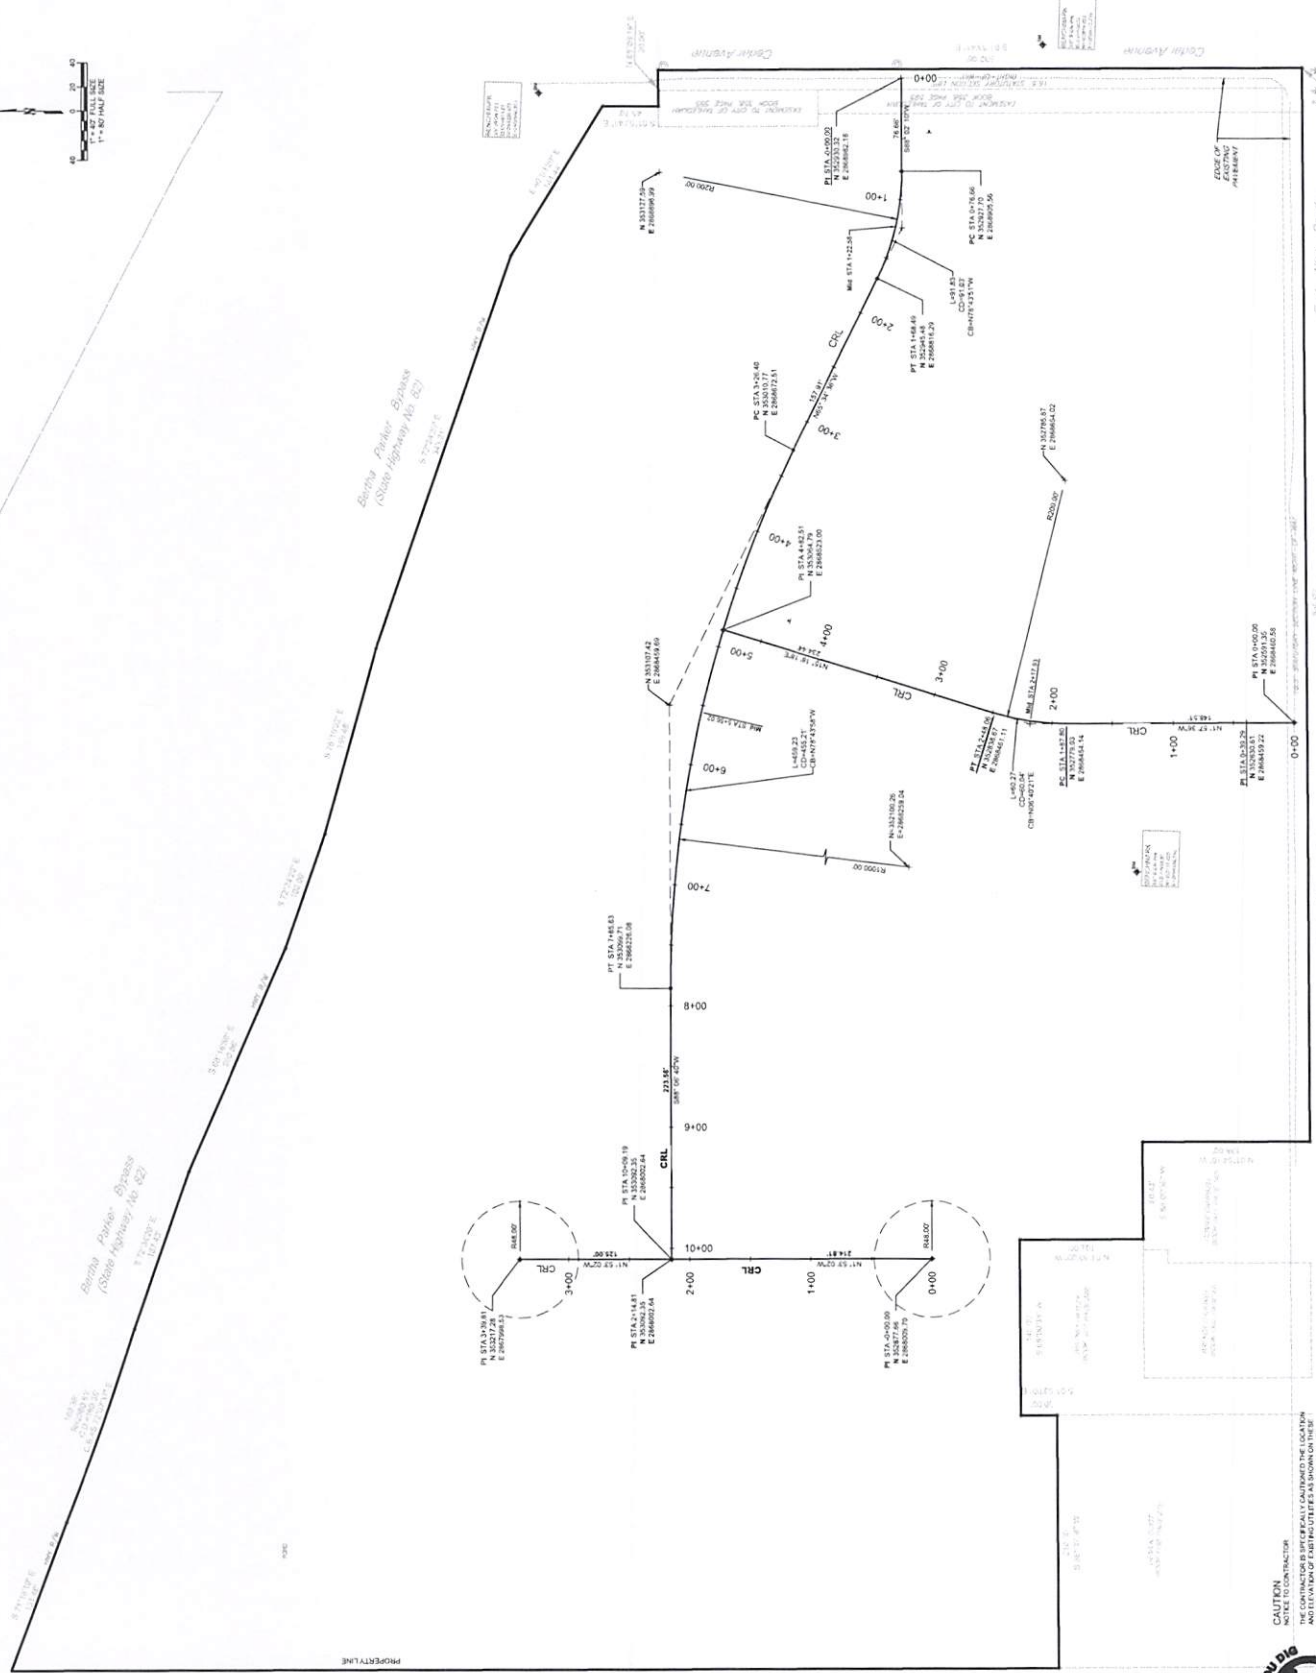

CAUTION
CONTRACTOR
THE CONTRACTOR IS SPECIFICALLY CAUTIONED THE LOCATION AND UTILITY DATA OF UTILITIES SHOWN ON THIS PLAN IS FOR INFORMATION ONLY. THE CONTRACTOR SHALL VERIFY THE LOCATION AND DEPTH OF ALL UTILITIES PRIOR TO CONSTRUCTION. THE CONTRACTOR SHALL CALL THE LOCAL UTILITY COMPANIES TO OBTAIN THE MOST CURRENT UTILITY DATA. THE CONTRACTOR SHALL CALL THE LOCAL UTILITY COMPANIES TO OBTAIN THE MOST CURRENT UTILITY DATA TO PREVENT DAMAGE TO UTILITIES.




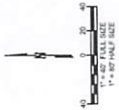

- GENERAL GRADING NOTES**
1. ALL GRADING SHALL NOT EXCEED DATE, PROPOSED CONTROL MEASURES SHALL BE SHOWN ON THE GRADING PLAN.
 2. ALL CUT OR FILL SLOPES SHALL BE AT OR FLATTER UNLESS OTHERWISE NOTED.
 3. ALL CUTS SHALL BE PROTECTED AGAINST EROSION BY PROPOSED MEASURES AND STRUCTURED FOR ALL GRASSES AND PAVED AREAS.
 4. CONSTRUCTION SHALL COMPLY WITH ALL APPLICABLE CONTROLLING CODES AND ORDINANCES.
 5. CONTRACTOR IS RESPONSIBLE FOR TEMPORARY ACCESS ROADS AND SHALL MAINTAIN ACCESS TO ALL ADJACENT PROPERTIES AT ALL TIMES. TEMPORARY ACCESS ROADS SHALL BE REPAIRED AND SHALL BE INCLUDED IN THE SCOPES OF WORK.
 6. ALL SECTIONS AND MAPS TO HAVE MAXIMUM LONGITUDINAL SLOPE OF 5% UNLESS OTHERWISE NOTED.
 7. EXISTING DAMAGE TO STRUCTURES TO BE PROTECTED AND REPAIRED AS NECESSARY.
 8. ALL EXISTING STRUCTURES TO REMAIN ARE CHANGED DURING CONSTRUCTION SHALL BE REPAIRED AND SHALL BE INCLUDED IN THE SCOPES OF WORK.
 9. ALL STORM PIPES ENTERING STRUCTURES SHALL BE GRANTED TO ASSURE CONNECTION AT STRUCTURE (IF NOT EXISTING).


NOTE:
FOR STORM SEWER REFER TO SHEETS C500A
FOR DRIVEWAY REFER TO ROAD

- BENCHMARK NOTES**
- BENCHMARK 1: BENCH MARK 1
 - BENCHMARK 2: BENCH MARK 2
 - BENCHMARK 3: BENCH MARK 3
 - BENCHMARK 4: BENCH MARK 4
 - BENCHMARK 5: BENCH MARK 5
 - BENCHMARK 6: BENCH MARK 6
 - BENCHMARK 7: BENCH MARK 7
 - BENCHMARK 8: BENCH MARK 8
 - BENCHMARK 9: BENCH MARK 9
 - BENCHMARK 10: BENCH MARK 10
 - BENCHMARK 11: BENCH MARK 11
 - BENCHMARK 12: BENCH MARK 12
 - BENCHMARK 13: BENCH MARK 13
 - BENCHMARK 14: BENCH MARK 14
 - BENCHMARK 15: BENCH MARK 15
 - BENCHMARK 16: BENCH MARK 16
 - BENCHMARK 17: BENCH MARK 17
 - BENCHMARK 18: BENCH MARK 18
 - BENCHMARK 19: BENCH MARK 19
 - BENCHMARK 20: BENCH MARK 20

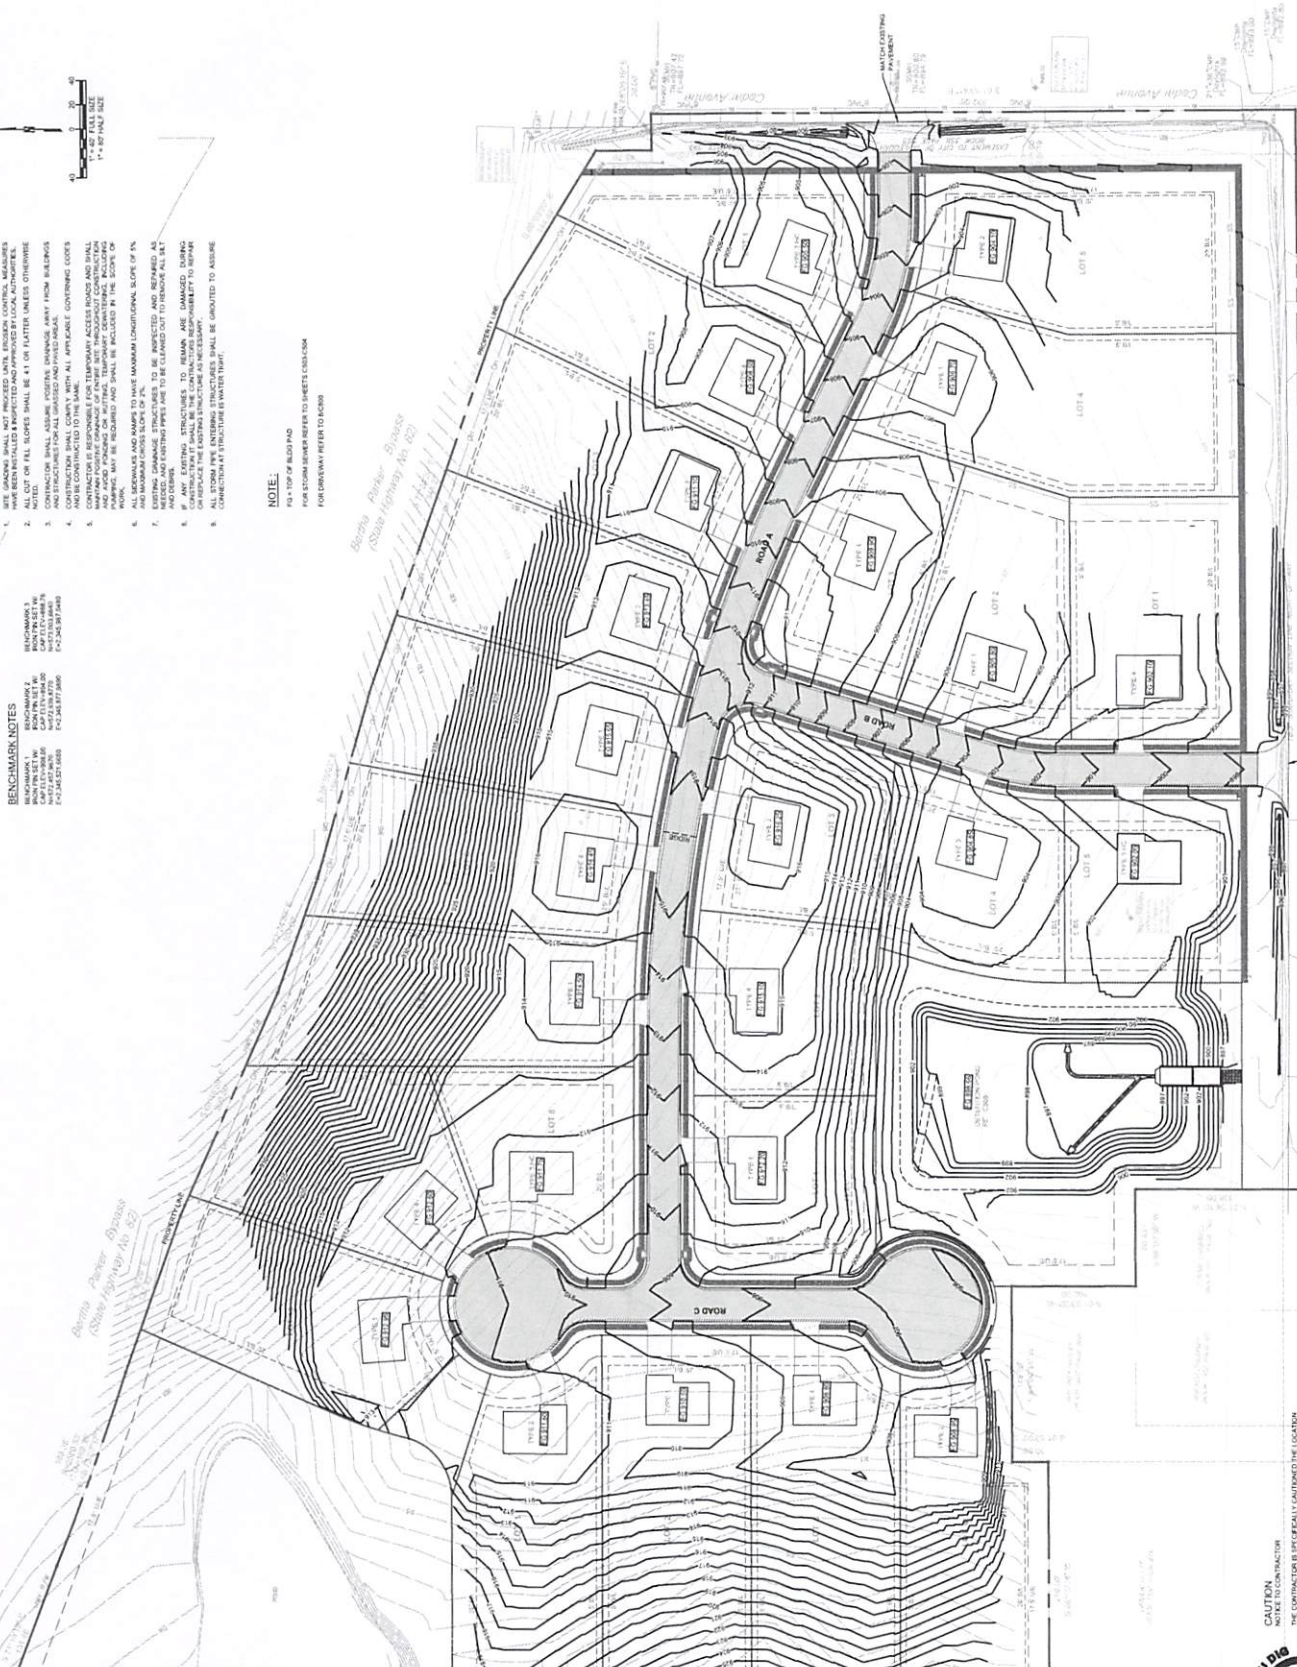

CAUTION:
NOTICE TO CONTRACTOR
THE CONTRACTOR IS SPECIFICALLY CAUTIONED THE LOCATION
AND DEPTH OF ALL UTILITIES SHOWN ON THIS PLAN ARE BASED ON RECORD DRAWINGS AND FIELD SURVEY DATA.
IT IS THE CONTRACTOR'S RESPONSIBILITY TO VERIFY THE LOCATION
AND DEPTH OF ALL UTILITIES PRIOR TO CONSTRUCTION.
THE CONTRACTOR SHALL BE RESPONSIBLE FOR OBTAINING ALL NECESSARY
PERMITS AND APPROVALS FROM THE LOCAL UTILITY COMPANIES.
TO PROTECT EXISTING UTILITIES, THE CONTRACTOR SHALL BE REQUIRED TO
INSTALL PROTECTIVE CASING AT ALL CROSSING POINTS AND TO MAINTAIN
THE EXACT LOCATION OF ALL UTILITIES.



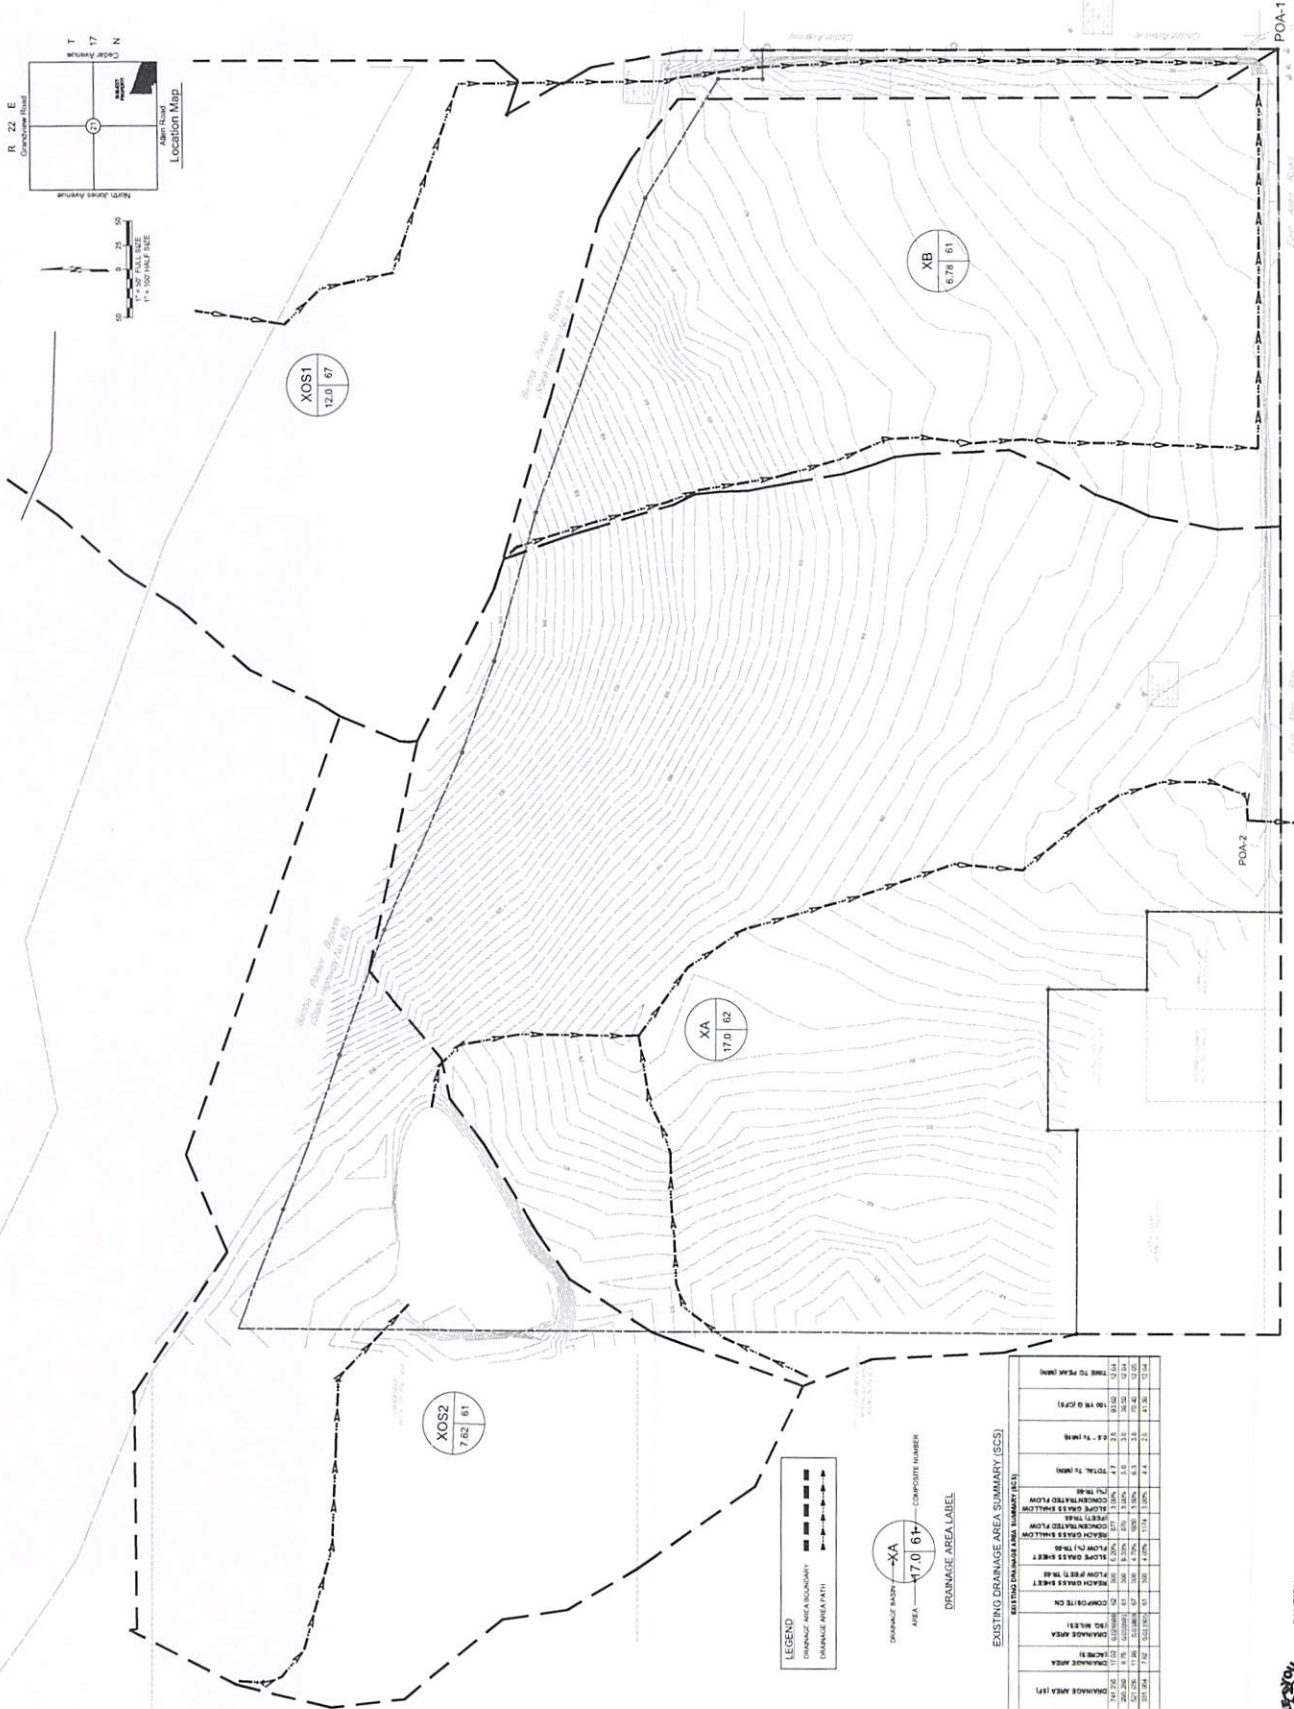


EXISTING DRAINAGE AREA SUMMARY (SCS)


DRAINAGE AREA (A)	AREA (ACRES)	PERCENT IMPERVIOUS	COEFFICIENT OF RUNOFF (C)	CONCENTRATION TIME (MIN)	TIME TO PEAK (MIN)
DRAINAGE AREA (A1)	17.0	15.0%	0.5	15	30
DRAINAGE AREA (A2)	7.62	15.0%	0.5	15	30
DRAINAGE AREA (A3)	12.0	15.0%	0.5	15	30
DRAINAGE AREA (A4)	6.76	15.0%	0.5	15	30
TOTAL	43.38	15.0%	0.5	15	30

CAUTION
THE CONTRACTOR IS SPECIFICALLY CAUTIONED THE LOCATION OF UTILITIES SHOWN ON THIS PLAN IS BASED ON RECORD DRAWINGS AND FIELD SURVEY DATA. THE CONTRACTOR SHALL BE RESPONSIBLE FOR VERIFYING THE LOCATION OF UTILITIES PRIOR TO CONSTRUCTION. ANY DAMAGE TO UTILITIES SHALL BE THE RESPONSIBILITY OF THE CONTRACTOR.

DRAINAGE AREA: XA 17.0 AC, XB 6.76 AC, XOS1 12.0 AC, XOS2 7.62 AC

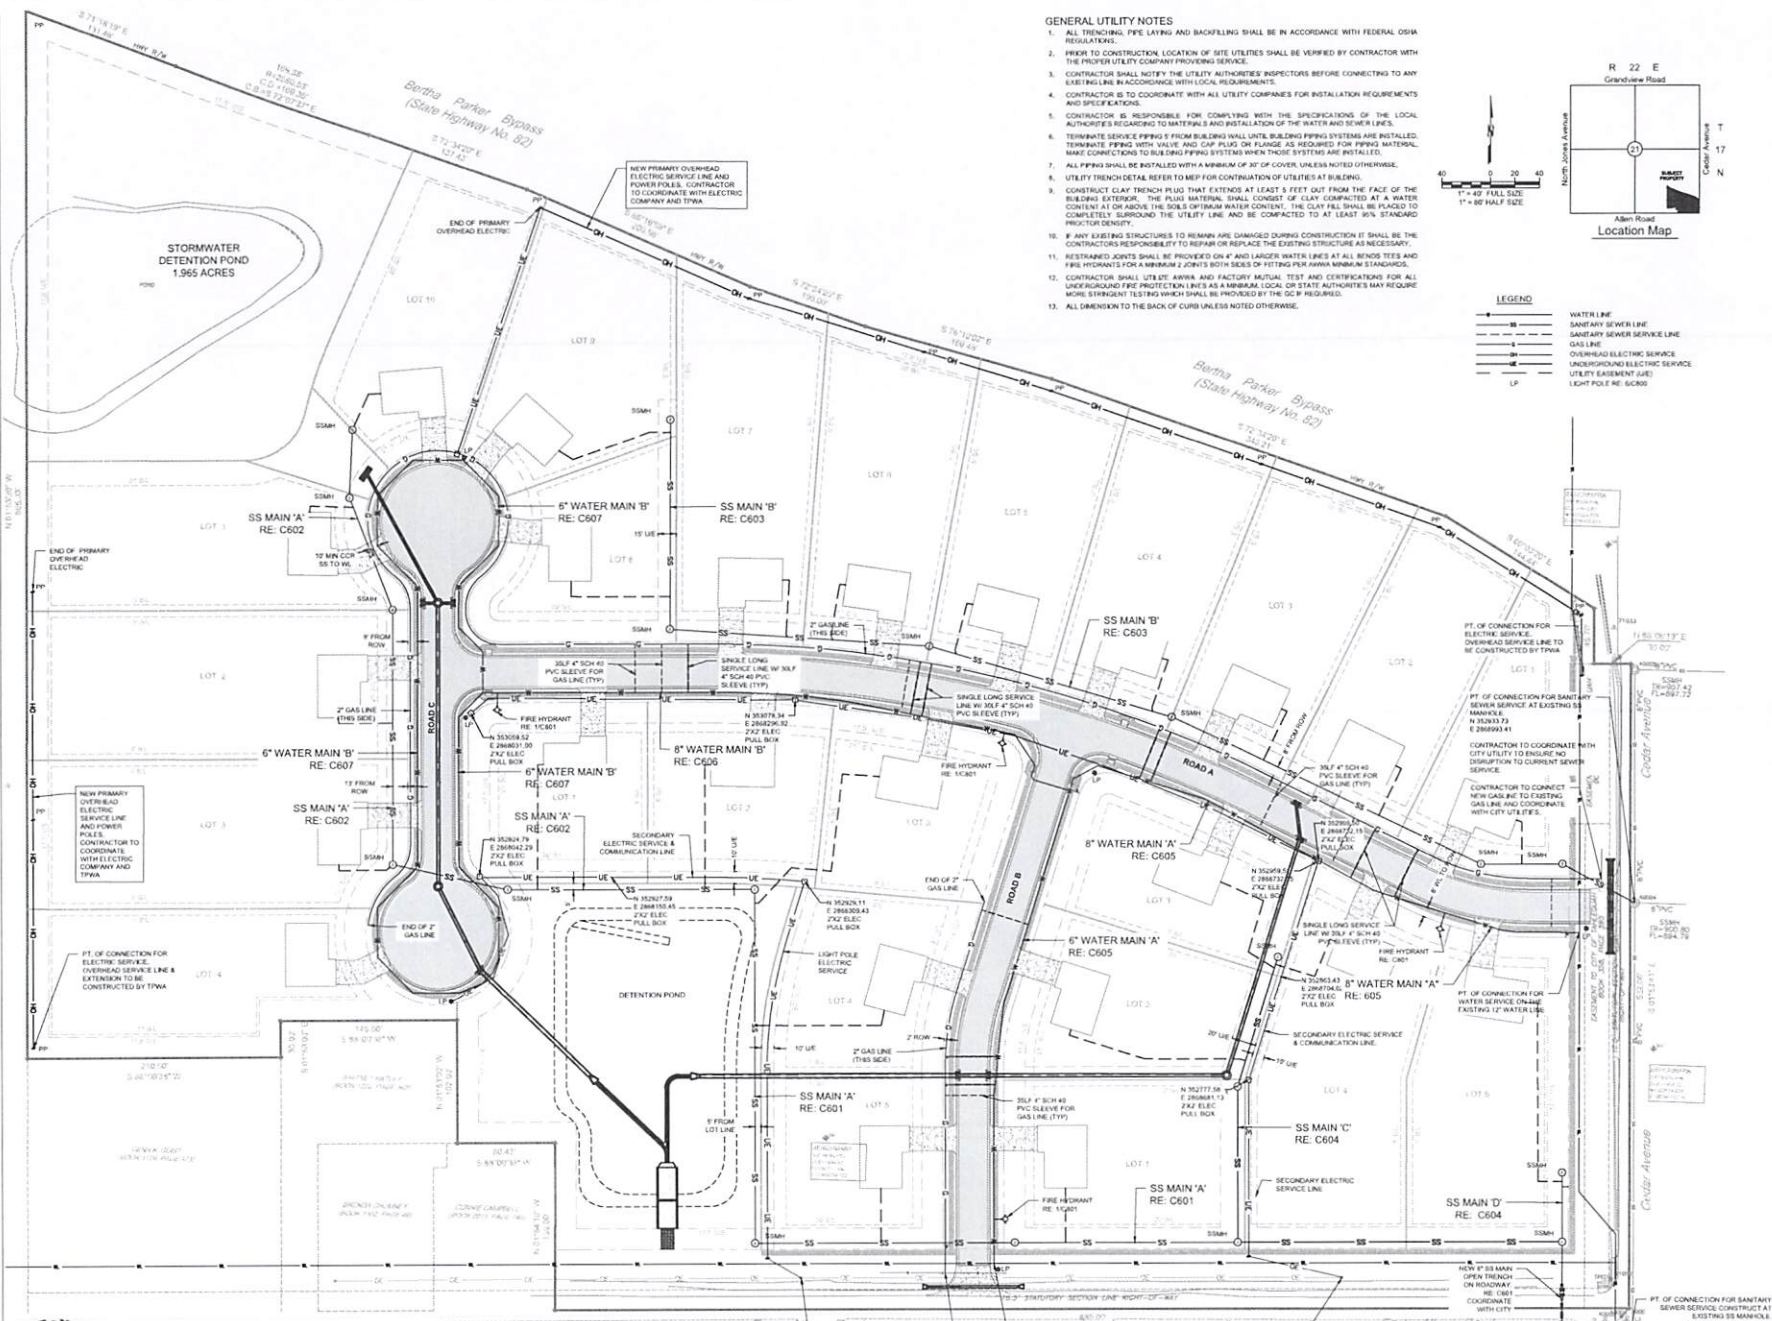

- GENERAL UTILITY NOTES**
1. ALL TRENCHING, PIPE LAYING AND BACKFILLING SHALL BE IN ACCORDANCE WITH FEDERAL OSHA REGULATIONS.
 2. PRIOR TO CONSTRUCTION, LOCATION OF SITE UTILITIES SHALL BE VERIFIED BY CONTRACTOR WITH THE PROPER UTILITY COMPANY PROVIDING SERVICE.
 3. CONTRACTOR SHALL NOTIFY THE UTILITY AUTHORITIES INSPECTORS BEFORE CONNECTING TO ANY EXISTING LINE IN ACCORDANCE WITH LOCAL REQUIREMENTS.
 4. CONTRACTOR IS TO COORDINATE WITH ALL UTILITY COMPANIES FOR INSTALLATION REQUIREMENTS AND SPECIFICATIONS.
 5. CONTRACTOR IS RESPONSIBLE FOR COMPLYING WITH THE SPECIFICATIONS OF THE LOCAL AUTHORITIES REGARDING TO MATERIALS AND INSTALLATION OF THE WATER AND SEWER LINES.
 6. TERMINATE SERVICE PIPING FROM BUILDING WALL UNTIL BUILDING PIPING SYSTEMS ARE INSTALLED. TERMINATE PIPING WITH VALVE AND CAP PLUG OR FLANGE AS REQUIRED FOR PIPING MATERIAL. MAKE CONNECTIONS TO BUILDING PIPING SYSTEMS WHEN THOSE SYSTEMS ARE INSTALLED.
 7. ALL PIPING SHALL BE INSTALLED WITH A MINIMUM OF 30" OF COVER UNLESS NOTED OTHERWISE.
 8. UTILITY TRENCH DETAIL REFER TO MEP FOR CONTINUATION OF UTILITIES AT BUILDING.
 9. CONSTRUCT CLAY TRENCH PLUG THAT EXTENDS AT LEAST 5 FEET OUT FROM THE FACE OF THE BUILDING EXTERIOR. THE PLUG MATERIAL SHALL CONSIST OF CLAY COMPACTED AT A WATER CONTENT AT 10% ABOVE THE SOILS OPTIMUM WATER CONTENT. THE CLAY FILL SHALL BE PLACED TO COMPLETELY SURROUND THE UTILITY LINE AND BE COMPACTED TO AT LEAST 95% STANDING PROCTOR DENSITY.
 10. IF ANY EXISTING STRUCTURES TO REMAIN ARE DAMAGED DURING CONSTRUCTION IT SHALL BE THE CONTRACTORS RESPONSIBILITY TO REPAIR OR REPLACE THE EXISTING STRUCTURE AS NECESSARY.
 11. RESTRAINED JOINTS SHALL BE PROVIDED ON 4" AND LARGER WATER LINES AT ALL BENDS TIES AND FIRE HYDRANTS FOR A MINIMUM 2 JOINTS BOTH SIDES OF FITTING FOR MINIMUM STANDARD.
 12. CONTRACTOR SHALL UTILIZE AWWA AND FACTORY MUTUAL TEST AND CERTIFICATIONS FOR ALL UNDERGROUND FIRE PROTECTION LINES AS A MINIMUM LOCAL OR STATE AUTHORITIES MAY REQUIRE MORE STRINGENT TESTING WHICH SHALL BE PROVIDED BY THE GC IF REQUIRED.
 13. ALL DIMENSION TO THE BACK OF CURB UNLESS NOTED OTHERWISE.

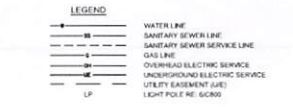

CAUTION
NOTICE TO CONTRACTOR

THE CONTRACTOR IS SPECIFICALLY CAUTIONED THE LOCATION AND ELEVATION OF EXISTING UTILITIES AS SHOWN ON THESE PLANS ARE BASED ON RECORDS OF THE VARIOUS UTILITY COMPANIES AND MEASUREMENTS TAKEN IN THE FIELD. THE INFORMATION IS NOT TO BE RELIED ON AS BEING EXACT OR COMPLETE. THE CONTRACTOR MUST CALL THE LOCAL UTILITY LOCATION CENTER AT LEAST 10 HOURS BEFORE ANY EXCAVATION TO REQUEST EXACT FIELD LOCATIONS OF THE UTILITIES.



INTERIM REVIEW ONLY

THIS DOCUMENT AND RECORDS ARE NOT TO BE USED FOR ANY PURPOSE OTHER THAN THAT FOR WHICH THEY WERE PREPARED.




**CHEROKEE HOUSING
TAHLEQUAH OKLAHOMA**




PROJECT NUMBER: 2240219
 DATE: 11/22/2022
 TITLE: 95% CONSTRUCTION DOCUMENTS
 OTHER SHEET: 047
UTILITY PLAN



C600

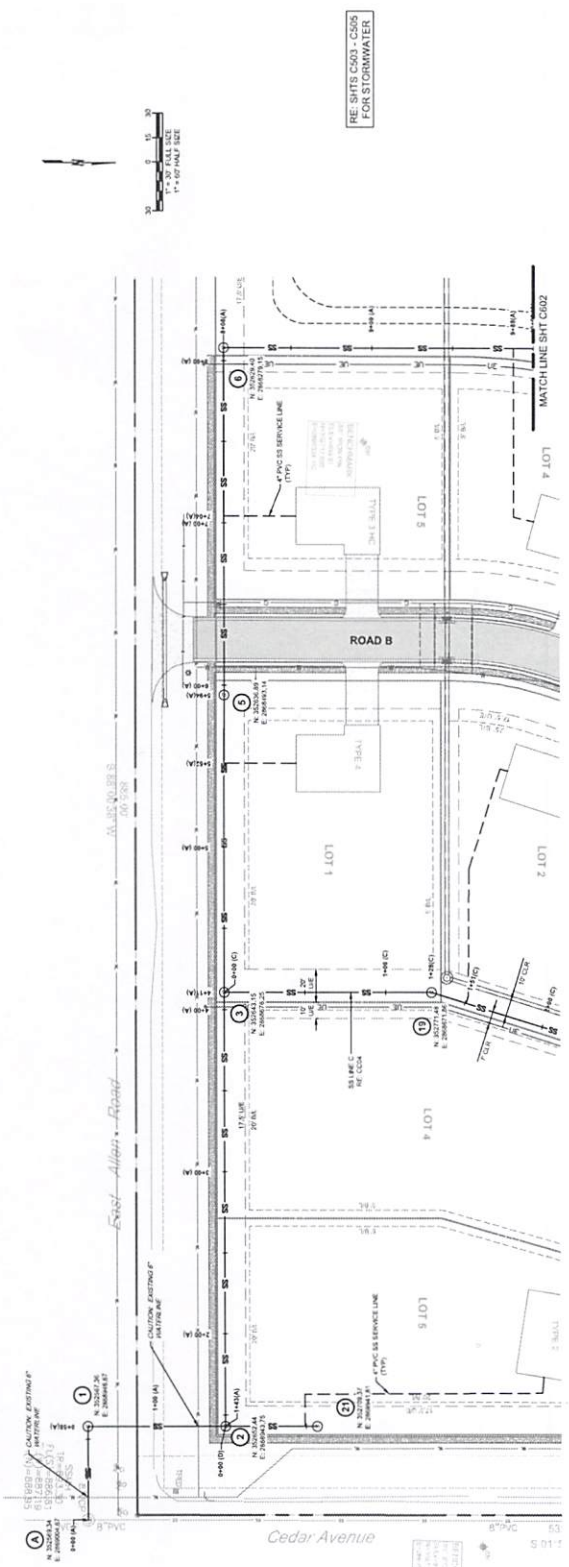

SANITARY SEWER PLAN
STA 3+00 THRU 10+00
SCALE 1"=20'

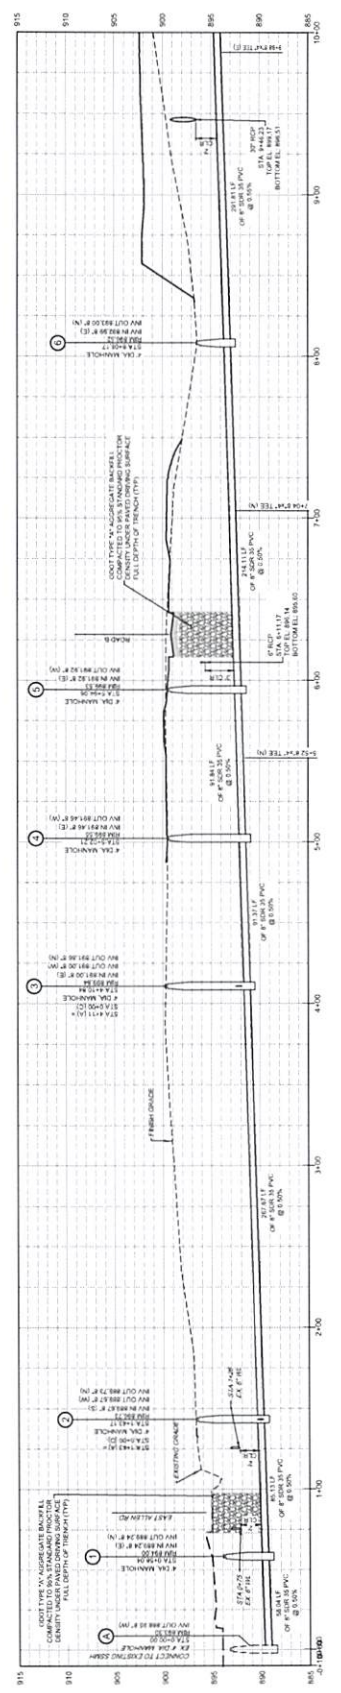

SANITARY SEWER 'A' PROFILE
STA 0+00 THRU 10+00
SCALE 1"=10' FULL SIZE

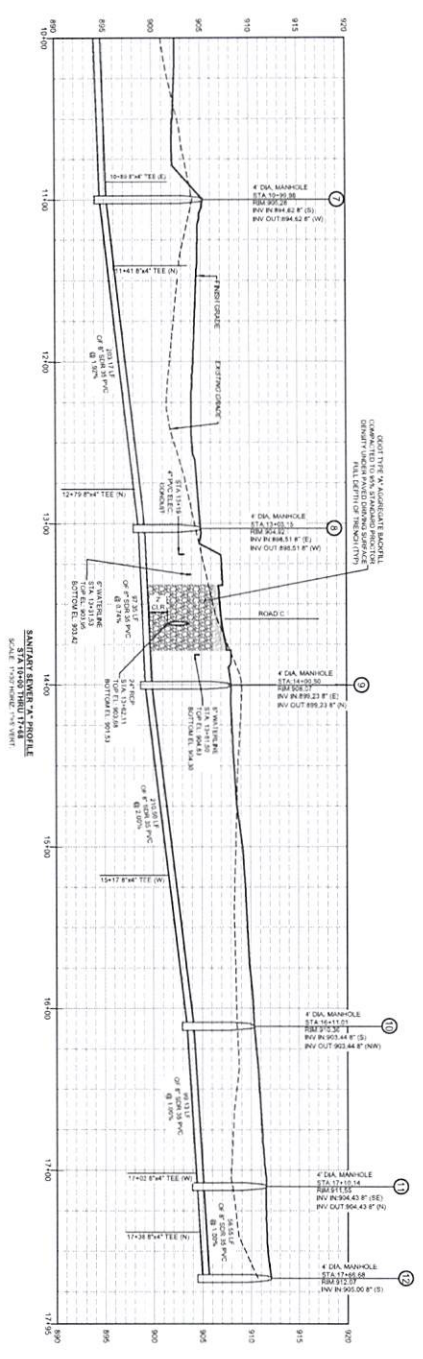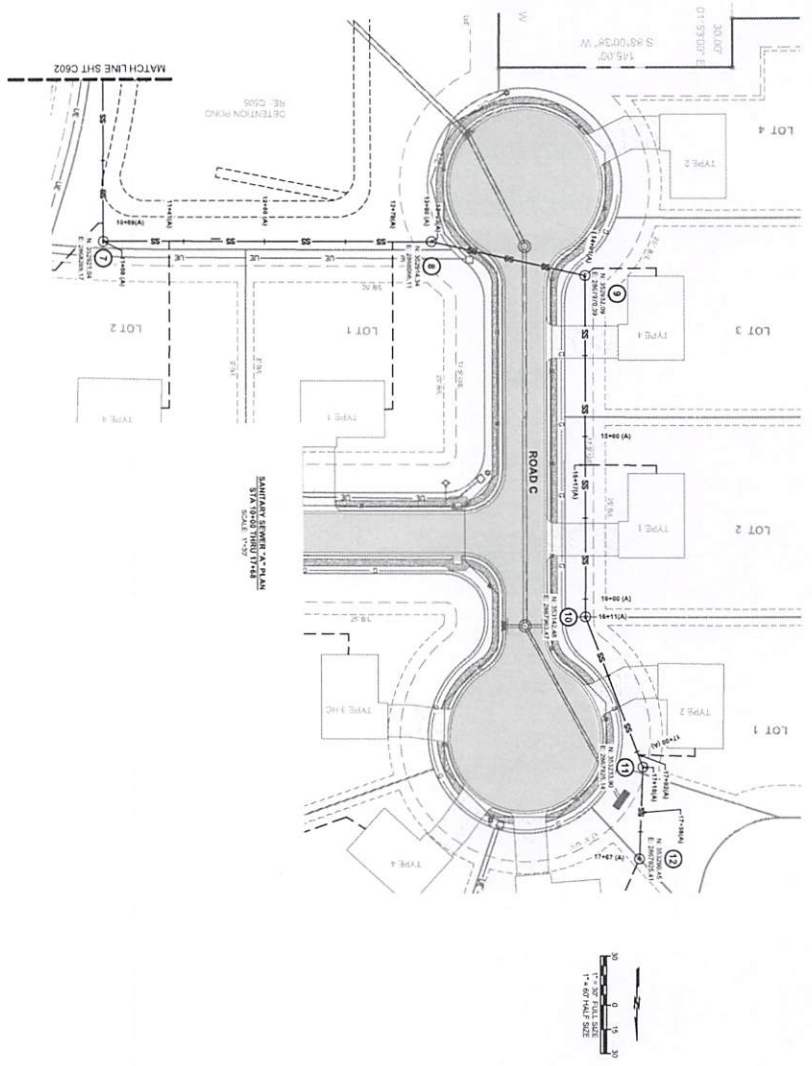


MANITARY SEWER SYSTEM
PLAN THROUGH PROFILE
SCALE: 1"=20' HORIZONTAL, 1"=2' VERTICAL




SANITARY SEWER - B' PROFILE
STA 0+00 THRU 10+12


SCALE: 1"=30' HORIZ. 1"=8' VERT.

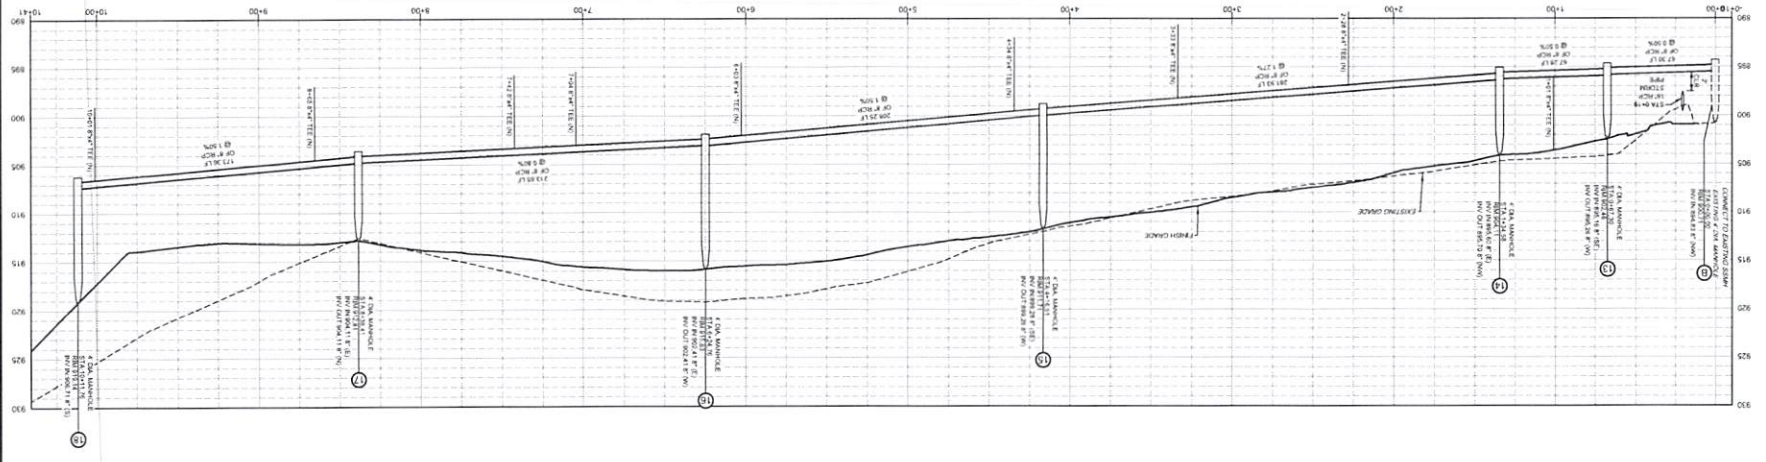


SANITARY SEWER - B' PLAN
STA 0+00 THRU 10+12

SCALE: 1"=30'

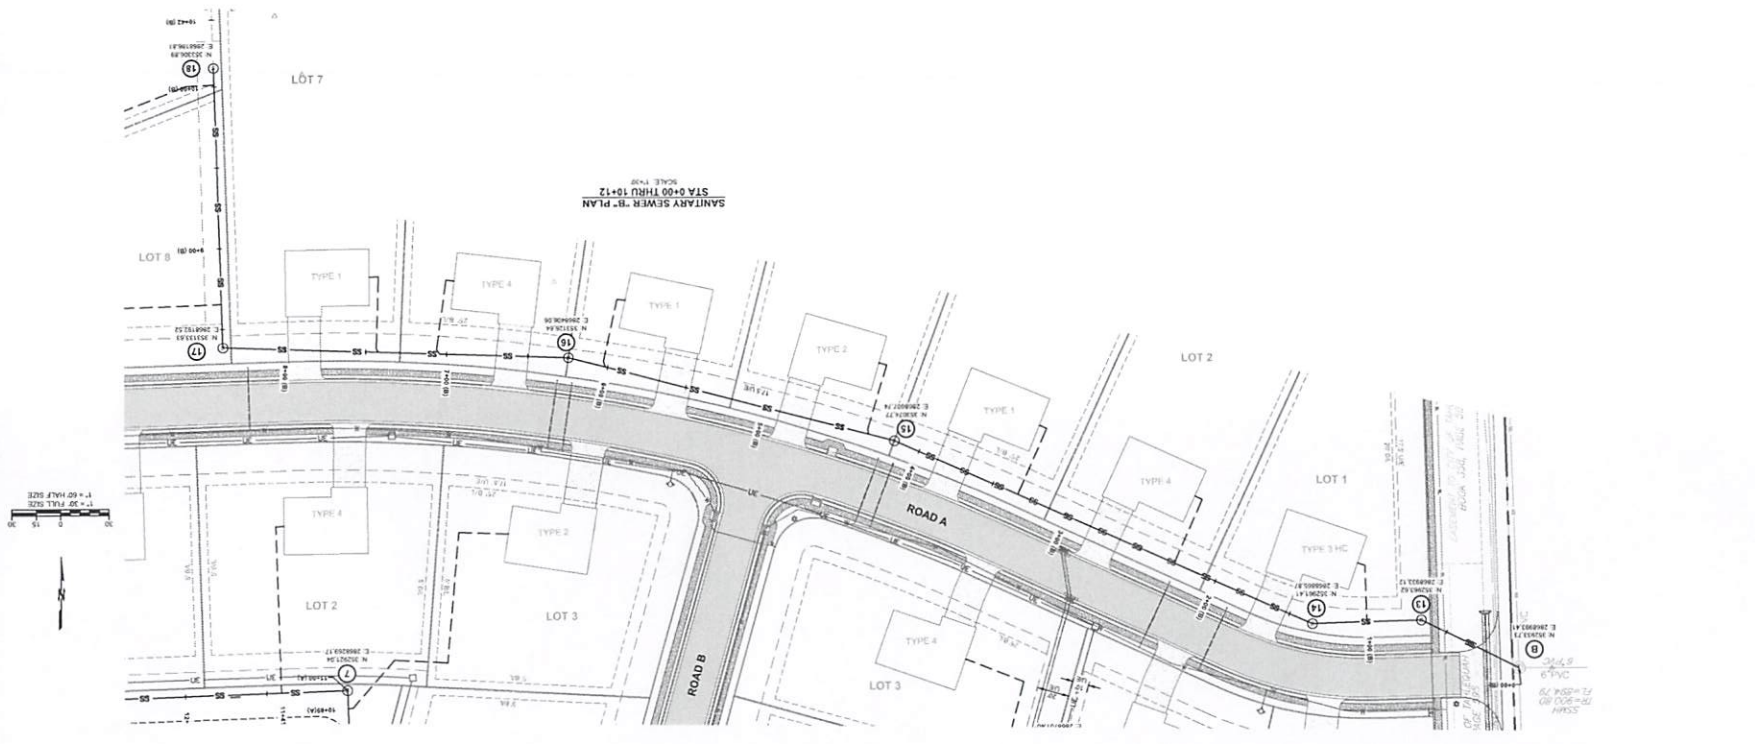


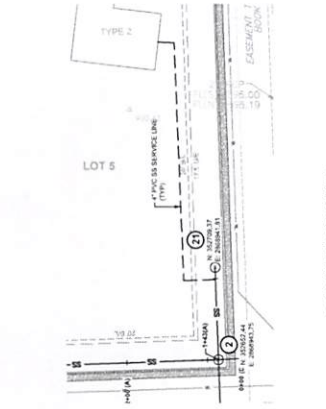


SANITARY SEWER "D" PLAN
STA 0+00 THRU 0+57
SCALE 1/8" = 1'-0"

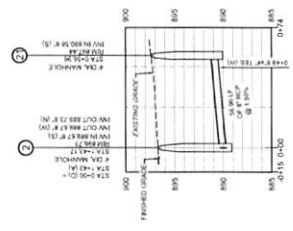




SANITARY SEWER "D" PROFILE
STA 0+00 THRU 0+57
SCALE 1/8" = 1'-0" (VERT.)

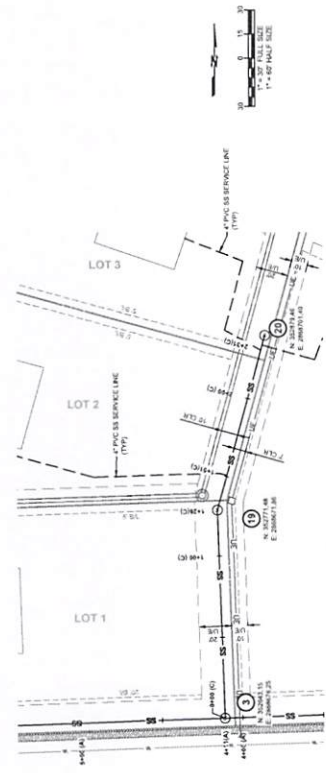

SANITARY SEWER "C" PLAN
STA 0+00 THRU 2+40
SCALE 1/8" = 1'-0"

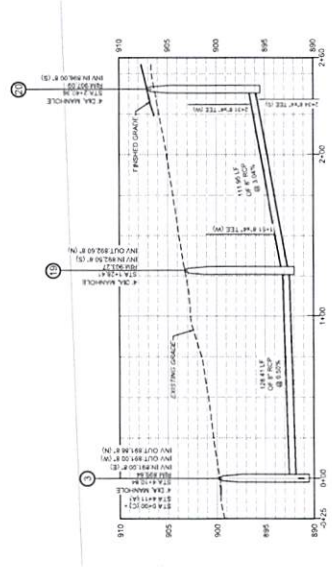

SANITARY SEWER "C" PROFILE
STA 0+00 THRU 2+40
SCALE 1/8" = 1'-0" (VERT.)

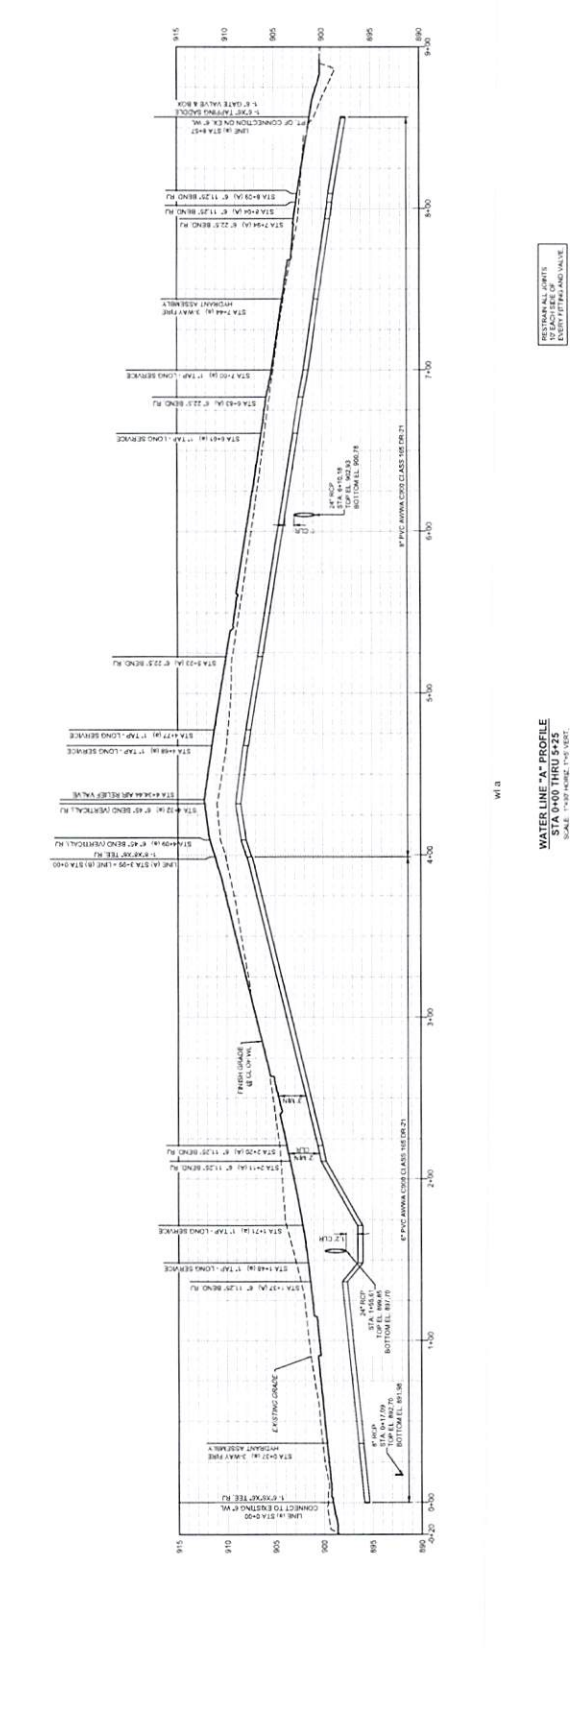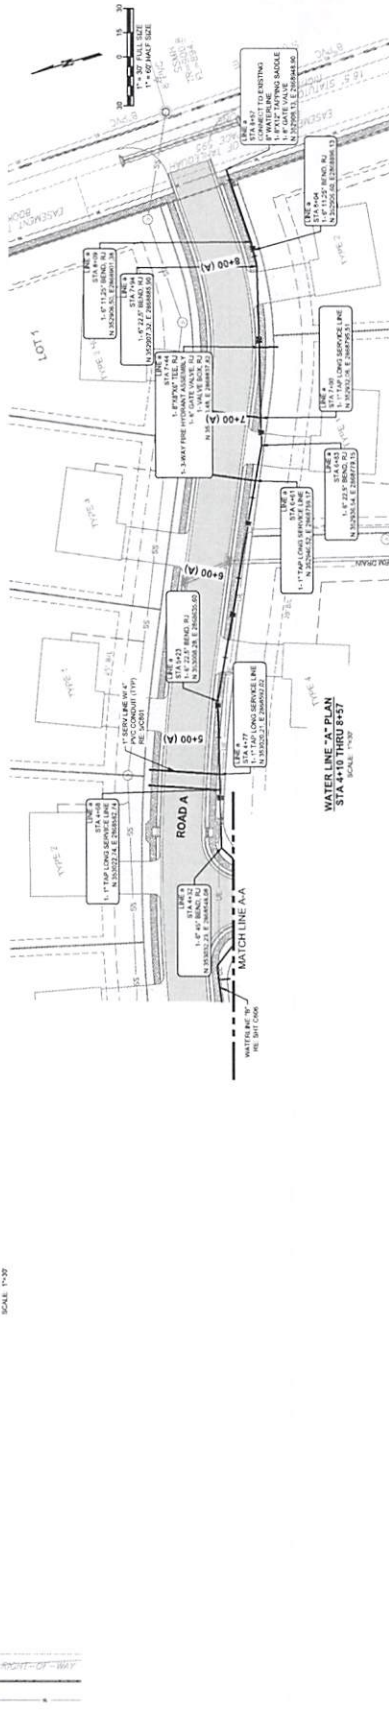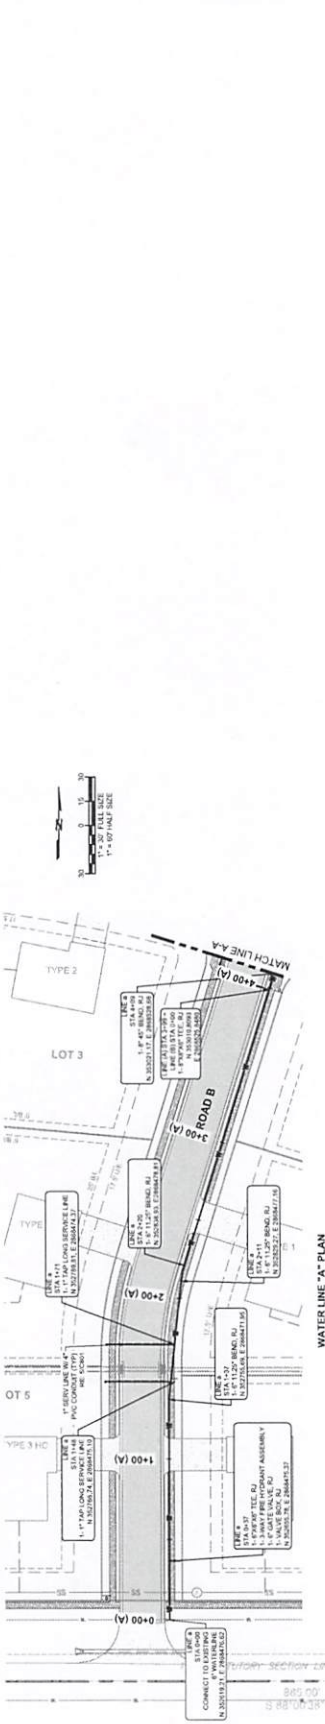


WATER LINE A PROFILE
 STA 4+10 THRU 8+25
 SCALE: 1"=10' VERTICAL, 1"=40' HORIZONTAL


W13

RESTRICTION: ALL DIMENSIONS SHALL BE TO CENTERLINE UNLESS OTHERWISE NOTED



REVISIONS SUBJECT TO REVISIONS OF THIS DRAWING.

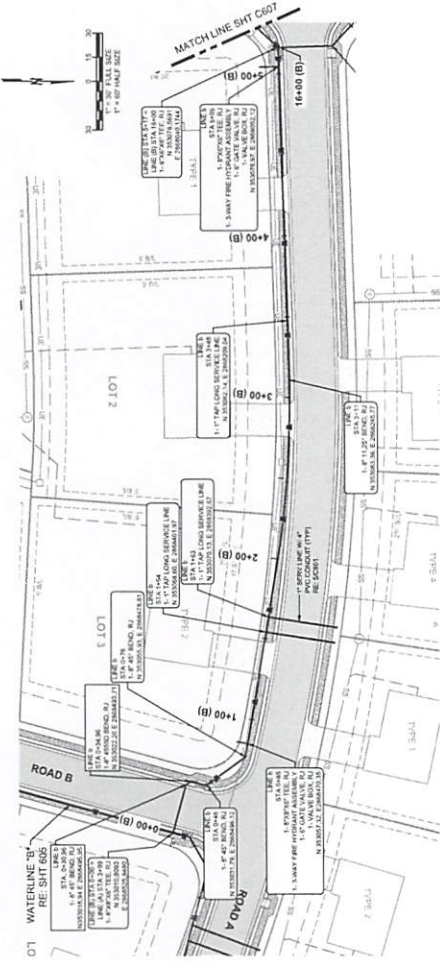


WATER LINE "B" PLAN
SCALE: 1"=40'

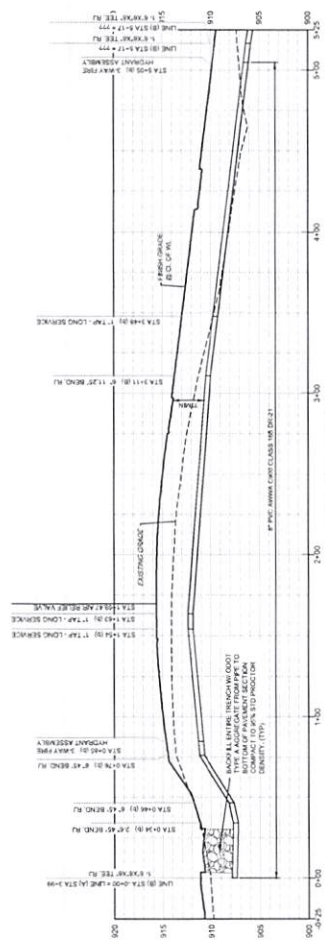

WATER LINE "B" PROFILE
SCALE: 1"=40' VERTICALLY, 1"=40' HORIZONTALLY

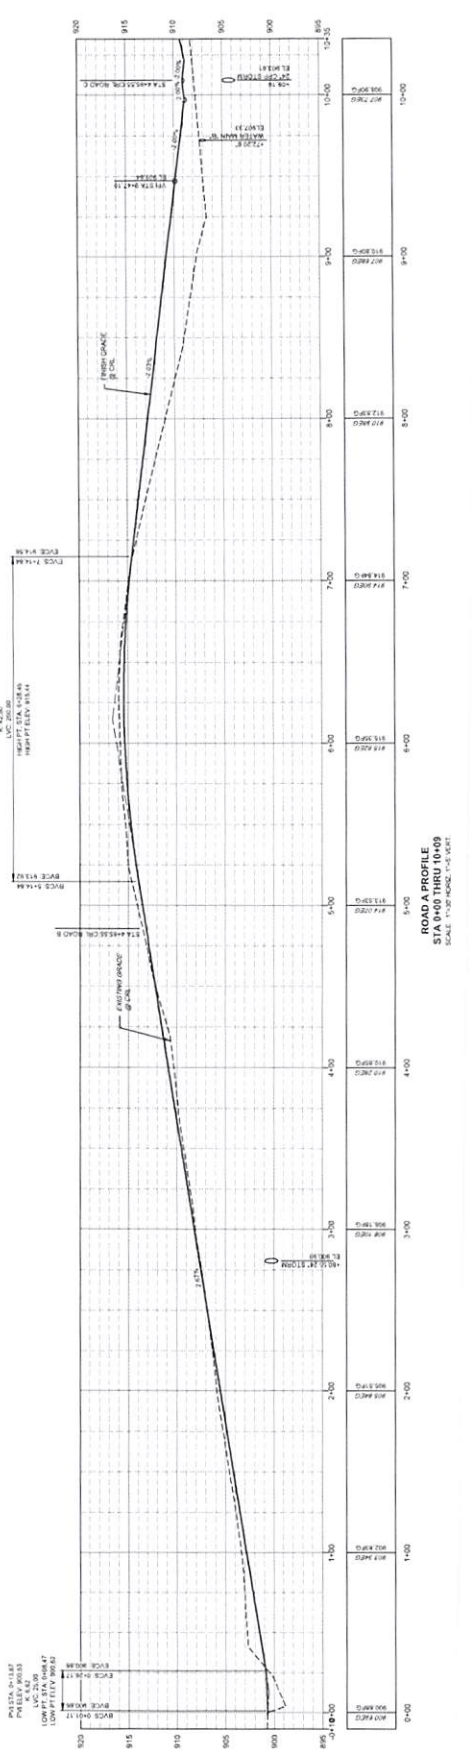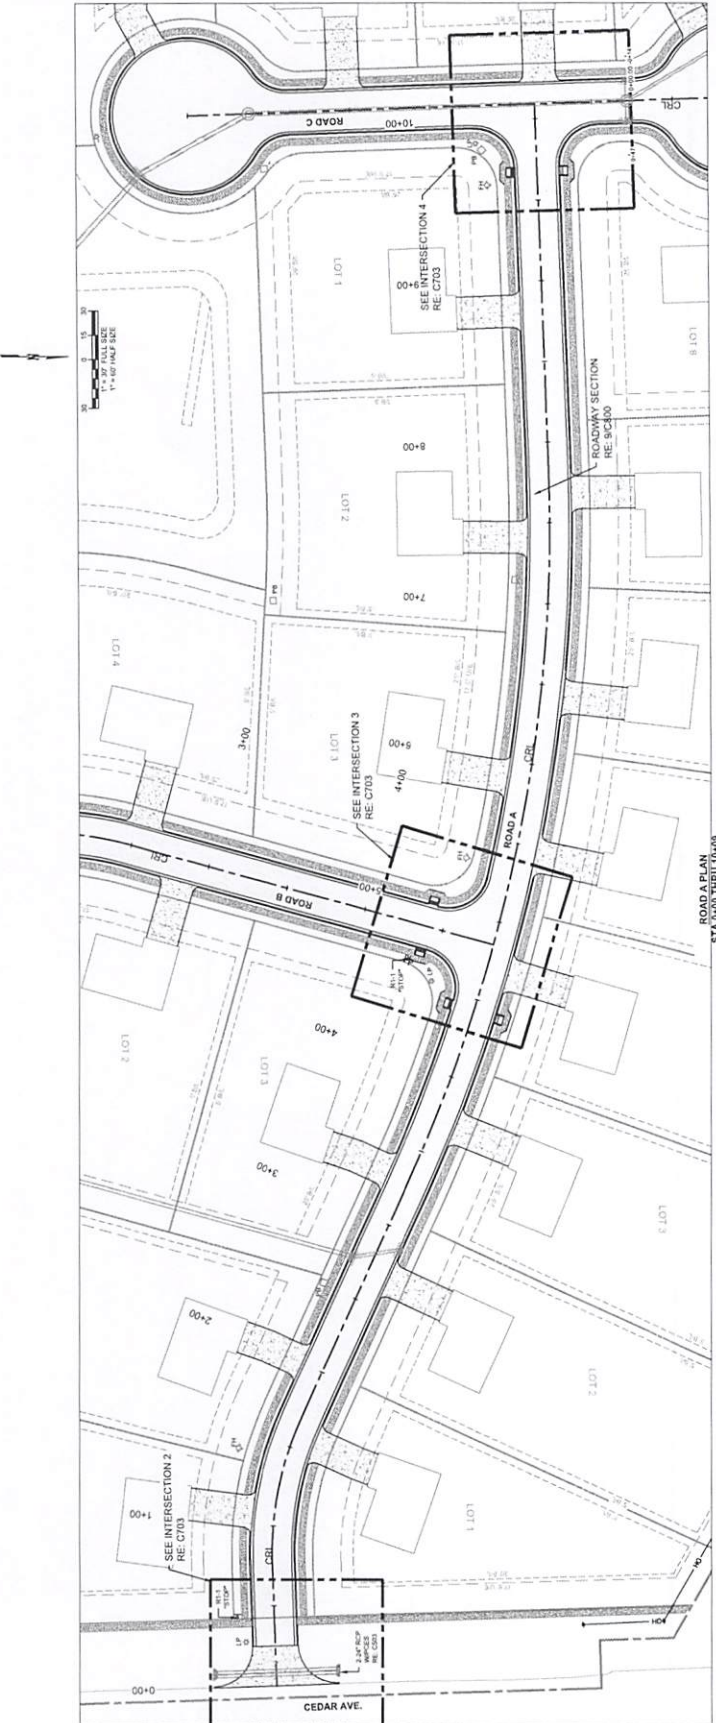


RECORD FOR GEOMETRICS

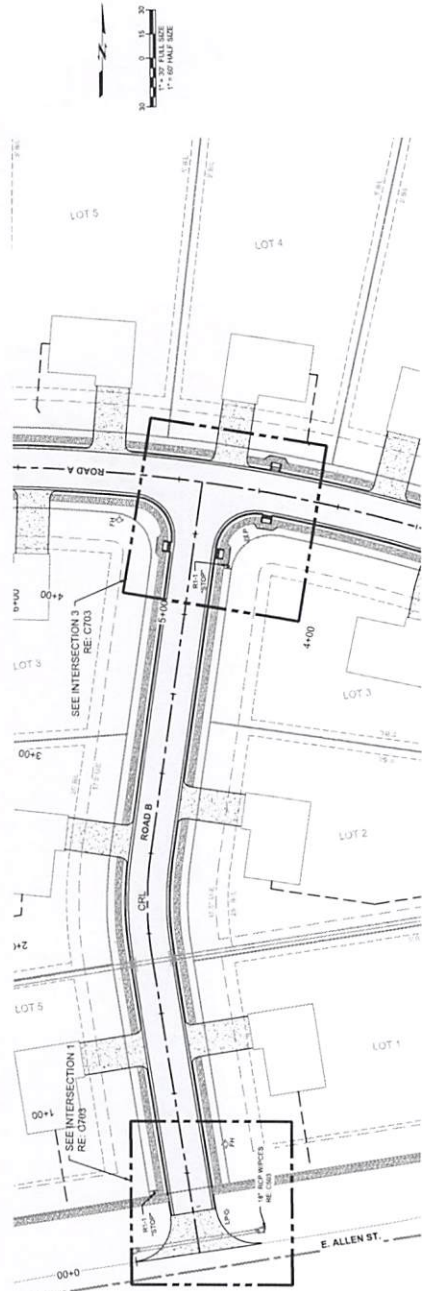

ROAD B PLAN
STA 0+00 THRU 10+09
SCALE 1"=30'


LEGEND

[Symbol]	CONCRETE SIDEWALK
[Symbol]	ASPHALT PAVING
[Symbol]	CONCRETE PAVING

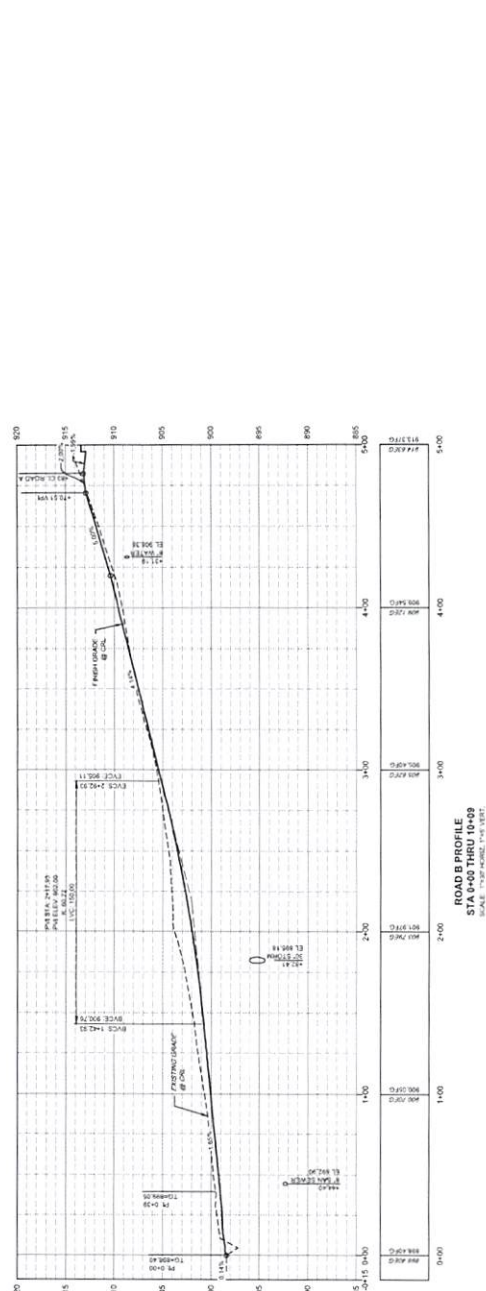



ROAD B PROFILE
STA 0+00 THRU 10+09
SCALE 1"=30' HORIZ. 1"=10' VERT.

RE: C700 FOR GEOMETRICS

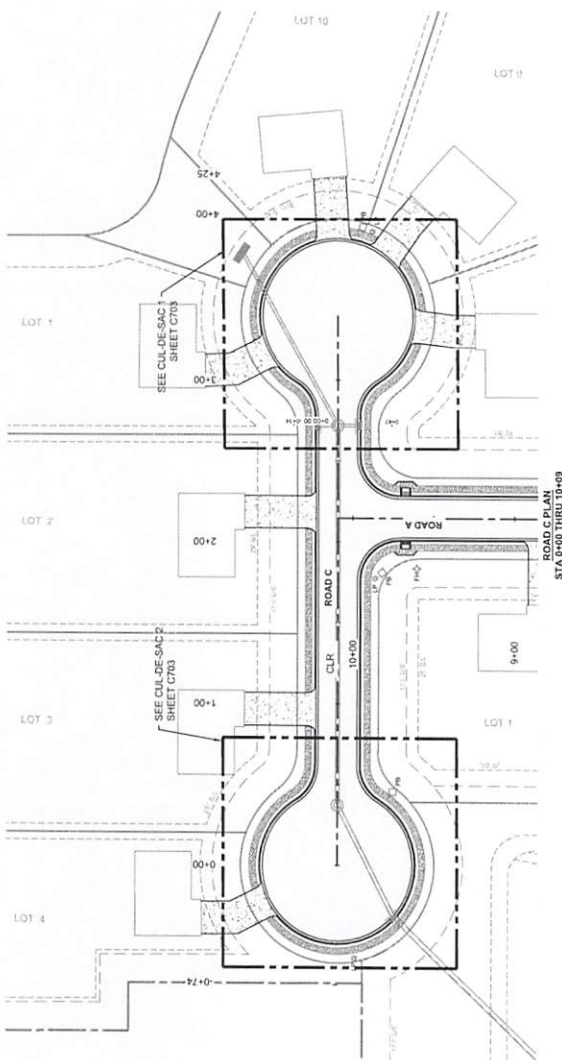

RE: C300 FOR GEOMETRICS

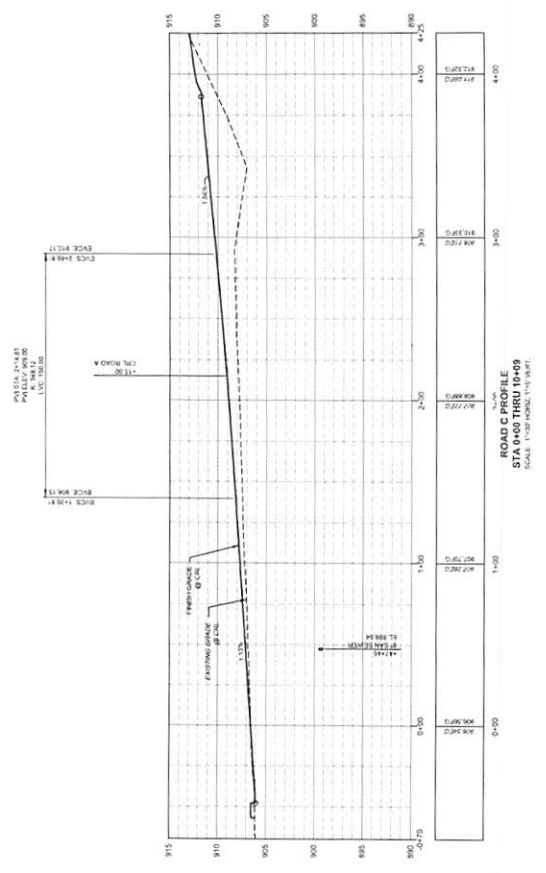

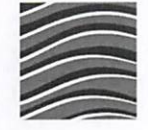

blue river
ARCHITECTS

INTERIM REVIEW ONLY



WALDCO
DESIGN
COMPANY

THIS DOCUMENT HAS BEEN REVIEWED FOR CONFORMANCE WITH THE MINIMUM REQUIREMENTS OF THE OKLAHOMA STATE DEPARTMENT OF TRANSPORTATION AND PUBLIC SAFETY. THIS REVIEW DOES NOT CONSTITUTE A GUARANTEE OF THE ACCURACY OF THE INFORMATION CONTAINED HEREIN.

blue river
ARCHITECTS

CHEROKEE HOUSING
TAHLEQUAH OKLAHOMA

11/22/2022
2240219
95% CONSTRUCTION DOCUMENTS

PROJECT NAME:
INTERSECTION DETAILS







C703




LEGEND




RE: C500 FOR GEOMETRICS

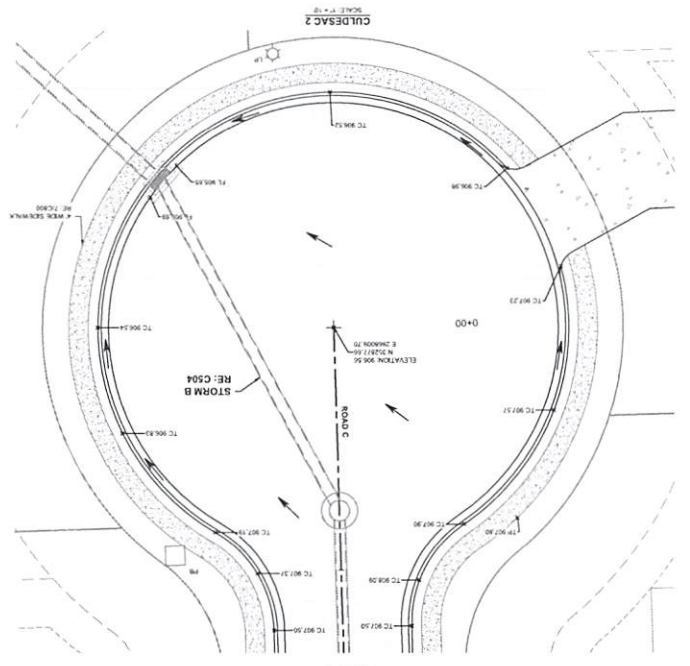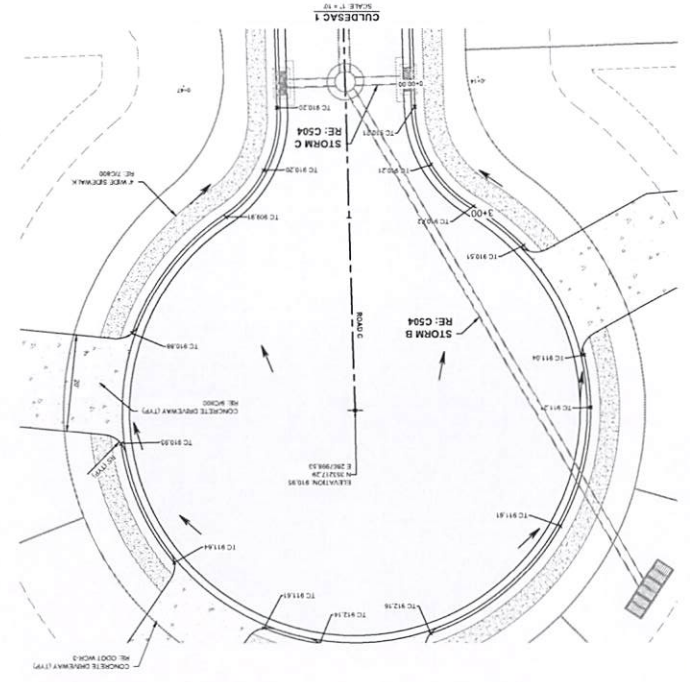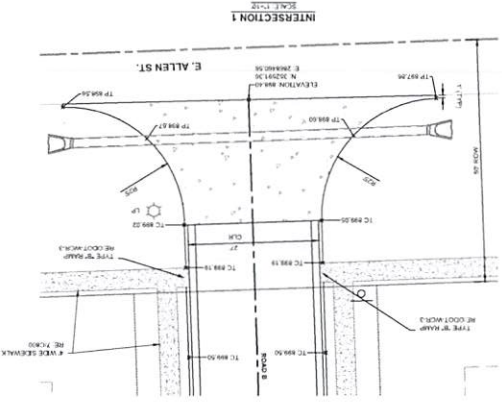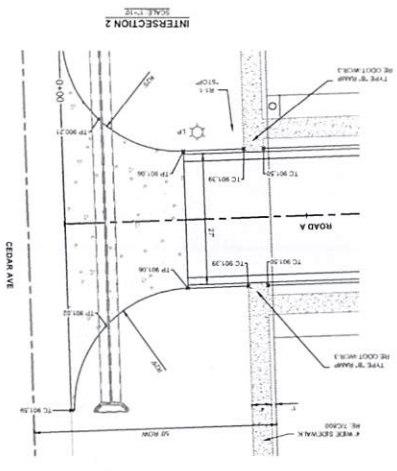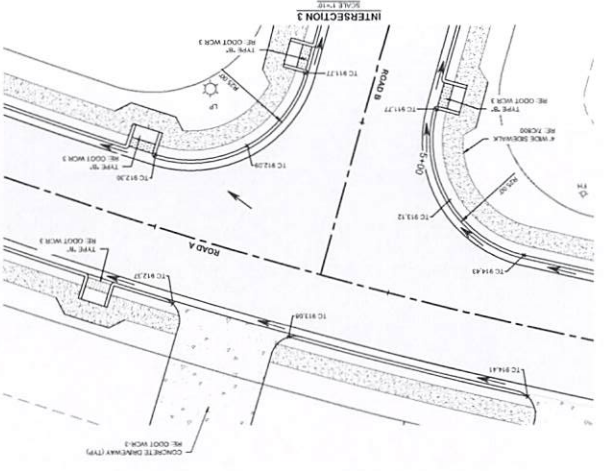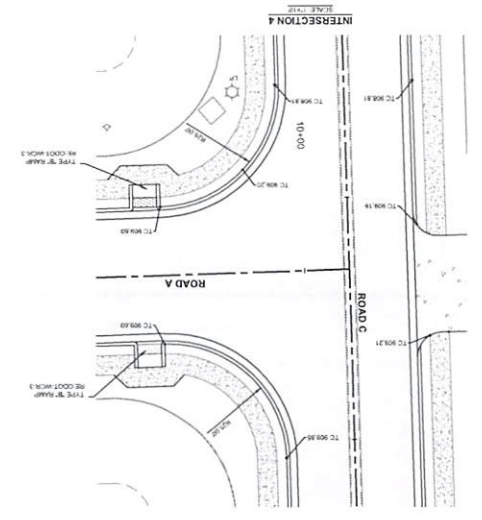


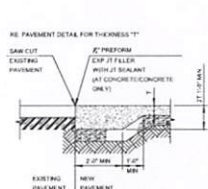


1 PAVEMENT TRANSITION
SCALE: NTS

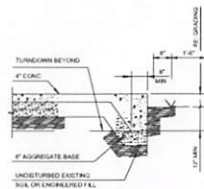

2 EQUIPMENT PAD/PATIO
SCALE: NTS

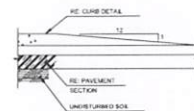


3 CURB TERMINATION
SCALE: NTS

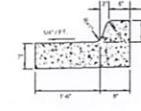


4 6" BARRIER CURB & GUTTER (FLOW AWAY)
SCALE: 1"=1'




5 CURB AND GUTTER
SCALE: NTS

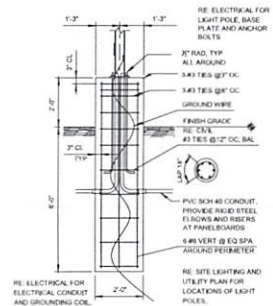


6 STREET LIGHTPOLE BASE
SCALE: NTS

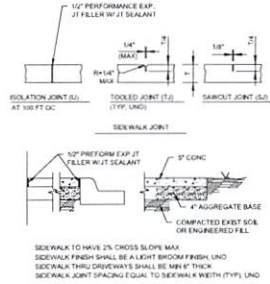

7 SIDEWALK
SCALE: NTS

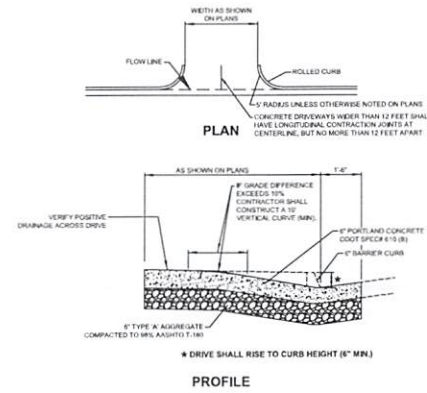

8 CONCRETE DRIVEWAY DETAIL
SCALE: NTS

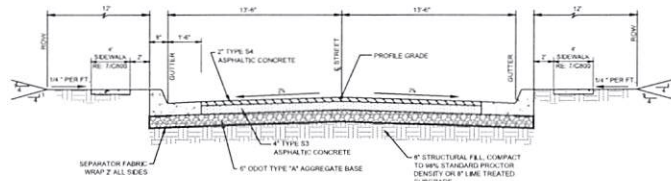

9 TYPICAL SECTION - RESIDENTIAL ROADWAY
SCALE: NTS



CAUTION
NOTICE TO CONTRACTOR

THE CONTRACTOR IS SPECIFICALLY CAUTIONED THE LOCATION AND DEPTH OF EXISTING UTILITIES AS SHOWN ON THESE PLANS ARE BASED ON RECORDS OF THE VARIOUS UTILITY COMPANIES AND MEASUREMENTS TAKEN IN THE FIELD. THE INFORMATION IS NOT TO BE RELIED ON AS BEING EXACT OR COMPLETE. THE CONTRACTOR MUST CALL THE LOCAL UTILITY LOCATION CENTER AT LEAST 72 HOURS BEFORE ANY EXCAVATION TO REQUEST EXACT FIELD LOCATIONS OF THE UTILITIES.



INTERIM REVIEW ONLY
THESE DOCUMENTS ARE PRELIMINARY. THEY MAY NOT BE USED FOR CONSTRUCTION WITHOUT THE WRITTEN APPROVAL OF BLUE RIVER ARCHITECTS.



CHEROKEE HOUSING
TAHLEQUAH OKLAHOMA



PROJECT NUMBER: 2240219
DATE: 11/22/2022
SCALE: 85% CONSTRUCTION DOCUMENTS

PROJECT NAME: PAVING DETAILS
SHEET NUMBER: C800

INTERIM REVIEW ONLY
THIS DOCUMENT IS PRELIMINARY AND NOT BE USED FOR ANY OTHER PURPOSES WITHOUT THE WRITTEN CONSENT OF THE ARCHITECT.

wallice design collective
ARCHITECTS
1000 N. UNIVERSITY AVENUE, SUITE 100
TULSA, OKLAHOMA 74107
TEL: 918.442.1111
WWW.WALLICEDESIGN.COM

**CHEROKEE HOUSING
TAHLEQUAH OKLAHOMA**


blue river
ARCHITECTS
A Native American Owned Firm

22-040219
ISSUE DATE:
11/22/2022
JOB:
95% CONSTRUCTION DOCUMENTS
OTHER SHEET DATA
NO. 1001-00000000 0478


SHEET NAME:
SANITARY SEWER DETAILS
SHEET NUMBER:
C802
© 2022 BLUE RIVER ARCHITECTS, LLC




1 TYPICAL MANHOLE INVERT DETAILS
SCALE: NTS

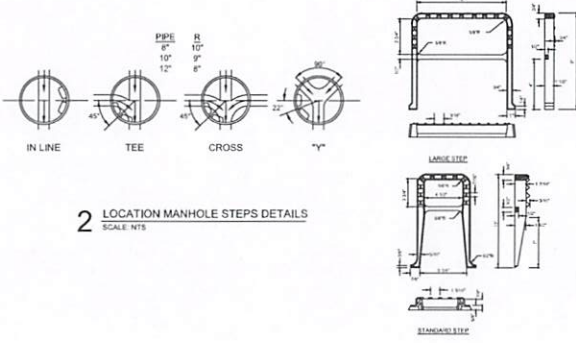


2 LOCATION MANHOLE STEPS DETAILS
SCALE: NTS

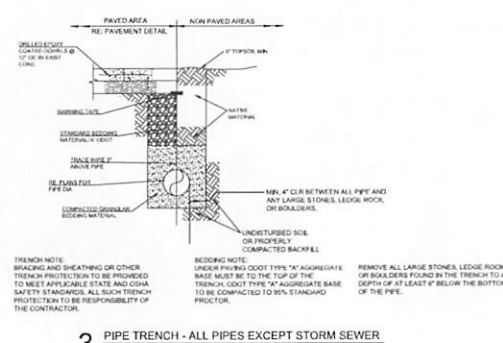


3 PIPE TRENCH - ALL PIPES EXCEPT STORM SEWER
SCALE: NTS

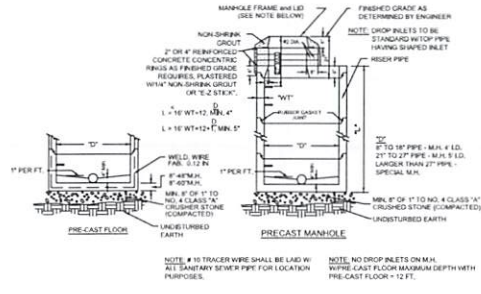


4 MANHOLE DETAILS
SCALE: NTS

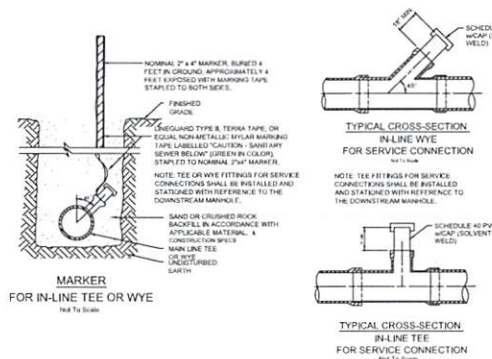


5 IN-LINE TEE DETAILS
SCALE: NTS

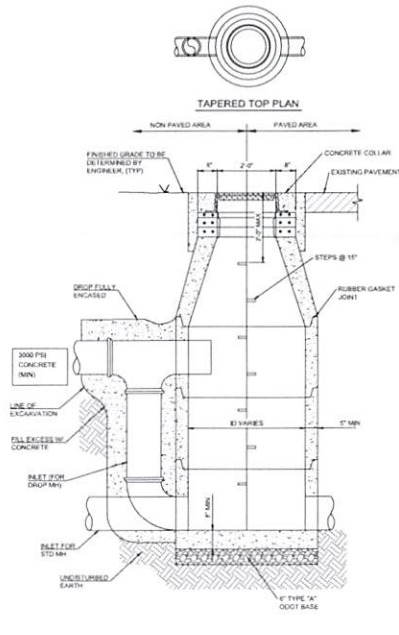

6 TAPERED DROP MANHOLE
SCALE: NTS

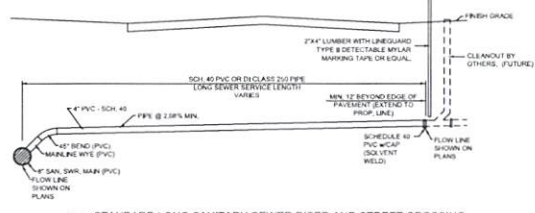

7 STANDARD LONG SANITARY SEWER RISER AND STREET CROSSING
SCALE: NTS

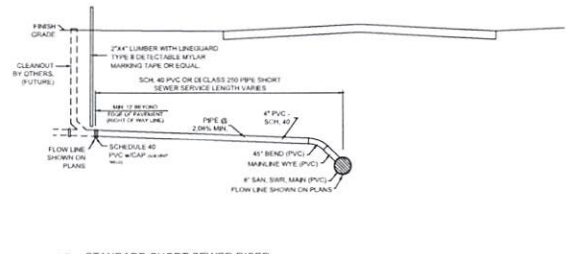

8 STANDARD SHORT SEWER RISER
SCALE: NTS



**CAUTION
NOTICE TO CONTRACTOR**
THE CONTRACTOR IS SPECIFICALLY CAUTIONED THE LOCATION AND UTILITY OF ALL UTILITIES AS SHOWN ON THESE PLANS ARE BASED ON RECORDS OF THE VARIOUS UTILITY COMPANIES AND MEASUREMENTS TAKEN IN THE FIELD. THE INFORMATION IS NOT TO BE RELIED ON AS BEING EXACT OR COMPLETE. THE CONTRACTOR MUST CALL THE LOCAL UTILITY LOCATION CENTER AT LEAST 12 HOURS BEFORE ANY EXCAVATION TO REQUEST EXACT FIELD LOCATIONS OF THE UTILITIES.