CHEROKEE NATION - W.W. HASTINGS REPLACEMENT HOSPITAL

SUMMARY OF WORK 1. The Work to be performed consists of providing all labor, materials, equipment and services necessary for the complete construction and start up of SCHEMATIC DESIGN or the <u>CHEROKEE NATION - W.W. HASTINGS REPLACEMENT HOSPITAL</u> as shown on the Drawings and herein specified in accordance with the Contract Documents.

CONTRACT COSTS 1. All costs for labor, materials, equipment, and services necessary for complete

- construction and start-up of the Work as shown on the Drawings and specified herein shall be included in the contract price unless otherwise indicated in the Contract
- 2. Work shown on the Drawings or required by the Specifications but not specifically listed in the Summary of Quantities shall be considered incidental construction, and the cost of such work shall be included in the Unit Prices Bid. 3. CONTRACTOR shall make their own estimate of the labor, materials, equipment, and
- services necessary to complete the work and shall visit the site and fully acquaint himself of the existing conditions prior to commencing construction. CONTRACTOR shall notify ENGINEER of any errors in the ENGINEER's construction quantities; or any condition at the site that may affect the construction of the work as shown on the

GENERAL REQUIREMENTS

- 1. Drawings, Specifications, or other documents (or copies of any thereof) prepared by or bearing the seal of Cardinal Engineering, Inc., including electronic media editions, shall not be reused on extensions of the Project or any other project without written consent of OWNER and Cardinal Engineering, Inc. and specific written verification or adaptation by Cardinal Engineering, Inc.
- 2. Survey information shown on the drawings were provided by Lemke Land Surveying. 3226 Bart Conner Drive, Norman, OK, 73072 Phone (405) 366-8541, CA #2054...

APPLICABLE CODES AND SPECIFICATIONS

1. All references to codes, specifications, and standards referred to in the Specification and on the Drawings shall mean, and are intended to be, the latest edition, amendment, and/or revision of such reference standard in effect as of the date of these Contract Documents.

PROCEDURAL REQUIREMENTS

- 1. CONTRACTOR shall make the coordination of the operations of all trades, subcontractors, and material suppliers engaged upon or in connection with the Work. Every effort shall be made to assure a harmonious, cooperative attitude on the part of all concerned. CONTRACTOR shall guarantee to each of his foremen and subcontractors the proper dimensions they may require for the fitting of their work to adjoining work. All fitting and adjusting necessary to make all the parts of the work join together properly shall
- 2. Cooperation with utility and government officials and inspectors shall occur at all times If any official or inspector deems special inspection is necessary, assistance and facilities that will expedite his inspection shall be provided.

TEMPORARY FACILITIES AND CONTROLS

- 1. Arrange for and provide temporary facilities and controls as specified herein and as required for the proper and expeditious prosecution of the work. Pay all costs, except as otherwise specified, until final acceptance of the work unless the OWNER makes arrangements for the use of completed portions of the work after substantial completion in accordance with the provisions of the General Conditions.
- 2. Make all temporary connections to utilities and services in locations acceptable to the OWNER, ENGINEER, and local authorities having jurisdiction thereof; furnish all necessary labor and materials, and make all installations in a manner subject to the acceptance of such authorities and the ENGINEER; maintain such connections; remove the temporary of supply to proper operating condition.
- 3. Pay all costs for temporary electrical power and temporary water.
- 4. Water necessary for construction purposes shall be provided. All temporary connections shall be made to existing mains. A temporary meter shall be provided. Arrangements and payment for the temporary water service, including cost of installation, maintenance thereof, and water used shall be made. At the completion of the construction work, all temporary water service equipment and piping shall be removed.
- 5. Chemical toilets for the use of all construction personnel shall be provided at a location within the limits of the Site. Chemical toilets shall be maintained in a sanitary
- 6. From the commencement to the completion of the work, keep all parts of the site and the project free from accumulation of water, and supply, maintain, and operate all necessary pumping and bailing equipment.
- 7. Remove snow and ice as necessary for the protection and prosecution of the work, and protect the work against weather damage.

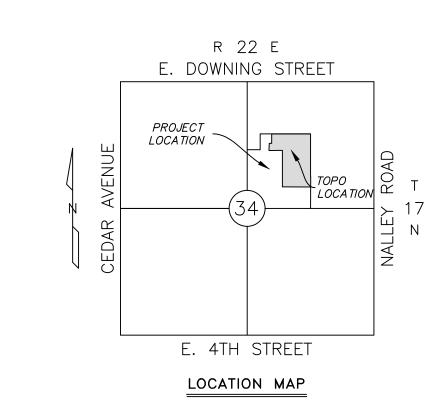
- 1. Materials, products, and equipment shall be properly containerized, packaged, boxed, and protected to prevent damage during transportation and handling. 2. Provide suitable temporary weather tight storage facilities as may be required for
- materials that will be damaged by storage in the open. Any off-site storage space used is the responsibility of the CONTRACTOR. Store and protect materials delivered at the site from damage. Do not use damaged material on the work. 3. Manufactured articles, materials, and equipment shall be applied, installed, connected,
- erected, used, cleaned, and conditioned as directed by the respective manufacturers, unless otherwise specified. 4. References to approved equal or similar terms mean that approval of the ENGINEER is
- 5. Whenever the Contract Documents require that a product be in accordance with Federal specification, ASTM designation, ANSI specification, AWWA specification, or other association standard, the CONTRACTOR shall present an affidavit from the manufacturer certifying that the product complies therewith. Where requested or specified, submit

EXECUTION REQUIREMENTS

supporting test data to substantiate compliance.

- 1. CONTRACTOR shall be responsible for properly laying out the work, and for lines and measurements for the work executed under the Contract Documents. Verify the figures shown on the Drawings before ordering any materials and laying out the work, and report errors or inaccuracies in writing to the ENGINEER before commencing work. The ENGINEER or his representative will in no case assume the responsibility for laying out
- 2. OWNER has or will perform a survey of the site, stake the property limits, and provide a reference benchmark elevation. CONTRACTOR shall be responsible for any additional offset staking or layout survey required to locate improvements and control grade of improvements. Be responsible for the proper location and level of the work and for the maintenance of reference lines and benchmarks. Any re-staking requested by the CONTRACTOR shall be done at his expense.
- 3. Existing survey points other than those specifically mentioned herein shall not be considered as acceptable control points unless approved by the ENGINEER. If approval is secured, CONTRACTOR remains responsible for maintaining them and for their

LEGAL DESCRIPTION AND LOCATION MAP



accuracy. Be responsible for preserving all existing iron or metal, and all concrete survey points or monuments for the construction period.

STORM WATER POLLUTION PREVENTION PLAN

devices damaged due to construction.

- 1. Construction activities that result in land disturbance of equal to or greater than one (1) acre, or less than one (1) acre, if they are part of a larger common plan of development or sale that totals at least one (1) acre must also obtain a permit for Storm Water Discharges from Construction Activities. This means that land disturbing of one (1) acre or more must permit with EPA.
- 2. A copy of the erosion control site plan must be on site at all times and made available to the inspector upon request. 3. The contractor shall be responsible for the repair or replacement of all erosion control
- 4. A Storm water Pollution Prevention Plan (SWPPP) has been prepared for the WORK and a Notice of Intent (NOI) has been submitted by OWNER. CONTRACTOR shall implemen the SWPPP, and construct, inspect, and maintain the erosion controls to prevent runoff of silt and sediment from the site. A copy of the SWPPP shall be kept at the site at all times and be made available to inspectors upon request. Inspections reports shall be maintained in the SWPPP and the SWPPP shall be updated when necessary. 5. The erosion control plan, Notice of Intent (NOI), and the Storm Water Pollution Prevention Plan (SWPPP), as well as any other applicable state or municipal permits
- be made available to state and municipal authorities upon request. 6. Inspect disturbed areas of the construction site that have not been finally stabilized, areas used for storage of materials that are exposed to precipitation, structural control measures, and locations where vehicles enter or exit the site, at least once every fourteen (14) calendar days and within 24 hours of the end of a storm event of 0.25

shall be kept on site by the construction superintendent at all times. Said items shall

- 7. All erosion and sediment control measures and other protective measures identified in this SWPPP must be maintained in effective operating condition. If site inspections identify erosion controls that are not operating effectively, maintenance shall be performed before the next anticipated storm event, or as necessary to maintain the continued effectiveness of storm water controls. If maintenance prior to the next anticipated storm event is impracticable, maintenance must be scheduled and
- accomplished as soon as practicable. 8. If sediment escapes the construction site, off-site accumulations of sediment shall be removed at a frequency sufficient to minimize offsite impacts (e.g., fugitive sediment in street could be washed into storm sewers by the next rain and/or pose a safety hazard to users of public streets).
- 9. Sediment shall be removed from sediment traps or sedimentation ponds when the design capacity has been reduced by 50%. 10.Litter, construction debris, and construction chemicals exposed to storm water shall be prevented from becoming a pollutant source for storm water discharges (e.g., screening

EXISTING UTILITIES AND STRUCTURES

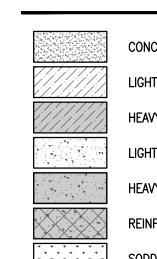
outfalls, picked up daily).

- 1. CONTRACTOR shall contact OKIE (1-800-522-6543) prior to construction for locating 2. The underground utilities shown have been located from field survey surface information
- and existing drawings. ENGINEER and Surveyor make no guarantee that the underground utilities shown comprise all such utilities in the area, either in service or abandoned. The underground utilities are located as accurately as possible from information available; however, ENGINEER and Surveyor further do not guarantee that the underground utilities shown are in the exact location indicated either vertically or horizontally. ENGINEER and Surveyor have not physically located the underground utilities by probing, excavating, hydro-vac, or by any other means.
- 3. Prior to construction, CONTRACTOR shall notify all utility companies and governmental agencies who may have utility lines on or about the premises or who may be affected by the construction. Notice shall be given no less than twenty-four hours prior to any work that may interfere with a utility. CONTRACTOR shall also coordinate the construction activities with the utility companies to ensure compliance with the project
- 4. All existing structures, improvement and utilities designated to remain shall be adequately protected from damage that might otherwise occur due to construction operations. Where construction comes in close proximity to existing structures, utilities or appurtenances, or if it becomes necessary to move services, poles, guy wires, pipe lines or other obstructions, CONTRACTOR shall notify and cooperate with the owner of the utility, structure, or appurtenance. The utility lines and other existing structures shown on the plans are for information only and are not guaranteed to be complete or accurate as to location and/or depth. CONTRACTOR shall be liable for damage to any utilities resulting from the CONTRACTOR's operations. During construction, all fire hydrants, valve boxes, fire or police call boxes and other existing utility controls shall be left intact, unobstructed and accessible unless noted on the plan.
- 5. Any existing valve boxes, meters, fire hydrants, manholes, and other public utilities shall be rebuilt to finished grades according to specifications. All valves, manhole lids, and sewer clean—outs located in paved areas, shall be rated for H—20 traffic loading. Coordinate the work with the appropriate utility department.

PROTECTION AND MAINTENANCE

- 1. Perform all special construction operations and take all precautions necessary to adequately protect the materials and work performed, the property and landscape of OWNER and others, existing buildings and improvements, existing utilities, workers and employees, and the public in general.
- 2. Where trees, plants, shrubbery, and other vegetation are adjacent to the line of the work and are designated not to be destroyed or removed and replaced, CONTRACTOR shall protect these items by substantial wooden boxes and guards and shall not permit machinery or employees to scrape, tear the limbs from or damage, or attach guy cables to them. Hand excavation may be required if machinery could damage trees, plants, shrubbery, and other vegetation designated to be left undisturbed. CONTRACTOR shall be responsible for all damages to such trees, plants, shrubbery, and other vegetation unless specific provisions are made for their removal or abandonment on the
- 3. Existing fences that require cutting for gates or other reasons shall be adequately braced to prevent slacking of the fence before it is cut. Livestock may be present in all fenced areas; therefore, points of entrance shall be kept closed at all times and the CONTRACTOR shall be responsible for the containment of livestock, their safety, and the safety of the public. All fencing shall be done in a workmanlike manner with standard construction practices as per the standard details provided. Gates installed shall be chained and locked closed. Locks shall be keyed alike. Provide a set of keys
- 4. The sides of all excavations shall be sufficiently sheeted and shored to prevent slides, cave-ins, settlement or movement of the banks and to maintain the excavation clear of all obstructions that will, in any way, hinder or delay the progress of the work. All sheeting, shoring and bracing shall have sufficient strength and rigidity to withstand the pressure exerted and maintain the sides of the excavation properly in place and protect all persons, including workmen, and all property from injury or damage. The removal of sheeting, shoring and bracing shall be done in such manner as to not endanger new or existing structures, public or private property, and to avoid cave—ins or slides of the

HARDSCAPE / LANDSCAPE PATTERNS



CONCRETE SIDEWALKS LIGHT DUTY ASPHALT PAVING HEAVY DUTY ASPHALT PAVING

LIGHT DUTY CONCRETE PAVING

HEAVY DUTY CONCRETE PAVING REINFORCED HEAVY DUTY CONCRETE PAVING SODDING / SEEDING / VEGETATIVE COVER

banks. Sheeting, shoring, or bracing shall not be left in place.

the work and restore all buildings, culverts, fences, walls, or other properties disturbed during the work to a condition equal to that existing before operation. CONTRACTOR shall be responsible for any injuries to persons and for damages to existing buildings or other structures affected by the work, and OWNER shall not be liable therefore. Immediately remove all surface or seepage water from sewers, drains, ditches, and other sources that may accumulate water during the excavation and construction work by pumping, bailing, or draining. CONTRACTOR shall have available at all times sufficient equipment in proper working order for doing the work herein required. All water removed from excavations shall be disposed of in an approved manner, so as to not create unsanitary conditions, nor to cause injury to persons or property or damage to the work in progress, nor to interfere unduly with the use of streets, private driveways or entrances.

5. Shore up and protect any building or other structure which may be endangered during

- . When existing storm sewers, drains, or ditches are blocked, cut, opened, or removed in the course of the work, CONTRACTOR shall provide and maintain temporary outlets and connections until permanent facilities have been restored. Provide and maintain any pumps, diversions, piping, containers, and other facilities required for this purpose. 8. During construction and until such time as vegetation is reestablished, keep exposed dirt areas within the limits of construction and in stockpiles areas damp to prevent blowing. CONTRACTOR shall be responsible for providing and maintaining adequate erosion protection during construction and following construction until such time as proper vegetation is reestablished.
- 9. The premises and the job site shall be maintained in a reasonably neat and orderly condition and kept free from accumulations of waste materials and rubbish during the entire construction period. Remove crates, cartons, and flammable waste materials or trash from the work areas at the end of each working day.
- 10. Upon completion of the work and before final acceptance and final payment shall be made, the CONTRACTOR shall completely clean and remove from the site of the work all equipment, construction materials, surplus and discarded materials, temporary structures and debris of every kind. CONTRACTOR shall leave the site of the work in a neat and orderly condition equal to that which originally existed, or as called for in the Contract documents. Surplus and waste materials removed from the site of the work shall be disposed of at locations satisfactory to the Engineer, and at the CONTRACTOR'S sole
- 11. All terraces. levees. and watercourses shall be restored to former condition to the satisfaction of OWNER so that they shall function as originally intended. 12. Fences disturbed by construction shall be restored to original condition and to the
- 13. Public and private streets, drives, and parking lots shall be restored to their original
- 14. When and where any damage or injury is done to public or private property on the part of the CONTRACTOR, it shall restore or have restored at its own cost and expense such property to a condition equal (or improved) to that existing before such damage was done by repairing, rebuilding or otherwise restoring as may be directed, or it shall make good such damage or injury in a manner acceptable to the property owner or the Engineer. Replacement of previously constructed items, such as curb, gutter, sidewalks, driveways, paving, etc., shall conform to the specifications for new construction, unless directed otherwise by the OWNER.

EXCAVATION AND TRENCH SAFETY SYSTEMS

. CONTRACTOR shall be responsible for complying with State laws and Federal regulations relating to excavation and trench safety, including those which may be enacted during the performance under this Contract. CONTRACTOR is advised that Federal Regulations 29 C.F.R. 1926.650-1926.652 have been, in their most recent version as amended, in effect since January 2, 1990. CONTRACTOR shall fully comply with the U.S. Department of Labor Occupational Safety and Health Administration (OSHA) regulations pertaining to excavations, trenching, and shoring and shall provide and familiarize its employees involved in excavation and trenching with the provisions in OSHA Pamphlet Number 2226, Excavating and Trenching Operations.

ADA COMPLIANCE

- 1. A Work Zone Permit must be obtained from the CITY at least two (2) working days prior to the start of work and/or placing or removing any barricades or modifying existing traffic control devices. CONTRACTOR shall be responsible for erecting and maintaining barricades and other traffic warning devices as necessary around the perimeter of construction and adjacent to any open trenches. Provide and maintain adequate detours around the work under construction. Provide sufficient lights, warning signs, and watchmen for the safety of
- 3. Any temporary street closure shall be coordinated with and approved by OWNER. CONTRACTOR shall establish all detour routes while streets are closed during construction. CONTRACTOR shall notify Fire, Police, and EMSA headquarters when any CONTRACTOR is responsible for the prompt replacement and/or repair of all traffic control devices, signs, and appurtenances damaged or disturbed due to construction.

Any existing traffic signals, signal loops, conduits, cables, signs, and other traffic control devices affected by the work shall be reset or replaced according to specifications. Coordinate the work with the traffic department.

1. CONTRACTOR is responsible for ensuring all sidewalks, curb ramps, ramps, stairs,

accessible parking spaces, and building access routes comply with the current

Americans with Disability Act (ADA) Standards prior to construction. Any errors found

shall be brought the ENGINEER'S attention for resolution. DEFECTIVE AND UNAUTHORIZED WORK

1. All work that has been rejected or condemned shall be repaired or if it can not be satisfactorily repaired, it shall be removed and replaced at the CONTRACTOR's expense. Defective materials shall be removed immediately from the site of the work. 2. Work done without lines and grades having been given, work done beyond the lines or not in conformity with grades shown on the plans or as given, work done with out proper inspection, or any extra or unclassified work done without written authority and prior written agreement as to prices, will be done at the CONTRACTOR's risk and will be considered unauthorized, and at the option of the ENGINEER, may not be measured an paid for and may be ordered to be removed at the CONTRACTOR's expense.

3. Upon failure of the CONTRACTOR to satisfactorily repair or to remove and replace, if so directed, and rejected, unauthorized, or condemned work or materials immediately after receiving notice from the ENGINEER, the ENGINEER shall, after giving written notice to the CONTRACTOR, have the authority to cause defective work to be remedied or removed and replaced, or to cause unauthorized work to be removed and replace, and to deduct the cost thereof from any compensation due or to become due the CONTRACTOR. If the ENGINEER and OWNER deem it not expedient to correct the work damaged or done not in accordance with the Contract, and equable deduction from the Contract Price shall be made thereof.

SYMBOL LEGEND

AC	AIR CONDITIONER
X	FIRE HYDRANT

G GAS METER

ర్ GAS VALVE

¹i GAS VENT TRA GROUND TRANSFORMER

 GUARD POST □ LIGHT POLE

(D) STORM DRAIN MANHOLE

(S) SANITARY SEWER MANHOLE PROPERTY CORNER FOUND

O PROPERTY CORNER SET (CO) SANITARY SEWER CLEANOUT

- COMMERCIAL SIGN - SIGN

Ö SPRINKLER HEAD び SPRINKLER VALVE

TELEPHONE RISER

門 TRAFFIC/ELECTRIC PULL BOX WATER METER

TC=1121.63 TOP OF CURB SPOT ELEVATION

LINE LEGEND

_xxx	xx	BARBED WIRE FENCE
		CHAINLINK FENCE
8 8 8		PIPERAIL FENCE
		STOCKADE FENCE
* * *	*	SECURITY FENCE
	E ———	ELECTRIC UNDERGROUND
— E	E	OVERHEAD ELECTRIC
	G	GAS LINE
— ss ———		SANITARY SEWER
====		STORM DRAIN PIPE (SURVEYED)
— SD ———		STORM DRAIN CENTERLINE
— w ———		WATER
- NW		NONPOTABLE WATER
=		CURB AND GUTTER
>> >>	>>	SURFACE DRAINAGE FLOWLINE
— FO ———	FO ———	FIBER OPTIC
— т	T	TELEPHONE (AERIAL)
— т ——	T	TELEPHONE (BURIED)
— TV	TV	TELEVISION (AERIAL)
— TV ———	TV ———	TELEVISION (BURIED)
		CENTERLINE
		EASEMENTS
		PROPERTY LINE
		RIGHT OF WAY
		EXISTING BUILDINGS
		BUILDING SETBACK
	— 1232 — —	EX 1 FT CONTOUR
	— <i>1235</i> ———	EX 5 FT CONTOUR
	1232	FG 1 FT CONTOUR
	1235	FG 5 FT CONTOUR
		DDO IFOT DOLINDADY

FINISHED FLOOR

FINISHED GRADE

FACE OF CONCRETE

GENERAL CONTRACTOR

FLOWLINE

FOOTING

FOOT/FEET

FIELD VERIFY

GALVANIZED

HEAVY DUTY

HORIZONTAL

INFORMATION

MANHOLE

MECH

MISC

MAXIMUM

MINIMUM

MECHANICAL

MISCELLANEOUS

INSIDE DIAMETER

INTERNATIONAL FUEL GAS CODE

INTERNATIONAL PLUMBING CODE

GUTTER

HEIGHT

FINISHED GRADE CENTER LINE

———————— DEMOLITION LINE

ABBRE	EVIATIONS		
Ø AFF AGRD AHJ	AT ABOVE FINISHED FLOOR ADJACENT GRADE AUTHORITY HAVING JURISDICTION	N/A	NOT APPLICABLE
APPROX ARCH	APPROXIMATE ARCHITECTURAL	OD	OUTSIDE DIAMETER
ASS'Y	ASSEMBLY	MTCH MEP	MATCH MECHANICAL / ELECTRICAL
BFF BLDG	BELOW FINISHED FLOOR BUILDING		/ PLUMBING
CIP CL CM	CAST IN PLACE CENTERLINE CONSTRUCTION MANAGER	N N NO.	NORTH NORTHING NUMBER
CNTR CONC CONST	CENTER CONCRETE CONSTRUCT	OC ODEQ	ON CENTER OKLAHOMA DEPARTMENT OF ENVIRONMENTAL QUALITY
CONTR	CONTINUOUS CONTRACTOR	ODOT	OKLAHOMA DEPARTMENT OF TRANSPORTATION
COORD DIA	COORDINATE DIAMETER	OWRB	OKLAHOMA WATER RESOURCES BOARD
DS DTL	DOWN SPOUT DETAIL	OZ PC	OUNCE PORTLAND CEMENT
DWG(S)	DRAWINGS	PC PC	PRE-CAST POINT OF CURVATURE
E E	EAST EASTING	PLBG POC	PLUMBING POINT OF CONNECTION
EG EGCL	EXISTING GRADE EXISTING GRADE CENTER LINE	PRC PT	POINT OF REVERSE CURVATURE POINT OF TANGENCY
ELEC ELEV EJ	ELECTRICAL ELEVATION EXPANSION JOINT	PVI QTY	POINT OF VERTICAL INTERSECTION QUANTITY
EQ ETR	EQUAL EXISTING TO REMAIN	R	RADIUS
EX EXHD	EXISTING EXTRA HEAVY DUTY	RE: REINF	REFERENCE REINFORCED
FD	FLOOR DRAIN	REQ'D	REQUIRED

RE: REINF REQ'D REV	REFERENCE REINFORCED REQUIRED REVISION	
S SAN SCHED SECT SF SHT SPEC SQ STRUC STD SW SY	SOUTH SANITARY SCHEDULE SECTION SQUARE FEET SHEET SPECIFICATION SQUARE STRUCTURAL STANDARD SIDEWALK SQUARE YARD	
TC	TOP OF CURB	

TOP OF CONCRETE TOP OF SLOPE TOE OF WALL TOP OF WALL TYPICAL

UNLESS NOTED OTHERWISE WITH

WEIGHT

CIVIL SD SHEET LIST

Sheet Number	Sheet Title	
CO-102	General Civil Notes	
C0-901	Project Map	
C3-101	Overall Site View	
C3-102	A1 Site Plan	
C3-103	A2 Site Plan	
C3-104	B1 Site Plan	
C3-105	B2 Site Plan	
C3-106	C1 Site Plan	
C3-107	C2 Site Plan	
C3-108	P1 Site Plan	
C3-109	P2 Site Plan	
C3-110	P3 Site Plan	
C3-111	P4 Site Plan	
C3-112	P5 Site Plan	
C3-501	Site Details	
C3-502	Site Details	
C3-503	Concrete Paving Joint Details	
C4-101	Overall Utility View	
C4-102	A1 Utilities	
C4-103	A2 Utilities	
C4-104	B1 Utilities	
C4-105	B2 Utilities	
C4-106	C1 Utilities	
C4-107	C2 Utilities	
C5-101	Overall Grading View	
C5-102	A1 Grading Plan	
C5-103	A2 Grading Plan	
C5-104	B1 Grading Plan	
C5-105	B2 Grading Plan	
C5-106	C1 Grading Plan	
C5-107	C2 Grading Plan	

P1 Grading Plan

| P2 Grading Plan

P4 Grading Plan

C5-110 | P3 Grading Plan

C5-112 | P5 Grading Plan

C5-108

BP1 SHEET LIST

Sheet Number	Sheet Title
CO-101	BP1 General Civil Notes
C1-101	Existing Conditions
C1-102	Existing Conditions
C2-101	Overall Demolition View
C2-102	A1 Demolition Plan
C2-103	A2 Demolition Plan
C2-104	B1 Demolition Plan
C2-105	B2 Demolition Plan
C2-106	C1 Demolition Plan
C2-107	C2 Demolition Plan
C2-108	BP1 Erosion Control Plan
C2-501	Erosion Control Details
C6-101	Storm Drain Plan
C6-201	Storm Drain Profiles
C6-501	Storm Drain Details
C6-502	Storm Drain Details
C6-503	Storm Drain Details
C6-504	Storm Drain Details
C6-505	Storm Drain Details
C6-506	Storm Drain Details
C6-507	Storm Drain Details
C6-508	Storm Drain Details
C6-509	Storm Drain Details
C6-801	Hydrology Map
-	

PROFESSIONAL SEAL PRELIMINARY REVIEW
This document is refersed
for the purpose of review to

James R. Childers

Architect, Inc.

Fort Smith, AR 72901

479-783-2480

www.childersarchitect.com





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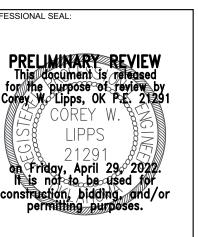
SCHEMATIC DESIGN

21-08.21

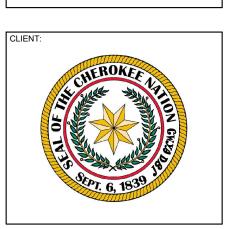
C0-102

GENERAL CIVIL NOTES









HEROKEE NATION

GS REPLACEMENT HOSPIT

KEY PLAN:

PROJECT PHASE:

SCHEMATIC DESIGN

	REVISIONS
\vdash	

21-08.21
ATE: 05-06-22
HEET NUMBER: C0-901

SHEET TITLE:

PROJECT MAP

PARKING TOTALS

ON-SITE SPACES LOST AND RECONSTRUCTED 819 PARKING SPACES

46 A.D.A SPACES 773 STANDARD SPACES

ON-SITE SPACES ADDED IN THE DESIGN 196 PARKING SPACES

38 A.D.A. SPACES 158 STANDARD SPACES

NET LOSS OF ON-SITE SPACES 623 PARKING SPACES LOST 8 A.D.A. SPACES LOST

NORTH SURFACE PARKING
1,031 STANDARD SPACES

615 STANDARD SPACES LOST

PARKING SPACES DIFFERENCE

8 A.D.A. SPACES LOST

416 STANDARD SPACES ADDED

408 TOTAL ADDITIONAL PARKING SPACES

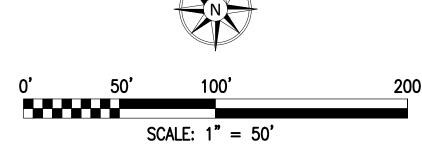
ON-SITE PAVING ESTIMATES

3,695 SY 4-IN THK SIDEWALK 9,149 SY 5-IN THK CONCRETE 3,000 SY 6-IN THK CONCRETE 5,353 SY 7-IN THK CONCRETE 10,710 SY BUILDING PAD 711 SY CEP PAD 5,969 LF 6-IN BARRIER CURB W/2-FT GUTTER / 6-IN THK



HARDSCAPE PATTERNS

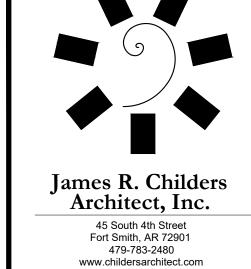
HAINDOCA	I L TATILINIS
	CONCRETE SIDEWALKS
4	LIGHT DUTY CONCRETE PAVING
4 4	MEDIUM DUTY CONCRETE PAVING
4 4	HEAVY DUTY CONCRETE PAVING
	REINFORCED HEAVY DUTY CONCRETE PA
	SODDING / SEEDING / VEGETATIVE COV

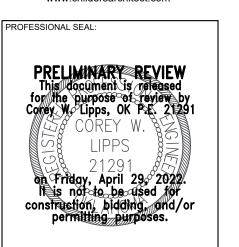


<u>UTILITY WARNING:</u>
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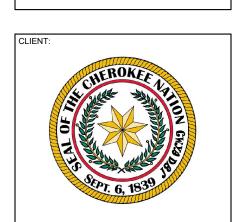
UTILITY ELEVATIONS AND SIZES MAY HAVE BEEN MEASURED UNDER ADVERSE FIELD CONDITIONS. UPON EXPOSING THE UTILITY, ELEVATIONS AND LINE SIZES SHOULD BE VERIFIED BY THE CONTRACTOR PRIOR TO CONSTRUCTION. CONTRACTOR SHOULD VERIFY CRITICAL ELEVATIONS USING THE BENCHMARK PROVIDED BY THE SURVEYOR OR ENGINEER. ANY DISCREPANCIES SHOULD BE IMMEDIATELY BROUGHT TO THE ENGINEER'S AND SURVEYOR'S ATTENTION.



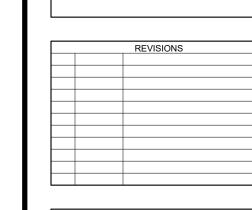








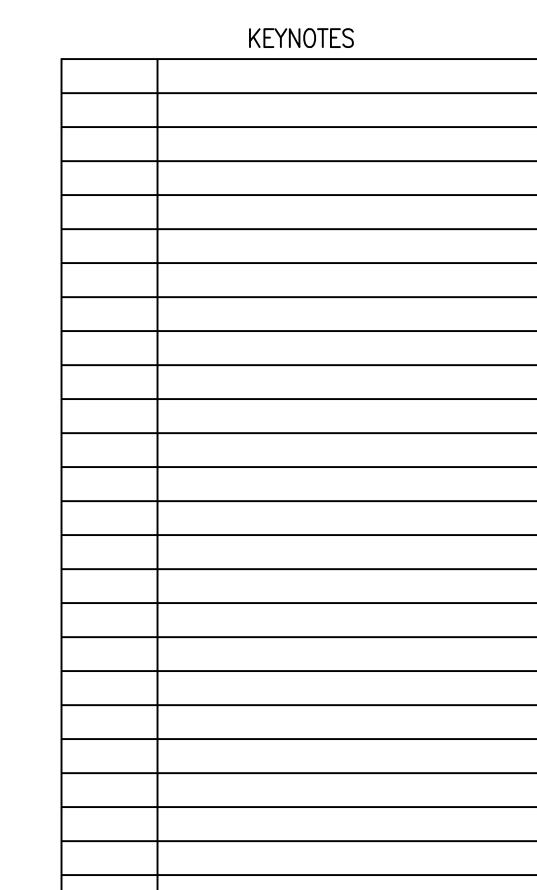
SCHEMATIC DESIGN



21-08.21 05-06-22

OVERALL SITE VIEW

	CONCRETE SIDEWALKS
4	LIGHT DUTY CONCRETE PAVING
4 D 4	MEDIUM DUTY CONCRETE PAVING
p. 7.	HEAVY DUTY CONCRETE PAVING
	REINFORCED HEAVY DUTY CONCRETE PAVING
\(\frac{1}{\psi}\)	SODDING / SEEDING / VEGETATIVE COVER



HARDSCAPE PATTERNS

MEDIUM DUTY CONCRETE PAVING

CONCRETE SIDEWALKS LIGHT DUTY CONCRETE PAVING

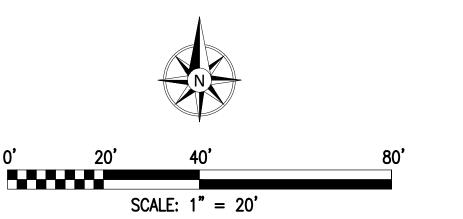
HEAVY DUTY CONCRETE PAVING REINFORCED HEAVY DUTY CONCRETE PAVING SODDING / SEEDING / VEGETATIVE COVER

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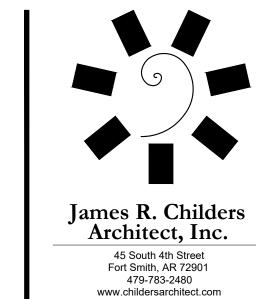
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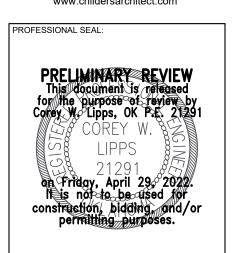
PROVIDED BY THE SURVEYOR OR ENGINEER. ANY DISCREPANCIES SHOULD

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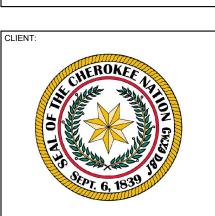


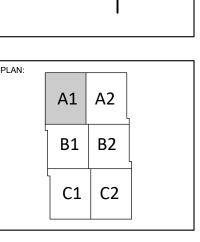












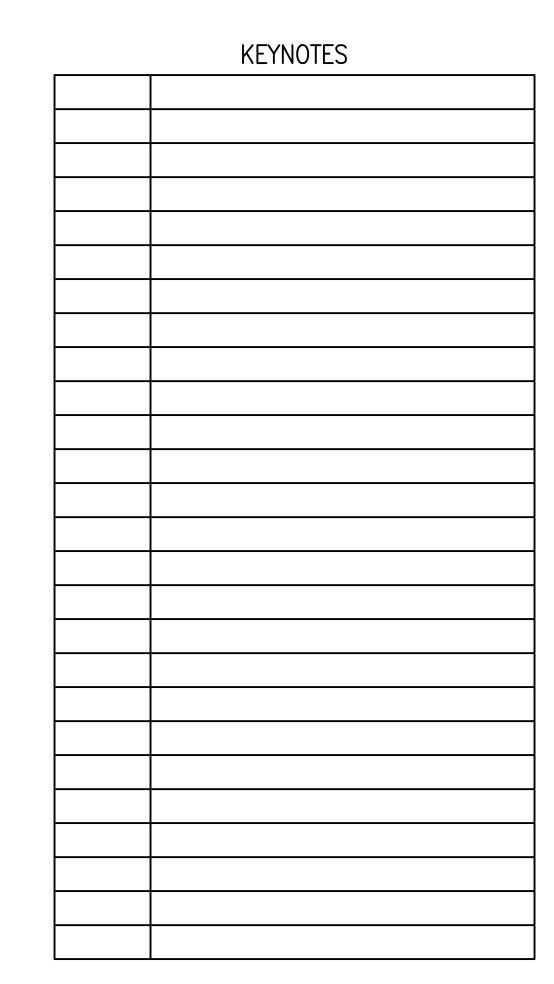
PROJECT PHASE: SCHEMATIC DESIGN

	REVISIONS
	1,27,6,6,10

21-08.21 05-06-22

C3-102

A1 SITE PLAN



HARDSCAPE PATTERNS

CONCRETE SIDEWALKS LIGHT DUTY CONCRETE PAVING

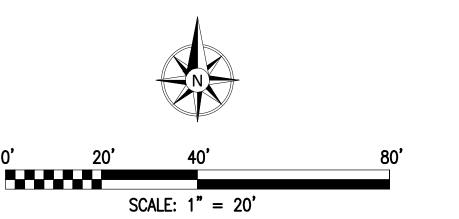
MEDIUM DUTY CONCRETE PAVING HEAVY DUTY CONCRETE PAVING REINFORCED HEAVY DUTY CONCRETE PAVING

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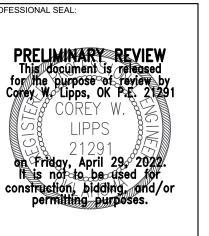
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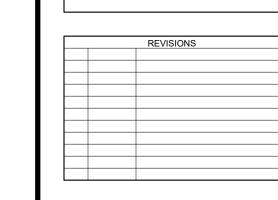








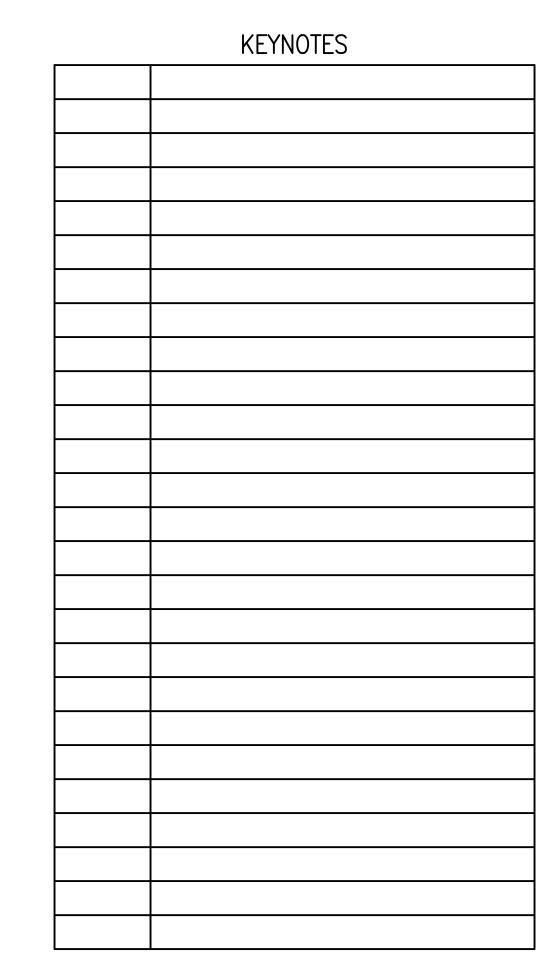
SCHEMATIC DESIGN



21-08.21 05-06-22

C3-103

N 346086.8938 E 2872782.6479



N 346093.0860 E 2872986.5539

HARDSCAPE PATTERNS

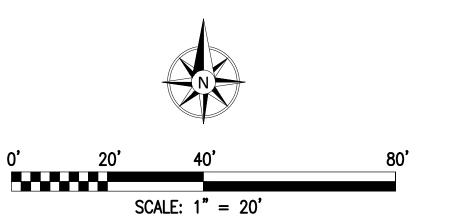
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LIGHT DUTY CONCRETE PAVING MEDIUM DUTY CONCRETE PAVING HEAVY DUTY CONCRETE PAVING REINFORCED HEAVY DUTY CONCRETE PAVING

SODDING / SEEDING / VEGETATIVE COVER

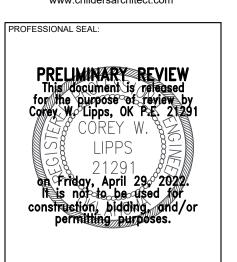
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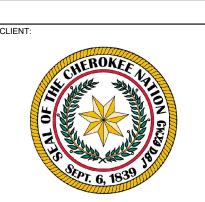




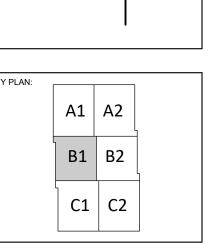
James R. Childers Architect, Inc. 45 South 4th Street Fort Smith, AR 72901 479-783-2480 www.childersarchitect.com







CHEROKI W.W. HASTINGS REP



PROJECT PHASE: SCHEMATIC DESIGN

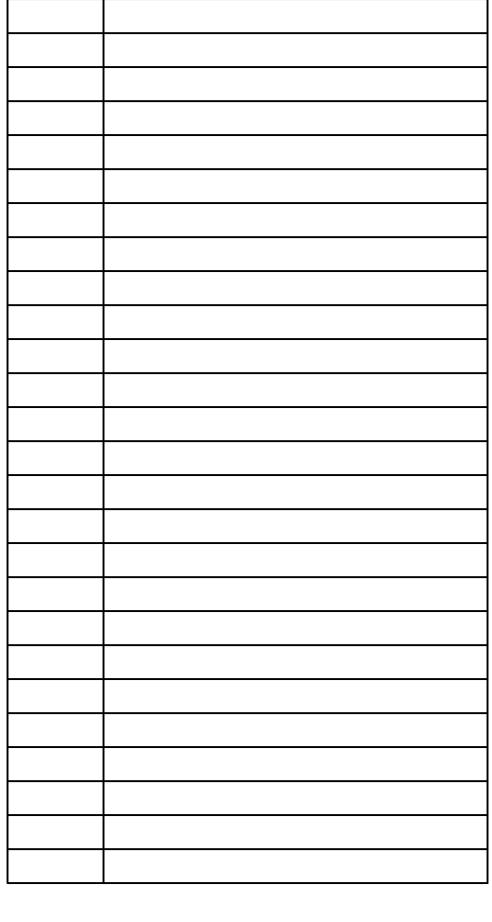
REVISIONS	

21-08.21 05-06-22

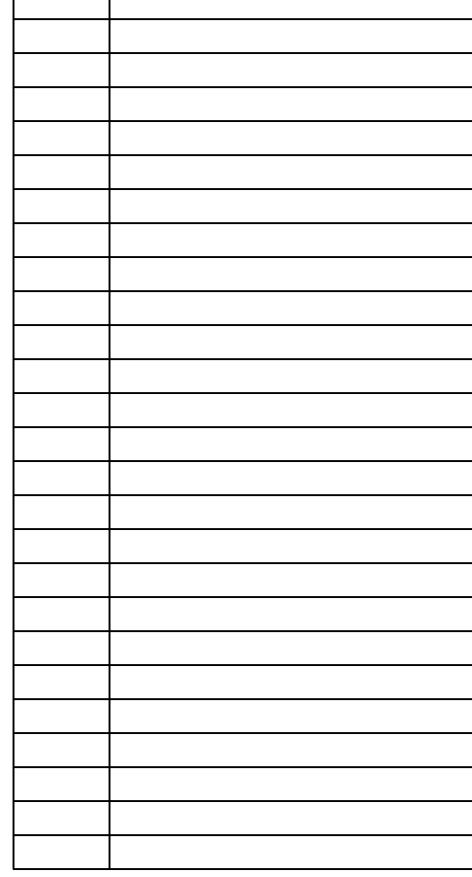
B1 SITE PLAN

N 346086.8938 E 2872782.6479

N 345890.9841 E 2872788.5973



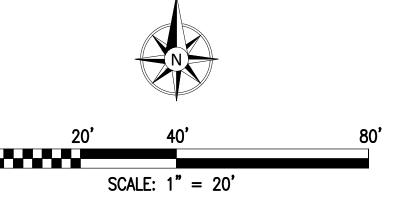
KEYNOTES



LLS 5534

REINFORCED HEAVY DUTY CONCRETE PAVING SODDING / SEEDING / VEGETATIVE COVER

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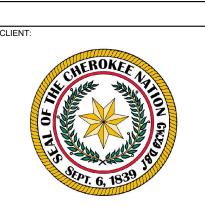
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> N 345963.9394 E 2873082.5182







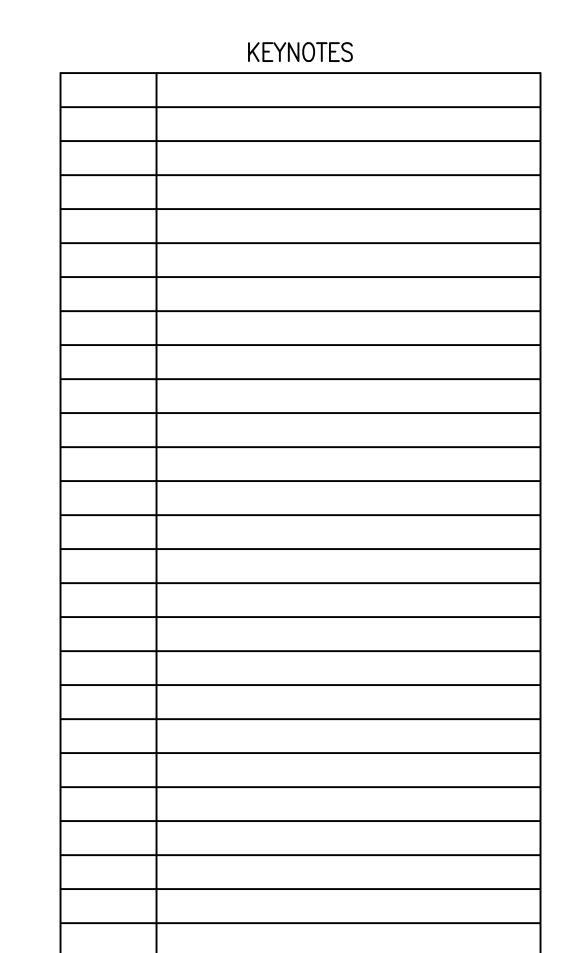


SCHEMATIC DESIGN

21-08.21 05-06-22 SHEET NUMBER: C3-105

B2 SITE PLAN

N 345699.0726



HARDSCAPE PATTERNS

CONCRETE SIDEWALKS

LIGHT DUTY CONCRETE PAVING

MEDIUM DUTY CONCRETE PAVING

HEAVY DUTY CONCRETE PAVING

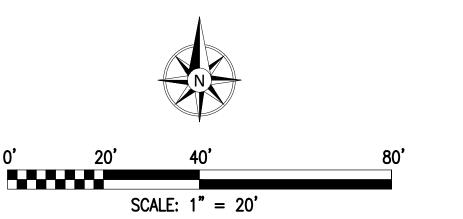
REINFORCED HEAVY DUTY CONCRETE PAVING

SODDING / SEEDING / VEGETATIVE COVER

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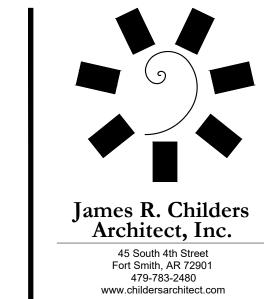
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C1



PRELIMINARY REVIEW
This document is released for the purpose of review by Corey W. Lipps, OK P.E. 21291
COREY W. LIPPS
21291
on Fridgy, April 29, 2022.
It is not to be used for construction, bidding, and/or permitting purposes.

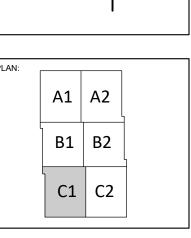




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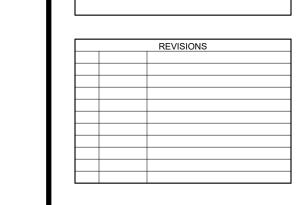
S REPLACEMENT HO
TAHLEQUAH, OKLAHOMA

W.W. HASTINGS REPLA



PROJECT PHASE:

SCHEMATIC DESIGN



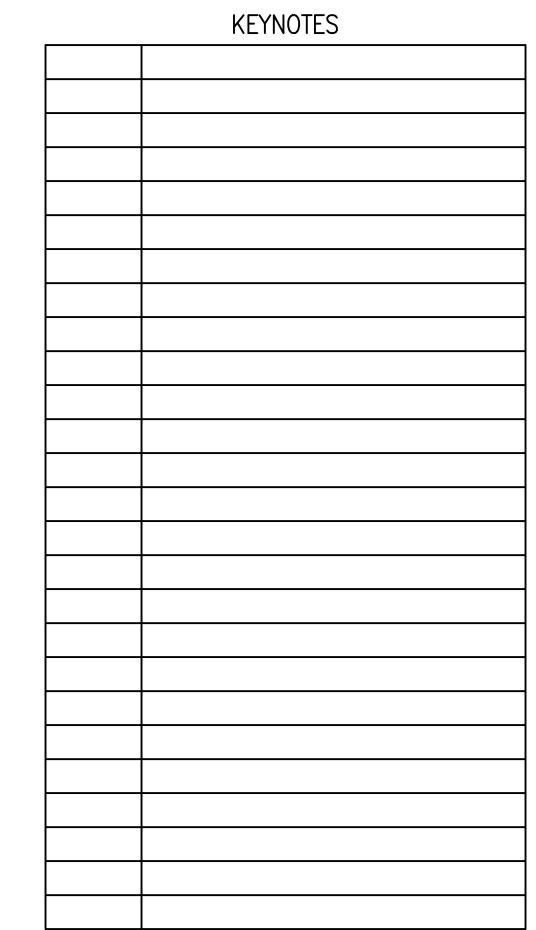
21-08.21

DATE: 05-06-22

SHEET NUMBER: 05-06-22

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C1 SITE PLAN



HARDSCAPE PATTERNS

CONCRETE SIDEWALKS LIGHT DUTY CONCRETE PAVING MEDIUM DUTY CONCRETE PAVING

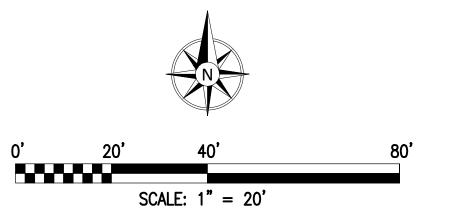
HEAVY DUTY CONCRETE PAVING REINFORCED HEAVY DUTY CONCRETE PAVING SODDING / SEEDING / VEGETATIVE COVER

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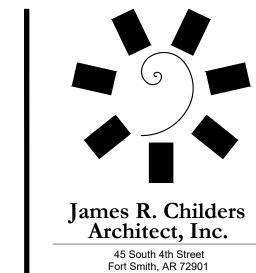
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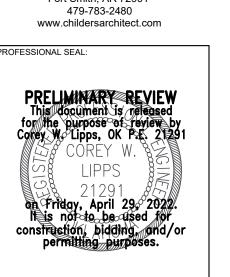
BE IMMEDIATELY BROUGHT TO THE ENGINEER'S AND SURVEYOR'S ATTENTION.

THE UNDERGROUND UTILITIES.

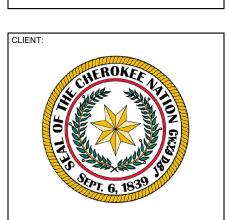




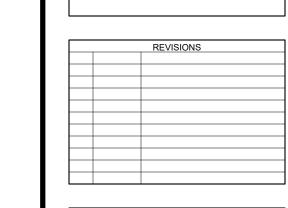






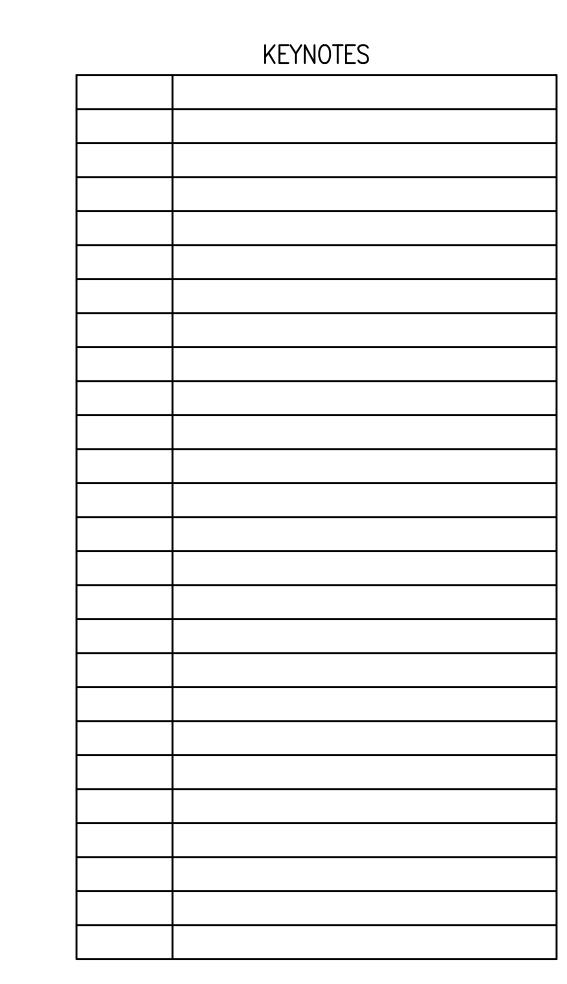


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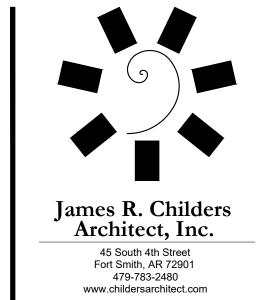


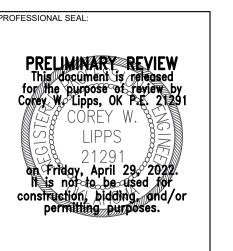
21-08.21 05-06-22 SHEET NUMBER: C3-107

C2 SITE PLAN

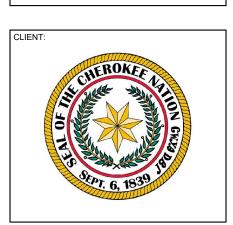


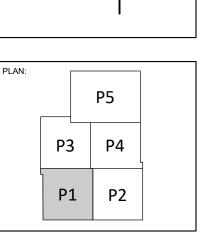
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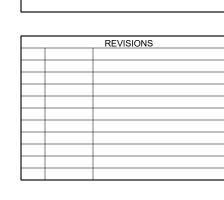








SCHEMATIC DESIGN



21-08.21 05-06-22 C3-108

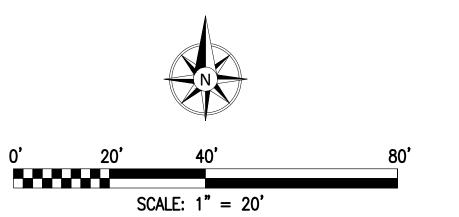
P1 SITE PLAN

LIGHT DUTY CONCRETE PAVING MEDIUM DUTY CONCRETE PAVING HEAVY DUTY CONCRETE PAVING REINFORCED HEAVY DUTY CONCRETE PAVING

SODDING / SEEDING / VEGETATIVE COVER

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HARDSCAPE PATTERNS

CONCRETE SIDEWALKS

LIGHT DUTY CONCRETE PAVING MEDIUM DUTY CONCRETE PAVING HEAVY DUTY CONCRETE PAVING

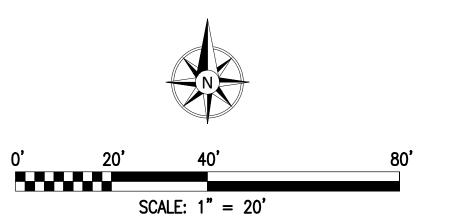
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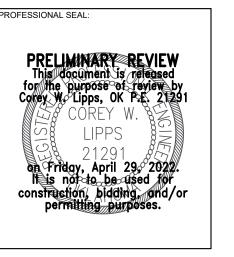
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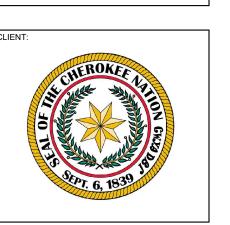


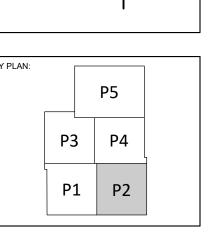


SURVEY INFORMATION IS CURRENTLY NOT AVAILABLE. James R. Childers Architect, Inc. 45 South 4th Street Fort Smith, AR 72901 479-783-2480 www.childersarchitect.com

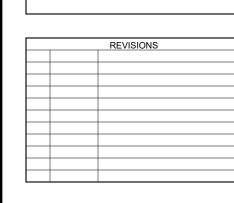








SCHEMATIC DESIGN



21-08.21 05-06-22 C3-109

P2 SITE PLAN

HARDSCAPE PATTERNS

CONCRETE SIDE

LIGHT DUTY CO

MEDIUM DUTY CO

HEAVY DUTY CO

CONCRETE SIDEWALKS

LIGHT DUTY CONCRETE PAVING

MEDIUM DUTY CONCRETE PAVING

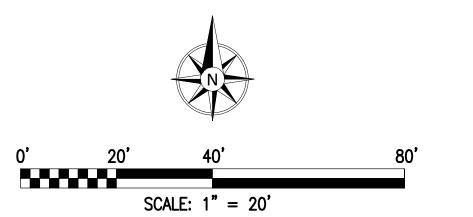
HEAVY DUTY CONCRETE PAVING

REINFORCED HEAVY DUTY CONCRETE PAVING

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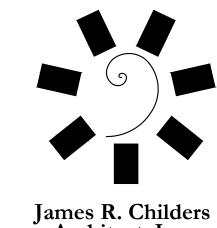
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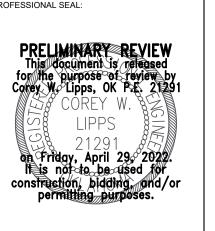
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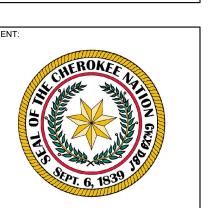


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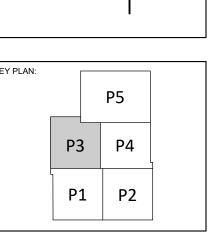






HOSPITAL

W.W. HASTINGS REPLACEMENT



PROJECT PHASE:

SCHEMATIC DESIGN

DE1/10/10/10			
		REVISIONS	

JOB NUMBER: 21-08.21

DATE: 05-06-22

SHEET NUMBER: C3-110

P3 SITE PLAN

HARDSCAPE PATTERNS

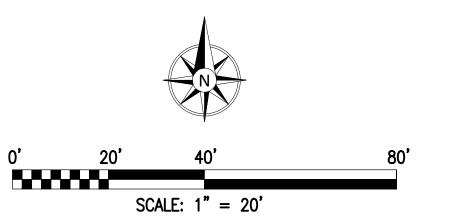
CONCRETE SIDEWALKS LIGHT DUTY CONCRETE PAVING MEDIUM DUTY CONCRETE PAVING

HEAVY DUTY CONCRETE PAVING REINFORCED HEAVY DUTY CONCRETE PAVING SODDING / SEEDING / VEGETATIVE COVER

UTILITY WARNING:
THE UNDERGROUND UTILITIES SHOWN HAVE BEEN LOCATED FROM RECORD DOCUMENTS OR FIELD LOCATIONS BY THE OPERATOR. THE SURVEYOR MAKES NO GUARANTEE THAT THE UNDERGROUND UTILITIES SHOWN COMPRISE ALL SUCH UTILITIES IN THE AREA EITHER IN SERVICE OR ABANDONED. THE SURVEYOR FURTHER DOES NOT WARRANT THAT THE UNDERGROUND UTILITIES SHOWN ARE IN THE EXACT LOCATION INDICATED ALTHOUGH THE SURVEYOR DOES CERTIFY THAT THEY ARE LOCATED AS ACCURATELY AS POSSIBLE FROM THE INFORMATION AVAILABLE. THE SURVEYOR HAS NOT PHYSICALLY LOCATED THE UNDERGROUND UTILITIES.

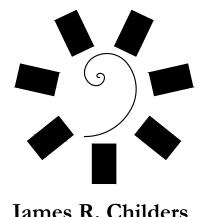
UTILITY ELEVATIONS AND SIZES MAY HAVE BEEN MEASURED UNDER ADVERSE FIELD CONDITIONS. UPON EXPOSING THE UTILITY, ELEVATIONS AND LINE SIZES SHOULD BE VERIFIED BY THE CONTRACTOR PRIOR TO CONSTRUCTION. CONTRACTOR SHOULD VERIFY CRITICAL ELEVATIONS USING THE BENCHMARK PROVIDED BY THE SURVEYOR OR ENGINEER. ANY DISCREPANCIES SHOULD

BE IMMEDIATELY BROUGHT TO THE ENGINEER'S AND SURVEYOR'S ATTENTION.

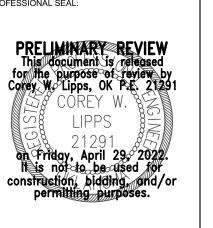




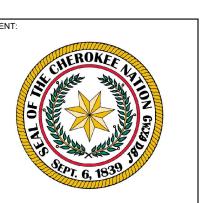
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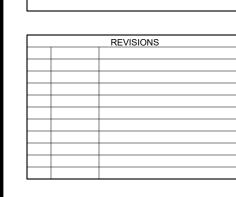
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SCHEMATIC DESIGN



21-08.21 05-06-22 C3-111

P4 SITE PLAN

HARDSCAPE PATTERNS

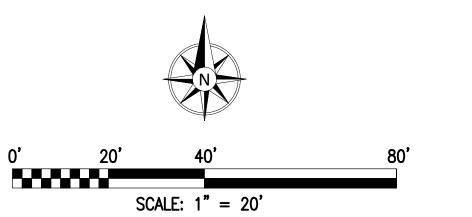
CONCRETE SIDEWALKS LIGHT DUTY CONCRETE PAVING

MEDIUM DUTY CONCRETE PAVING HEAVY DUTY CONCRETE PAVING REINFORCED HEAVY DUTY CONCRETE PAVING SODDING / SEEDING / VEGETATIVE COVER

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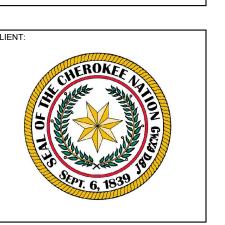
BE IMMEDIATELY BROUGHT TO THE ENGINEER'S AND SURVEYOR'S ATTENTION.



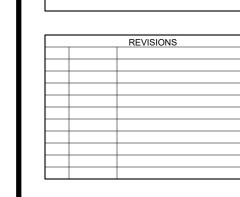


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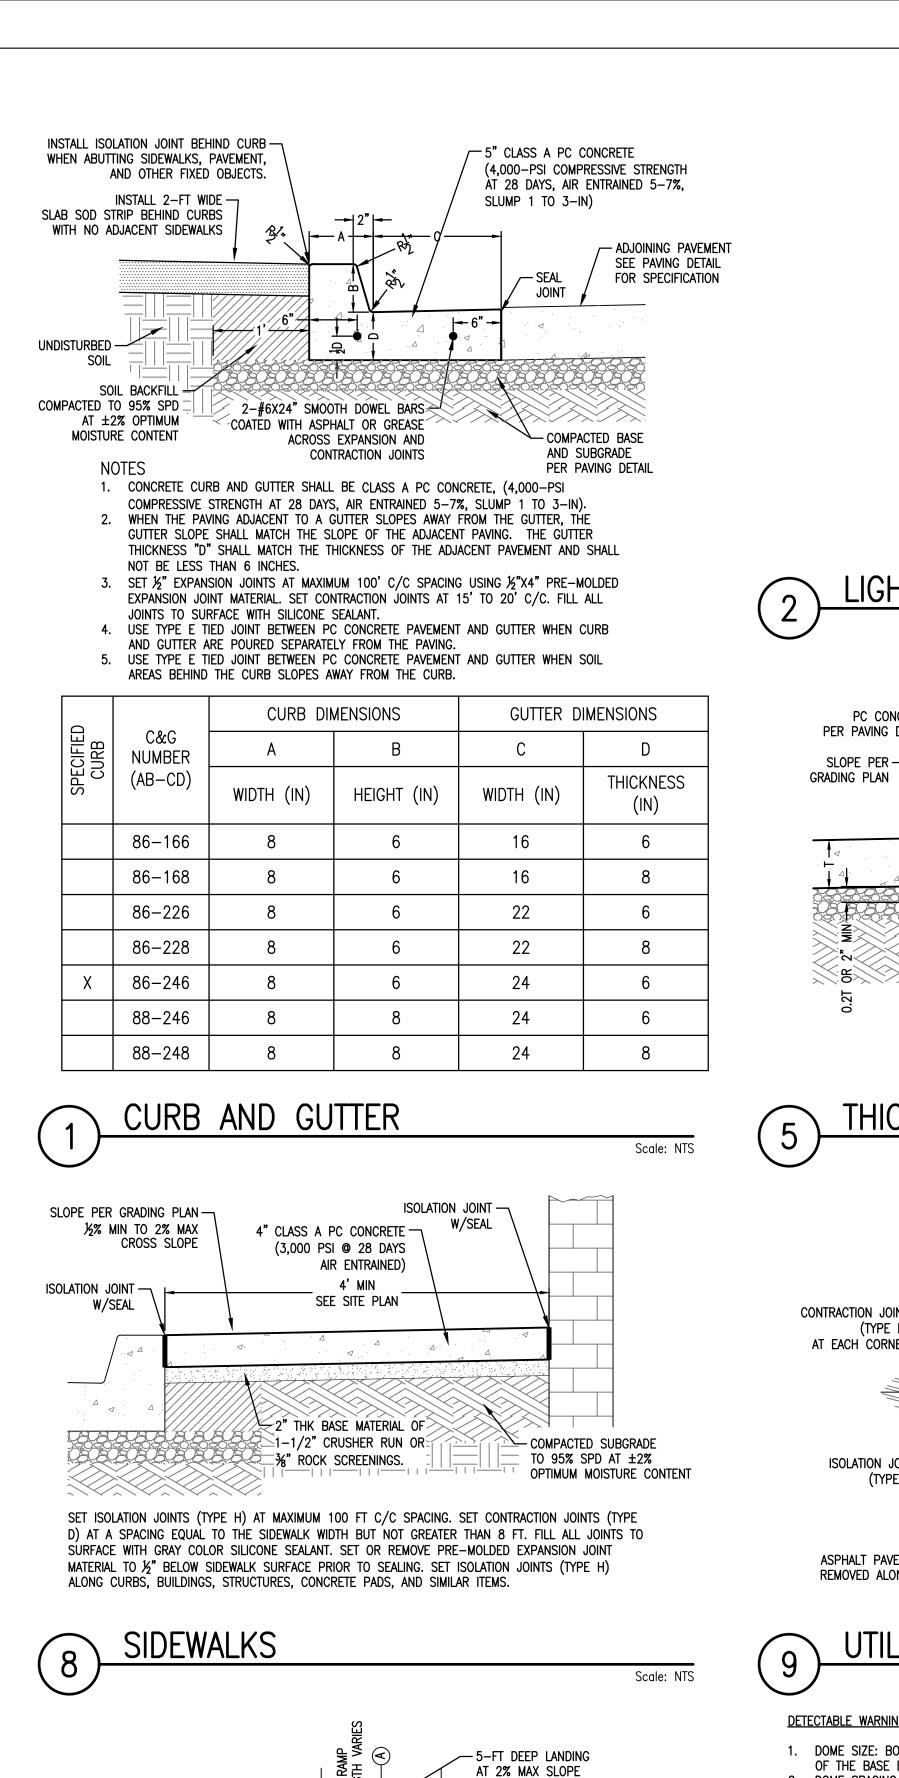




SCHEMATIC DESIGN



21-08.21 05-06-22 C3-112



EACH WAY

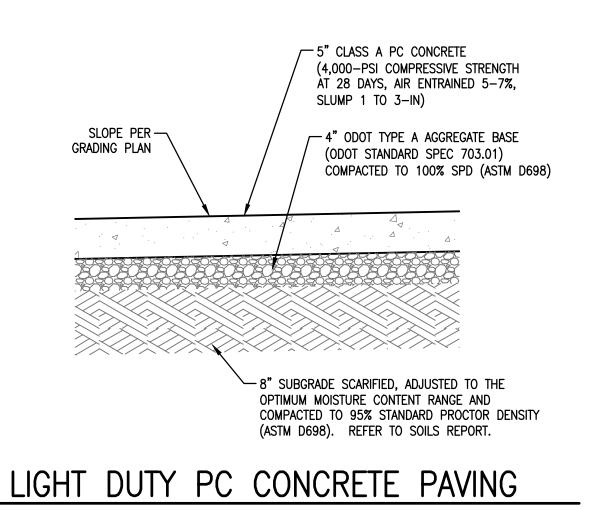
— 2-FT WIDE DETECTABLE

WARNING SURFACE SET

AT 8-IN FROM GUTTER

FLARED SLOPE

- BARRIER CURB PER PLAN



TOOL EDGE %" RADIUS. —

JOINT SEALER.

— ADJOINING PAVEMENT

SEE PAVING DETAIL

FOR SPECIFICATION

Scale: NTS

Scale: NTS

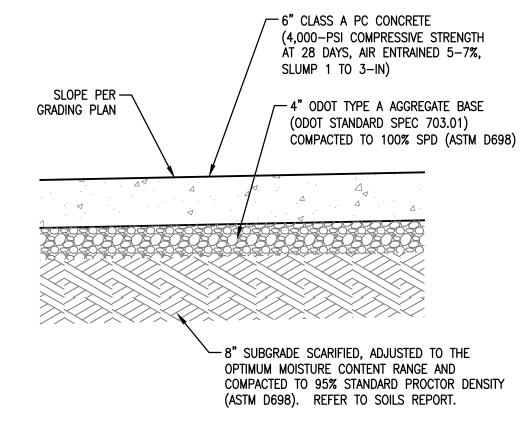
SEAL WITH HOT POURED

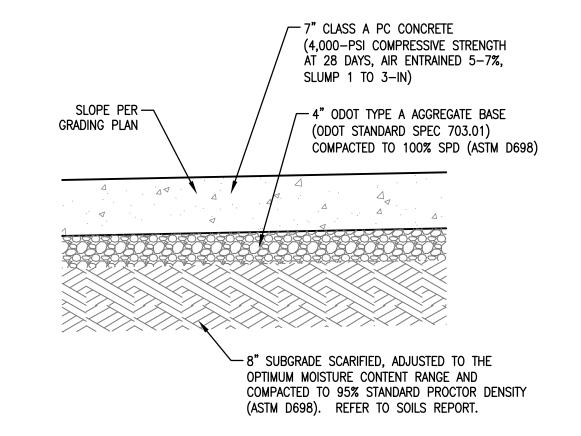
HICKENED CONCRETE EDGE

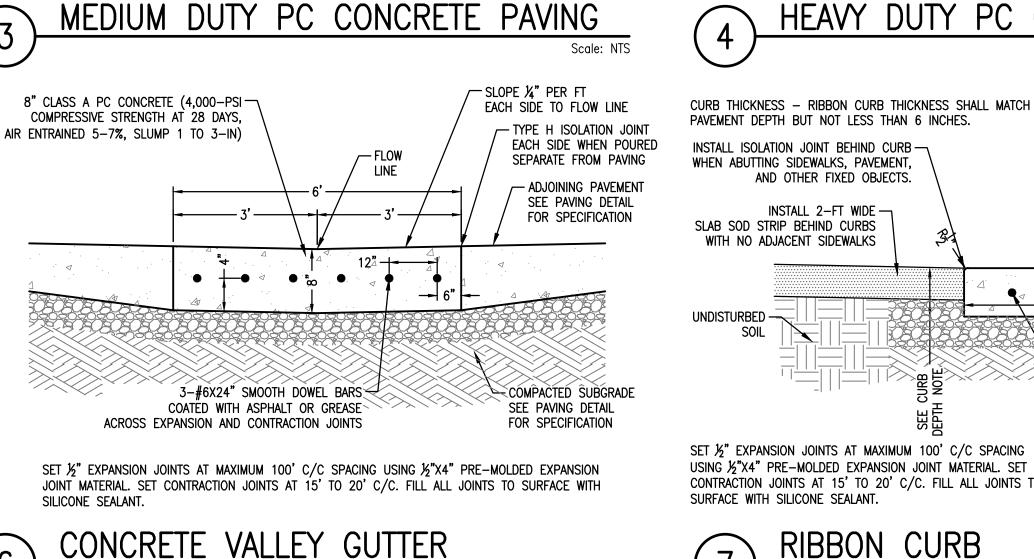
PC CONCRETE -

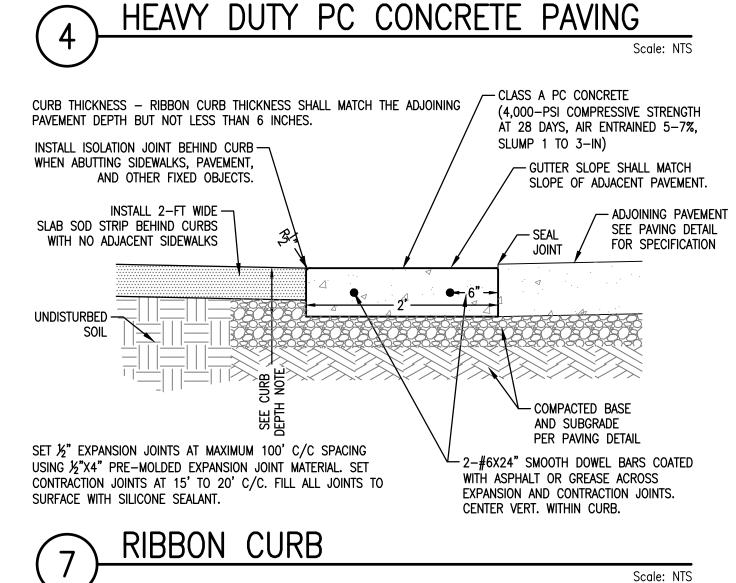
PER PAVING DETAIL

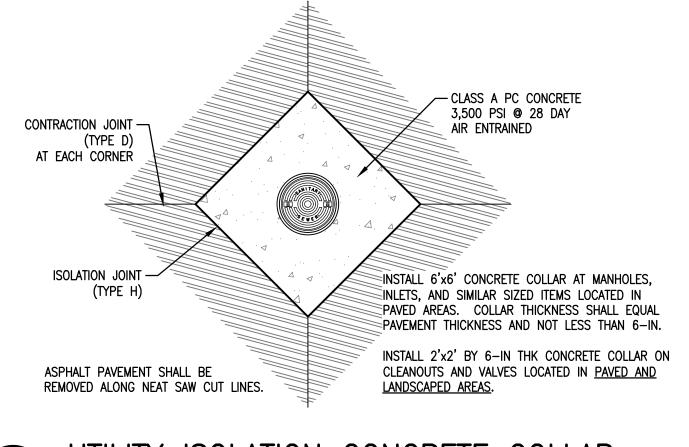
SLOPE PER —







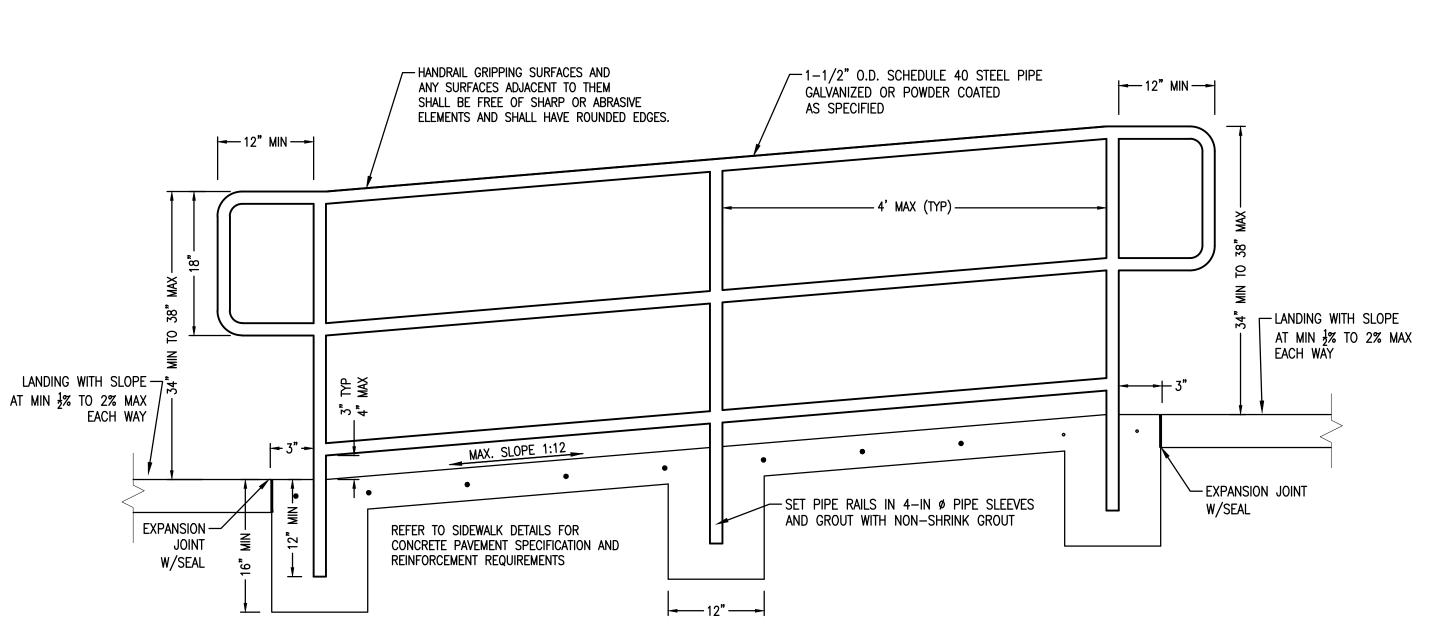


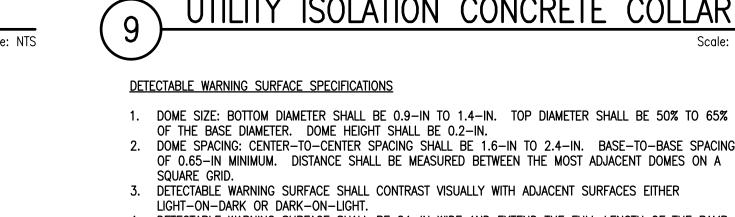


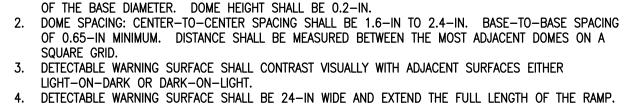
- COMPACTED BASE

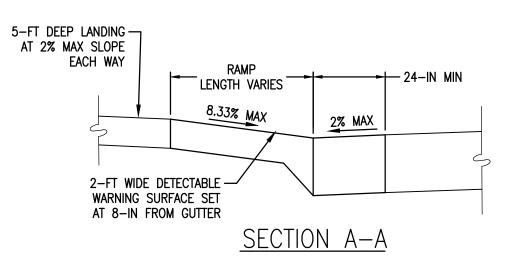
PER PAVING DETAIL

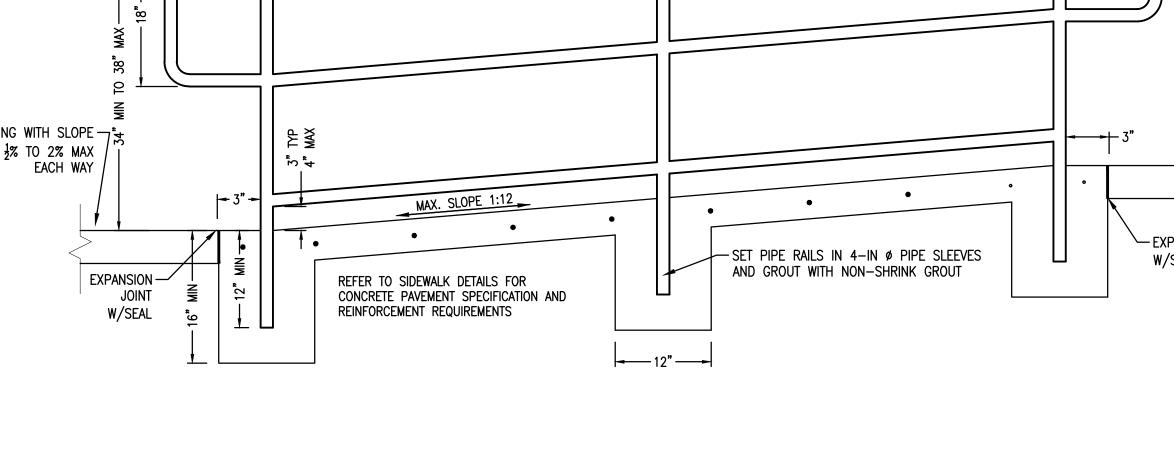
AND SUBGRADE











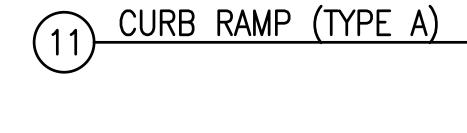
5-FT DEEP LANDING

AT 2% MAX SLOPE

EACH WAY

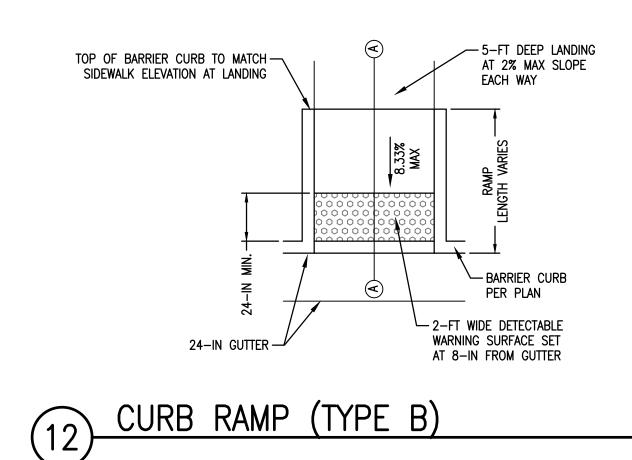
— Barrier Curb Per Plan

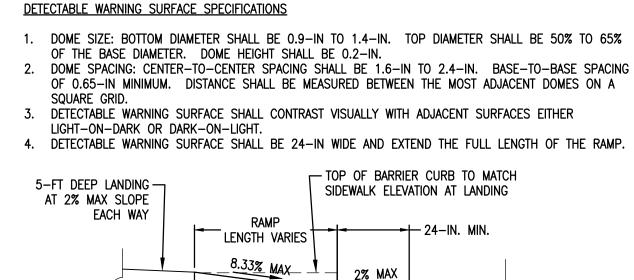
Scale: NTS

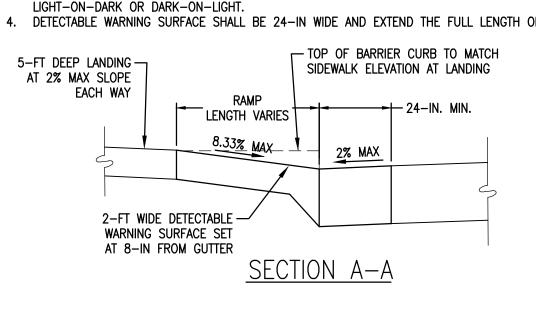


FLARED SLOPE

24-IN GUTTER -









_ Length varies _

8.33% MAX.

24-IN GUTTER-

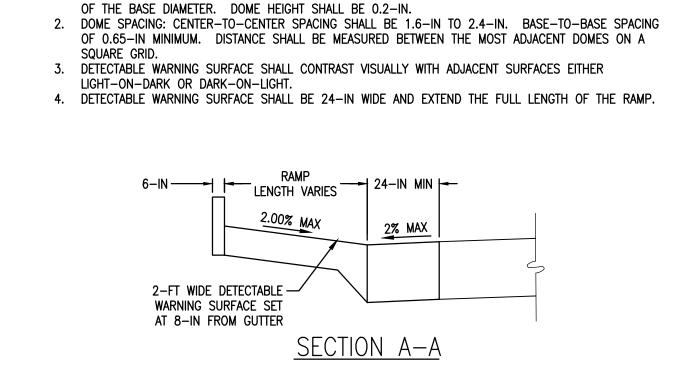
HANDRAILS AT ACCESSIBLE RAMP

__6−IN WIDE CURB

8.33% MAX.

2-FT WIDE DETECTABLE WARNING SURFACE SET

AT 8-IN FROM GUTTER



DOME SIZE: BOTTOM DIAMETER SHALL BE 0.9-IN TO 1.4-IN. TOP DIAMETER SHALL BE 50% TO 65%

DETECTABLE WARNING SURFACE SPECIFICATIONS

Scale: NTS

Scale: NTS



James R. Childers

Architect, Inc.

PROFESSIONAL SEAL:

45 South 4th Street Fort Smith, AR 72901 479-783-2480 www.childersarchitect.com

PRELIMINARY REVIEW
This document is released for the purpose of review by Corey W. Lipps, OK P.E. 2



EH CH

PROJECT PHASE: **SCHEMATIC DESIGN**

21-08.21 05-06-22

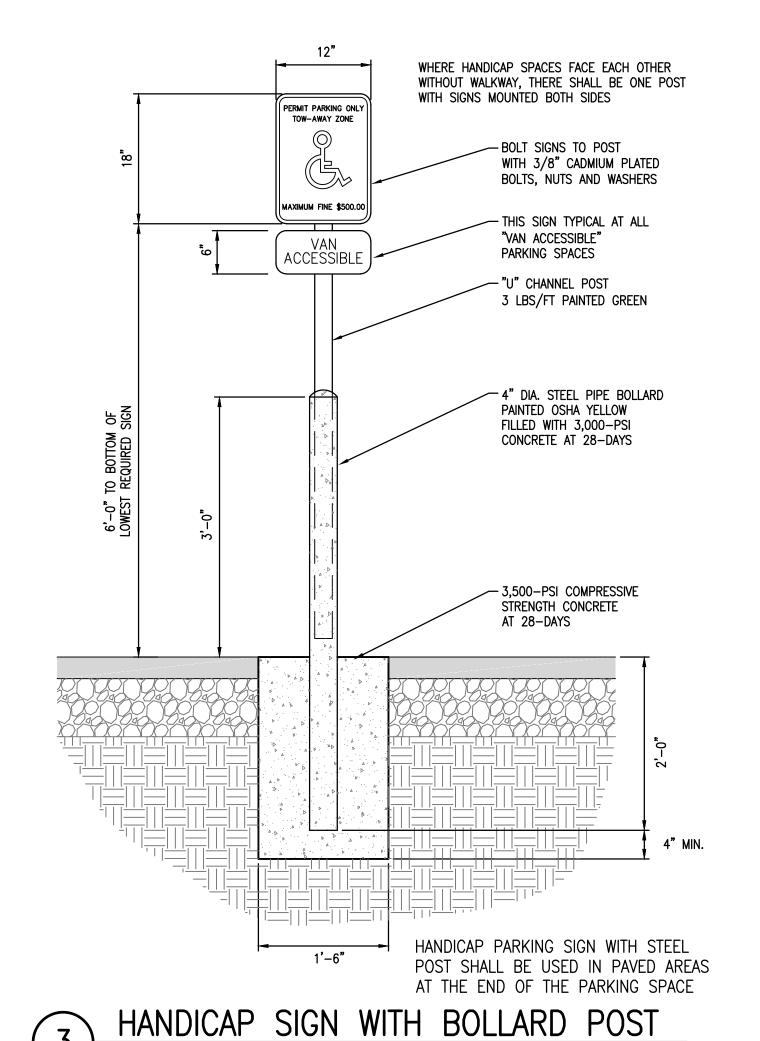
C3-501

SITE DETAILS

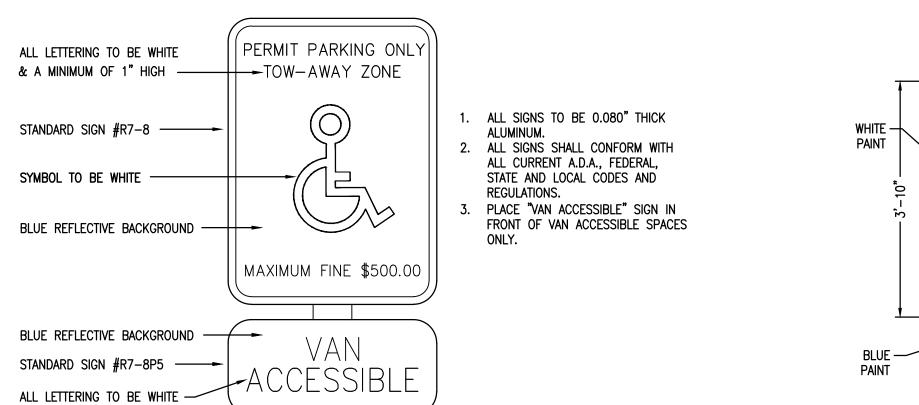
PARKING SPACE LINES SHALL BE PAINTED WHITE. HANDICAPPED ACCESS AISLES AND NO PARKING AREAS SHALL BE PAINTED YELLOW. HANDICAPPED PARKING SPACE SYMBOLS SHALL BE PAINTED BLUE AND WHITE AS SHOWN IN DETAIL PROVIDED. FIRELANE STRIPING SHALL BE PAINTED RED. PAVEMENT STRIPING SHALL BE APPLIED IN TWO COATS, FOUR (4) INCHES WIDE, UNLESS SHOWN OTHERWISE ON THE PLANS.

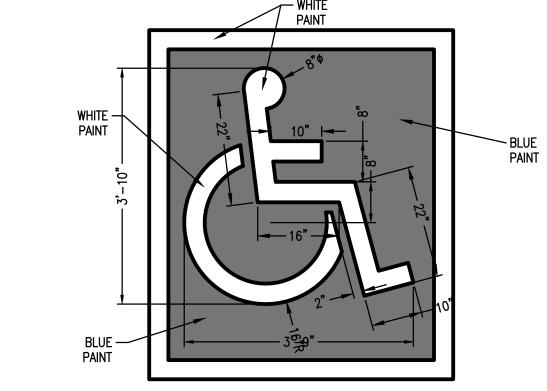
BOLT SIGNS TO POST WITH 3/8" CADMIUM PLATED PERMIT PARKING ONLY
TOW-AWAY ZONE BOLTS, NUTS AND WASHERS — THIS SIGN TYPICAL AT ALL "VAN ACCESSIBLE" PARKING SPACES VAN ACCESSIBLE ← 2−3/8" DIA. GALVANIZED STEEL POST WITH 0.065-IN WALL THICKNESS OR GREATER - WHEN INSTALLED IN PAVEMENT, TOP OF CONCRETE SHALL MATCH PAVEMENT. WHEN INSTALLED IN SOIL, TOP OF CONCRETE SHALL EXTEND 2-IN ABOVE GRADE WITH A 1-IN CROWN. √ 3,500−PSI COMPRESSIVE STRENGTH CONCRETE AT 28-DAYS HANDICAP PARKING SIGN WITH STEEL POST SHALL BE USED IN LANDSCAPED AREAS BEHIND THE SIDEWALK HANDICAP SIGN WITH STEEL POST

Scale: NTS



PARKING SPACE PAINT STRIPING

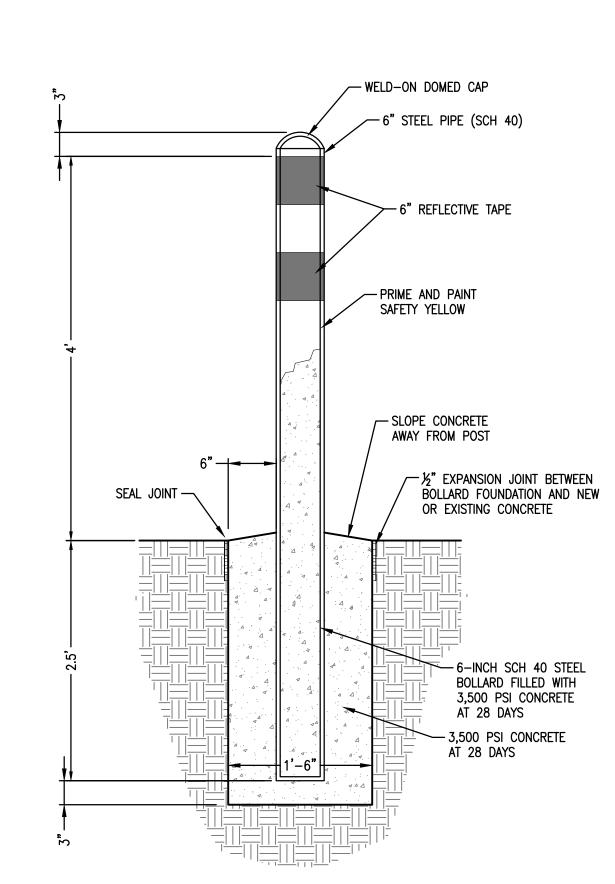


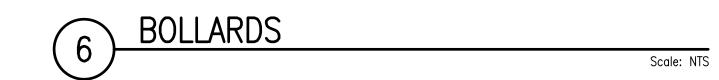




& A MINIMUM OF 1" HIGH







CHEROKE HASTINGS REPL

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PRELIMINARY REVIEW
This document is refersed for the purpose of review by Correy W. Lipps, OK P.E. 2139

14101 Wireless Way, Suite 350 Oklahoma City, OK 73134 405-832-9900

www.parkhill.com Oklahoma CA #7110, Expires 6/30/2022

PROFESSIONAL SEAL:

CONSULTANT LOGO:

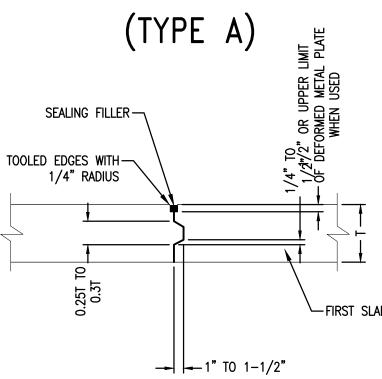
SCHEMATIC DESIGN

C3-502

SITE DETAILS

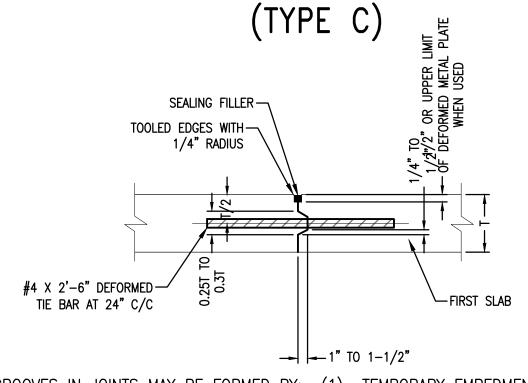
SMOOTH DOWEL BARS ACROSS EXPANSION JOINTS SHALL BE PROVIDED WITH EXPANSION CAPS, AND COATED WITH ASPHALT OR GREASE. GROOVES IN JOINTS MAY BE FORMED BY: (1) TEMPORARY EMBEDMENT OF A SUITABLE MANDREL, (2) INSTALLATION OF A THIN STRIP OF PREMOULDED JOINT FILLER MATERIAL, (3) SAWING THE PAVEMENT AFTER THE CONCRETE HAS HARDENED.

EXPANSION JOINT



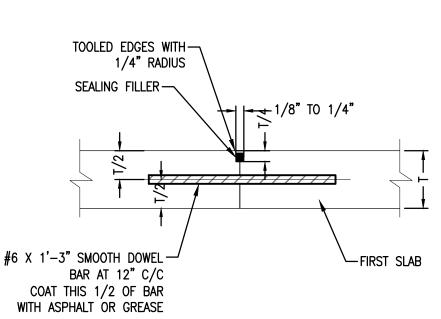
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TONGUE & GROOVE CONSTRUCTION JOINT



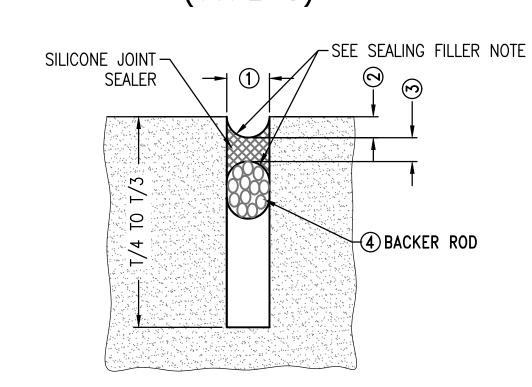
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TIED CONSTRUCTION JOINT (TYPE E)

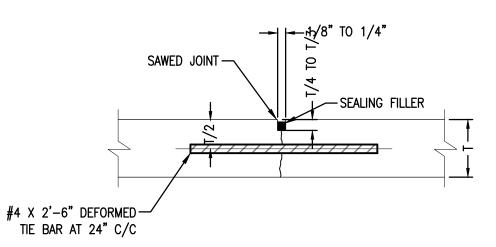


GROOVES IN JOINTS MAY BE FORMED BY: (1) TEMPORARY EMBEDMENT OF A SUITABLE MANDREL, (2) INSTALLATION OF A THIN STRIP OF PREMOULDED JOINT FILLER MATERIAL, (3) SAWING THE PAVEMENT AFTER THE CONCRETE HAS HARDENED.

DOWELED CONSTRUCTION JOINT (TYPE G)

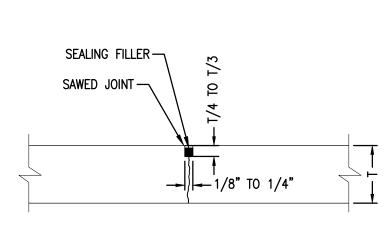


CONTRACTION JOINT SEALING FILLER



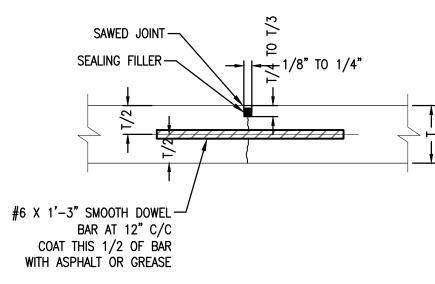
GROOVES IN JOINTS MAY BE FORMED BY: (1) TEMPORARY EMBEDMENT OF A SUITABLE MANDREL, (2) INSTALLATION OF A THIN STRIP OF PREMOULDED JOINT FILLER MATERIAL, (3) SAWING THE PAVEMENT AFTER THE CONCRETE HAS HARDENED.

TIED JOINT (TYPE B)



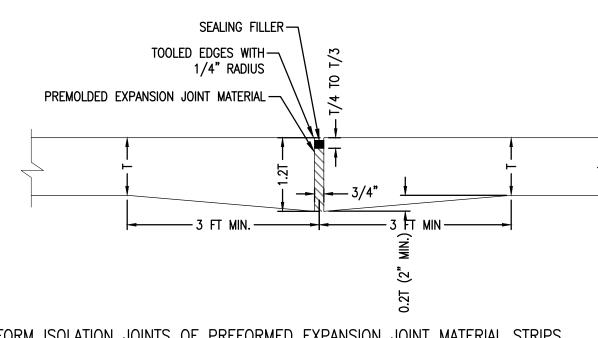
GROOVES IN JOINTS MAY BE FORMED BY: (1) TEMPORARY EMBEDMENT OF A SUITABLE MANDREL, (2) INSTALLATION OF A THIN STRIP OF PREMOULDED JOINT FILLER MATERIAL, (3) SAWING THE PAVEMENT AFTER THE CONCRETE HAS HARDENED.

CONTRACTION JOINT



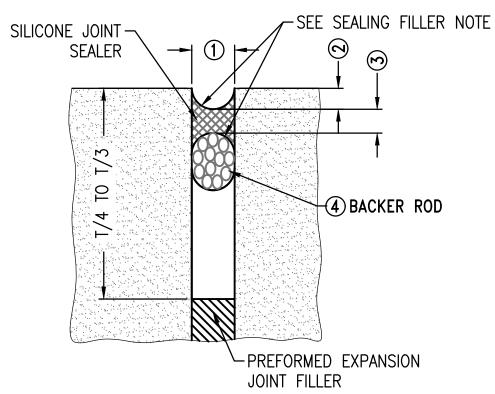
GROOVES IN JOINTS MAY BE FORMED BY: (1) TEMPORARY EMBEDMENT OF A SUITABLE MANDREL, (2) INSTALLATION OF A THIN STRIP OF PREMOULDED JOINT FILLER MATERIAL, (3) SAWING THE PAVEMENT AFTER THE CONCRETE

DOWELED CONTRACTION JOINT (TYPE F)



FORM ISOLATION JOINTS OF PREFORMED EXPANSION JOINT MATERIAL STRIPS ABUTTING CONCRETE CURBS, CATCH BASINS, MANHOLES, INLETS STRUCTURES, OTHER FIXED OBJECTS, AND WHERE INDICATED.

ISOLATION JOINT (TYPE H)



EXPANSION JOINTS / ISOLATION JOINTS SEALING FILLER

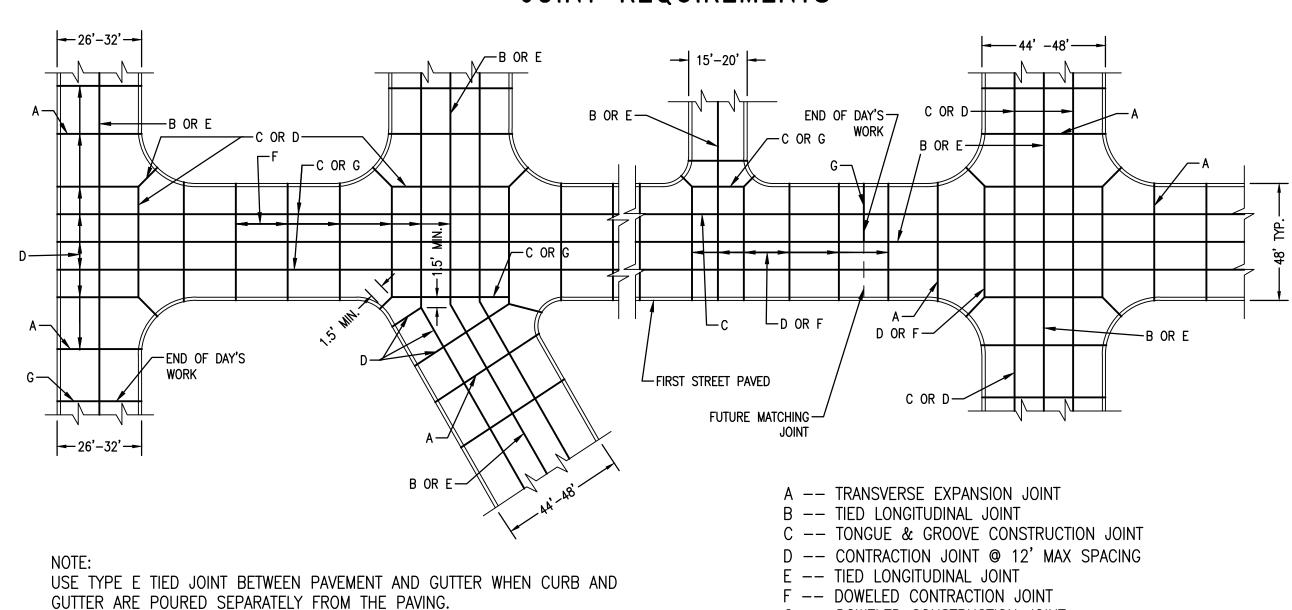
JOINT REQUIREMENTS

be used on the centerline joints of entrance drives.

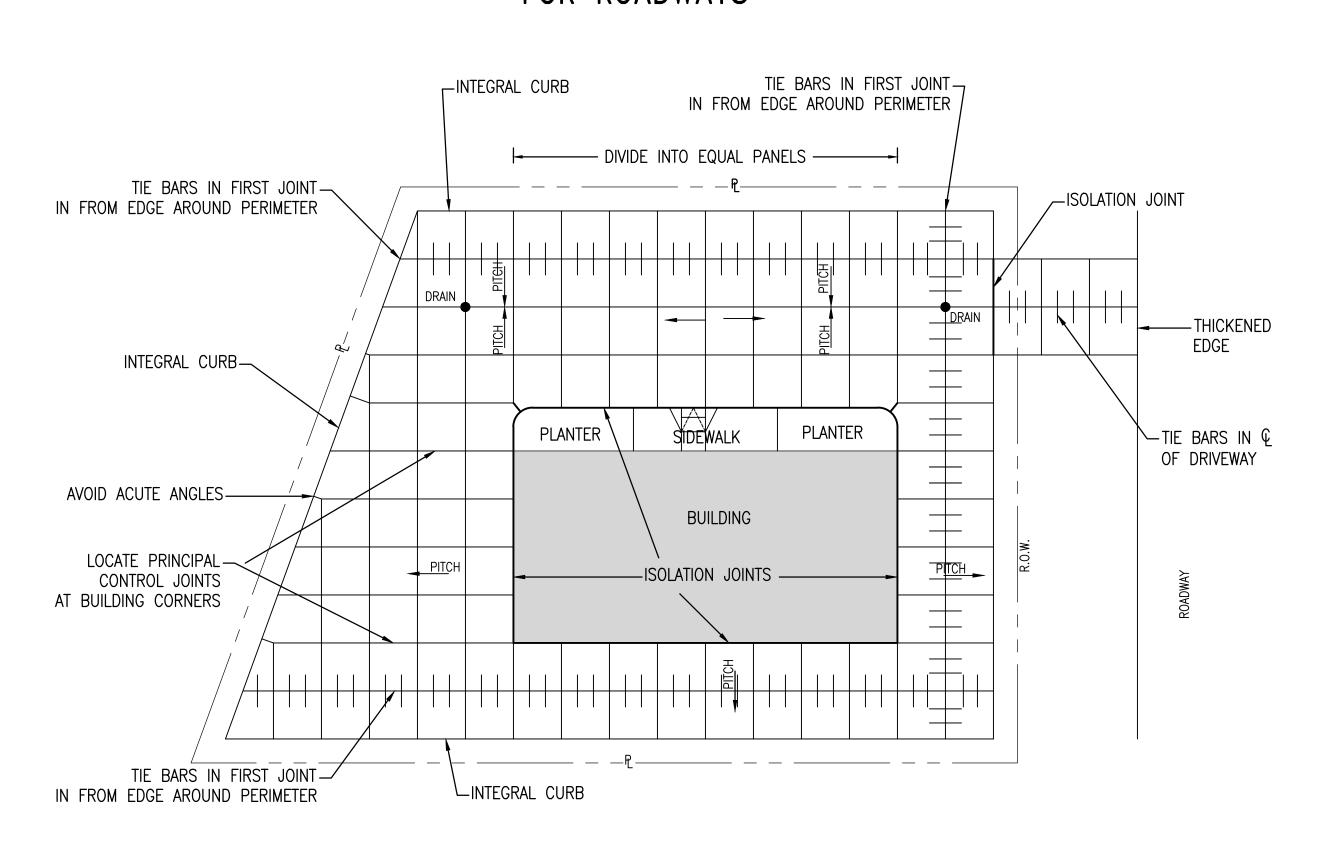
- Avoid odd-shaped slabs. The maximum transverse joint spacing for drives shall be 24 to 30 times the slab thickness or 15 ft,
- whichever is less. Divide the length between the concrete being placed into equally spaced joints. 3. Slabs shall be as square as possible. The length of a panel shall not be more than 25% greater than
- 4. All transverse contraction joints shall be continuous through the curb and have a depth equal to 1/4 to
- 5. In isolation joints, the filler shall be full depth and extend through the curb.
- 6. If there is no curb, longitudinal joints shall be tied with deformed tie bars. 7. Offsets at radius points shall be at least 1.5 ft wide. Joint intersection angles less than 60 degrees
- Minor adjustments in joint location made by shifting or skewing to meet inlets and manholes is allowable.
- 9. Place joints to meet drainage structures, if possible. 10. In parking lots, tie bars shall be used in the first longitudinal joint from the pavement edge to keep the outside slab from separating from the pavement. Tie bars are not required in the interior joints of parking lots and other wide paved areas because they are confined by surrounding slabs. Tie bars shall
- 11. Planned interruptions in paving shall have either a Doweled Construction Joint Type G or a Tongue and
- Groove Construction Joint Type C. 12. If curbs are poured separate from pavement, a Tied Construction Joint Type E shall be used between the
- curb and the pavement. 13. Where slabs of different paving thickness come together, the subgrade under the thinner pavement shall be sloped from a distance of 3 ft or more to provide a gradual transition to the larger pavement
- 14. Seal joints according to joint sealing details and specifications.
- 15. Submit joint layout plan to Engineer for approval prior to concrete placement. 16. See specifications 32 13 00 RIGID PAVING, 32 13 73 JOINT SEALANTS, and 32 16 13 CONCRETE CURBS AND GUTTERS for additional requirements.

SPACING BET	WEEN JOINTS
PAVEMENT THICKNESS, INCHES	MAXIMUM SPACING, FEET
4 AND 4.5	8
5 AND 5.5	10
6	12
OVER 6	15

JOINT REQUIREMENTS



TYPICAL JOINT LAYOUT DETAILS FOR ROADWAYS



TYPICAL JOINT LAYOUT DETAILS FOR PARKING LOTS

- FUNCTION OF SEALED JOINTS. THE JOINT SHAPE FACTOR IS DEFINED AS
- THE TOOLING OPERATION WILL FIRMLY PRESS THE FRESHLY APPLIED MATERIAL INTIMATELY AGAINST THE CUT SIDES OF THE RECESS AND THE BACKER ROD SURFACES. THE ROUNDED SHAPE ON TOP AND BOTTOM OF THE SILICONE ALLOWS THE SEALANT TO PROPERLY FLEX BUT MAINTAIN
- ADHERENCE TO THE PAVING. . SELF LEVELING SEALANTS WILL BE INSTALLED TO BE FLUSH WITH THE PAVEMENT SURFACE OR BY MANUFACTURER'S RECOMMENDATION.

EXP	ANSION JOINT TREATMEN	/ ISOLATION JONT TABLE	TAIC
JOINT WIDTH	SEALANT RECESS DEPTH 2	SILICONE SEALANT THICKNESS 3	BACKER AND DIAMETER 4
1/2"	3/8"	1/4"	5/8"
3/4"	3/8"	3/8"	7/8"
1"	3/8"	1/2"	1-1/4"
1-1/2"	1/2"	3/4"	2"
2"	1/2"	3/4"	2-1/2"

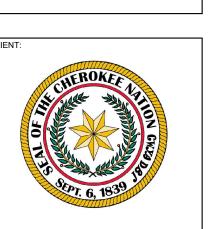
EXPANSION AND ISOLATION JOINT WIDTHS SHALL BE 3/4" UNLESS OTHERWISE SPECIFIED ON THE PLANS. TABLE VALUES AS SHOWN IN THIS TABLE SHALL BE USED IN THOSE SPECIFIED CASES.

SEALING FILLER TREATMENT TABLE

SEALING FILLER NOTES

Scale: NTS

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NATION

CHEROKE HASTINGS REPI

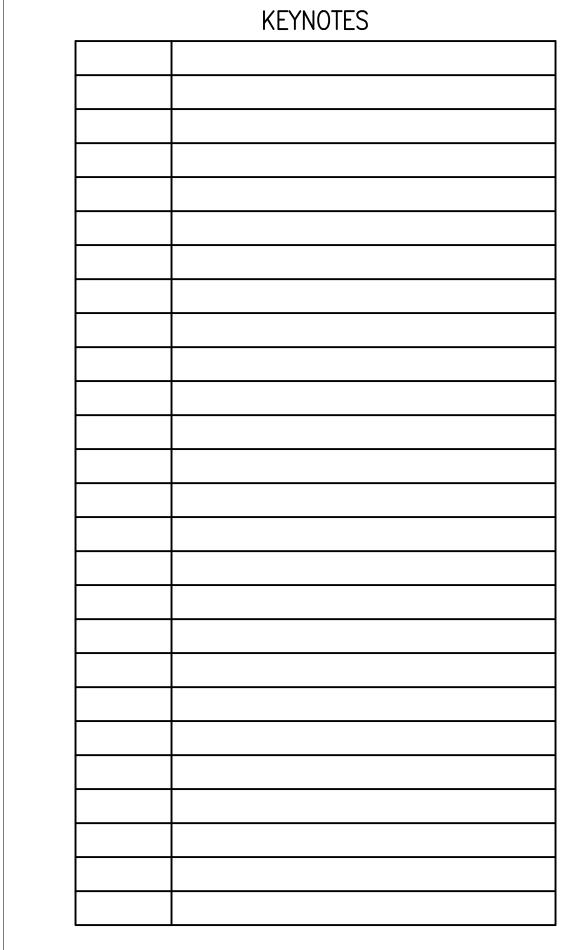
SCHEMATIC DESIGN

21-08.21 05-06-22

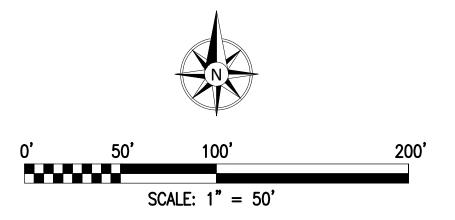
C3-503

CONCRETE PAVING

JOINT DETAILS



UTILITY	LEGEND					
ELEC.	STORM DRAIN	- E - E - G - O ₂ - SS - SD		E — E — G — O ₂ — SS — SD —	E E G O ₂ SS SD	
	******				 W SS	

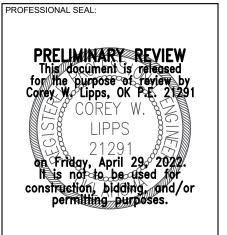


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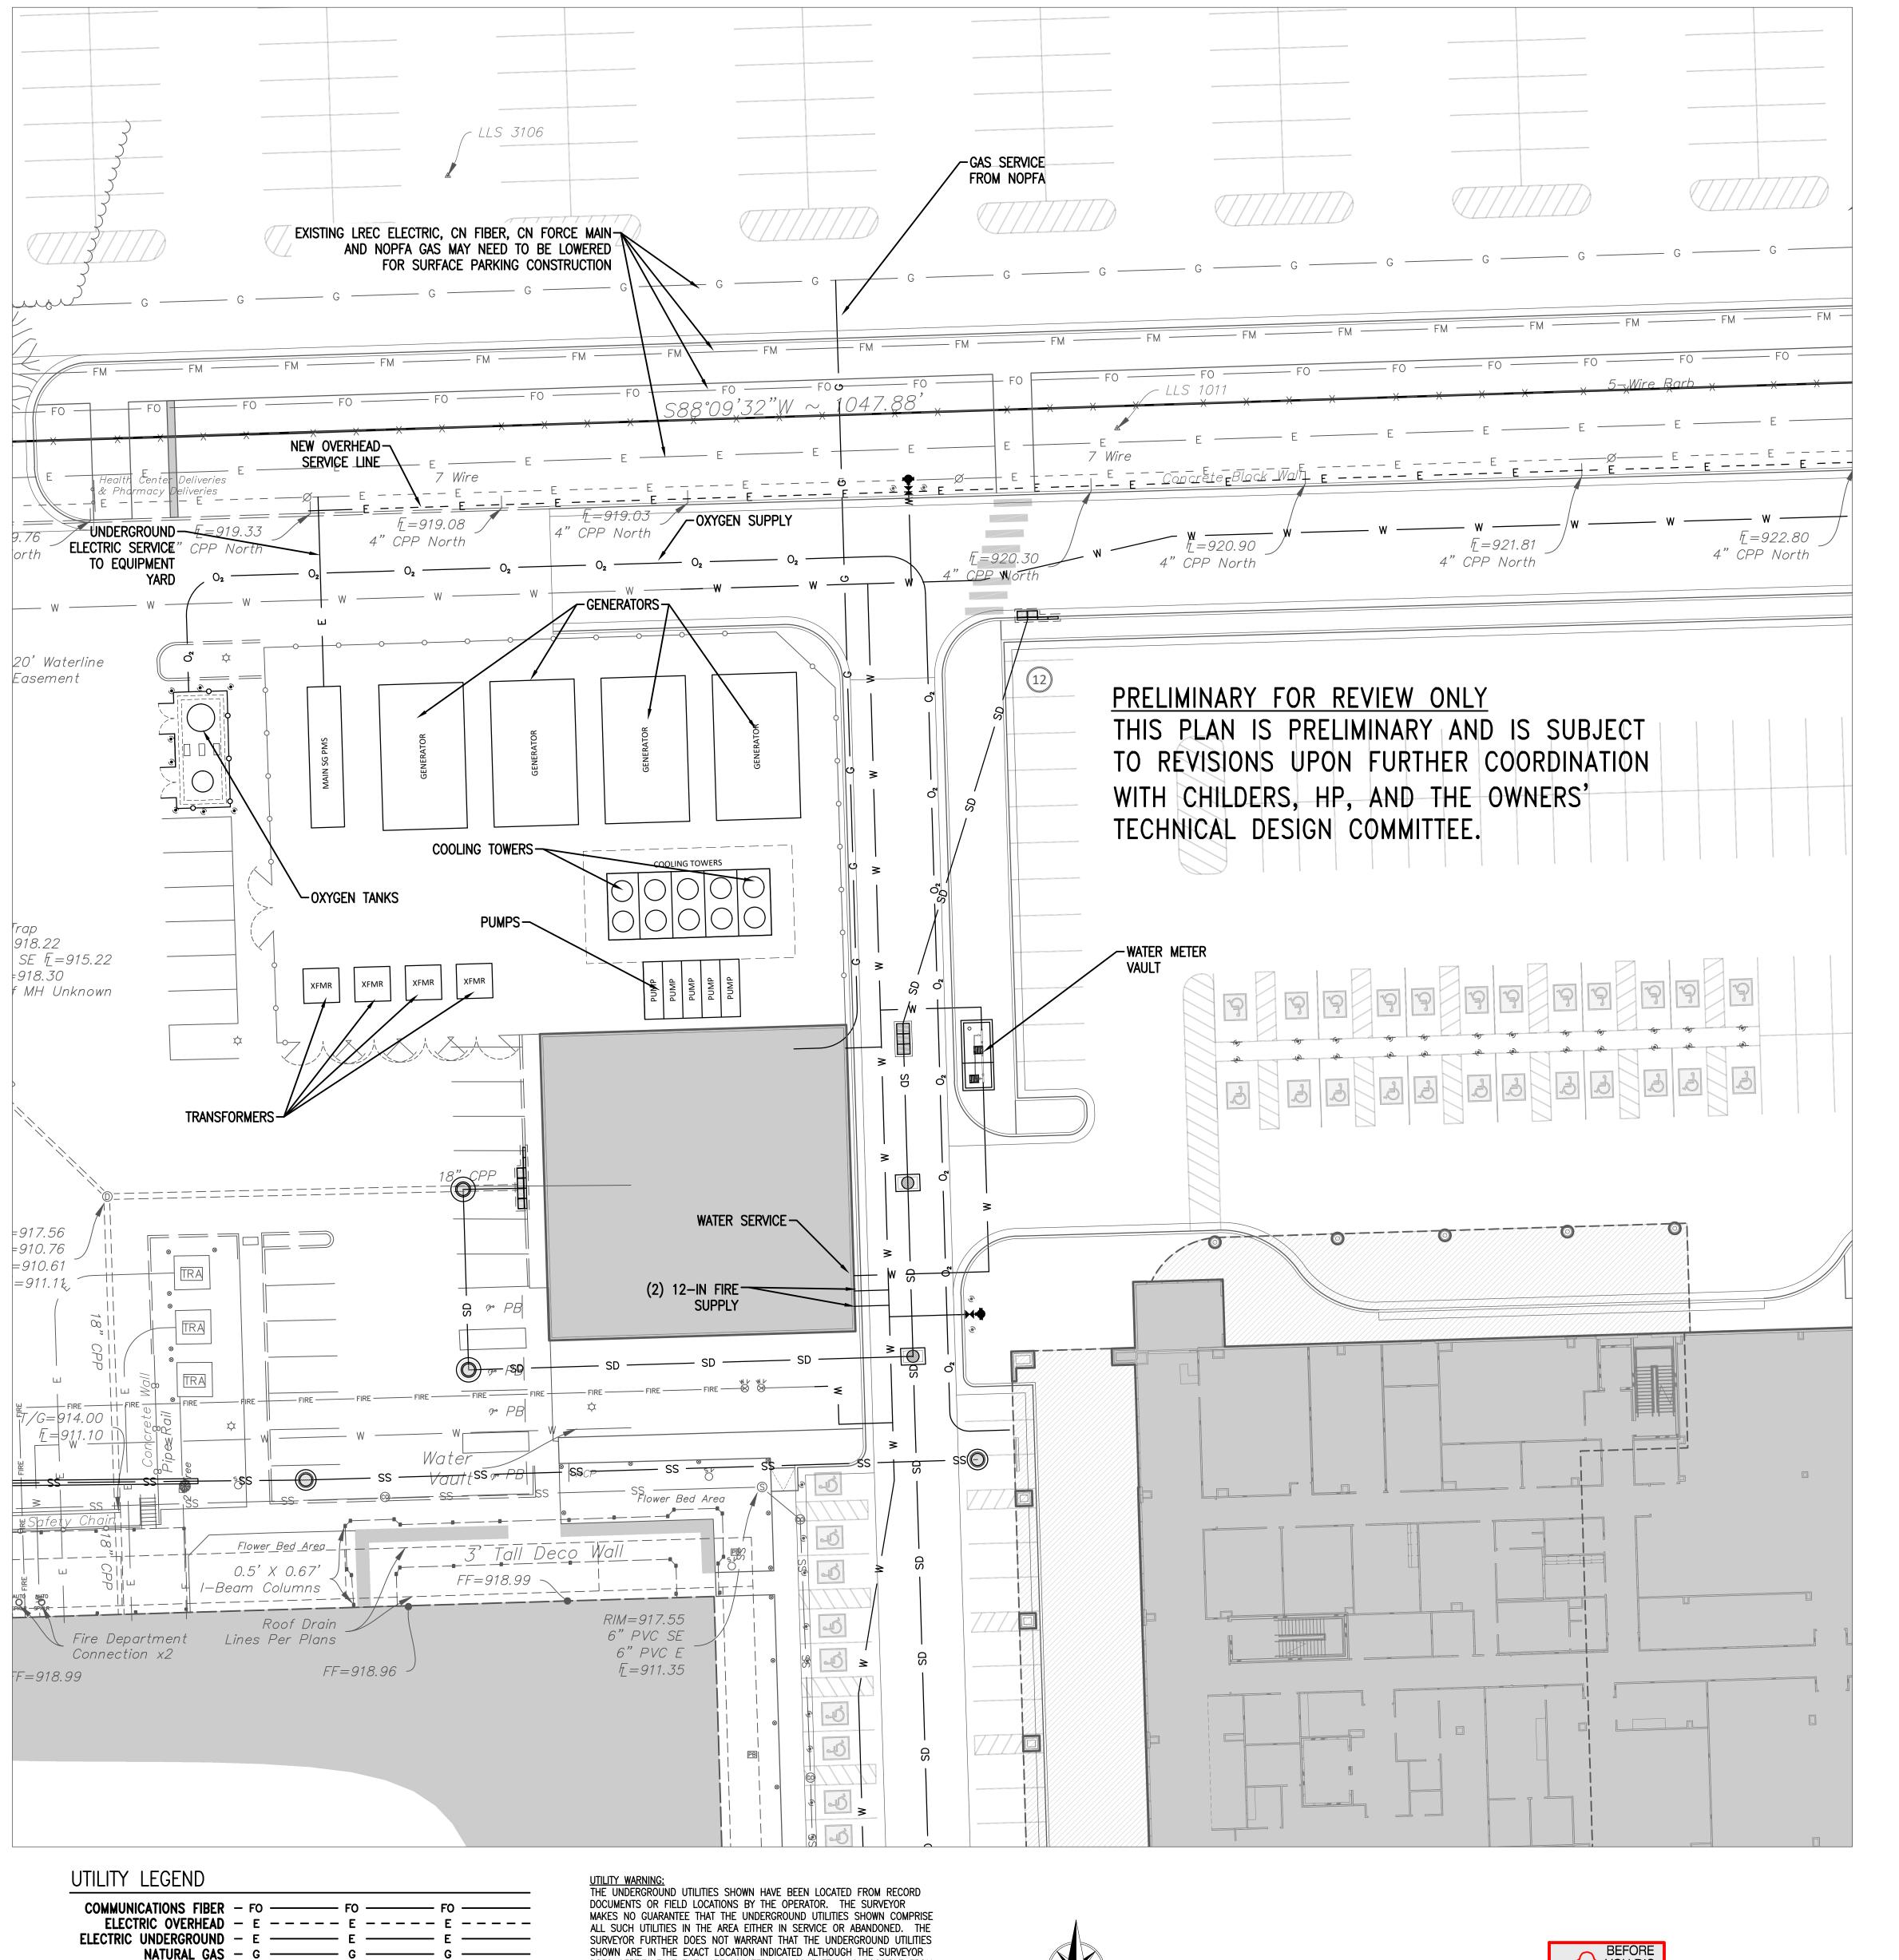




SCHEMATIC DESIGN

21-08.21 05-06-22 C4-101

OVERALL UTILITY VIEW



DOES CERTIFY THAT THEY ARE LOCATED AS ACCURATELY AS POSSIBLE FROM

UTILITY ELEVATIONS AND SIZES MAY HAVE BEEN MEASURED UNDER ADVERSE

SIZES SHOULD BE VERIFIED BY THE CONTRACTOR PRIOR TO CONSTRUCTION. CONTRACTOR SHOULD VERIFY CRITICAL ELEVATIONS USING THE BENCHMARK PROVIDED BY THE SURVEYOR OR ENGINEER. ANY DISCREPANCIES SHOULD

BE IMMEDIATELY BROUGHT TO THE ENGINEER'S AND SURVEYOR'S ATTENTION.

SCALE: 1" = 20'

FIELD CONDITIONS. UPON EXPOSING THE UTILITY, ELEVATIONS AND LINE

THE UNDERGROUND UTILITIES.

THE INFORMATION AVAILABLE. THE SURVEYOR HAS NOT PHYSICALLY LOCATED

OXYGEN GAS - 0₂ ----- 0₂ ------

STORM DRAIN - SD ----- SD ----- SD -----

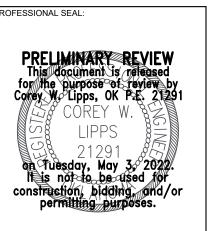
SEWER - SS ------ SS ------ SS ------

WATER - W ------ W ------- W ------

SEWER - SS ------ SS ------ SS ------

KEYNOTES



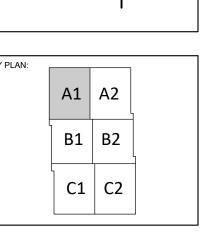






CHEROKEE NATION
V. HASTINGS REPLACEMENT I

TAHLEQUAH, OKLAHOMA



PROJECT PHASE:

SCHEMATIC DESIGN

	REVISIONS	

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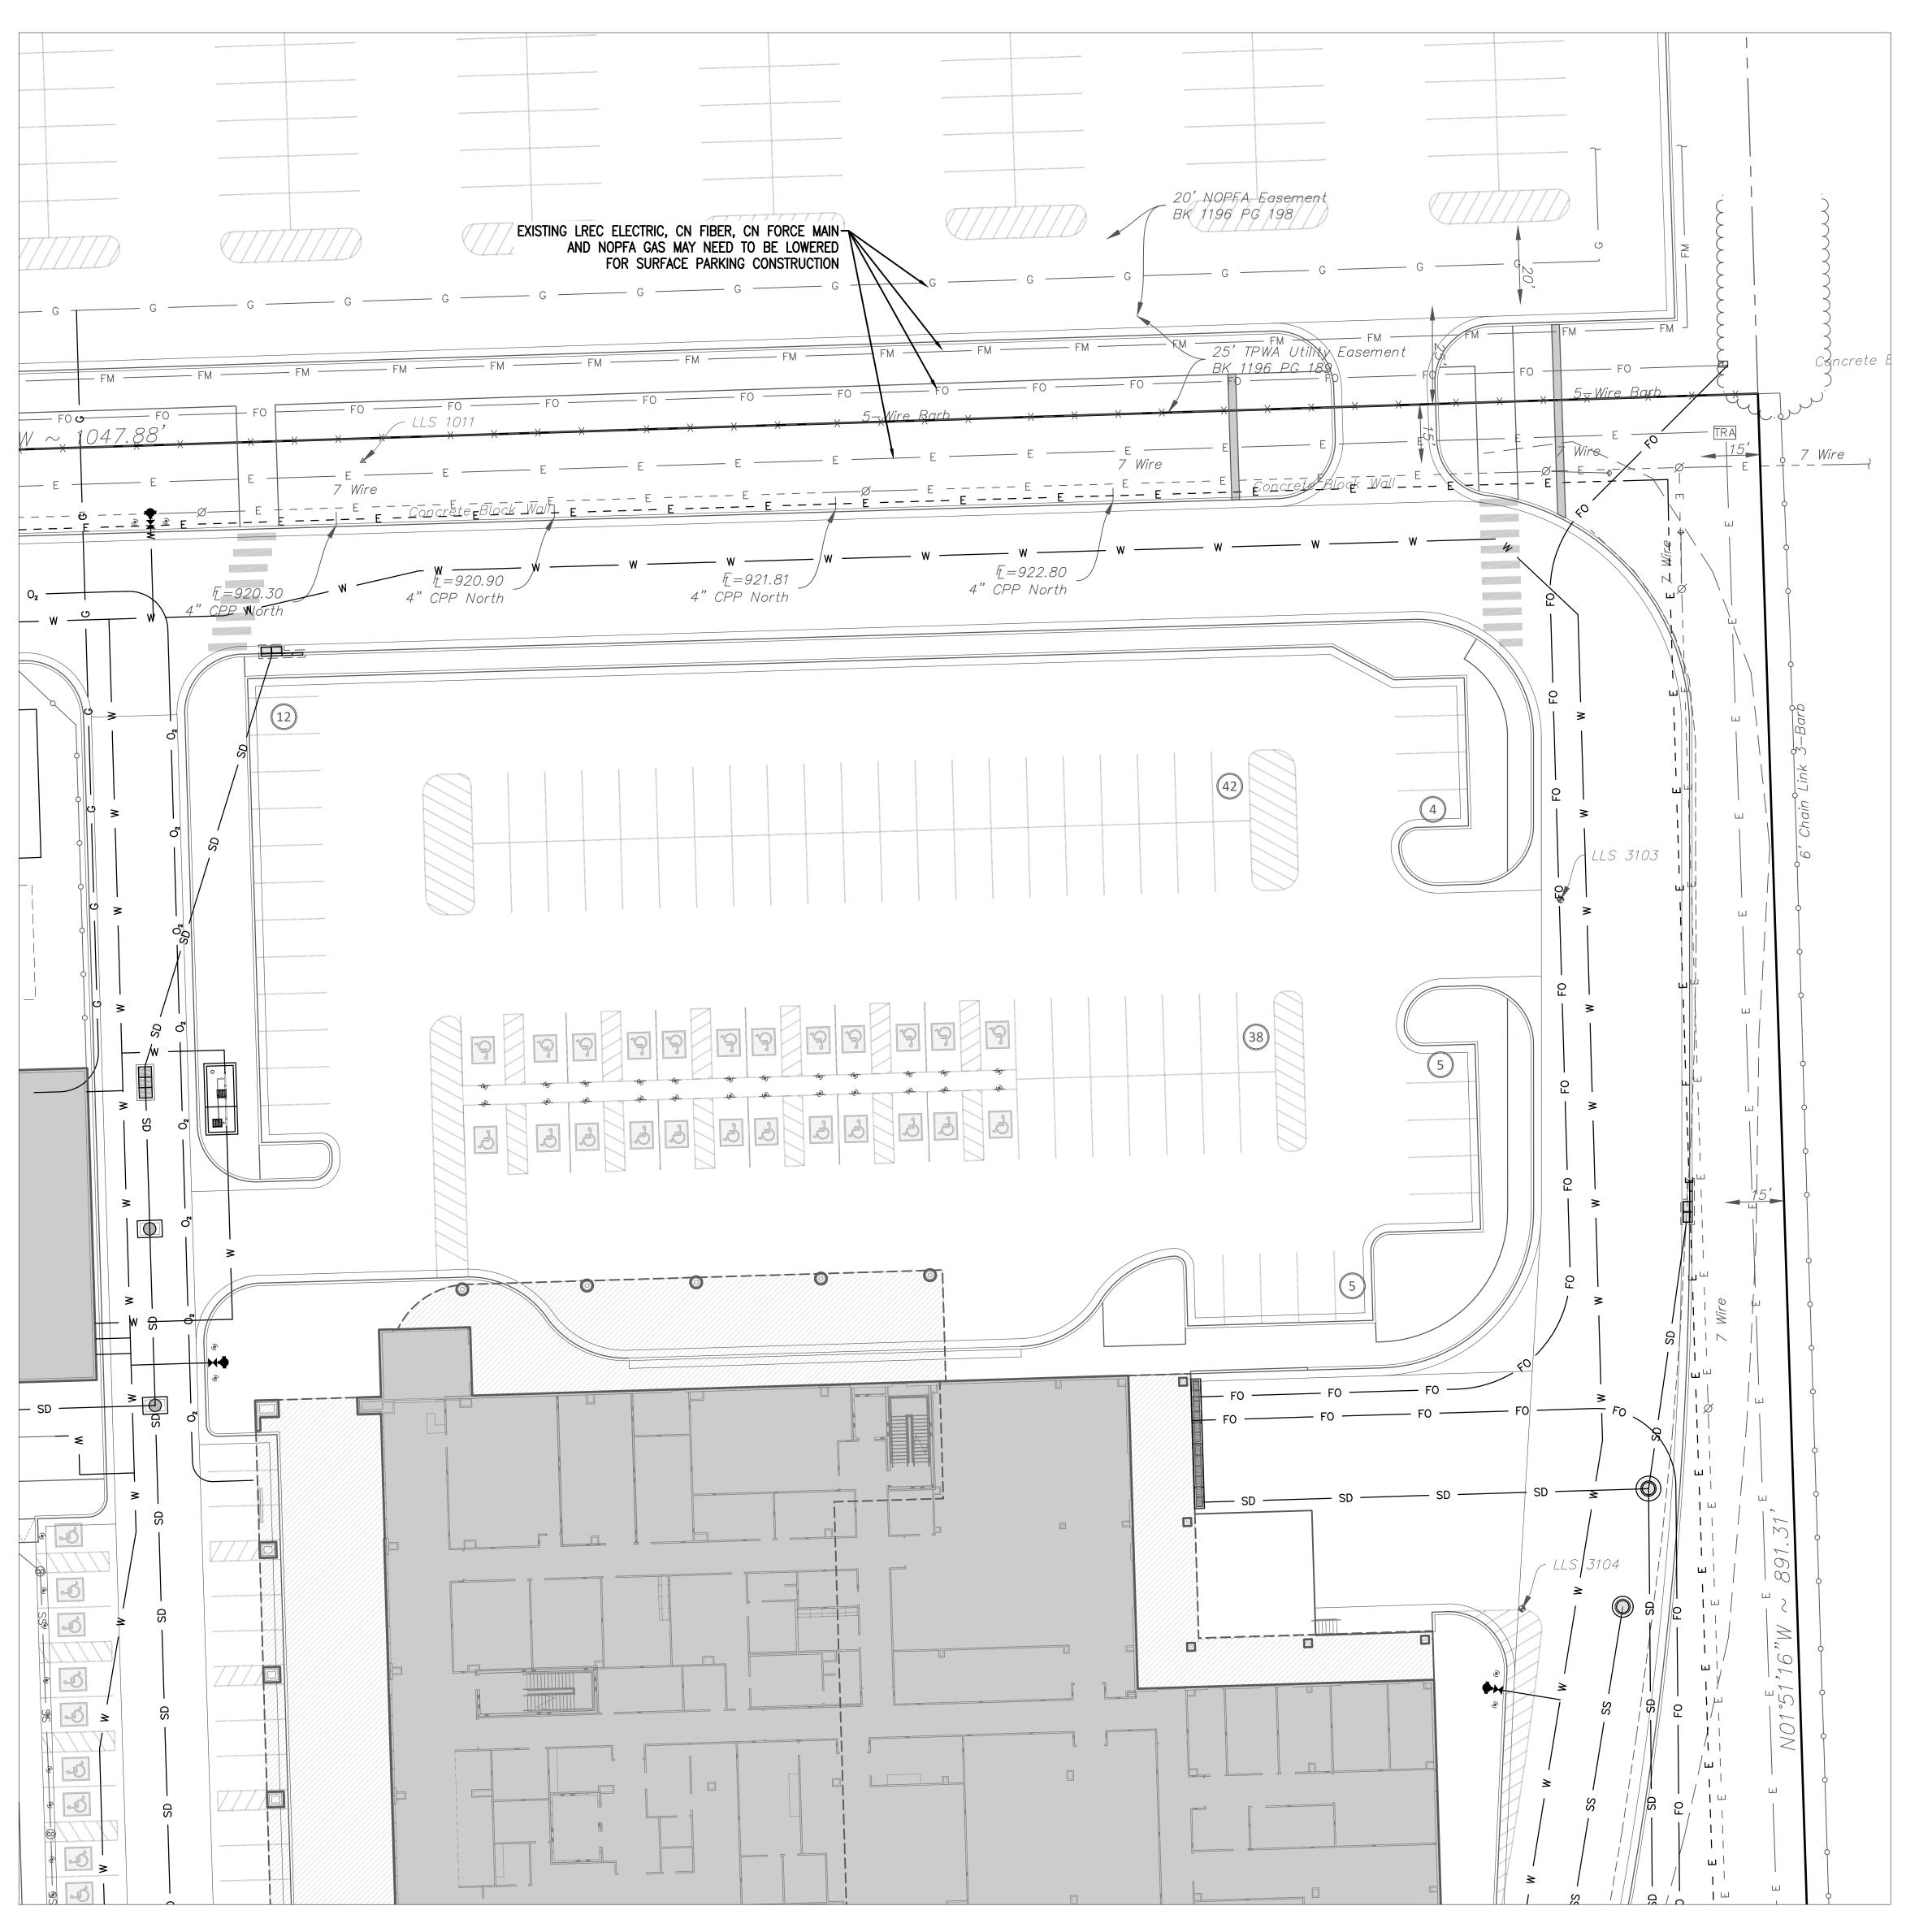
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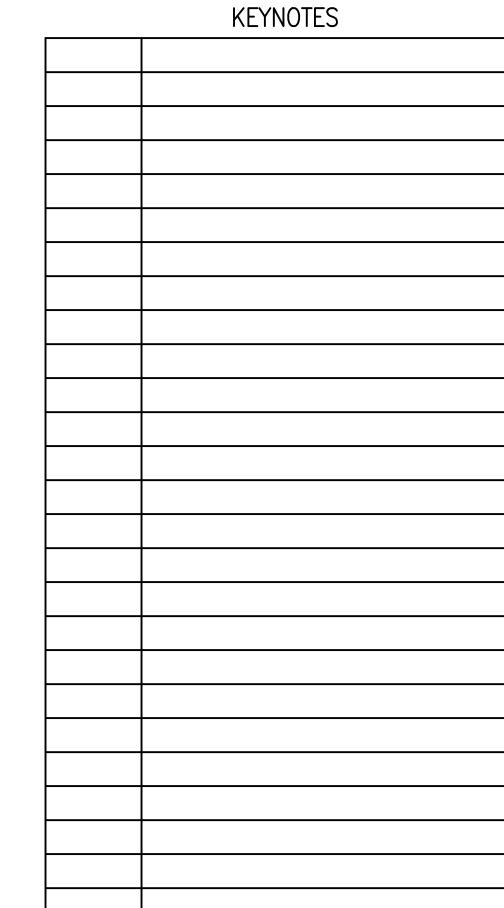
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A1 UTILITIES

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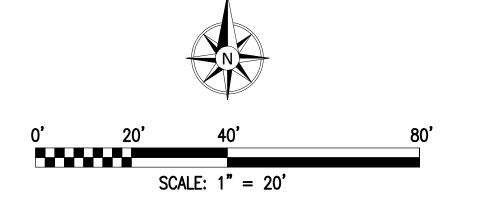


UTILITY LEGEND

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UTILITY WARNING:
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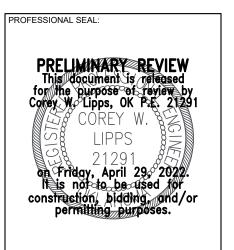
UTILITY ELEVATIONS AND SIZES MAY HAVE BEEN MEASURED UNDER ADVERSE FIELD CONDITIONS. UPON EXPOSING THE UTILITY, ELEVATIONS AND LINE SIZES SHOULD BE VERIFIED BY THE CONTRACTOR PRIOR TO CONSTRUCTION. CONTRACTOR SHOULD VERIFY CRITICAL ELEVATIONS USING THE BENCHMARK PROVIDED BY THE SURVEYOR OR ENGINEER. ANY DISCREPANCIES SHOULD BE IMMEDIATELY BROUGHT TO THE ENGINEER'S AND SURVEYOR'S ATTENTION.



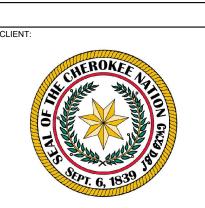


James R. Childers
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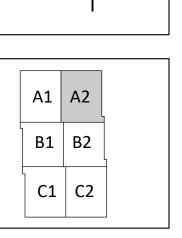




HOSPITAL

V. HASTINGS REPLACEMENT

TAHLEQUAH, OKLAHOMA



PROJECT PHASE:

SCHEMATIC DESIGN

REVISIONS	

21-08.21
DATE: 05-06-22
SHEET NUMBER:

C4-103

A2 UTILITIES



	KEYNOTES

A1 A2
B1 B2
C1 C2

CHEROKEE W.W. HASTINGS REPLA

James R. Childers Architect, Inc.

45 South 4th Street Fort Smith, AR 72901

479-783-2480 www.childersarchitect.com

14101 Wireless Way, Suite 350 Oklahoma City, OK 73134 405-832-9900 www.parkhill.com Oklahoma CA #7110, Expires 6/30/2022

PROFESSIONAL SEAL:

PROJECT PHASE:

SCHEMATIC DESIGN

	REVISIONS	

21-08.21
PATE: 05-06-22
HEET NUMBER:

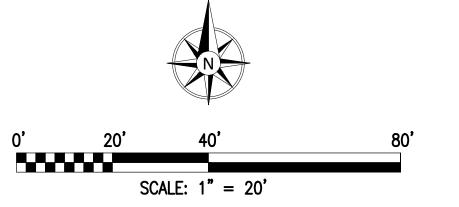
C4-104

B1 UTILITIES

UTILITY LEGEND

UTILITY WARNING:
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	KEYNOTES

UTILITY LEGEND

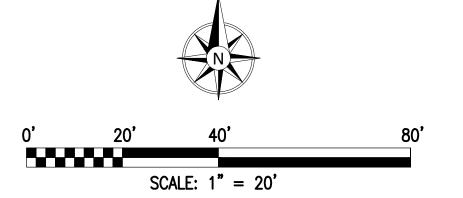
ELECTRIC OVERHEAD — E — — — — E — — — — E — — — — ELECTRIC UNDERGROUND — E — E — E — E — E NATURAL GAS - G ----- G ----- G -----OXYGEN GAS - O₂ ----- O₂ ------SEWER - SS ------ SS ------- SS ------WATER - W ------ W ------- W ------

SEWER – SS — SS — SS — SS —

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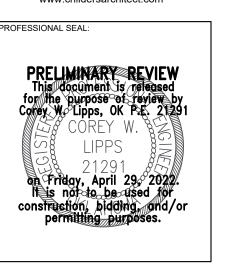
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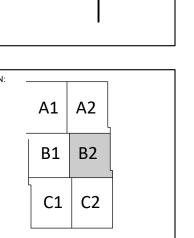


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21-08.21 05-06-22

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B2 UTILITIES



	KEYNOTES

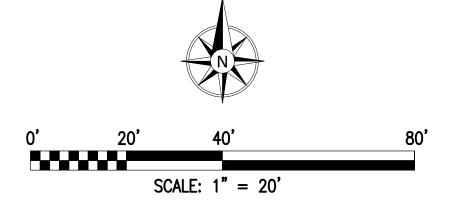
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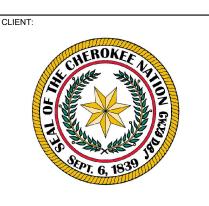


James R. Childers
Architect, Inc.

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479-783-2480
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COREY W.
LIPPS
21291
an Friday, April 29, 2022.
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CHEROKEE NATION

HASTINGS REPLACEMENT HOSPITAL

A1 A2 B1 B2 C1 C2

PROJECT PHASE:

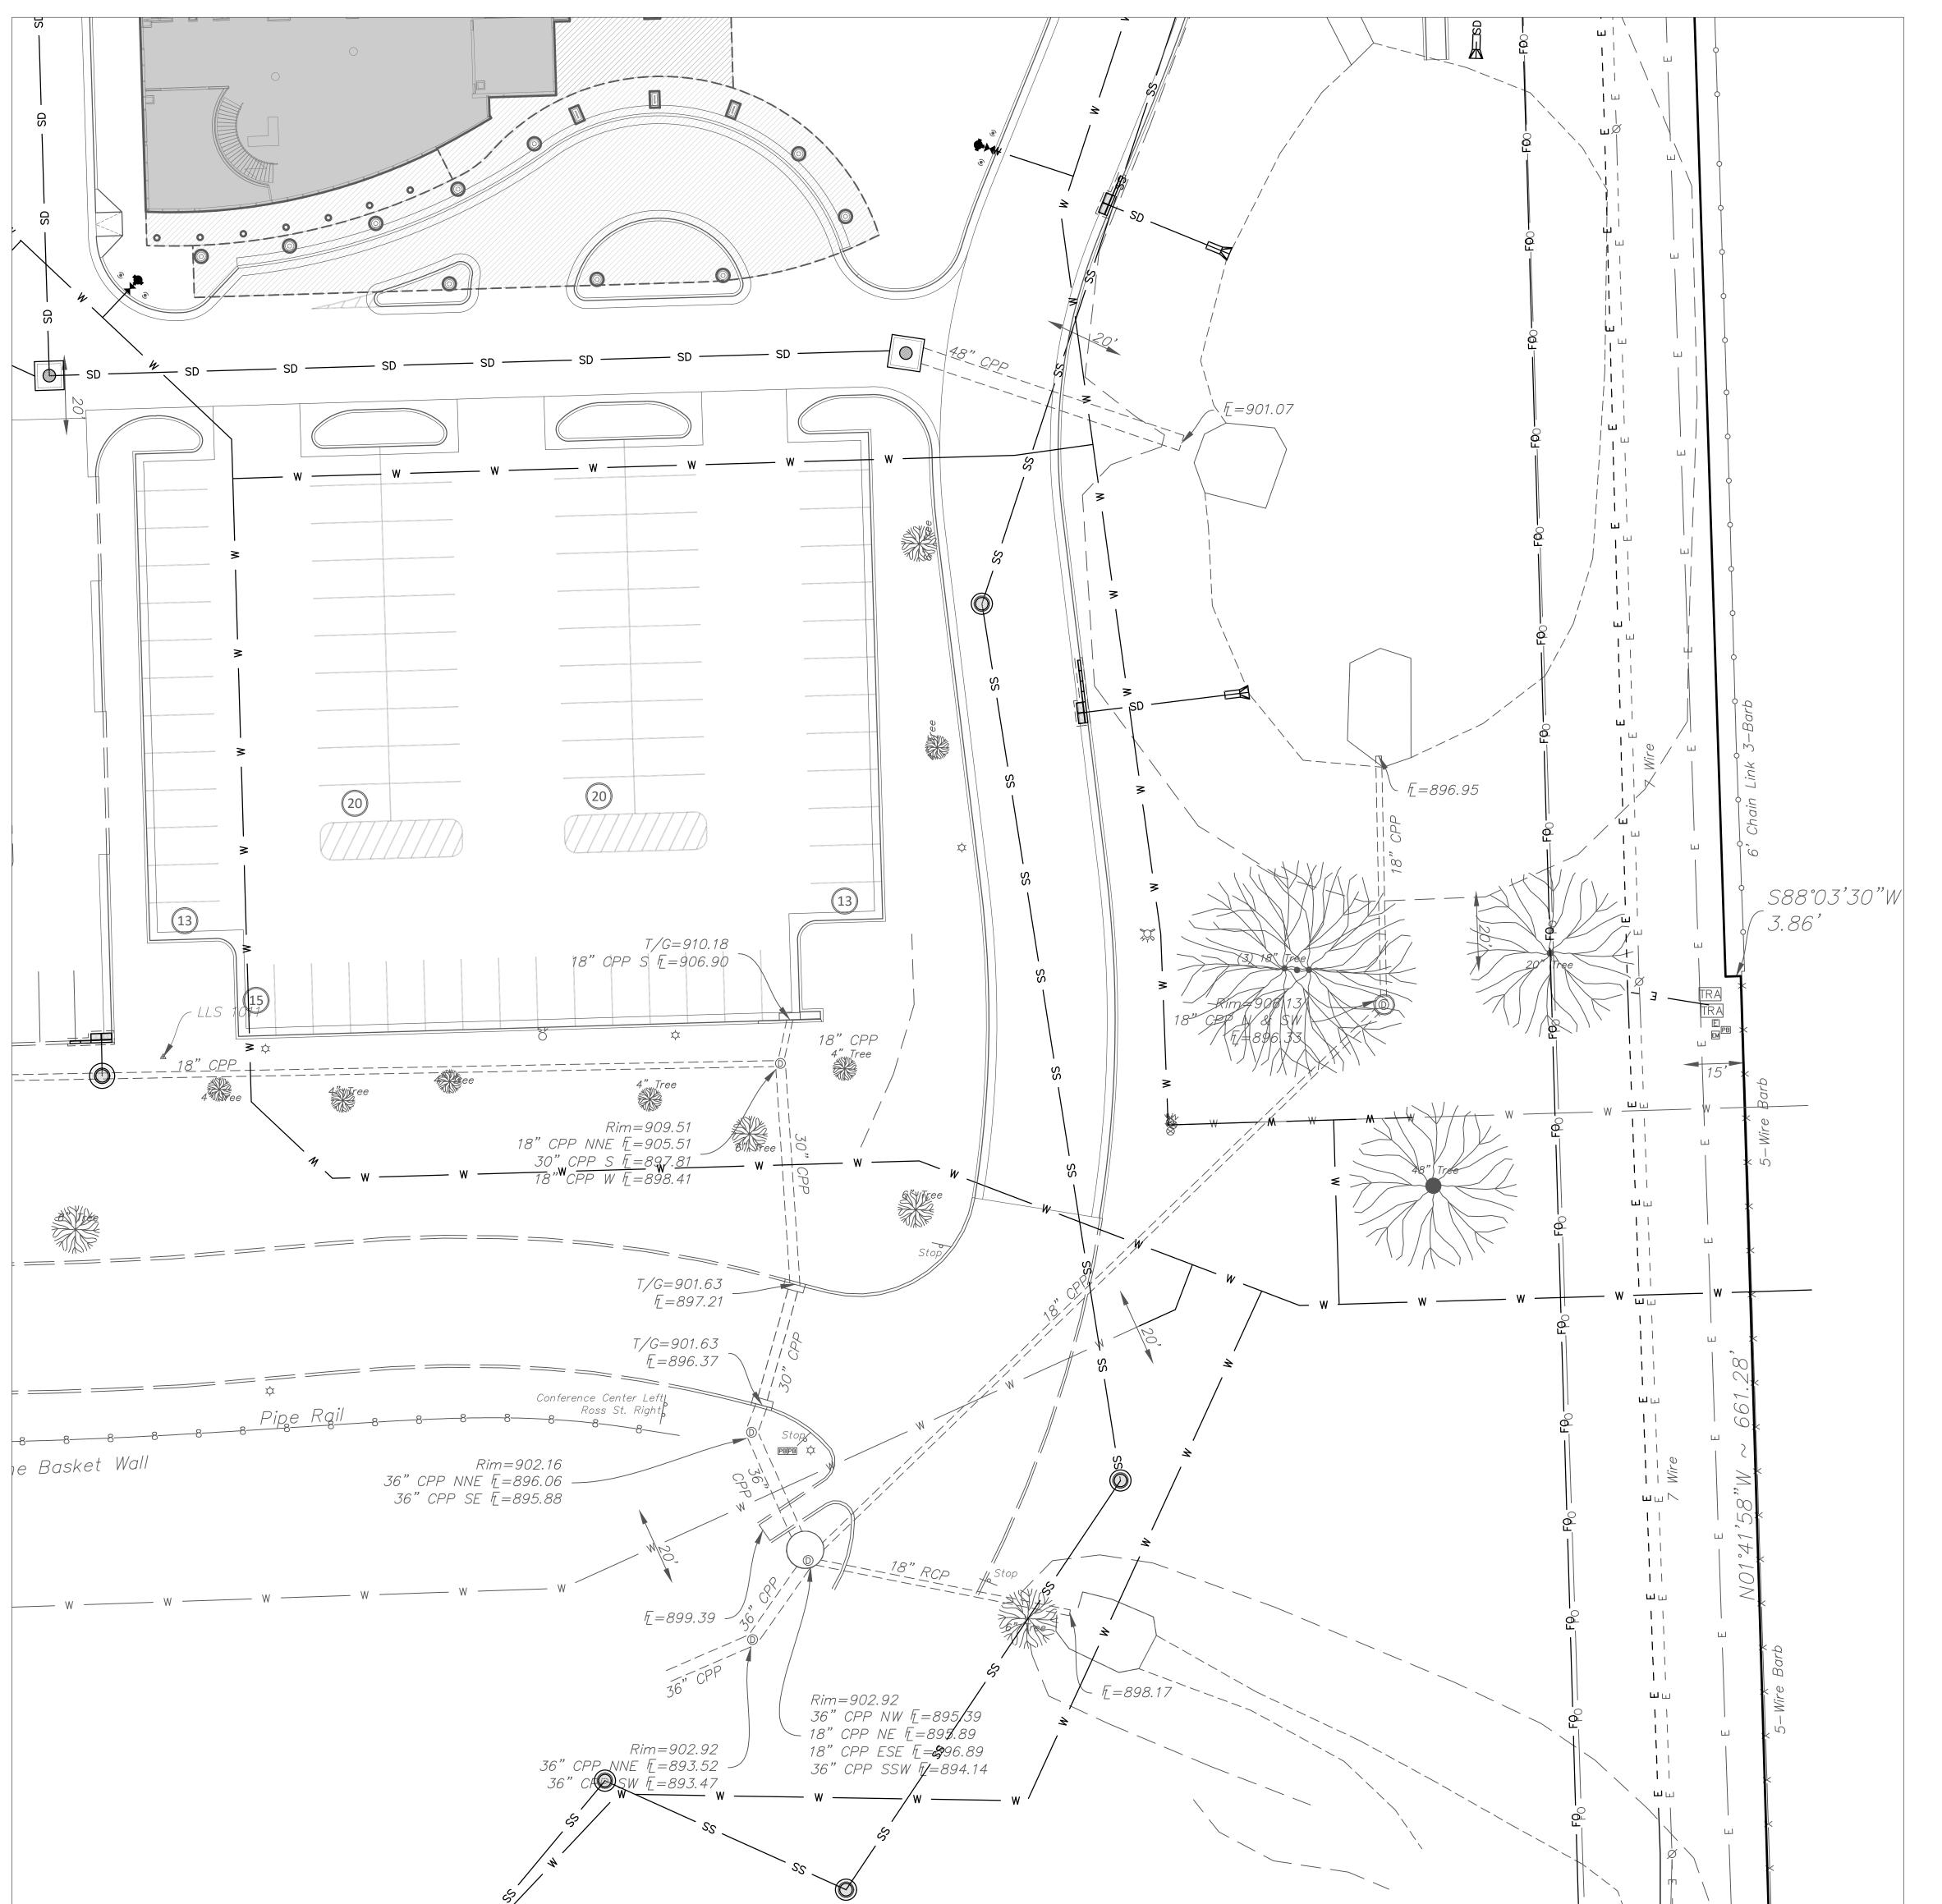
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21-08.21
ATE: 05-06-22
HEET NUMBER:

C4-106

C1 UTILITIES



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CHEROKEE NATION

V.W. HASTINGS REPLACEMEN

TAHLEQUAH, OKLAHOMA

A1 A2 B1 B2

SCHEMATIC DESIGN

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21-08.21
TE: 05-06-22

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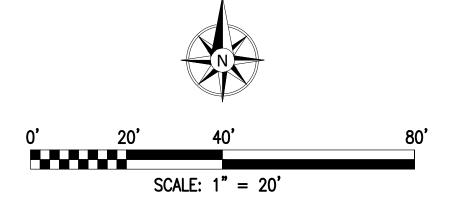
C2 UTILITIES

UTILITY LEGEND

SEWER - SS ------ SS ------ SS ------

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EARTHWORK CALCULATION NOTES

- 1. THE EARTHWORK VOLUMES PROVIDED ARE CALCULATED BY COMPARING THE FINISHED GRADE SURFACE MODEL WITH THE EXISTING GRADE SURFACE MODEL.
- 2. NO ADJUSTMENTS MADE FOR COMPACTION OR EXPANSION OF MATERIAL.
- . NO ADJUSTMENTS ARE MADE FOR BUILDING PAD(S), STRUCTURES, OR PAVEMENTS. 4. NO ADJUSTMENTS ARE MADE FOR UTILITY TRENCH SPOILS.
 - CUT VOLUME = 1,765 CY FILL VOLUME = 24,855 CY

NET VOLUME = 23,090 CY CUT / FILL

ON-SITE PAVING ESTIMATES

3,695 SY 4-IN THK SIDEWALK 9,149 SY 5-IN THK CONCRETE 3,000 SY 6-IN THK CONCRETE 5,353 SY 7-IN THK CONCRETE

10,710 SY BUILDING PAD 711 SY CEP PAD

5,969 LF 6-IN BARRIER CURB W/2-FT GUTTER / 6-IN THK

SCALE: 1" = 50'

HARDSCAPE PATTERNS

	CONCRETE SIDEWALKS
	LIGHT DUTY CONCRETE PAVING
	MEDIUM DUTY CONCRETE PAVING
	HEAVY DUTY CONCRETE PAVING
	REINFORCED HEAVY DUTY CONCRETE PAVIN

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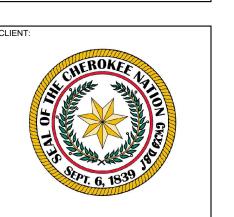


James R. Childers Architect, Inc.

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45 South 4th Street Fort Smith, AR 72901





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21-08.21 05-06-22

OVERALL GRADING VIEW

SODDING / SEEDING / VEGETATIVE COVER

HARDSCAPE PATTERNS

CONCRETE SIDEWALKS

LIGHT DUTY CONCRETE PAVING

MEDIUM DUTY CONCRETE PAVING

HEAVY DUTY CONCRETE PAVING

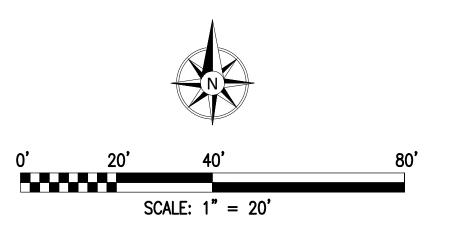
REINFORCED HEAVY DUTY CONCRETE PAVING

SODDING / SEEDING / VEGETATIVE COVER

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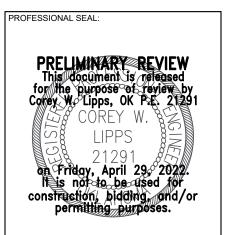
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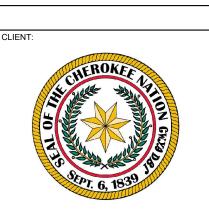


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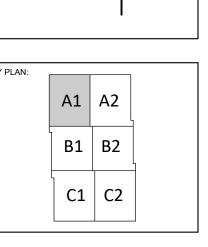


T HOSPITAL

CHEROKEE NATION

W.W. HASTINGS REPLACEMEN

TAHLEQUAH, OKLAHOMA



PROJECT PHASE:

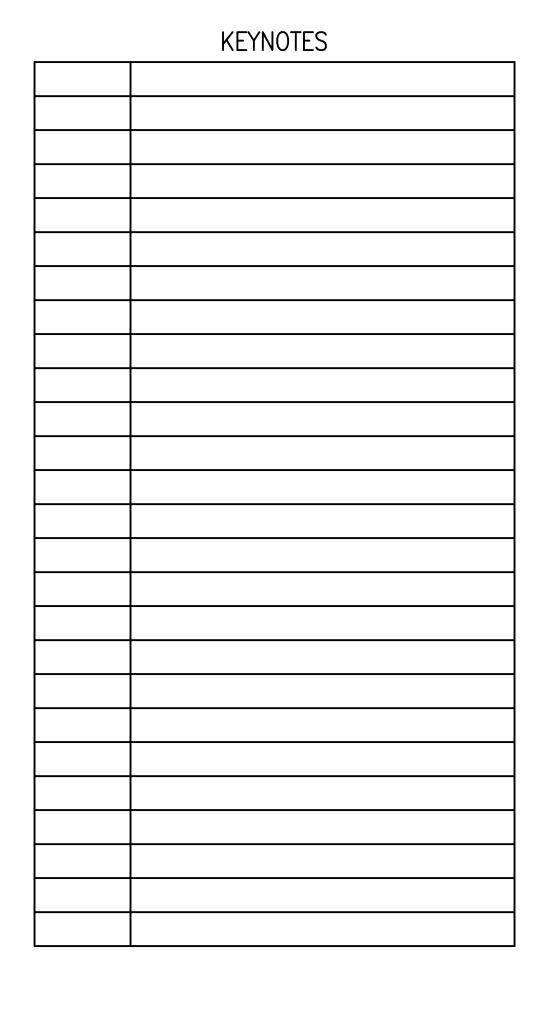
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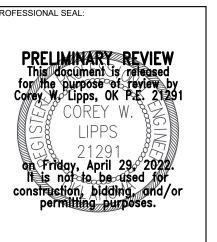
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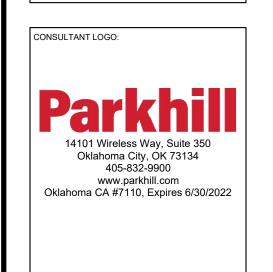
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A1 GRADING PLAN

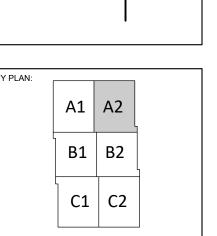


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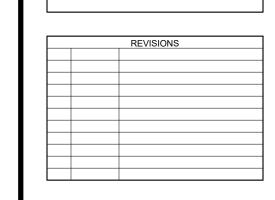








SCHEMATIC DESIGN



21-08.21 05-06-22

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A2 GRADING PLAN

HARDSCAPE PATTERNS

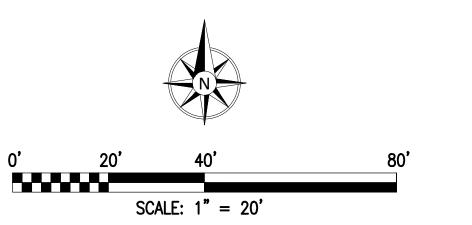
CONCRETE SIDEWALKS LIGHT DUTY CONCRETE PAVING

MEDIUM DUTY CONCRETE PAVING HEAVY DUTY CONCRETE PAVING REINFORCED HEAVY DUTY CONCRETE PAVING

SODDING / SEEDING / VEGETATIVE COVER

UTILITY WARNING:
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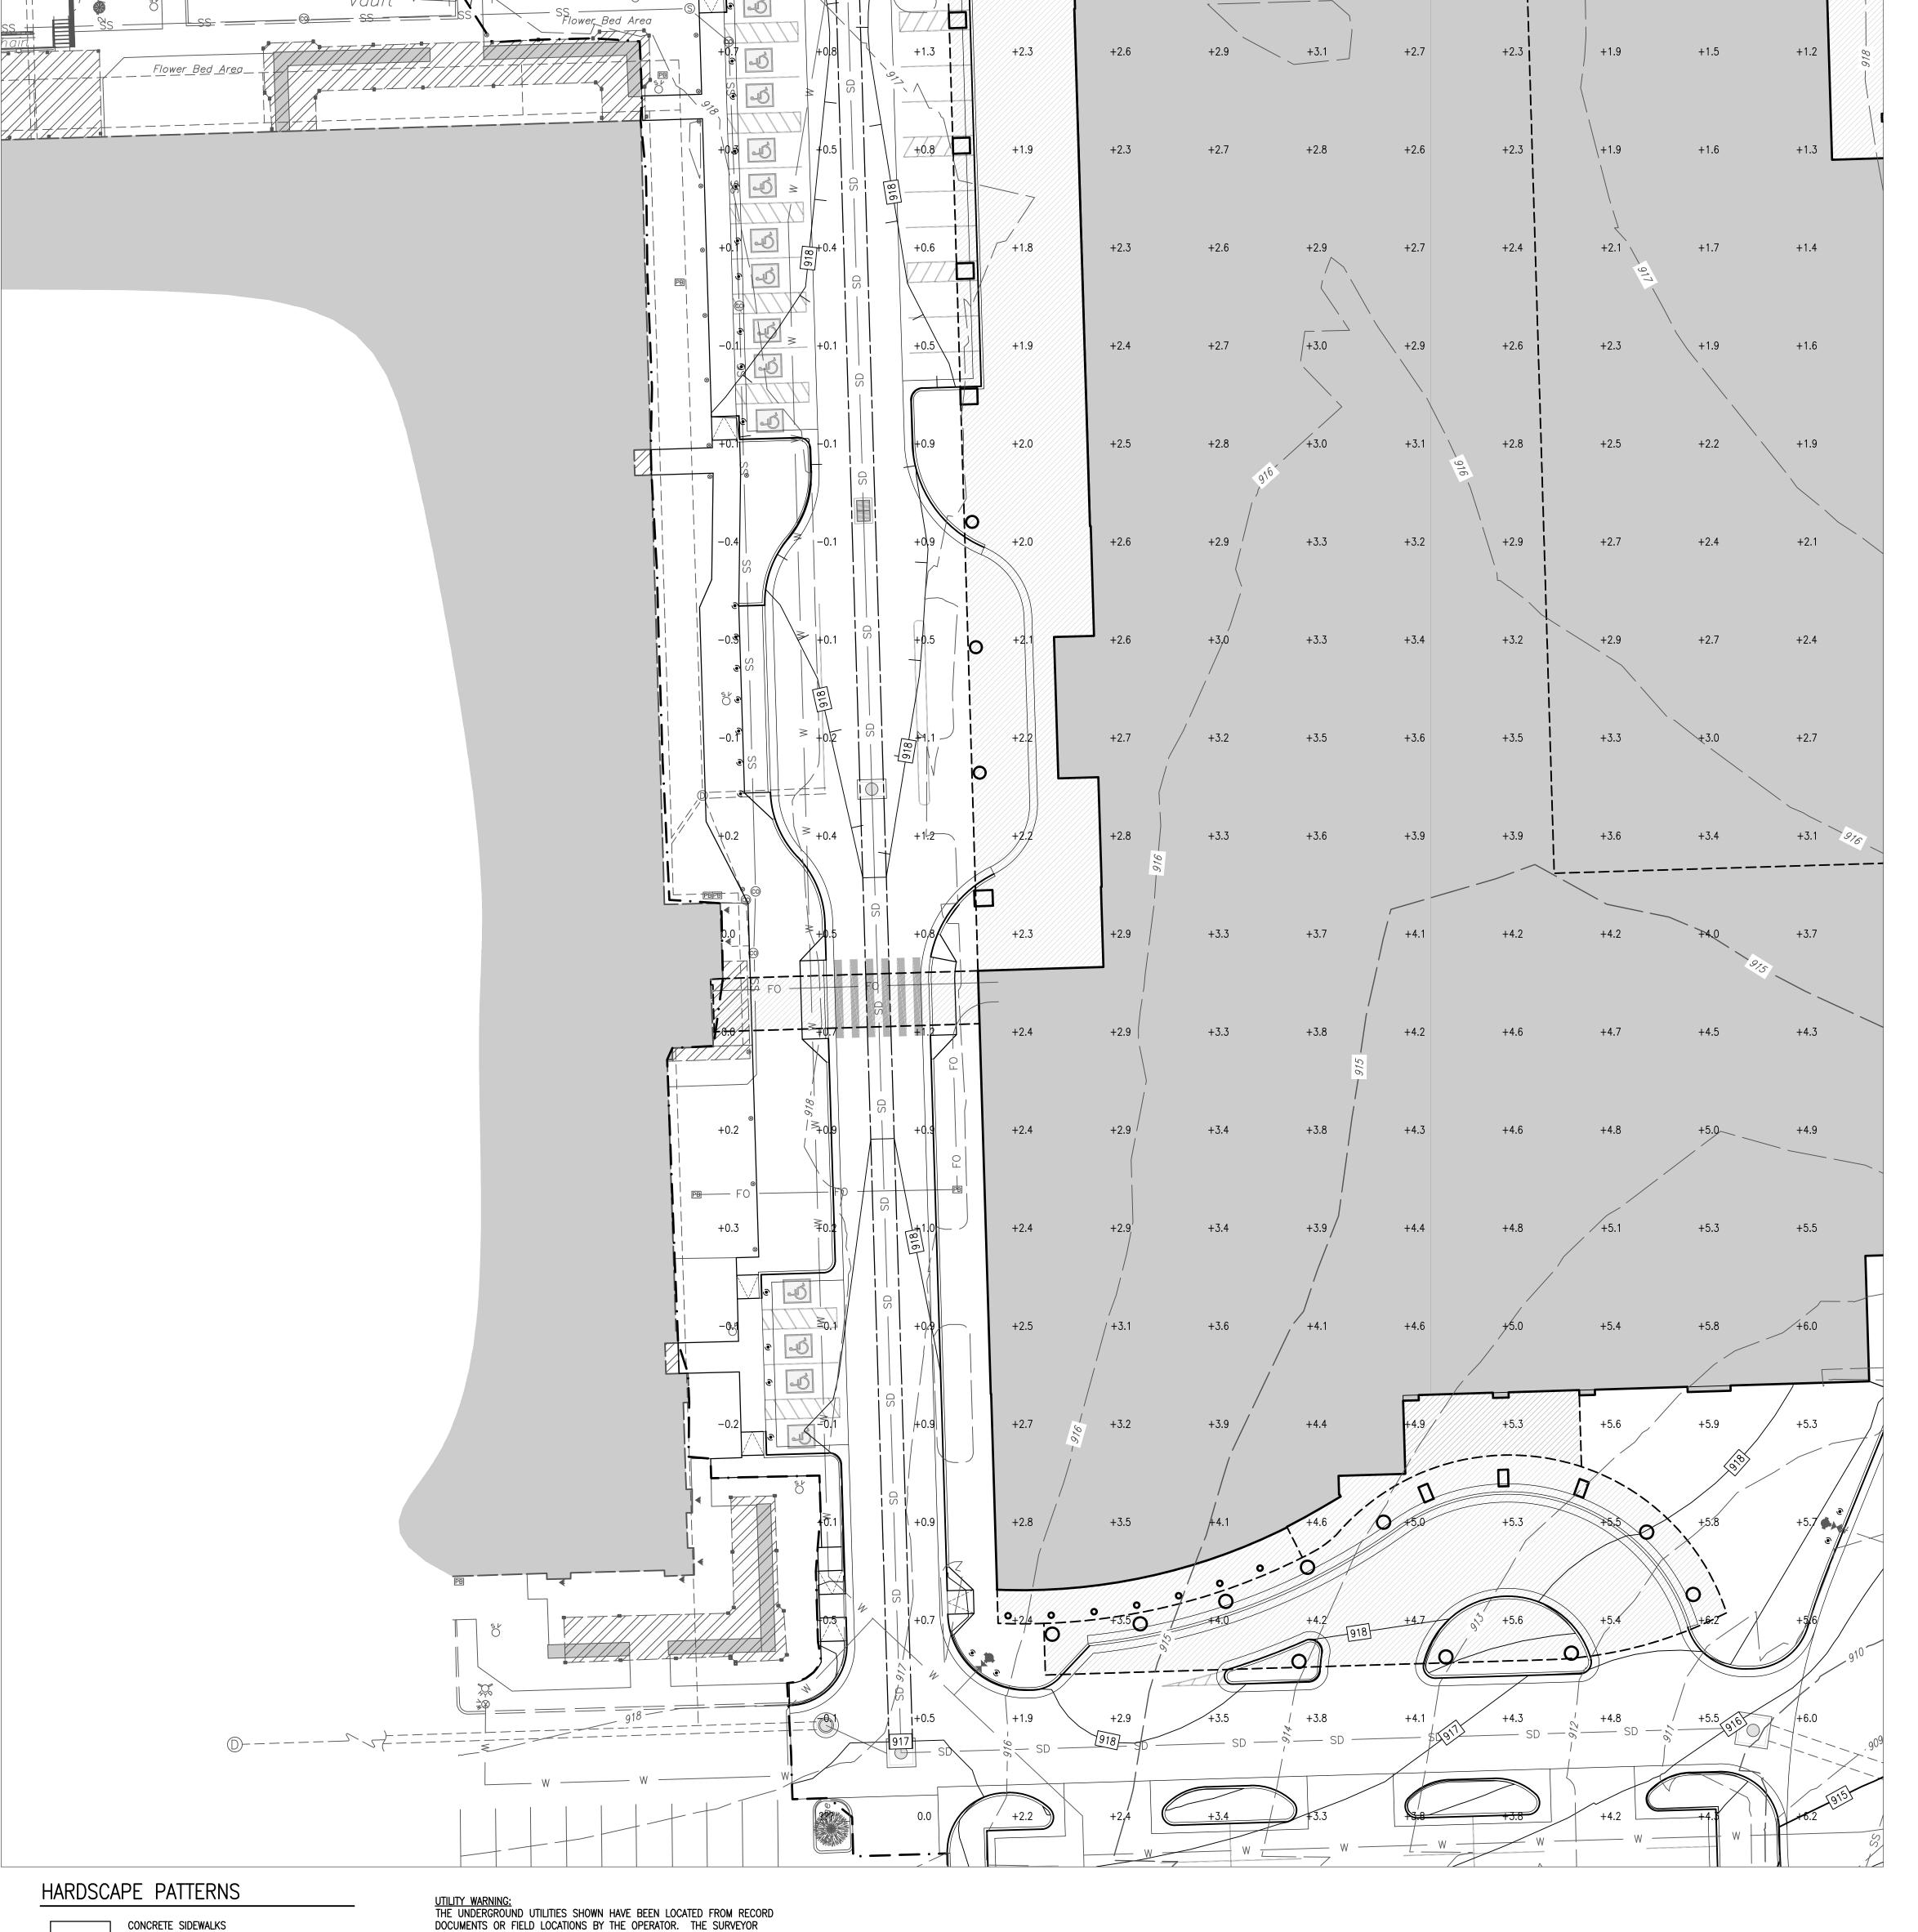
LIGHT DUTY CONCRETE PAVING

MEDIUM DUTY CONCRETE PAVING

HEAVY DUTY CONCRETE PAVING

REINFORCED HEAVY DUTY CONCRETE PAVING

SODDING / SEEDING / VEGETATIVE COVER



SCALE: 1" = 20'

MAKES NO GUARANTEE THAT THE UNDERGROUND UTILITIES SHOWN COMPRISE ALL SUCH UTILITIES IN THE AREA EITHER IN SERVICE OR ABANDONED. THE

SURVEYOR FURTHER DOES NOT WARRANT THAT THE UNDERGROUND UTILITIES SHOWN ARE IN THE EXACT LOCATION INDICATED ALTHOUGH THE SURVEYOR

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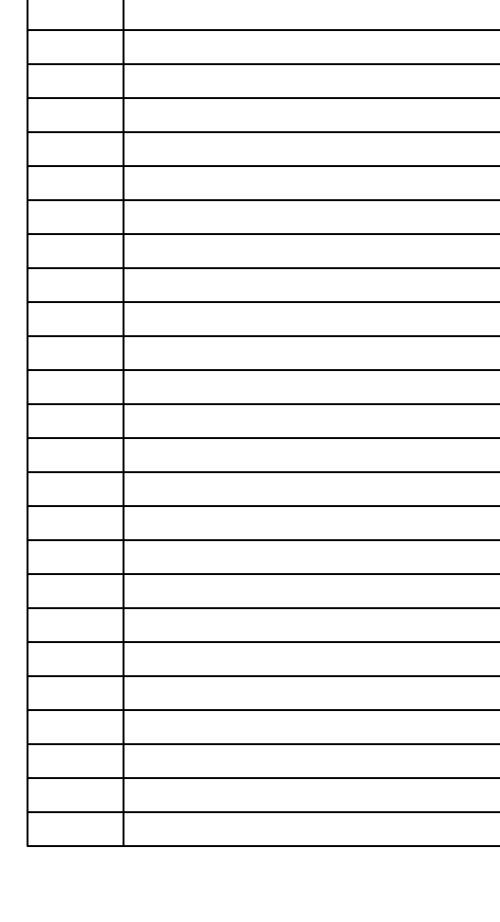
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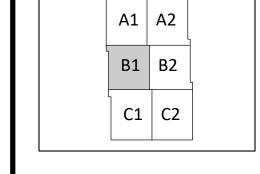
BE IMMEDIATELY BROUGHT TO THE ENGINEER'S AND SURVEYOR'S ATTENTION.

FIELD CONDITIONS. UPON EXPOSING THE UTILITY, ELEVATIONS AND LINE

THE UNDERGROUND UTILITIES.

KEYNOTES





CHEROKE HASTINGS REPI

James R. Childers Architect, Inc.

45 South 4th Street Fort Smith, AR 72901 479-783-2480 www.childersarchitect.com

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www.parkhill.com Oklahoma CA #7110, Expires 6/30/2022

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CONSULTANT LOGO:

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21-08.21 05-06-22

C5-104

B1 GRADING PLAN

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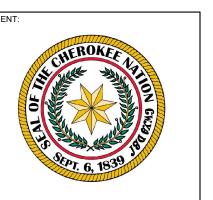
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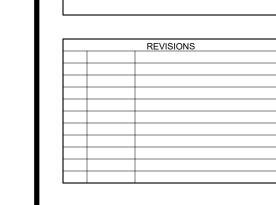
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M. HASTINGS REPLACEMENT HC

A1 A2
B1 B2
C1 C2

PROJECT PHASE:

SCHEMATIC DESIGN



DATE: 05-06-22

SHEET NUMBER: C5-105

HEET TITLE:

B2 GRADING PLAN

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20' 40' 80'

SCALE: 1" = 20'



HEAVY DUTY CONCRETE PAVING

REINFORCED HEAVY DUTY CONCRETE PAVING

SODDING / SEEDING / VEGETATIVE COVER

HARDSCAPE PATTERNS

CONCRETE SIDEWALKS

LIGHT DUTY CONCRETE PAVING

MEDIUM DUTY CONCRETE PAVING

HEAVY DUTY CONCRETE PAVING

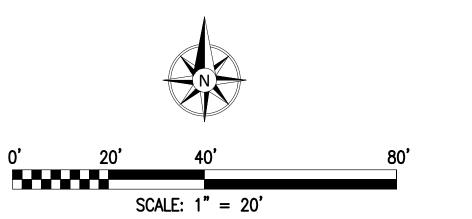
REINFORCED HEAVY DUTY CONCRETE PAVING

SODDING / SEEDING / VEGETATIVE COVER

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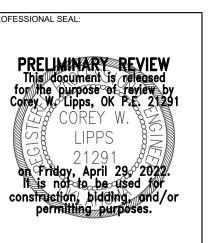
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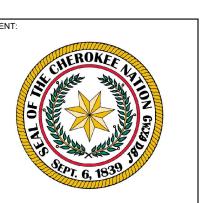


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A1 A2 B1 B2

SCHEMATIC DESIGN

REVISIONS

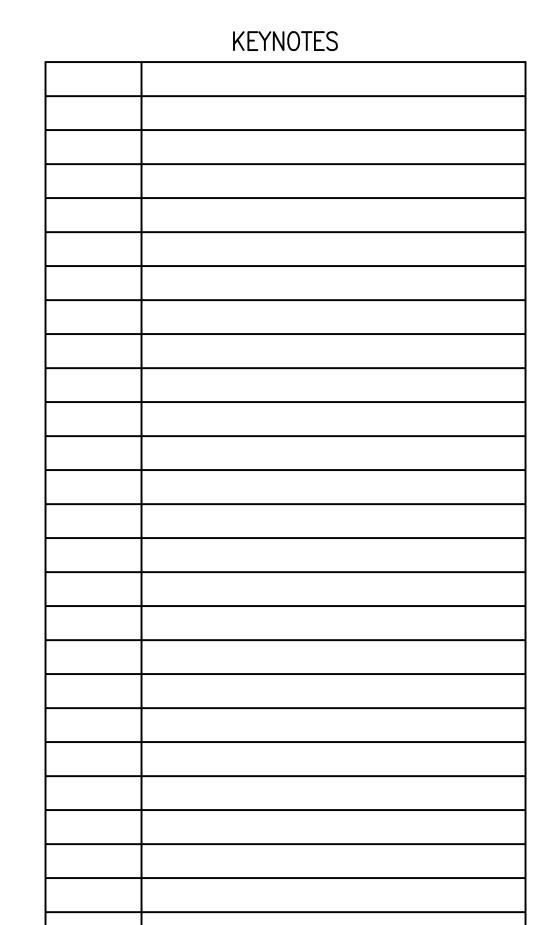
21-08.21

DATE: 05-06-22

SHEET NUMBER: C5-106

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C1 GRADING PLAN



HARDSCAPE PATTERNS

CONCRETE SIDEWALKS

LIGHT DUTY CONCRETE PAVING

MEDIUM DUTY CONCRETE PAVING

HEAVY DUTY CONCRETE PAVING

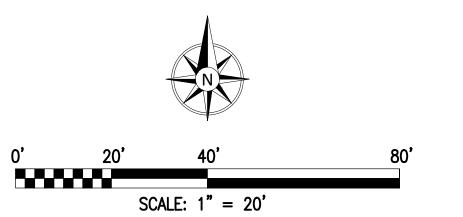
REINFORCED HEAVY DUTY CONCRETE PAVING

SODDING / SEEDING / VEGETATIVE COVER

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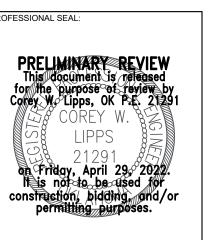
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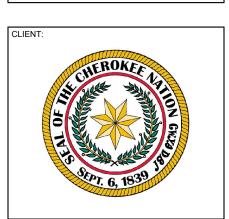


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HOSPITAL

W.W. HASTINGS REPLACEMENT

A1 A2 B1 B2 C1 C2

SCHEMATIC DESIGN

REVISIONS

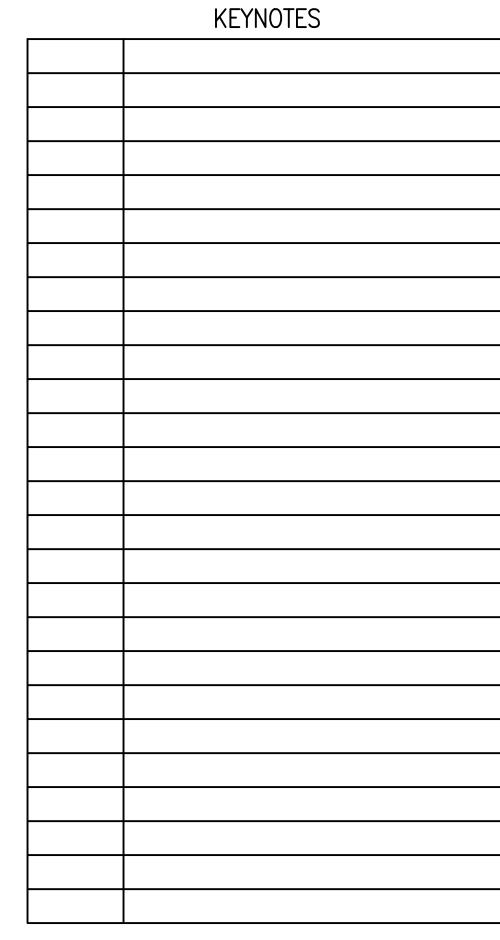
21-08.21

DATE: 05-06-22

SHEET NUMBER: C5-107

HEET TITLE:

C2 GRADING PLAN



21-08.21 05-06-22

SCHEMATIC DESIGN

James R. Childers Architect, Inc.

45 South 4th Street Fort Smith, AR 72901 479-783-2480 www.childersarchitect.com

14101 Wireless Way, Suite 350 Oklahoma City, OK 73134 405-832-9900 www.parkhill.com Oklahoma CA #7110, Expires 6/30/2022

C5-108

P1 GRADING PLAN

SURVEY INFORMATION IS CURRENTLY NOT AVAILABLE.

CONCRETE SIDEWALKS LIGHT DUTY CONCRETE PAVING MEDIUM DUTY CONCRETE PAVING HEAVY DUTY CONCRETE PAVING REINFORCED HEAVY DUTY CONCRETE PAVING

SODDING / SEEDING / VEGETATIVE COVER

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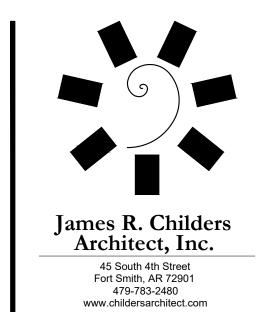
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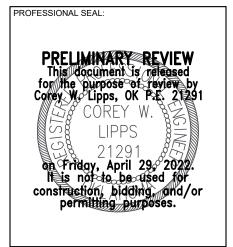


SCALE: 1" = 20'

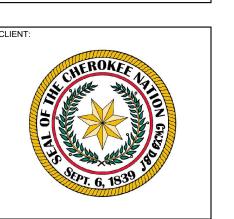
KEYNOTES
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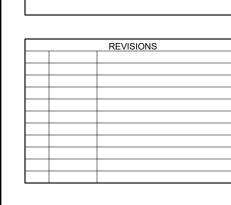








SCHEMATIC DESIGN



21-08.21 05-06-22 C5-109

P2 GRADING PLAN

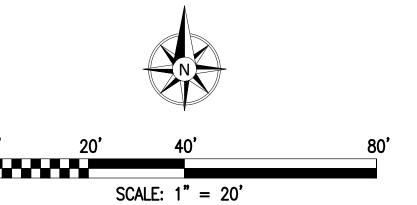
MEDIUM DUTY CONCRETE PAVING HEAVY DUTY CONCRETE PAVING

REINFORCED HEAVY DUTY CONCRETE PAVING

SODDING / SEEDING / VEGETATIVE COVER

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	KEYNOTES

Architect, Inc. 45 South 4th Street Fort Smith, AR 72901 479-783-2480 www.childersarchitect.com

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SCHEMATIC DESIGN

21-08.21 05-06-22 C5-110

P3 GRADING PLAN

SURVEY INFORMATION IS CURRENTLY NOT AVAILABLE.

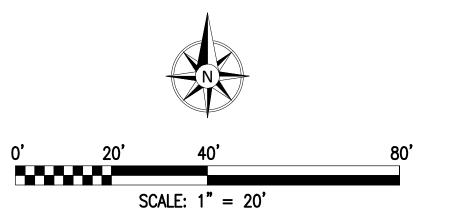
CONCRETE SIDEWALKS

LIGHT DUTY CONCRETE PAVING MEDIUM DUTY CONCRETE PAVING HEAVY DUTY CONCRETE PAVING REINFORCED HEAVY DUTY CONCRETE PAVING

SODDING / SEEDING / VEGETATIVE COVER

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PROJECT PHASE:

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PROJECT PHASE:
SCHEMATIC DESIGN

REVISIONS

JOB NUMBER: 21-08.21

DATE: 05-06-22

SHEET NUMBER: C5-111

P4 GRADING PLAN

C5-1

SURVEY INFORMATION IS CURRENTLY NOT AVAILABLE.

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CONCRETE SIDEWALKS

LIGHT DUTY CONCRETE PAVING

MEDIUM DUTY CONCRETE PAVING

HEAVY DUTY CONCRETE PAVING

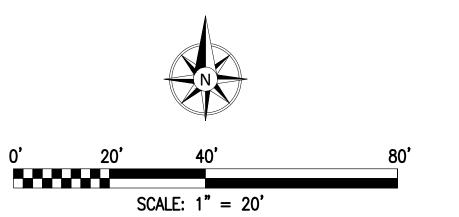
REINFORCED HEAVY DUTY CONCRETE PAVING

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James R. Childers
Architect, Inc.

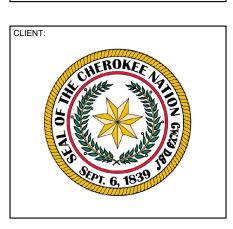
45 South 4th Street
Fort Smith, AR 72901

KEYNOTES

PRELIMINARY REVIEW
This document is released for the purpose of review by Corey W. Lipps, OK P.E. 21291
COREY W. LIPPS
21291
on Friday, April 29, 2022.
It is not to be used for construction, bidding, and/or permitting purposes.

479-783-2480 www.childersarchitect.com





REPLACEMENT HOSPITA

PT P2
PROJECT PHASE:
SCHEMATIC DESIGN

REVISIONS

JOB NUMBER: 21-08.21

DATE: 05-06-22

SHEET NUMBER:

SHEET NUMBER: **C5-112**

HEET TITLE:

P5 GRADING PLAN

CONCRETE SIDEWALKS

LIGHT DUTY CONCRETE PAVING

MEDIUM DUTY CONCRETE PAVING

HEAVY DUTY CONCRETE PAVING

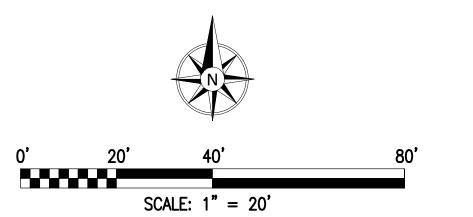
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SODDING / SEEDING / VEGETATIVE COVER

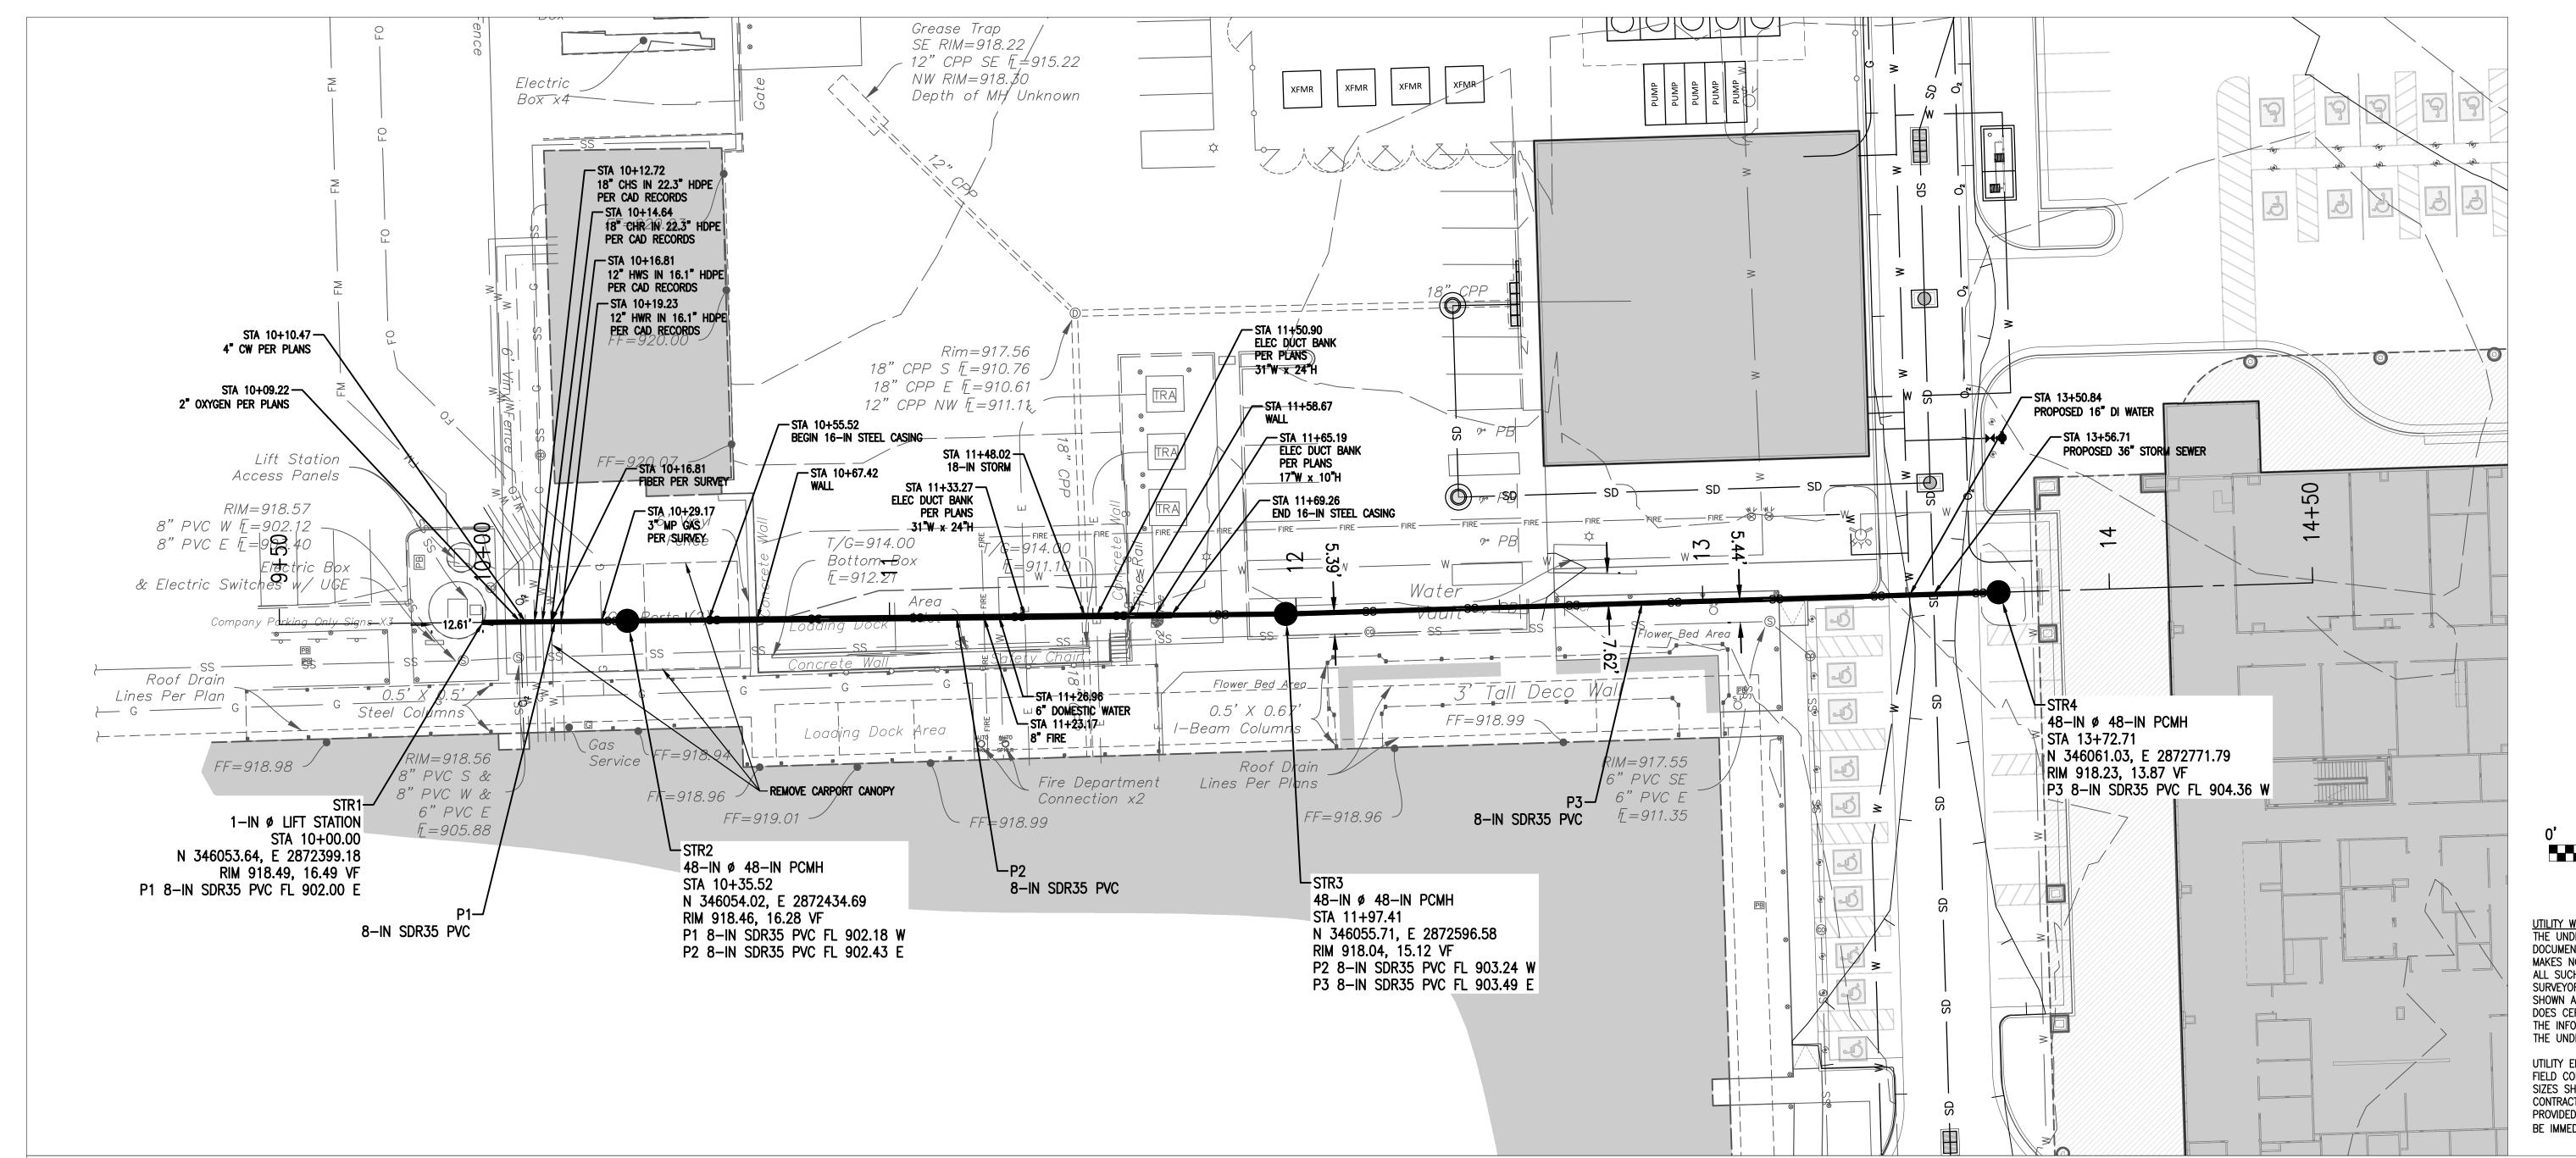
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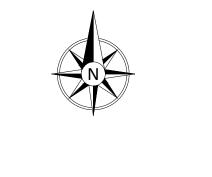
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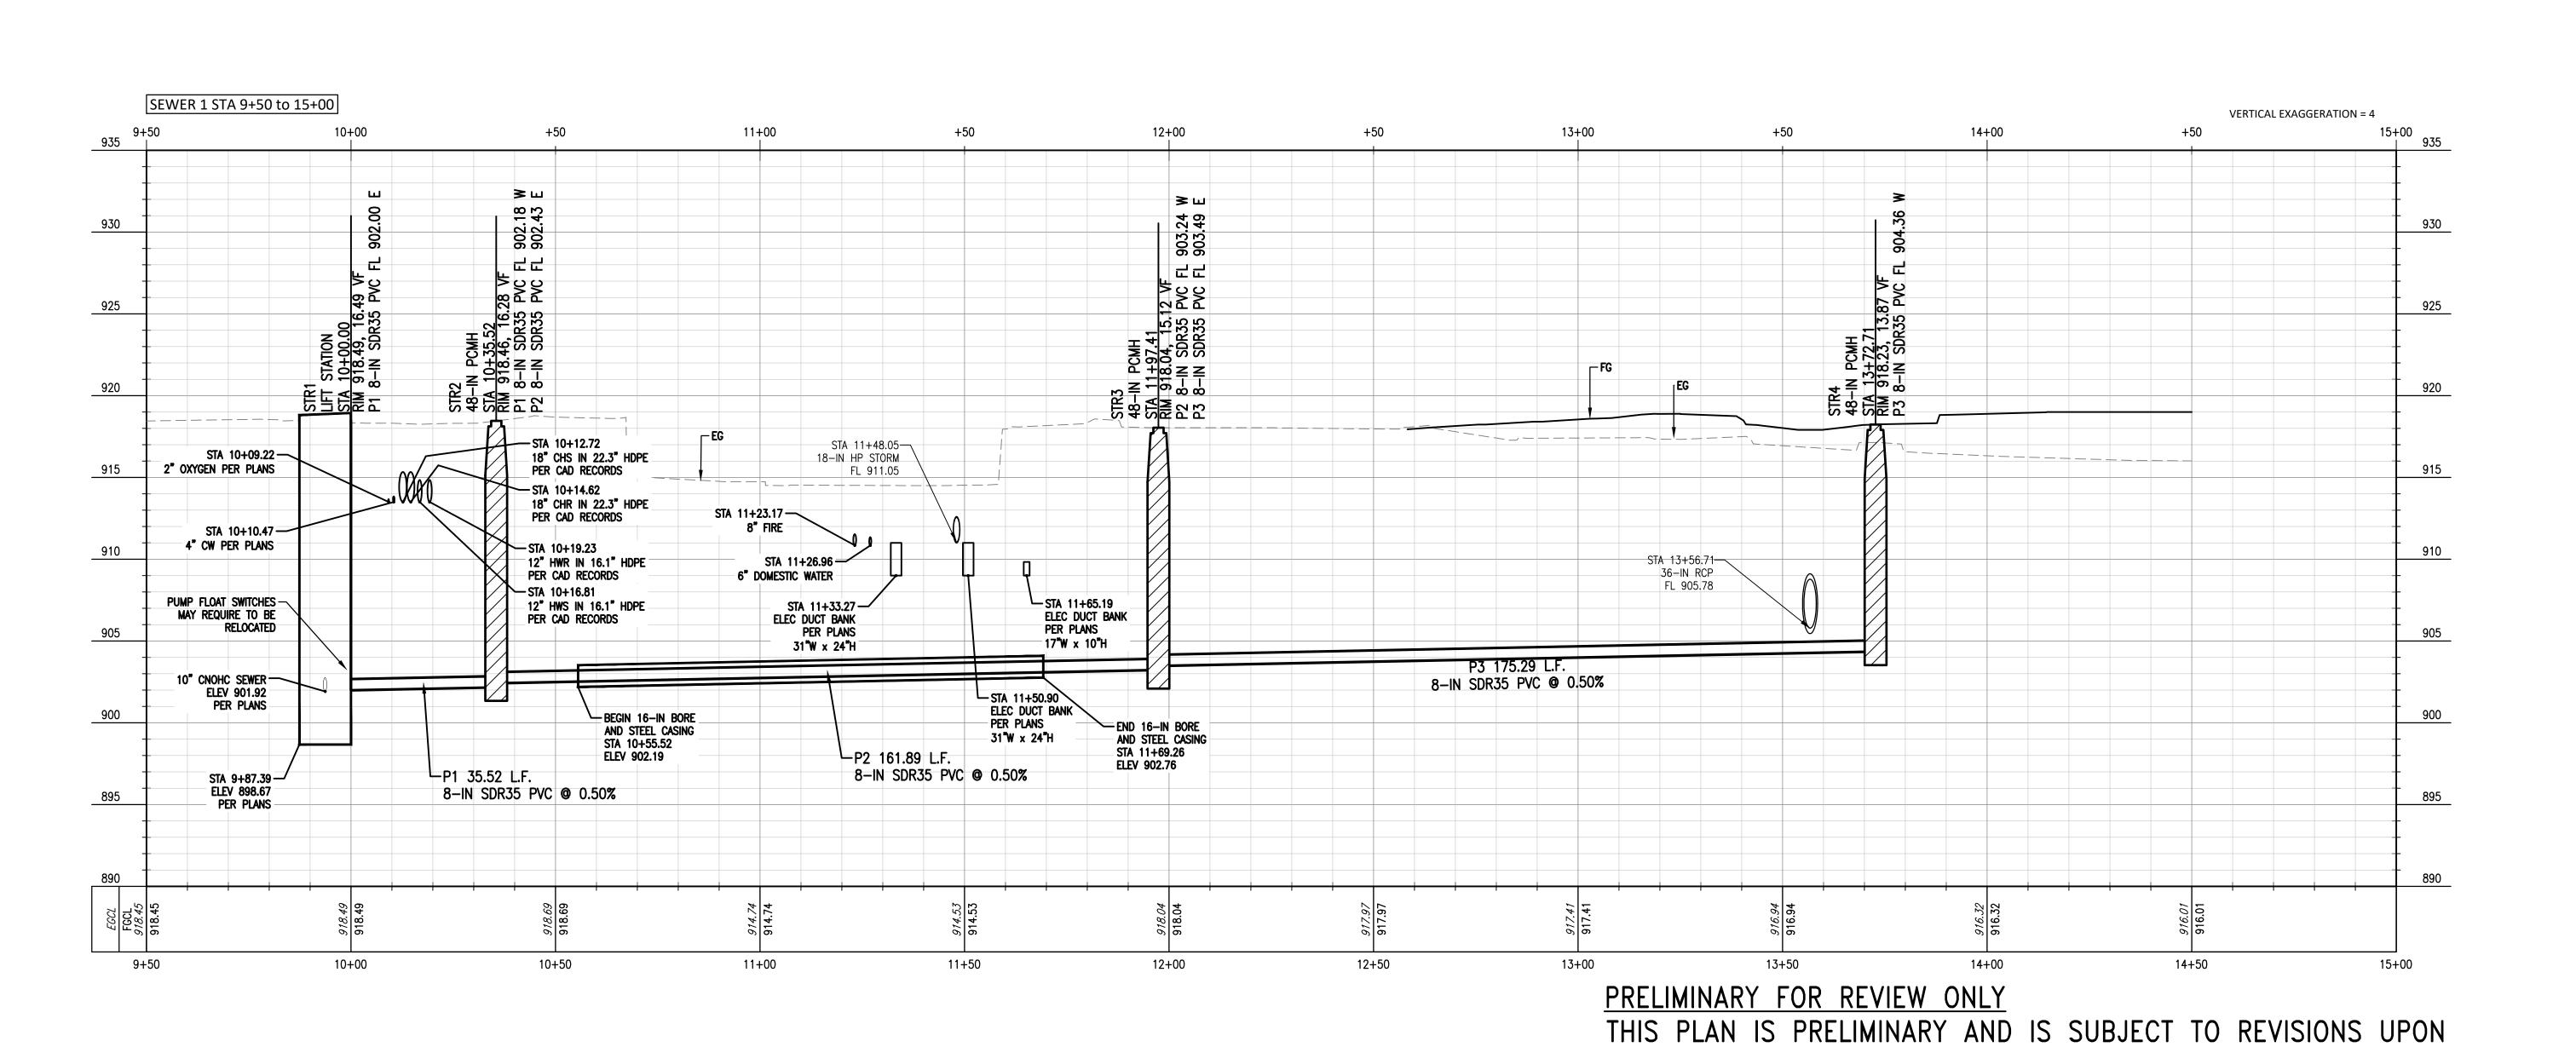






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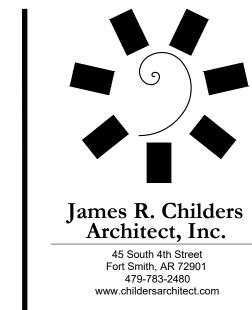
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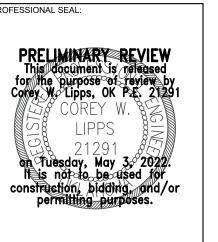




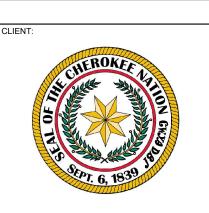
FURTHER COORDINATION WITH CHILDERS, HP, AND THE OWNERS'

TECHNICAL DESIGN COMMITTEE.

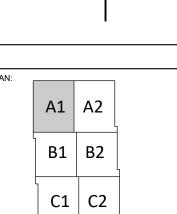




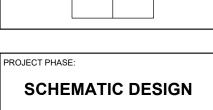




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SEWER PLAN AND PROFILE