


# CHEROKEE NATION

# HOUSING DEVELOPMENT

## CONSTRUCTION DOCUMENTS

7/26/22

TYPE 2

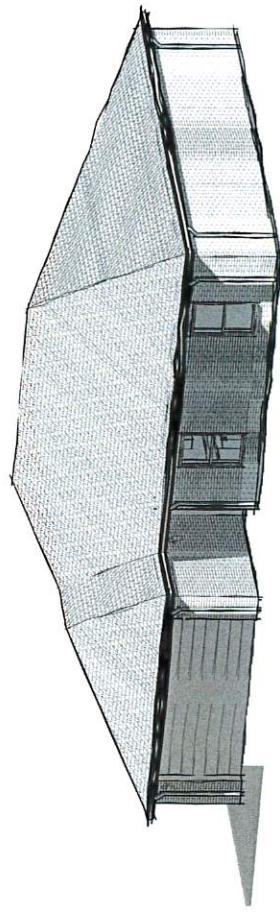

# HOUSING DEVELOPMENT

## CONSTRUCTION DOCUMENTS

7/26/22

TYPE 2

PROJECT CONTACTS		GENERAL CONTRACTOR		SUBCONTRACTORS		GENERAL CONTRACTOR		SUBCONTRACTORS		GENERAL CONTRACTOR		SUBCONTRACTORS	
OWNER	CHEROKEE NATION	ARCHITECT	blue river ARCHITECTS LLC	ELECTRICAL	blue river ARCHITECTS LLC	ELECTRICAL	GENERAL CONTRACTOR	CHIEF CONTRACTOR	GENERAL CONTRACTOR	GENERAL CONTRACTOR	GENERAL CONTRACTOR	GENERAL CONTRACTOR	GENERAL CONTRACTOR
NAME	JOHN SMITH, CHIEF	NAME	JOHN SMITH, ARCHITECT	PHONE	123-456-7890	PHONE	JOHN SMITH, CHIEF	NAME	JOHN SMITH, CHIEF	NAME	JOHN SMITH, CHIEF	NAME	JOHN SMITH, CHIEF
ADDRESS	PO BOX 123, TULSA, OK 74101	ADDRESS	PO BOX 123, TULSA, OK 74101	EMAIL	john.smith@blue-river.com	EMAIL	john.smith@chief-contractors.com	ADDRESS	PO BOX 123, TULSA, OK 74101	ADDRESS	PO BOX 123, TULSA, OK 74101	ADDRESS	PO BOX 123, TULSA, OK 74101
PHONE	(555) 123-4567	PHONE	(555) 123-4567	FAX	(555) 123-4568	FAX	(555) 123-4568	PHONE	(555) 123-4569	PHONE	(555) 123-4569	PHONE	(555) 123-4569
CONTACT	JOHN SMITH, CHIEF	CONTACT	JOHN SMITH, ARCHITECT	CONTACT	JOHN SMITH, CHIEF	CONTACT	JOHN SMITH, CHIEF	CONTACT	JOHN SMITH, CHIEF	CONTACT	JOHN SMITH, CHIEF	CONTACT	JOHN SMITH, CHIEF
ADDITIONAL INFORMATION													
NOTES:													

CONSULTANT CONTACTS		GENERAL CONTRACTOR		SUBCONTRACTORS		GENERAL CONTRACTOR		SUBCONTRACTORS		GENERAL CONTRACTOR		SUBCONTRACTORS	
GENERAL CONTRACTOR	SUBCONTRACTORS	GENERAL CONTRACTOR	SUBCONTRACTORS	GENERAL CONTRACTOR	SUBCONTRACTORS	GENERAL CONTRACTOR	SUBCONTRACTORS	GENERAL CONTRACTOR	SUBCONTRACTORS	GENERAL CONTRACTOR	SUBCONTRACTORS	GENERAL CONTRACTOR	SUBCONTRACTORS
NAME	JOHN SMITH	NAME	JOHN SMITH	NAME	JOHN SMITH	NAME	JOHN SMITH	NAME	JOHN SMITH	NAME	JOHN SMITH	NAME	JOHN SMITH
ADDRESS	PO BOX 123, TULSA, OK 74101	ADDRESS	PO BOX 123, TULSA, OK 74101	ADDRESS	PO BOX 123, TULSA, OK 74101	ADDRESS	PO BOX 123, TULSA, OK 74101	ADDRESS	PO BOX 123, TULSA, OK 74101	ADDRESS	PO BOX 123, TULSA, OK 74101	ADDRESS	PO BOX 123, TULSA, OK 74101
PHONE	(555) 123-4567	PHONE	(555) 123-4567	PHONE	(555) 123-4568	PHONE	(555) 123-4568	PHONE	(555) 123-4569	PHONE	(555) 123-4569	PHONE	(555) 123-4569
CONTACT	JOHN SMITH	CONTACT	JOHN SMITH	CONTACT	JOHN SMITH	CONTACT	JOHN SMITH	CONTACT	JOHN SMITH	CONTACT	JOHN SMITH	CONTACT	JOHN SMITH
ADDITIONAL INFORMATION													
NOTES:													





blue  
river  
ARCHITECTS  
A Division of Blue River Group LLC  
Architectural Services




STATE OF OKLAHOMA  
THE GREAT SEAL  
APPROVED BY THE LEGISLATURE  
MAY 1, 1907  
RE-APPROVED MAY 1, 1911  
RE-APPROVED MAY 1, 1915  
RE-APPROVED MAY 1, 1919  
RE-APPROVED MAY 1, 1923  
RE-APPROVED MAY 1, 1927  
RE-APPROVED MAY 1, 1931  
RE-APPROVED MAY 1, 1935  
RE-APPROVED MAY 1, 1939  
RE-APPROVED MAY 1, 1943  
RE-APPROVED MAY 1, 1947  
RE-APPROVED MAY 1, 1951  
RE-APPROVED MAY 1, 1955  
RE-APPROVED MAY 1, 1959  
RE-APPROVED MAY 1, 1963  
RE-APPROVED MAY 1, 1967  
RE-APPROVED MAY 1, 1971  
RE-APPROVED MAY 1, 1975  
RE-APPROVED MAY 1, 1979  
RE-APPROVED MAY 1, 1983  
RE-APPROVED MAY 1, 1987  
RE-APPROVED MAY 1, 1991  
RE-APPROVED MAY 1, 1995  
RE-APPROVED MAY 1, 1999  
RE-APPROVED MAY 1, 2003  
RE-APPROVED MAY 1, 2007  
RE-APPROVED MAY 1, 2011  
RE-APPROVED MAY 1, 2015  
RE-APPROVED MAY 1, 2019  
RE-APPROVED MAY 1, 2023

CHEROKEE NATION HOUSING  
DEVELOPMENT - TYPE 2


A101  
FLOOR PLANS  
blue river  
ARCHITECTS  
A Division of Blue River Group LLC  
Architectural Services  
ADDRESS HERE  
MAILING ADDRESS  
2000 N May Ave  
Oklahoma City, OK 73106  
Phone: 405.231.7222  
Fax: 405.231.7223  
DESIGN DEVELOPMENT  
UNPUBLISHED DRAWINGS  
NOT FOR CONSTRUCTION  
PRINTED ON 100% RECYCLED PAPER

FLOOR PLANS  
blue river  
ARCHITECTS  
A Division of Blue River Group LLC  
Architectural Services  
PRINTED ON 100% RECYCLED PAPER

A101  
FLOOR PLANS  
blue river  
ARCHITECTS  
A Division of Blue River Group LLC  
Architectural Services  
PRINTED ON 100% RECYCLED PAPER

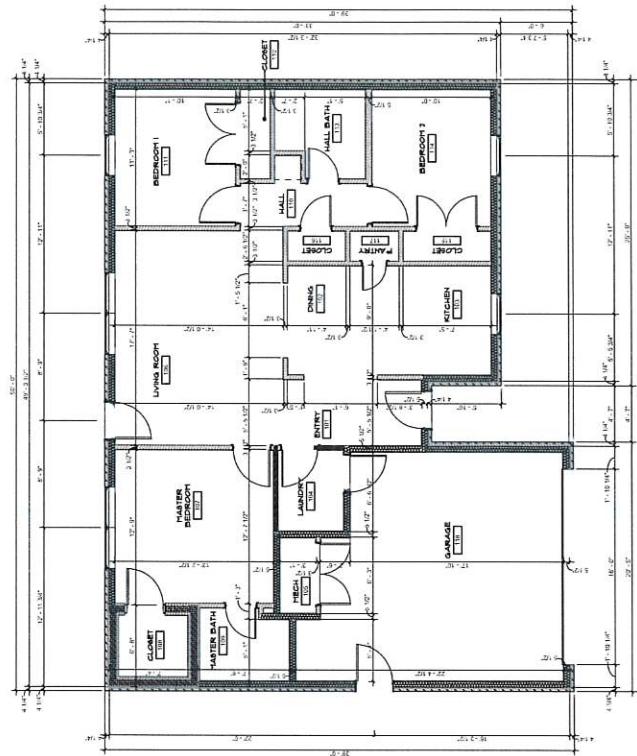

A FIRST FLOOR DIMENSION PLAN  
1/4" = 1'-0"

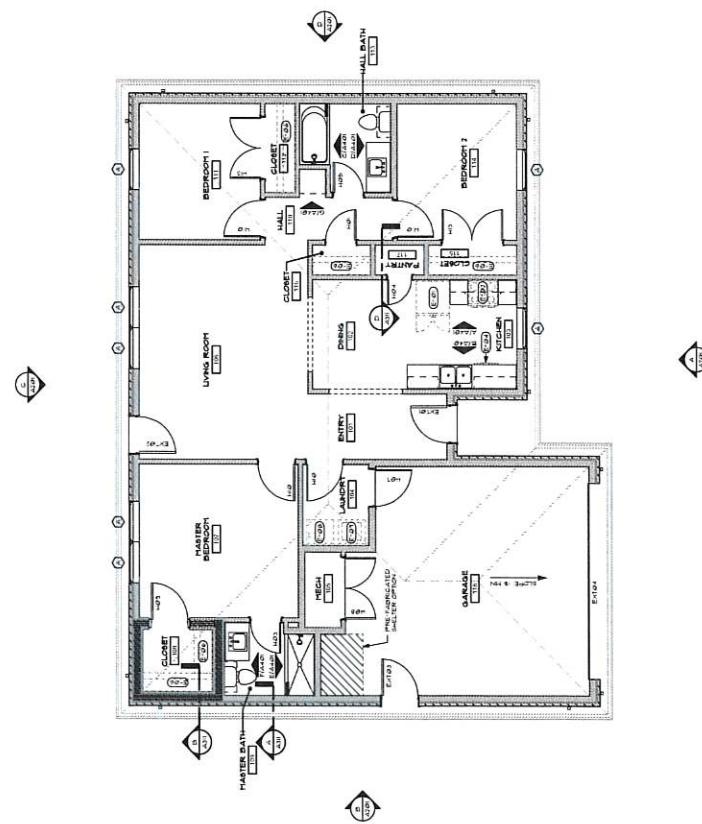

B FIRST FLOOR REFERENCE PLAN  
1/4" = 1'-0"



**blue**  
river  
ARCHITECTS



CHEROKEE NATION HOUSING  
DEVELOPMENT - TYPE 2

REFLECTED CEILING PLAN AND ROOF PLAN  
ADDRESS HERE  
OF OWNERSHIP  
APPROVED BY OWNER  
07/25/22



A121

REFLECTED CEILING PLAN AND ROOF PLAN  
ADDRESS HERE  
OF OWNERSHIP  
APPROVED BY OWNER  
07/25/22




DESIGN DEVELOPMENT

UNIVERSITY DATE  
07/25/22

REFLECTED  
CEILING PLAN  
AND  
ROOF PLAN  
SHEET NUMBER  
A121



**A REFLECTED CEILING PLAN**

**B ROOF PLAN**

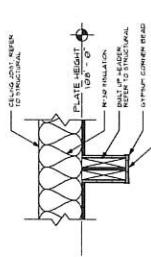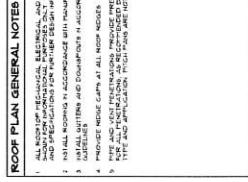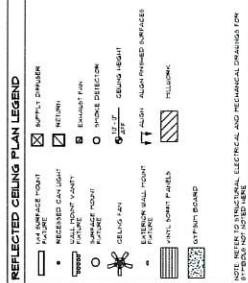

**C CEILING DETAIL**

REFLECTED CEILING PLAN AND ROOF PLAN  
ADDRESS HERE  
OF OWNERSHIP  
APPROVED BY OWNER  
07/25/22

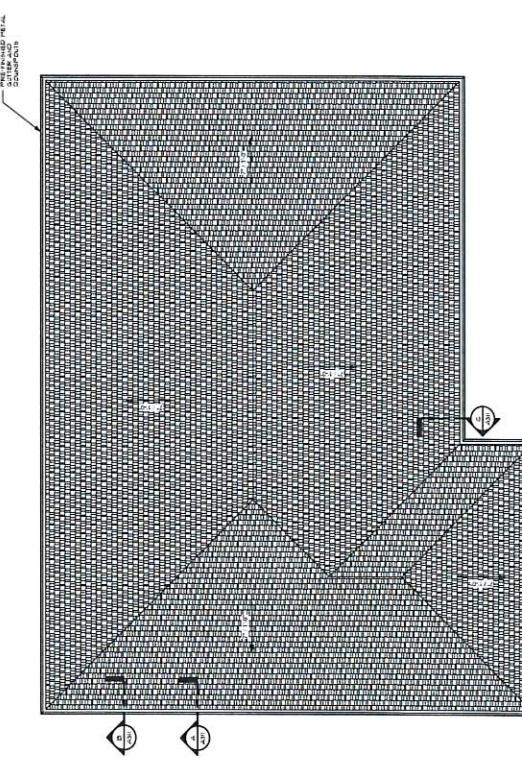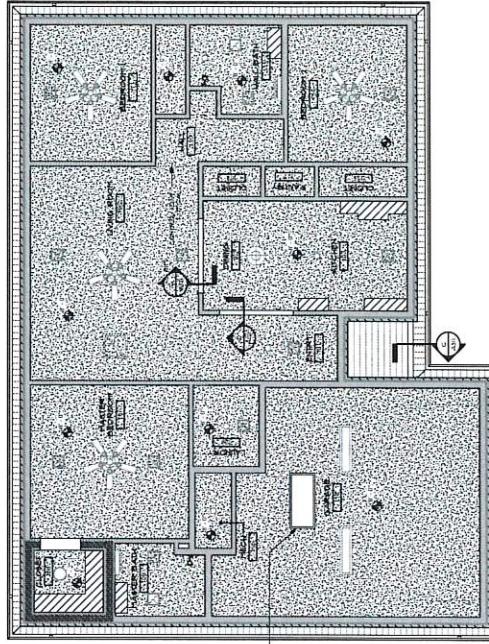




**EXTERIOR ELEVATION GENERAL NOTES**

REFER TO SHEET A40 FOR COLOR PRODUCTS


- REFER TO SHEET A40 FOR COLOR PRODUCTS
- REFER TO MATERIAL NOTES IN THE EXTERIOR WALL SECTION
- REFER TO MATERIAL NOTES IN THE EXTERIOR WALL SECTION
- REFER TO MATERIAL NOTES IN THE EXTERIOR WALL SECTION
- DETAILS ON EXTERIOR ELEVATION ARE PROVIDED IN NATURE AND NOT DRAWN TO SCALE. ALL DIMENSIONS ARE IN FEET UNLESS OTHERWISE SPECIFIED. ALL DIMENSIONS ARE IN FEET UNLESS OTHERWISE SPECIFIED.
- REFER TO ELECTRICAL FOR ADDITIONAL INFORMATION AT EXTERIOR GURDOWNS
- PROVIDE CONTROL CLOPS PER PLATE AND OTHER SPECIFICATIONS
- PLATE ATTACHMENT SHALL AT ALL SURFACES ATTACHMENT AND TIE-OFF NEED

**EXTERIOR MATERIAL LEGEND**


INSULATED BRICK	INSULATED BRICK, GREEN COLORANT FOR DARK, 100% LEAD-BASED GRAY
ALUMINUM INSULATED BRICK	ALUMINUM INSULATED BRICK, 100% LEAD-BASED GRAY
WALL CLADDING	WALL CLADDING - PLATE
METAL ROOFING	METAL, ALUMINUM, IRON/STEEL - PLATE
STRUCTURE	STRUCTURE AND FOUNDATION, CONCRETE - PLATE
UNIQUE TYPE	UNIQUE TYPE
LIGHTING OPEN TO ELECTRICAL	LIGHTING OPEN TO ELECTRICAL

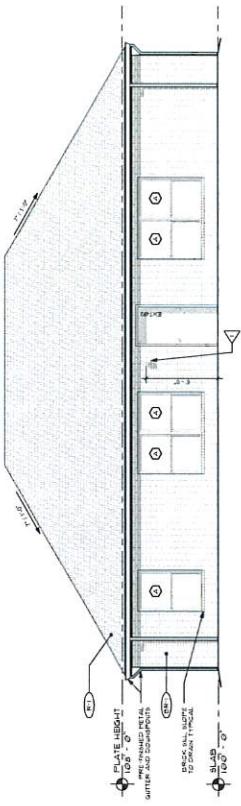


C EXTERIOR ELEVATION

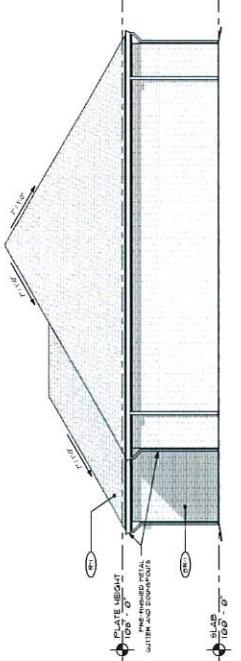


D EXTERIOR ELEVATION

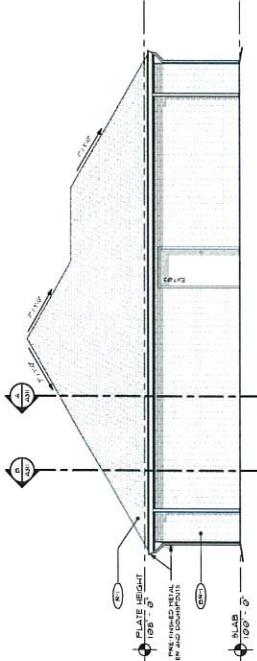


A EXTERIOR ELEVATION

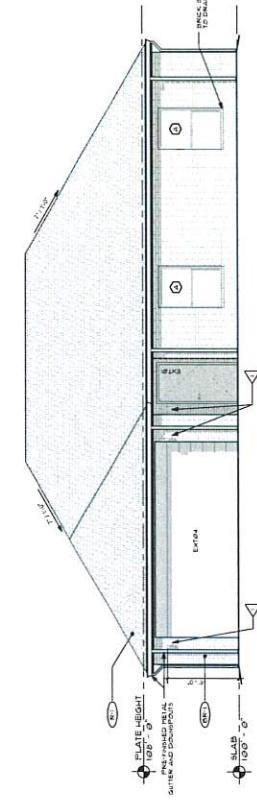

B EXTERIOR ELEVATION

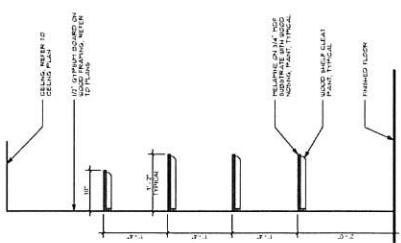

**D CASEWORK SECTION**  
1' = 10'<sup>ft</sup>

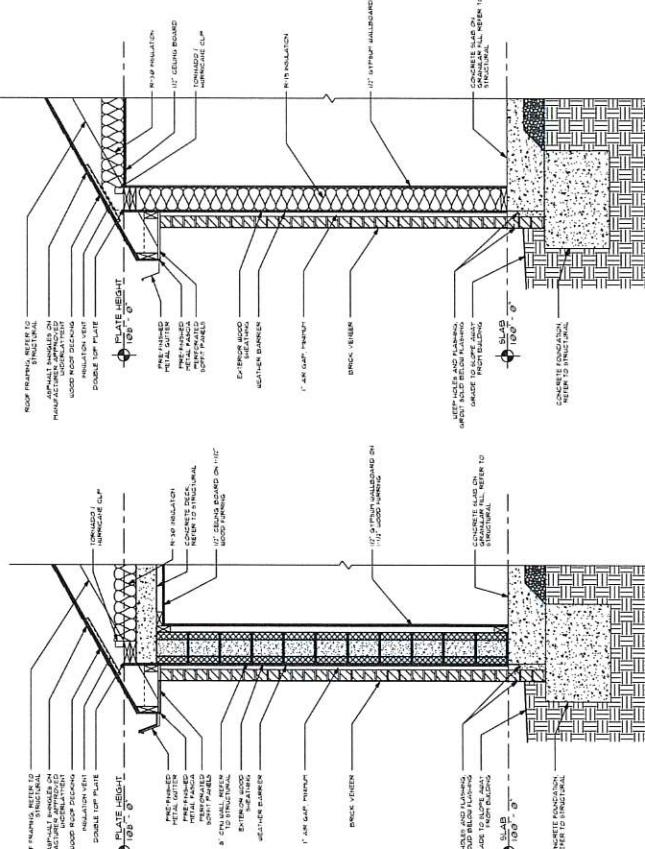

ADDRESS HERE  
A311

WALL SECTION  
A311



**B WALL SECTION**  
1' = 10'<sup>ft</sup>

WALL SECTION  
A311



**C WALL SECTION**  
1' = 10'<sup>ft</sup>

WALL SECTION  
A311

**A311**  
SHEET NUMBER  
A311







**blue river**  
ARCHITECTS  
Natalie Pfeifer, FAIA, LEED AP




blue river  
ARCHITECTS  
Natalie Pfeifer, FAIA, LEED AP  
2009

**CONSTRUCTION NOTES:**

1. TYPE OF SLAB FOUNDATION AND FOUNDATION DEPTH: A thickened slab foundation is used for all exterior walls. The thickness is 10 inches. The foundation depth is 30 inches below grade level. The slab thickness is 10 inches.
2. FOUNDATION WALL THICKNESS: The foundation walls are 8 inches thick. They are made of concrete blocks or concrete piers.
3. FOUNDATION WALL FINISH: The foundation walls are finished with a smooth, flat surface.
4. FOUNDATION WALL TIE-OFFS: Tie-offs are provided for all exterior walls. They are located at the top and bottom of each wall.
5. FOUNDATION WALL SUPPORTS: A support is provided for each exterior wall. It is located at the center of each wall.
6. FOUNDATION WALL VENTS: Vents are provided for each exterior wall. They are located at the top and bottom of each wall.
7. FOUNDATION WALL COLUMN HOLE: A hole is provided for each exterior wall. It is located at the center of each wall.

**blue river**  
ARCHITECTS  
S-102  
TYPE 2 - FOUNDATION PLAN  
**CHEROKEE NATION HOUSING**  
**DEVELOPMENT - TYPES 1 TO 4**


INSTITUTE  
TYPE 2 -  
FOUNDATION  
PLAN  
SHEET NUMBER:  
**S-102**

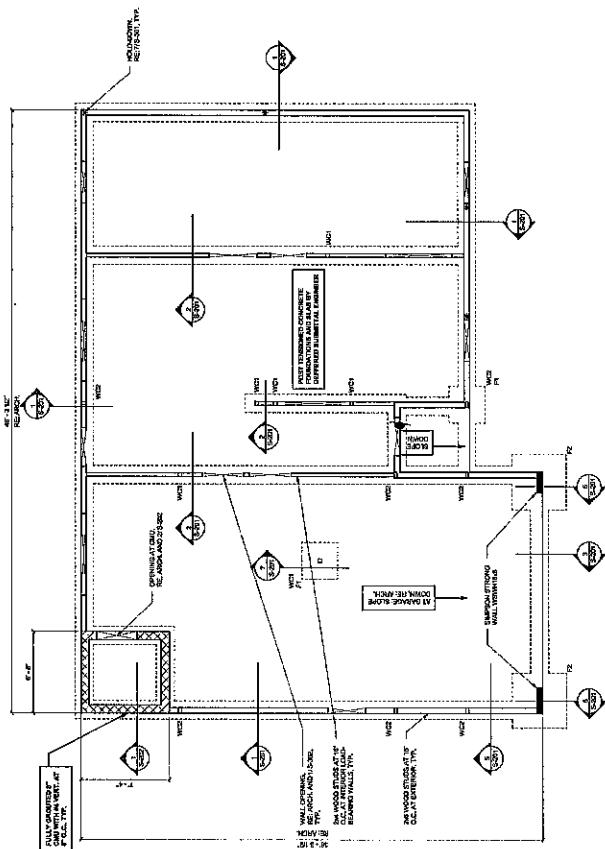


1 FOUNDATION PLAN - TYPE 2









RECOMMENDED DRAWINGS  
1. RECOMMENDED DRAWDINGS FOR USE AND LOCATION  
2. SUPPORTING DOCUMENTS  
3. SUPPORTING DETAILS  
4. REFERENCE DRAWINGS  
5. REFER TO THE PROJECT SPECIFICATIONS FOR THE LATEST INFORMATION  
6. REFER TO THE PROJECT SPECIFICATIONS FOR THE LATEST INFORMATION  
7. REFER TO THE PROJECT SPECIFICATIONS FOR THE LATEST INFORMATION  
8. REFER TO THE PROJECT SPECIFICATIONS FOR THE LATEST INFORMATION

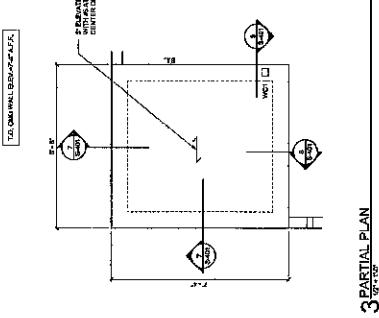

### CHEROKEE NATION HOUSING DEVELOPMENT - TYPES 1 TO 4

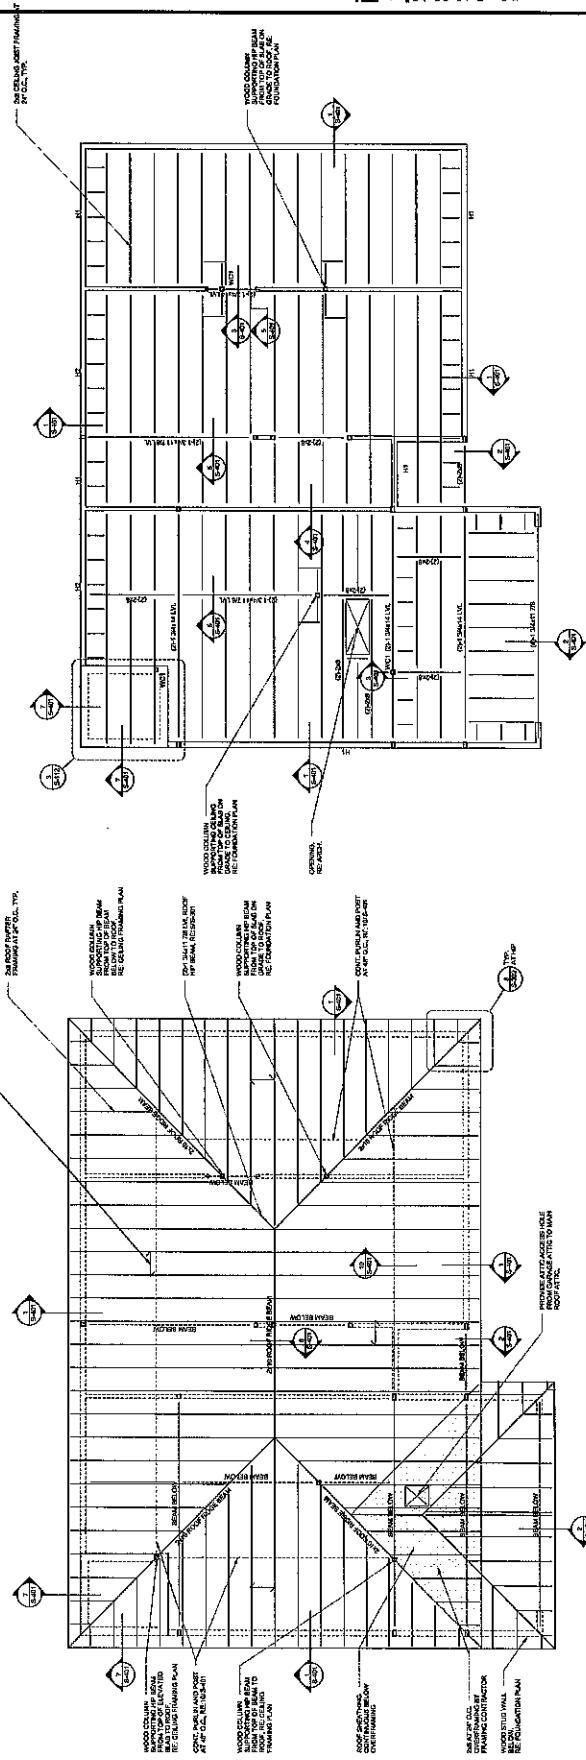

S-112  
blue river ARCHITECTS  
PROJECT NUMBER: CHN-001  
RELEASE DATE: 04/16/22  
100% CONSTRUCTION DOCUMENTS  
CROSS-REFERENCED  
SHEET NUMBER: S-112

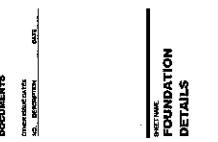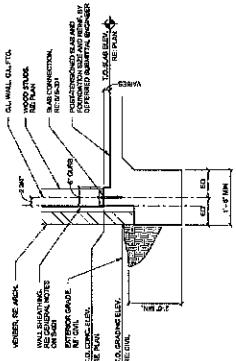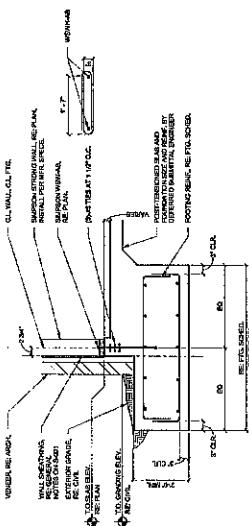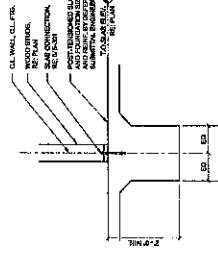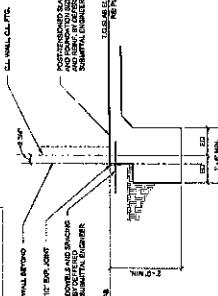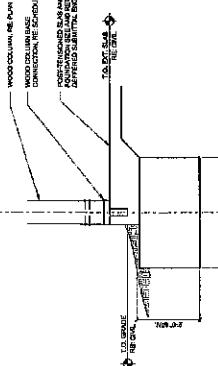
 FOUNDATION DETAIL  
 1

 FOUNDATION DETAIL  
 5

 FOUNDATION DETAIL  
 6

 FOUNDATION DETAIL  
 2

 FOUNDATION DETAIL  
 3

 FOUNDATION DETAIL  
 4

NAME:	FOOTING SCHEDULE		
	SL.	TYPE	SIZE
1	1-1	WOOD COLUMN	12" x 12"
2	1-2	WOOD COLUMN	12" x 12"
3	1-3	WOOD COLUMN	12" x 12"
4	1-4	WOOD COLUMN	12" x 12"

 FOUNDATION DETAIL  
 7



**blue river**  
ARCHITECTS  
An architectural division



WORKS  
CONTRACT  
NO. CLAW-0001  
DATE: 01/01/2023

CHEROKEE NATION HOUSING  
DEVELOPMENT - TYPES 1 TO 4



S-202  
TYPICAL CMU DETAILS

**blue river**  
ARCHITECTS



AS-B-A-0001  
ADAPTEC  
REV B22  
100% CONSTRUCTION  
DOCUMENTS  
DRAFTS

S-202  
TYPICAL CMU  
DETAILS

**S-202**

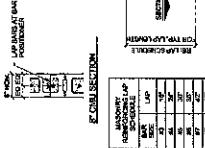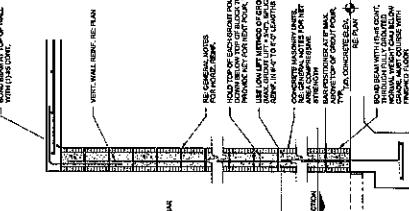

1 CMU WALL REINFORCING DIAGRAM

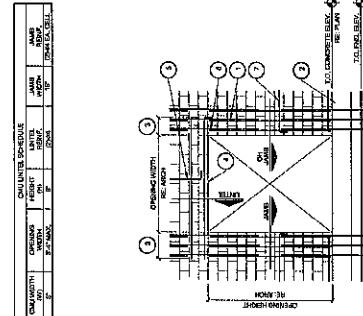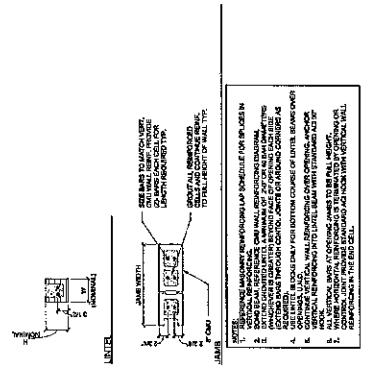

2 TYPICAL MASONRY WALL OPENING DIAGRAM AND SCHEDULE

CHASSIS	CHASSIS TYPE	FRONT WHEEL WHEEL TYPE	REAR WHEEL WHEEL TYPE	FRONT DOOR WHEEL WHEEL TYPE	REAR DOOR WHEEL WHEEL TYPE
E	E-A MAX	F	F	F	F





A R C H I T E C T S  
A TEAM APPROVED BY THE STATE OF OKLAHOMA

YORKSHIRE CONSULTING



REGISTERED PROFESSIONAL

ENGINEERS AND ARCHITECTS


OKLAHOMA CITY

MASONRY VENEER LOOSE LINTEL ANGLE SCHEDULE		
GLAZESPAN	ANGLE SIZE	SPAN
12'-0"	1/2"	12'-0"


12 MASONRY LOOSE LINTEL ANGLE SCHEDULE

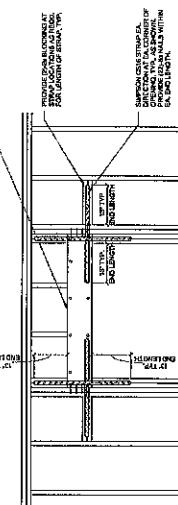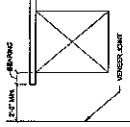


11 FORCE TRANSFER AROUND OPENINGS

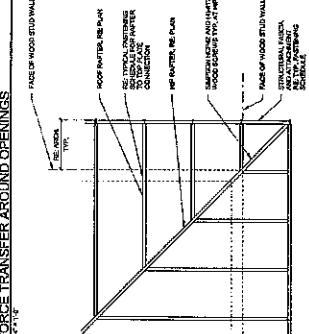

12 HIP FRAMING DETAIL

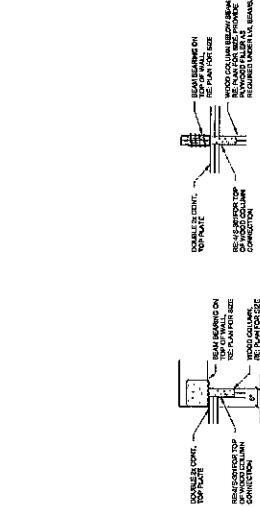


10 TYPICAL BEAM TO STUD WALL CONNECTIONS

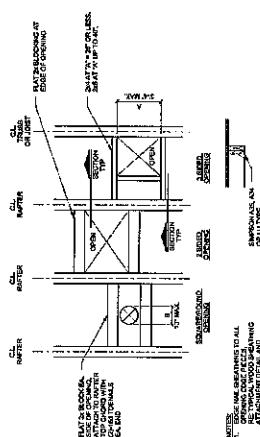


12 MASONRY LOOSE LINTEL ANGLE SCHEDULE


13 SMALL OPENING IN WOOD SHEATHING

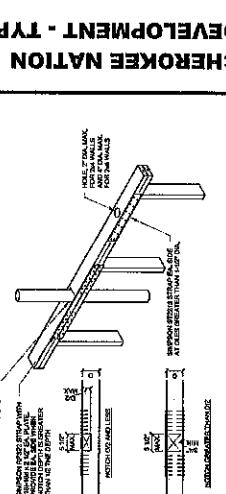


13 SMALL OPENING IN WOOD SHEATHING

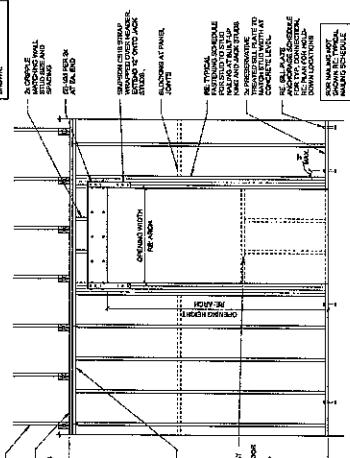


14 5 HOLES AND NOTCHES IN TOP PLATE

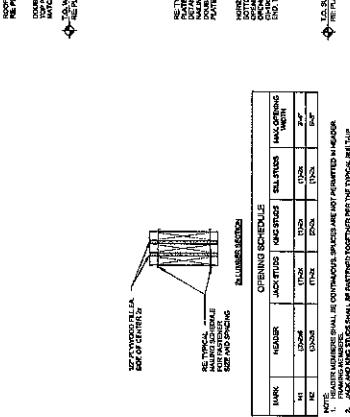


15 TYPICAL ROOF RAFTER TIE DOWN DETAIL

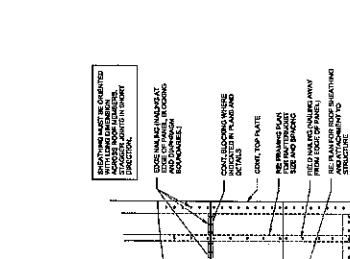

16 BEARING WALL FRAMING ALIGNMENT DETAIL

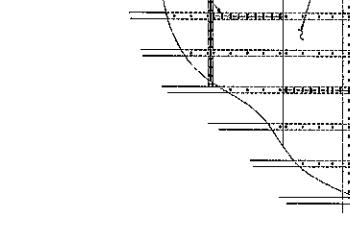

17 TYPICAL WALL SHEATHING ATTACHMENT DIAGRAM

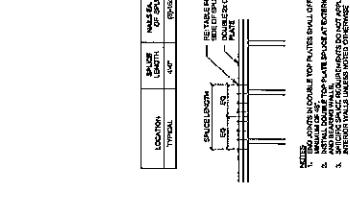


18 4 TYPICAL TOP PLATE SPLICE



19 CHEROKEE NATION HOUSING DEVELOPMENT TYPES 1 TO 4

20 S-302

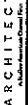

A R C H I T E C T S  
A TEAM APPROVED BY THE STATE OF OKLAHOMA

YORKSHIRE CONSULTING

REGISTERED PROFESSIONAL

ENGINEERS AND ARCHITECTS

OKLAHOMA CITY

YORKSHIRE CONSULTING

REGISTERED PROFESSIONAL

ENGINEERS AND ARCHITECTS

OKLAHOMA CITY

YORKSHIRE CONSULTING

REGISTERED PROFESSIONAL

ENGINEERS AND ARCHITECTS

OKLAHOMA CITY

YORKSHIRE CONSULTING

REGISTERED PROFESSIONAL

ENGINEERS AND ARCHITECTS

OKLAHOMA CITY

YORKSHIRE CONSULTING

REGISTERED PROFESSIONAL

ENGINEERS AND ARCHITECTS

OKLAHOMA CITY

YORKSHIRE CONSULTING

REGISTERED PROFESSIONAL

ENGINEERS AND ARCHITECTS

OKLAHOMA CITY

YORKSHIRE CONSULTING

REGISTERED PROFESSIONAL

ENGINEERS AND ARCHITECTS

OKLAHOMA CITY

YORKSHIRE CONSULTING

REGISTERED PROFESSIONAL

ENGINEERS AND ARCHITECTS

OKLAHOMA CITY

S-302




**blue river**  
ARCHITECTS  
A Division of Cottrell & Associates  
Architects, Engineers & Planners




CHEROKEE NATION  
Housing Development  
Architectural Services

OSCAR L. WOOD


CHEROKEE NATION HOUSING  
DEVELOPMENT - TYPES I TO 4

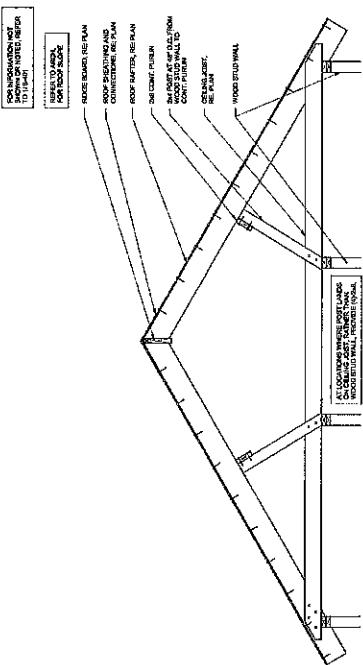


10 FRAMING DETAIL  
 $\frac{1}{2}'' = 1'-0''$

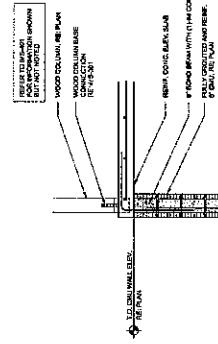


9 ROOF FRAMING AT SHELTER  
 $\frac{1}{2}'' = 1'-0''$

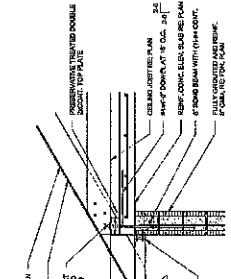


7 FRAMING DETAIL  
 $\frac{1}{2}'' = 1'-0''$

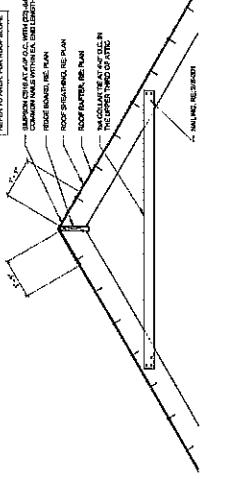


6 FRAMING DETAIL  
 $\frac{1}{2}'' = 1'-0''$

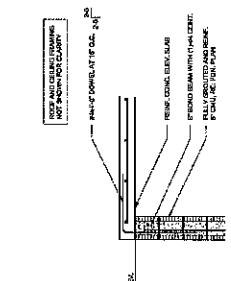

8 FRAMING DETAIL  
 $\frac{1}{2}'' = 1'-0''$

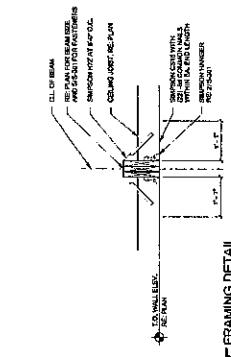

5 FRAMING DETAIL  
 $\frac{1}{2}'' = 1'-0''$

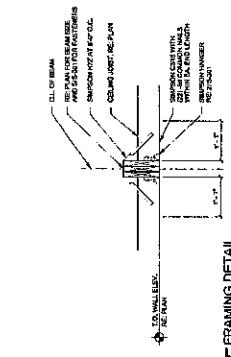

3 FRAMING DETAIL  
 $\frac{1}{2}'' = 1'-0''$



4 FRAMING DETAIL  
 $\frac{1}{2}'' = 1'-0''$

FRAMING DETAILS  
S-401  
blue river  
ARCHITECTS  
A Division of Cottrell & Associates  
Architects, Engineers & Planners

CHEROKEE NATION  
Housing Development  
Architectural Services

OSCAR L. WOOD


CHEROKEE NATION  
Housing Development  
Architectural Services

OSCAR L. WOOD

**S-401**  
blue river  
ARCHITECTS  
A Division of Cottrell & Associates  
Architects, Engineers & Planners

CHEROKEE NATION  
Housing Development  
Architectural Services

OSCAR L. WOOD

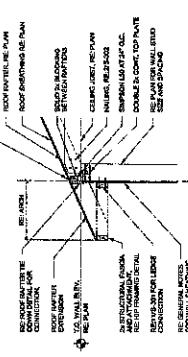

1 FRAMING DETAIL  
 $\frac{1}{2}'' = 1'-0''$

FRAMING DETAILS  
S-401  
blue river  
ARCHITECTS  
A Division of Cottrell & Associates  
Architects, Engineers & Planners

CHEROKEE NATION  
Housing Development  
Architectural Services

blue river  
ARCHITECTS  
A Division of Cottrell & Associates  
Architects, Engineers & Planners

blue river  
ARCHITECTS  
A Division of Cottrell & Associates  
Architects, Engineers & Planners

2 FRAMING DETAIL  
 $\frac{1}{2}'' = 1'-0''$

FRAMING DETAILS  
S-401  
blue river  
ARCHITECTS  
A Division of Cottrell & Associates  
Architects, Engineers & Planners

CHEROKEE NATION  
Housing Development  
Architectural Services

blue river  
ARCHITECTS  
A Division of Cottrell & Associates  
Architects, Engineers & Planners

blue river  
ARCHITECTS  
A Division of Cottrell & Associates  
Architects, Engineers & Planners

3 FRAMING DETAIL  
 $\frac{1}{2}'' = 1'-0''$

FRAMING DETAILS  
S-401  
blue river  
ARCHITECTS  
A Division of Cottrell & Associates  
Architects, Engineers & Planners

CHEROKEE NATION  
Housing Development  
Architectural Services

blue river  
ARCHITECTS  
A Division of Cottrell & Associates  
Architects, Engineers & Planners

blue river  
ARCHITECTS  
A Division of Cottrell & Associates  
Architects, Engineers & Planners







NAME	NET COOLING		NET HEATING		ELECTRICAL		NOTES
	TON/HOUR	TON/HOUR	TON/HOUR	TON/HOUR	AMPS	KWH	
1							
2							
3							
4							
5							

NOTES:  
 1. All units shall be refrigeration systems with no auxiliary heating, cooling or grade, low ambient heating, dehumidification and fans.  
 2. The system shall be a variable air volume system with variable speed fan and variable speed pump.  
 3. The system shall be a two stage system with two heat pumps.  
 4. The system shall be a two stage system with two heat pumps.  
 5. The system shall be a two stage system with two heat pumps.

NAME	MANUFACTURER & MODEL		COOLING		ELECTRICAL		NOTES
	MANUFACTURER	MODEL	TON	CFM	VOLT	AMP	
1	BAUER	2009FCP-L	24	3000	208V	15	
2	BAUER	2009FCP-L	24	3000	208V	15	


NOTES:  
 1. REFRIGERATION SYSTEMS WILL BE PROVIDED BY THE MANUFACTURER.  
 2. ALL UNITS WILL BE PROVIDED BY THE MANUFACTURER.  
 3. ALL UNITS WILL BE PROVIDED BY THE MANUFACTURER.  
 4. ALL UNITS WILL BE PROVIDED BY THE MANUFACTURER.

NAME	MANUFACTURER & MODEL	LOCATION	COOLING	ELECTRICAL	REFRIGERANT		NOTES
					MANUFACTURER	MODEL	
1	TECO	THOT-3	VENT FAN	TECO	TECO	1/2	

NOTES:  
 1. EXHAUST FANS ARE PROVIDED BY THE MANUFACTURER.  
 2. EXHAUST FANS ARE PROVIDED BY THE MANUFACTURER.

NAME	MANUFACTURER & MODEL	LOCATION	ELECTRICAL		NOTES
			MANUFACTURER	MODEL	
1	TECO	SUPPLY FAN	TECO	1/2	
2	TECO	EXHAUST FAN	TECO	1/2	
3	TECO	EXHAUST FAN	TECO	1/2	
4	TECO	VENT FAN	TECO	1/2	

NOTES:  
 1. EXHAUST FANS ARE PROVIDED BY THE MANUFACTURER.  
 2. EXHAUST FANS ARE PROVIDED BY THE MANUFACTURER.

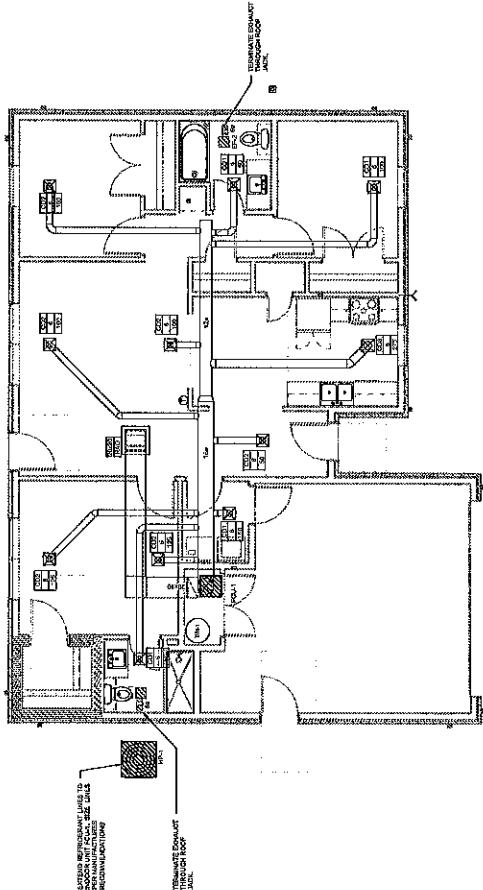

FIRST FLOOR HOME PLAN  
1ST FLOOR





**CHEROKEE NATION HOUSING  
DEVELOPMENT - TYPE 2**




**P101**  
TYPE 2 PLUMBING PLANS

CHIEF PLUMBER  
DRAFTER  
CIVIL ENGINEER  
ARCHITECT  
PROJECT MANAGER


**TYPE 2 PLUMBING PLANS**

**P101**

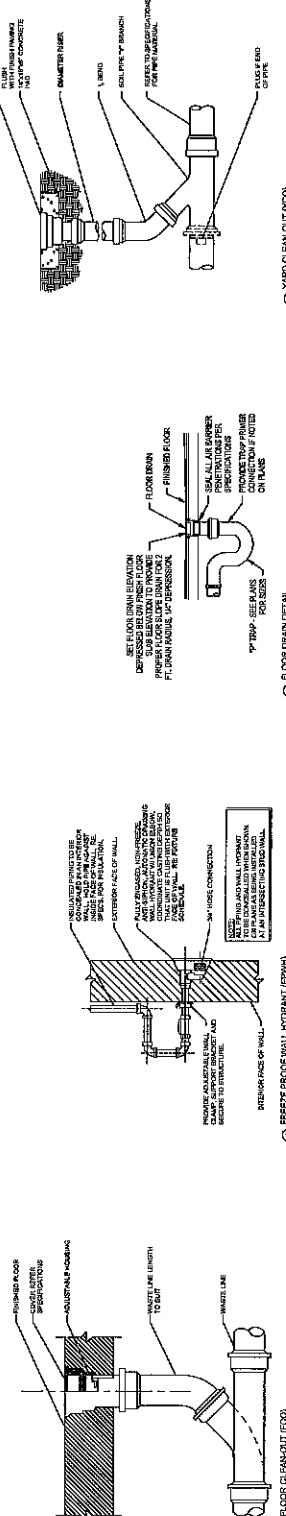


**PLUMBING FIXTURE SCHEDULE**


NAME	ITEM	SIZE	DIMENSIONS AND MATERIAL	TYPE	PLATE	DESCRIPTION	INTEGRITY TESTS	
							MIN.	MAX.
WCS	WATER CLOSET	7"	18" x 30" x 14"	CP	WCS-0001	WATER CLOSET WITH DRAIN	100%	100%
WCS	WATER CLOSET	7"	18" x 30" x 14"	CP	WCS-0002	WATER CLOSET WITH DRAIN	100%	100%
WCS	WATER CLOSET	7"	18" x 30" x 14"	CP	WCS-0003	WATER CLOSET WITH DRAIN	100%	100%
WCS	WATER CLOSET	7"	18" x 30" x 14"	CP	WCS-0004	WATER CLOSET WITH DRAIN	100%	100%
WCS	WATER CLOSET	7"	18" x 30" x 14"	CP	WCS-0005	WATER CLOSET WITH DRAIN	100%	100%
VFC	VACUUM FLUSH CLOSET	7"	18" x 30" x 14"	CP	VFC-0001	VACUUM FLUSH CLOSET	100%	100%
VFC	VACUUM FLUSH CLOSET	7"	18" x 30" x 14"	CP	VFC-0002	VACUUM FLUSH CLOSET	100%	100%
VFC	VACUUM FLUSH CLOSET	7"	18" x 30" x 14"	CP	VFC-0003	VACUUM FLUSH CLOSET	100%	100%
VFC	VACUUM FLUSH CLOSET	7"	18" x 30" x 14"	CP	VFC-0004	VACUUM FLUSH CLOSET	100%	100%
VFC	VACUUM FLUSH CLOSET	7"	18" x 30" x 14"	CP	VFC-0005	VACUUM FLUSH CLOSET	100%	100%
KIC	KITCHEN SINK	1" DIA. X 12"	18" x 30"	CP	KIC-0001	KITCHEN SINK	100%	100%
KIC	KITCHEN SINK	1" DIA. X 12"	18" x 30"	CP	KIC-0002	KITCHEN SINK	100%	100%
KIC	KITCHEN SINK	1" DIA. X 12"	18" x 30"	CP	KIC-0003	KITCHEN SINK	100%	100%
KIC	KITCHEN SINK	1" DIA. X 12"	18" x 30"	CP	KIC-0004	KITCHEN SINK	100%	100%
KIC	KITCHEN SINK	1" DIA. X 12"	18" x 30"	CP	KIC-0005	KITCHEN SINK	100%	100%
BAT	BATH TUB	1" DIA. X 12"	18" x 30"	CP	BAT-0001	BATH TUB	100%	100%
BAT	BATH TUB	1" DIA. X 12"	18" x 30"	CP	BAT-0002	BATH TUB	100%	100%
BAT	BATH TUB	1" DIA. X 12"	18" x 30"	CP	BAT-0003	BATH TUB	100%	100%
BAT	BATH TUB	1" DIA. X 12"	18" x 30"	CP	BAT-0004	BATH TUB	100%	100%
BAT	BATH TUB	1" DIA. X 12"	18" x 30"	CP	BAT-0005	BATH TUB	100%	100%
SOF	SINK OVERFLOW	1" DIA. X 12"	18" x 30"	CP	SOF-0001	SINK OVERFLOW	100%	100%
SOF	SINK OVERFLOW	1" DIA. X 12"	18" x 30"	CP	SOF-0002	SINK OVERFLOW	100%	100%
SOF	SINK OVERFLOW	1" DIA. X 12"	18" x 30"	CP	SOF-0003	SINK OVERFLOW	100%	100%
SOF	SINK OVERFLOW	1" DIA. X 12"	18" x 30"	CP	SOF-0004	SINK OVERFLOW	100%	100%
SOF	SINK OVERFLOW	1" DIA. X 12"	18" x 30"	CP	SOF-0005	SINK OVERFLOW	100%	100%

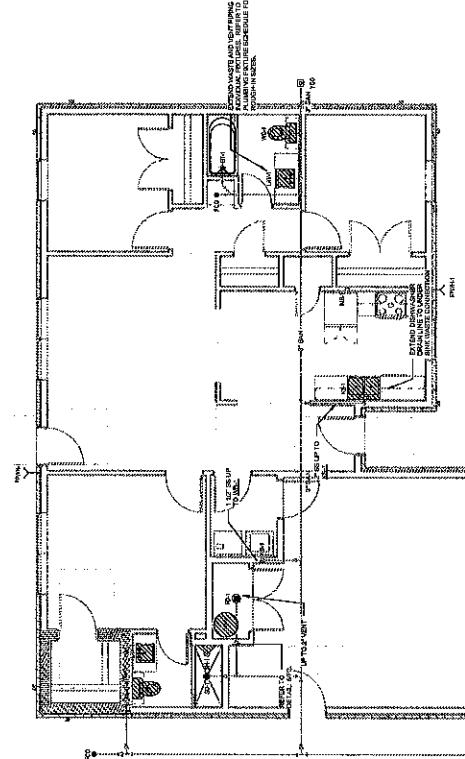


(1) FIRST FLOOR SANITARY PLAN  
1/2" = 1'-0"

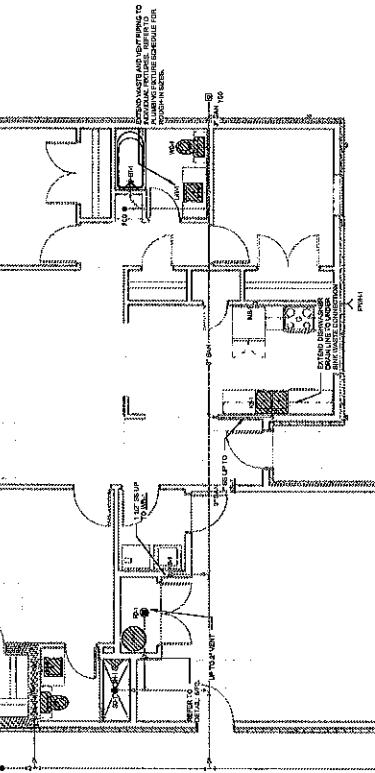


(2) SECOND FLOOR SANITARY PLAN  
1/2" = 1'-0"

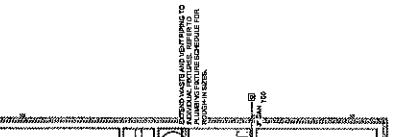

(3)

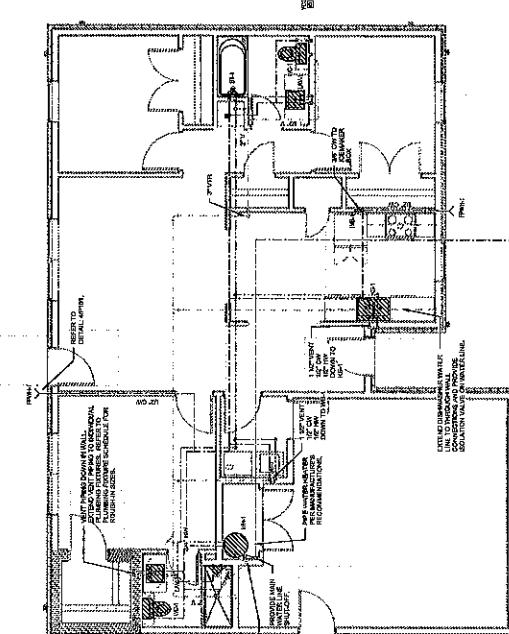

(4)

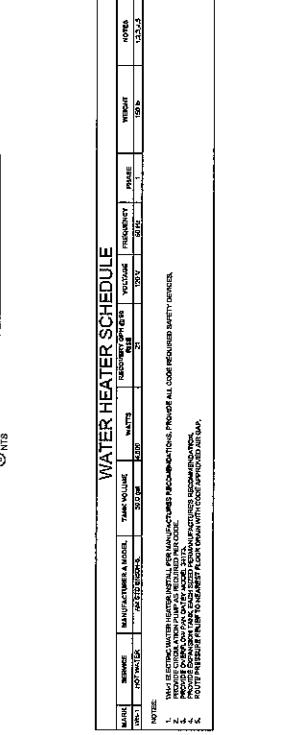

**WATER HEATER SCHEDULE**

NAME	SERIAL	MANUFACTURER & MODEL	TANK VOLUME	WATERS	RELIEF VALVE	RELIEF VALVE	FREQUENCY	TEST	PHASE	SIZZ	WIRK
<b>NOTE:</b> THIS ESTIMATES WATER HEATERS WHICH MEET THE STATED REQUIREMENTS. PROVIDE ALL CODE REQUIRED SAFETY DEVICES.											